

PLANNING INFO.

■ PROPERTY OWNER: OLIVER AND BROOKE RICKARD 1304 SUTTON DRIVE COLUMBIA, MO. 65203

■ PROJECT ADDRESS: 5 YANKEE BEACH WAY CARMEL, CA 93923

■ PROJECT SCOPE: • INTERIOR REMODEL TO EXISTING SINGLE FAMILY DWELLING WITH

AN ADDITION OF 933 SF. • INTERIOR REMODEL OF EXISTING GUESTHOUSE, CONVERTING 89

SF. INTO NEW OFFICE. ADDITION OF 101 SF. TO NEW HOME OFFICE, TOTALING 190 SF.

NEW HOME OFFICE. ADDITION OF 170 SF TO EXISTING GARAGE.

 NEW 118 SF. STORAGE AT MAIN RESIDENCE. AFTER THE FACT EMERGENCY PERMIT FOR EXISTING BRIDGE.

■ A.P.N.: 243-141-008

ZONE: $LDR/1-D(20)(CZ) \mid RC-D(20')(CZ)$

■ STORIES: ONE

■ MAX BLDG. HT: 20 FT

■ GRADING: 35 CY CUT | 10 CY FILL, SEE CIVIL PLANS

■ TREE REMOVAL: NONE

■ TOPOGRAPHY: SLOPING

2022 CBC, CMC, CPC, CFC, CEC, CALIFORNIA RESIDENTIAL CODE CALIFORNIA GREEN BUILDING CODE & 2022 CALIFORNIA ENERGY CODE

■ LOT AREA: 31,695 SF (0.73 Ac.)

■ LOT COVERAGE CALCULATIONS IN LDR ZONE:

	EXISTING	PROPOSED ADDITION	PROPOSED REMOVAL	PROPOSED TOTAL
MAIN BUILDING	2015	1084	-5	3094
GUEST HOUSE	476	0	-89	387
OFFICE	0	190	0	190
GARAGE	506	170	0	676
PLAYHOUSE	69	0	0	69
SHEDS	82	0	-36	46
TOTAL	3148	1444	-130	4462

■ LOT COVERAGE "LDR ZONE" ALLOWED: 4,754.7 SF (15%)

■ LOT COVERAGE "LDR ZONE" PROPOSED: 4,462 SF (14.1%)

■ LOT COVERAGE CALCULATIONS IN RC ZONE:

	EXISTING		PROPOSED REMOVAL	PROPOSED TOTAL
MAIN BUILDING	486	0	0	486
TOTAL	486	0	0	486

■ LOT COVERAGE "RC ZONE" ALLOWED: 1,584.9 SF (5%)

■ LOT COVERAGE "RC ZONE" EXISTING: 486 SF (1.5%)

■ F.A.R. CALCULATIONS:

	EXISTING	PROPOSED ADDITION	PROPOSED REMOVAL	PROPOSED TOTAL
MAIN BUILDING	2585	938	-5	3518
GUEST HOUSE	476	0	-89	387
OFFICE	0	190	0	190
GARAGE	506	170	0	676
TOTAL	3567	1298	-94	477

Three Palm Software

■ F.A.R. ALLOWED:

6,339.6 SF (20%)

■ F.A.R. PROPOSED:

4,771 SF (15%)

DATE: JUNE 4, 2024

JUN A. SILLANO, AIA

ARCHITECTURE + PLANNING + INTERIOR DESIGN

721 LIGHTHOUSE AVE

PACIFIC GROVE CA.

93950

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EMAIL

WEB

DISCLAIMER:

STAMPS:

PROJECT/CLIENT:

PROJECT ADDRESS:

RICKARD

RESIDENCE

5 YANKEE BEACH

WAY

CARMEL, CA

93923

APN: 243-141-008

(831) 646-1261

(831) 646-1290

idg@idg-inc.net

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REVISIONS:

1 OCTOBER 1, 2024 PLANNING DEPT. SUBMITTAL

2\ NOVEMBER 20, 2024

PLANNING DEPT. SUBMITTAL 3 JANUARY 10, 2025

PLANNING DEPT. SUBMITTAL 4\ <u>FEBRUARY 26, 2025</u>


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APPLICATION REQ. SUBMITTAL

SITE PLAN **EXISTING**

SHEET NO.

A1.0

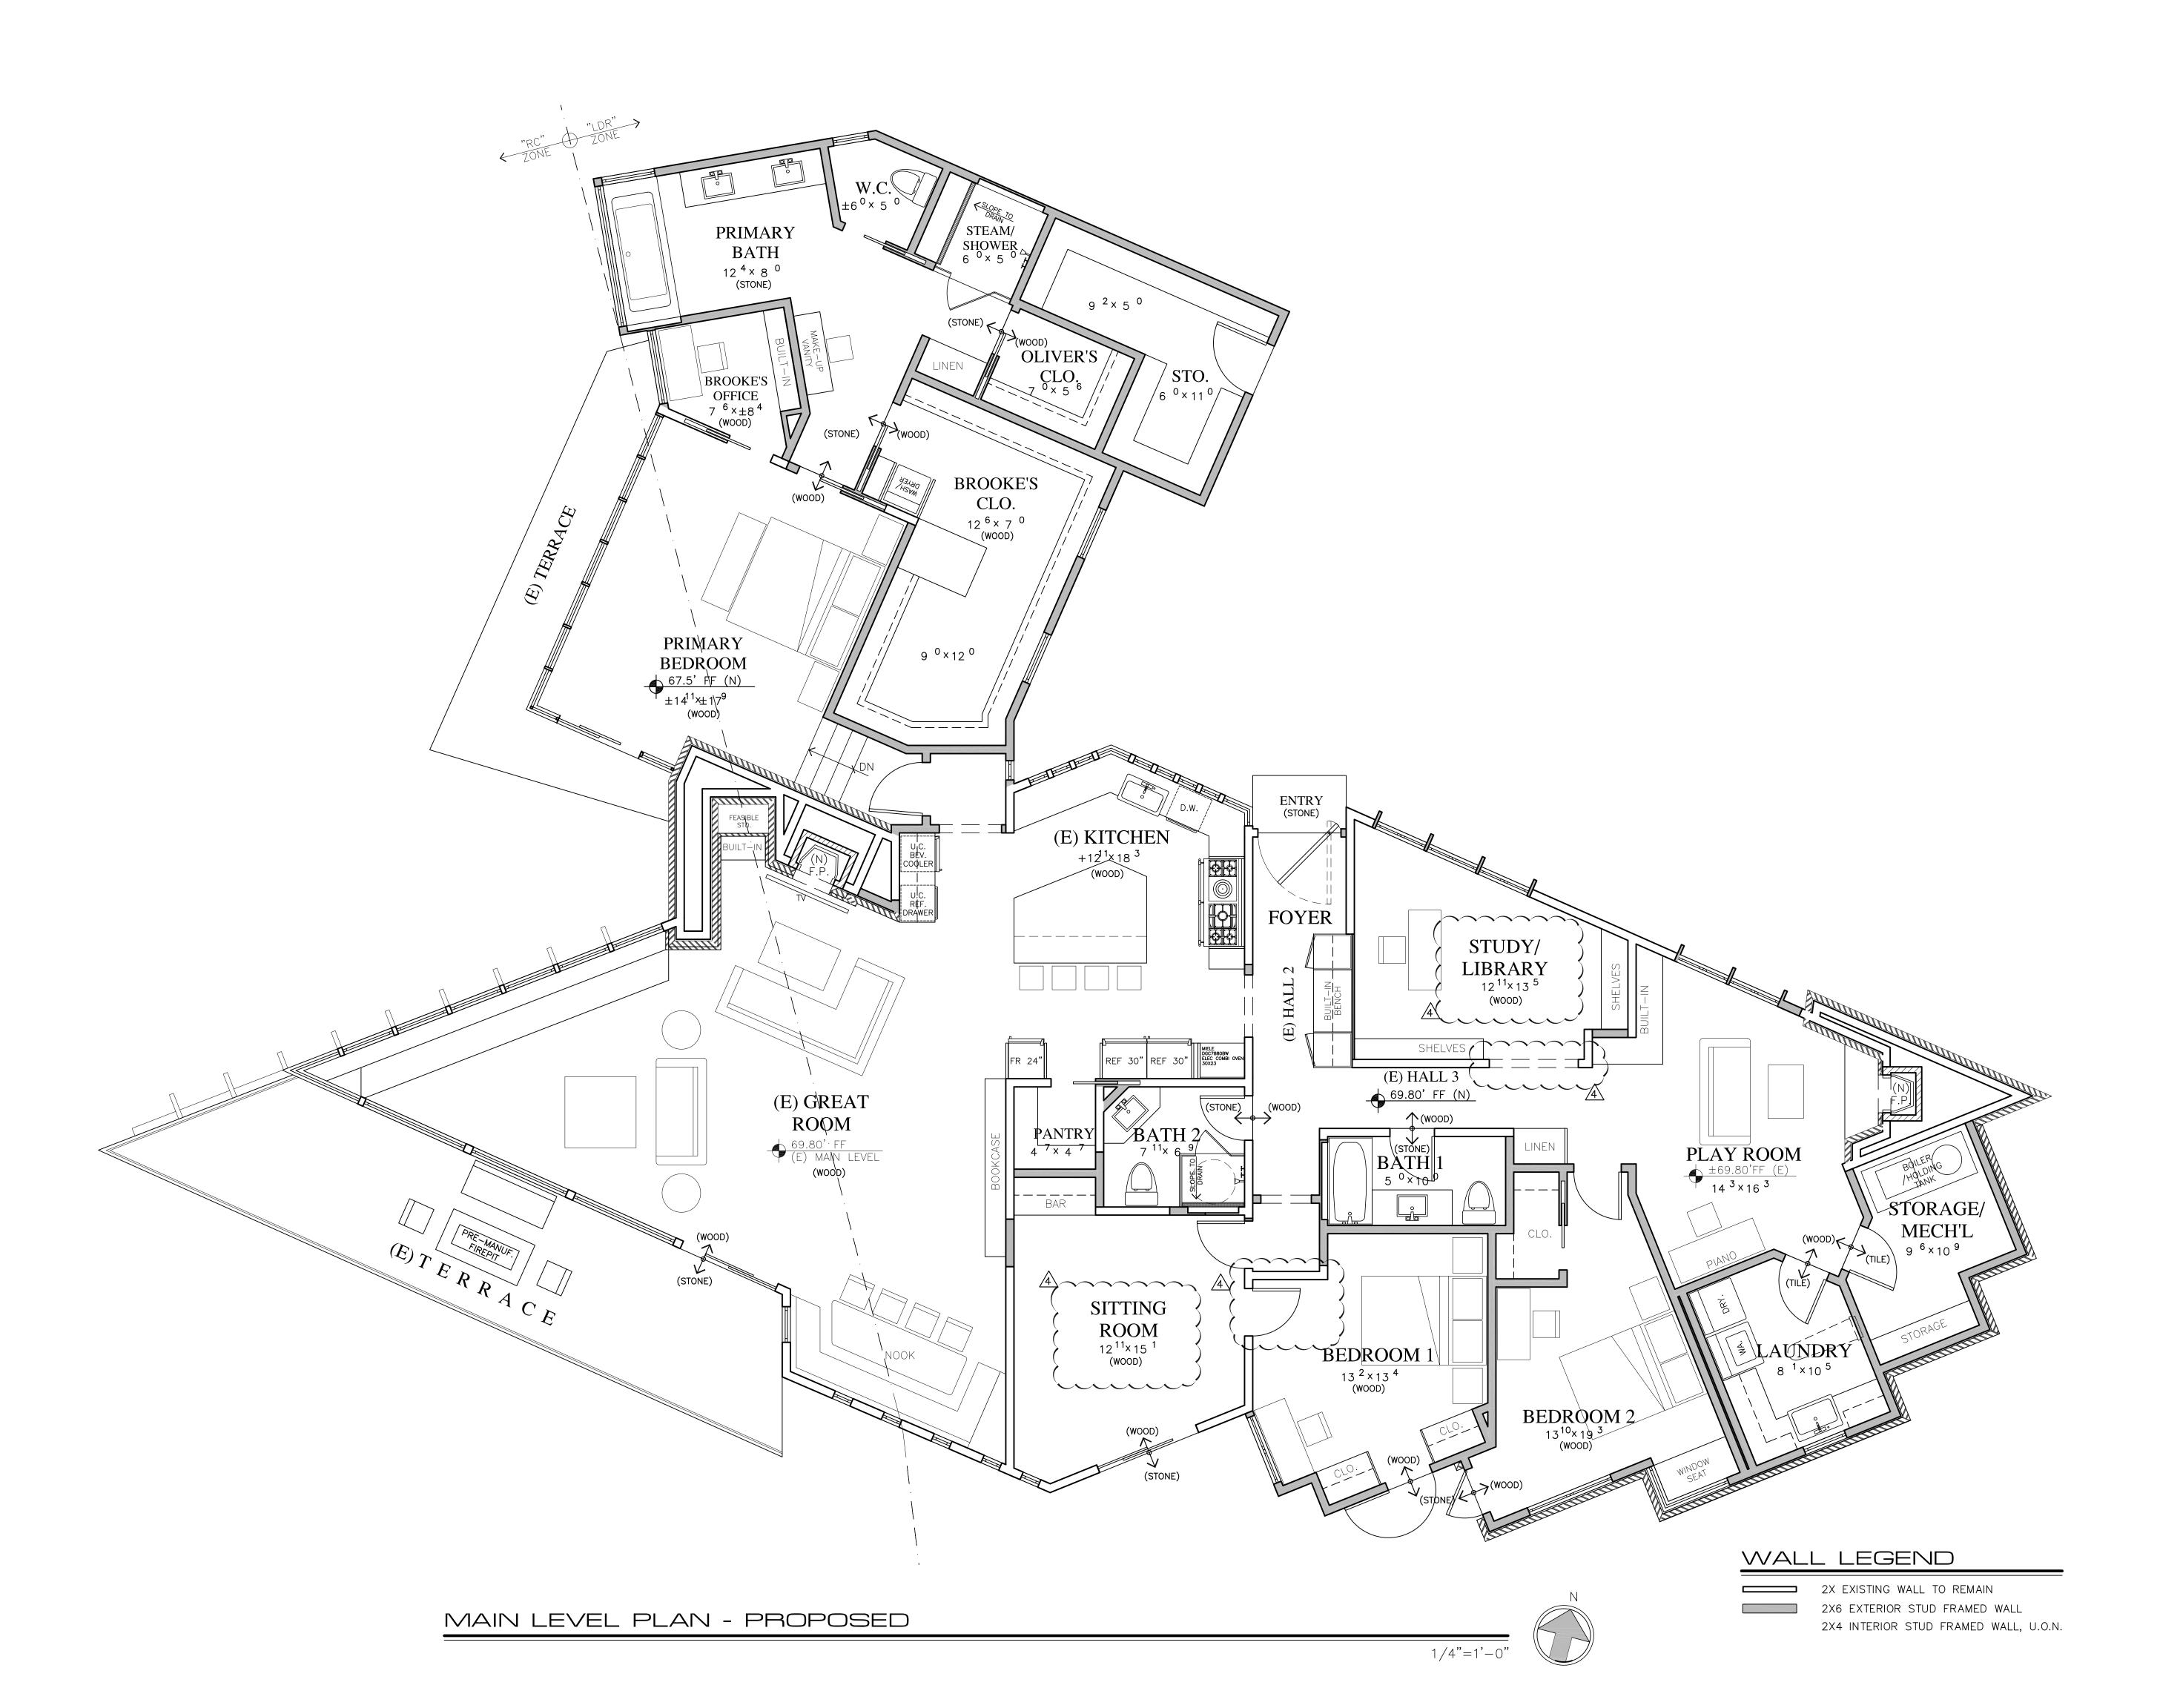

JUN A. SILLANO, AIA



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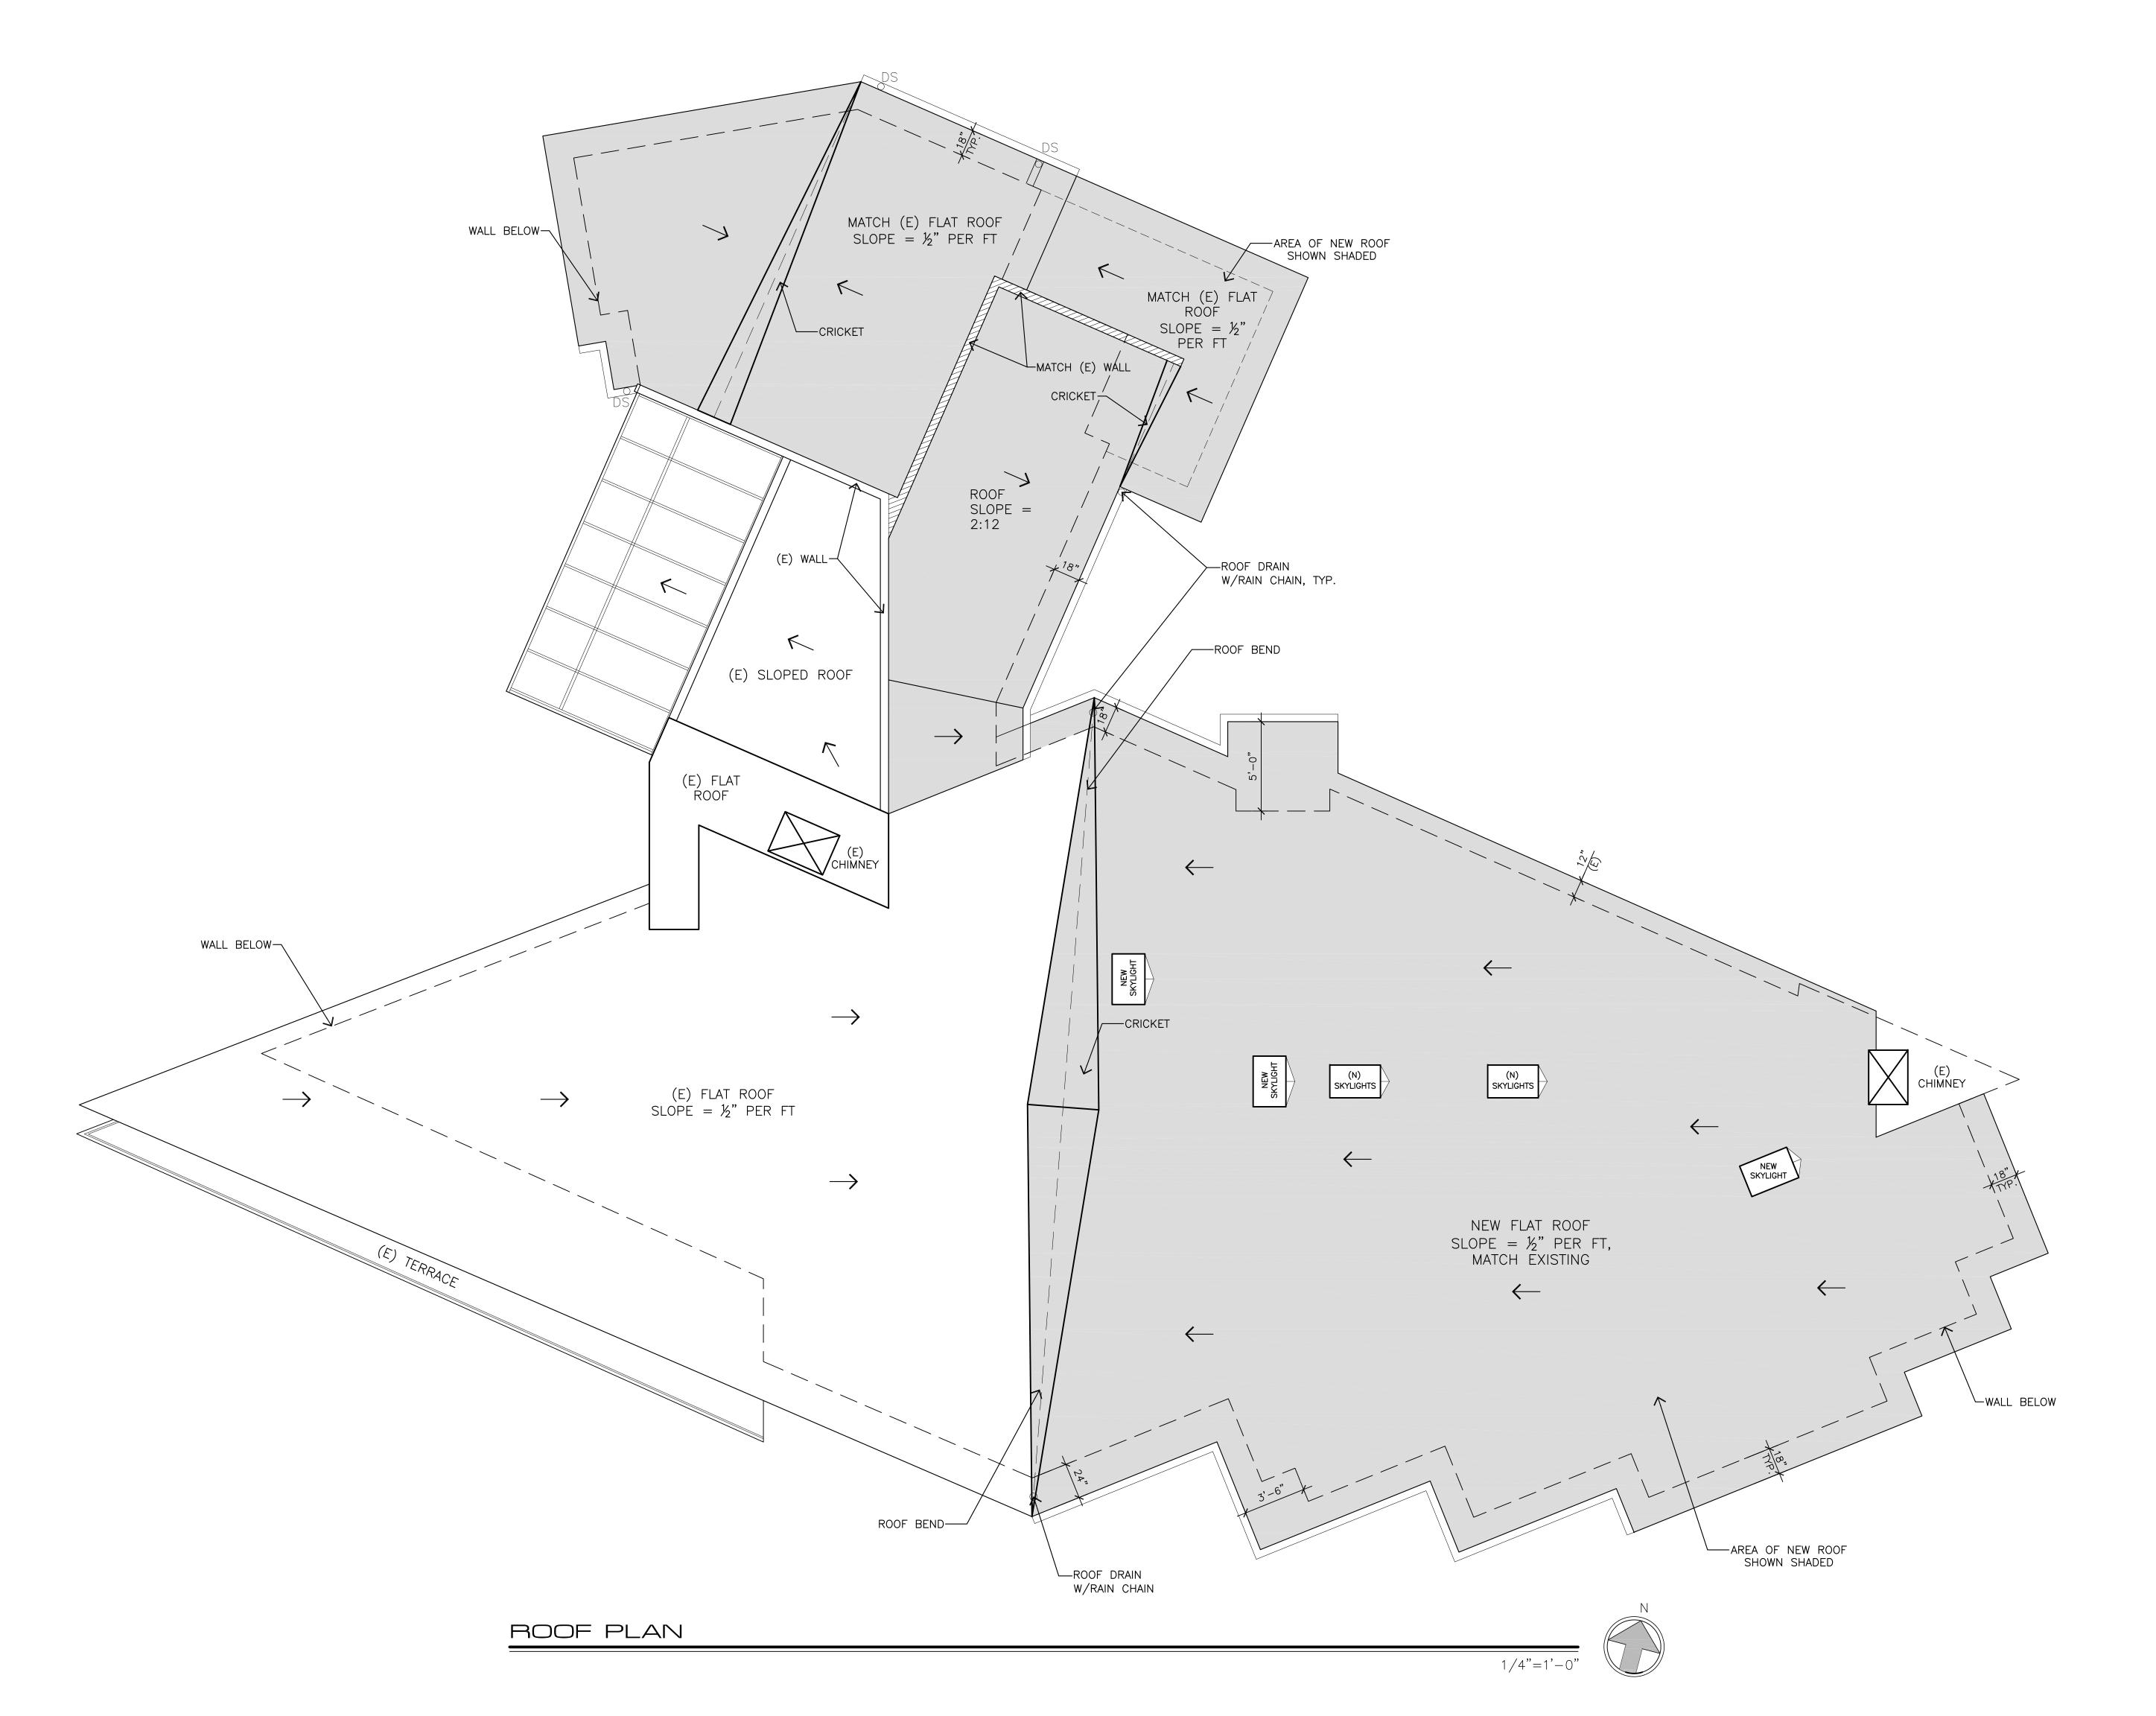
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MAIN LEVEL

PLAN

SHEET NO.

A2.0



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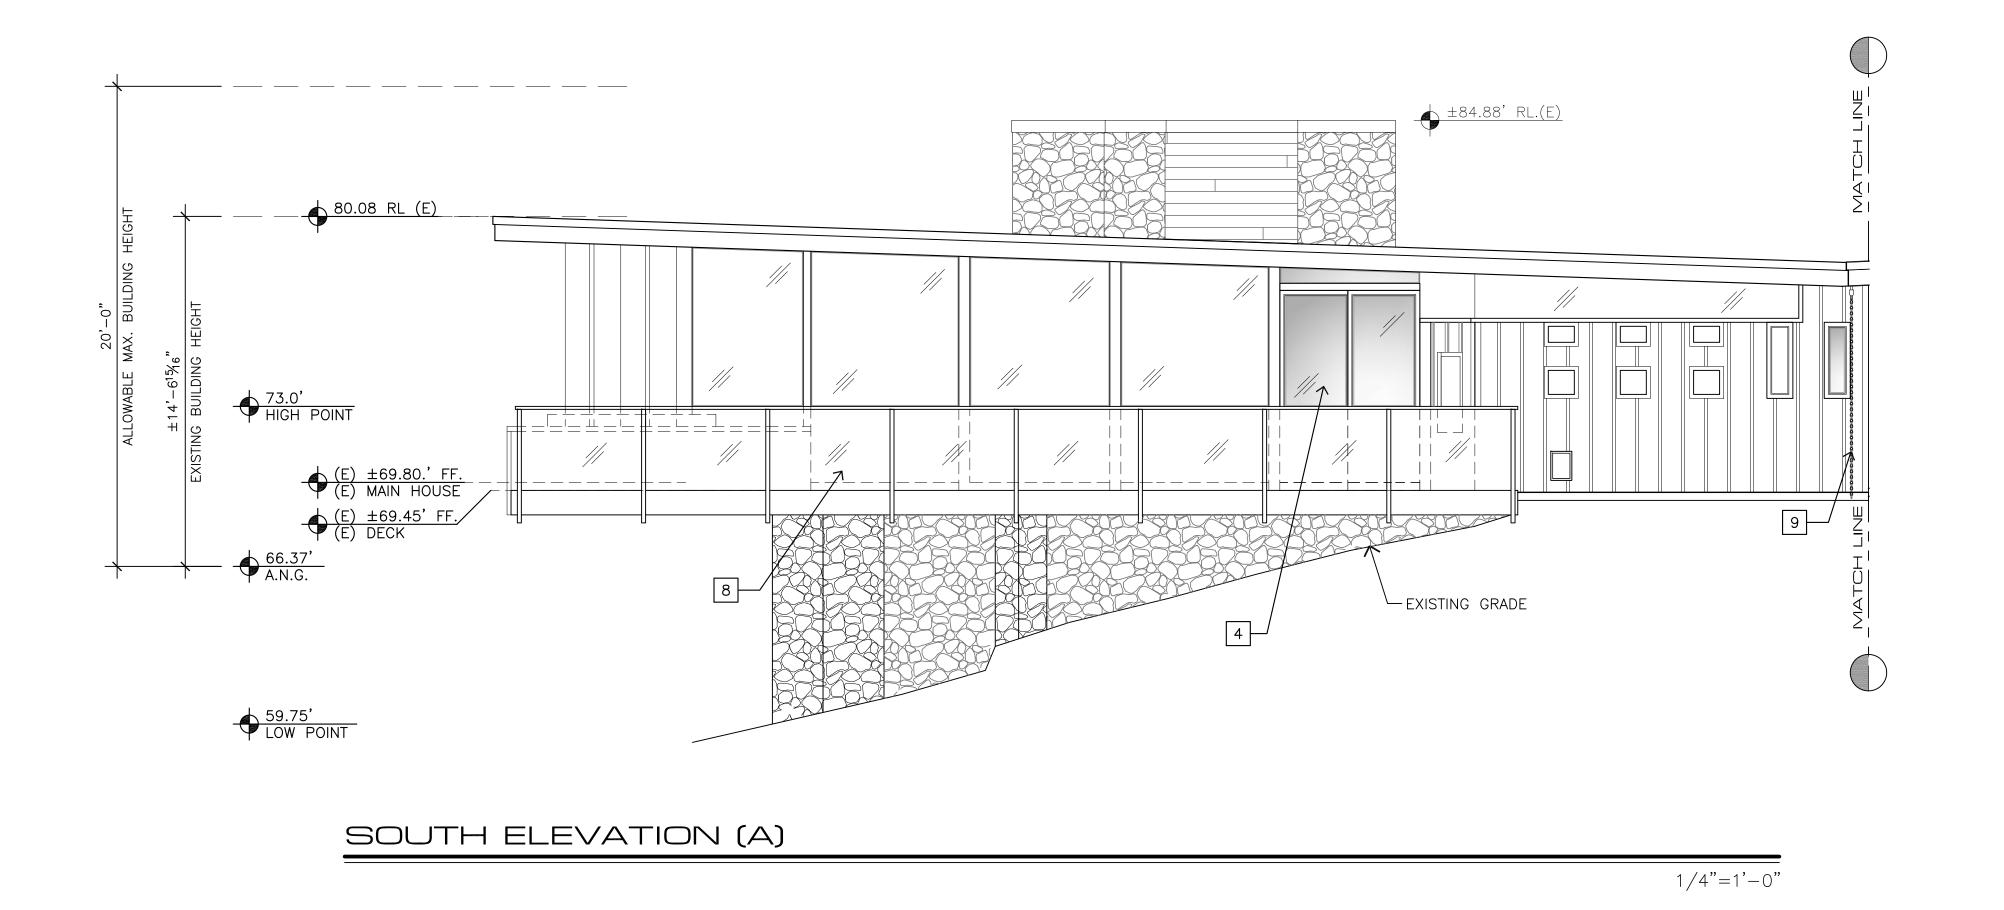
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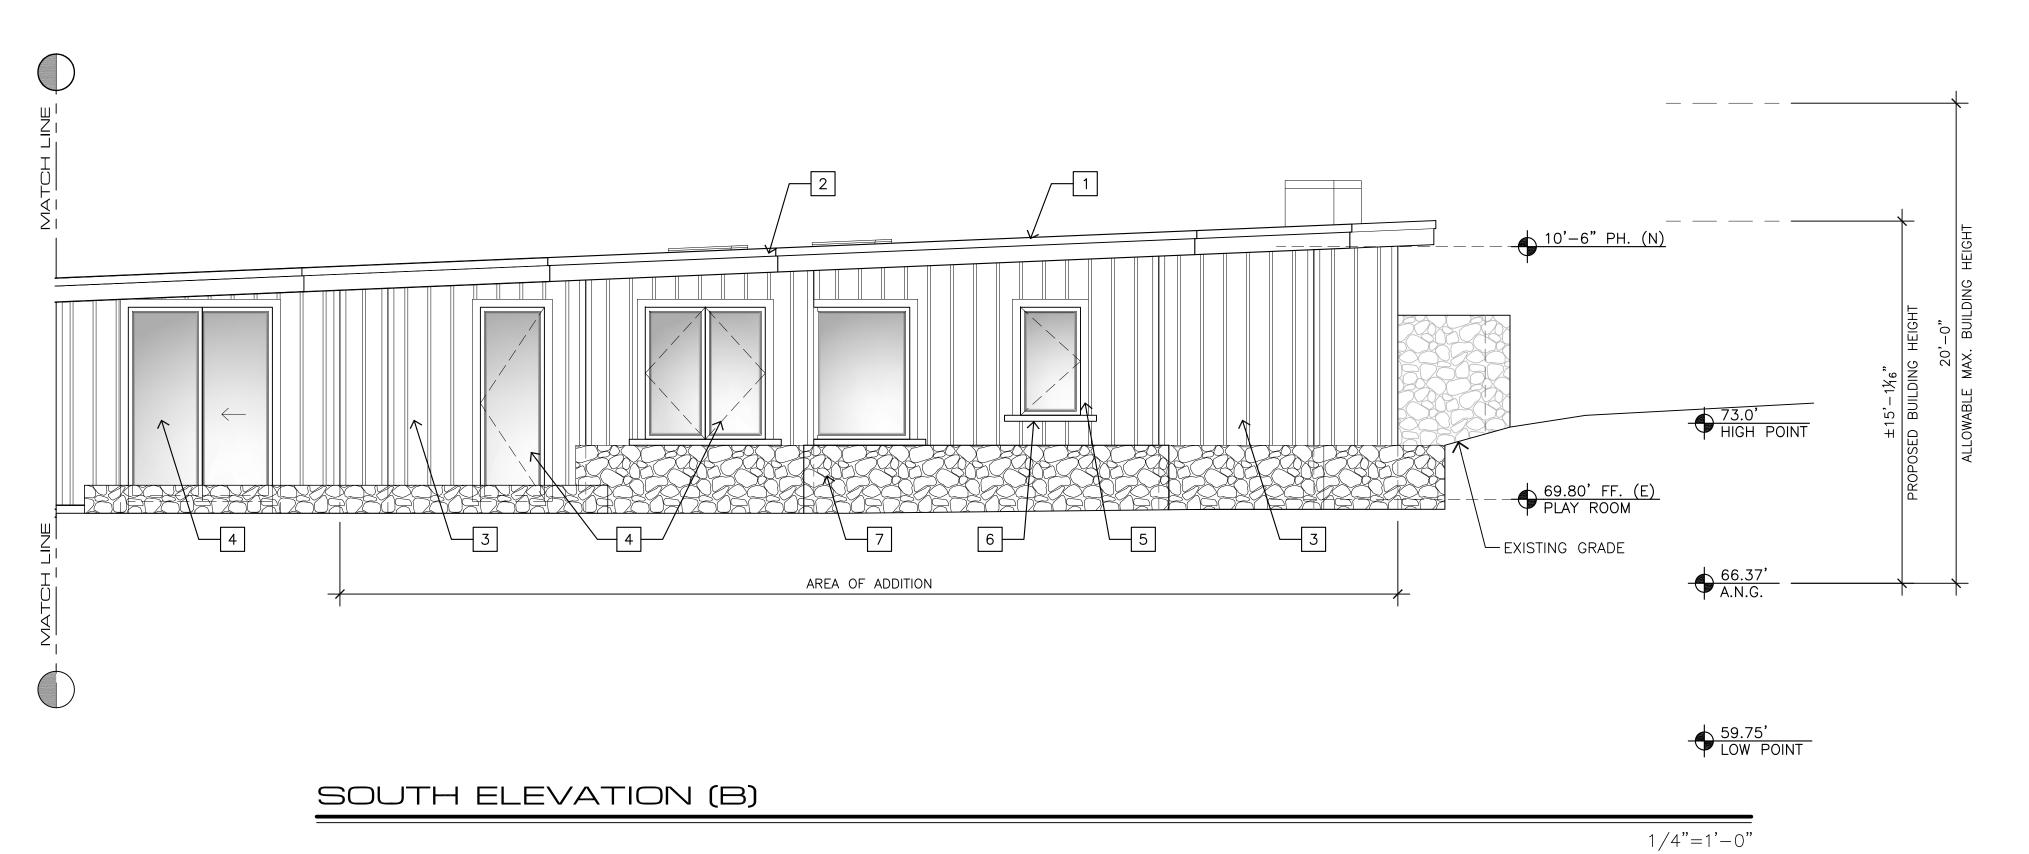
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ROOF

PLAN SHEET NO.

A5.0






EXTERIOR FINISH LEGEND

- 1 BUILT UP ROOFING MATCH EXISTING
- 2X12 CEDAR FASCIA WITH GALVANIZED METAL GUTTER & DOWNSPOUTS MATCH EXISTING
- JAMES HARDIE PAINTED BOARD AND BATTEN SIDING
- METAL CLAD WOOD EXTERIOR DOORS & WINDOWS

 MATCH EXISTING
- 5 1X4 PAINTED CEDAR TRIM
- 6 4X PAINTED CEDAR SILL
- 7 RANDOM RIVER ROCK STONE MATCH EXISTING
- REPAIR/REPLACE AS NEEDED, SIMULATED WOOD GUARDRAIL WITH ½" TEMPERED GLASS MATCH EXISTING

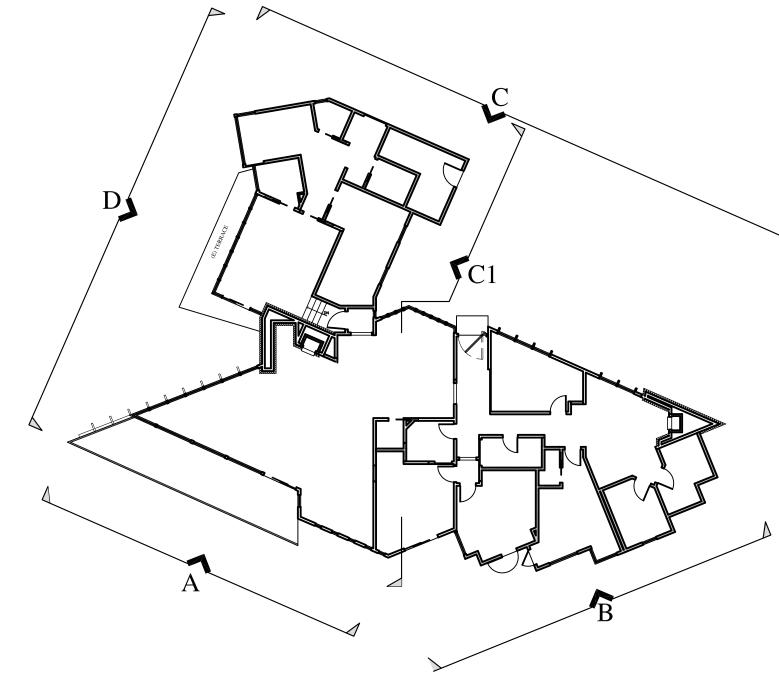

KEY PLAN

1/16"=1'-0"

JUN A. SILLANO, AIA

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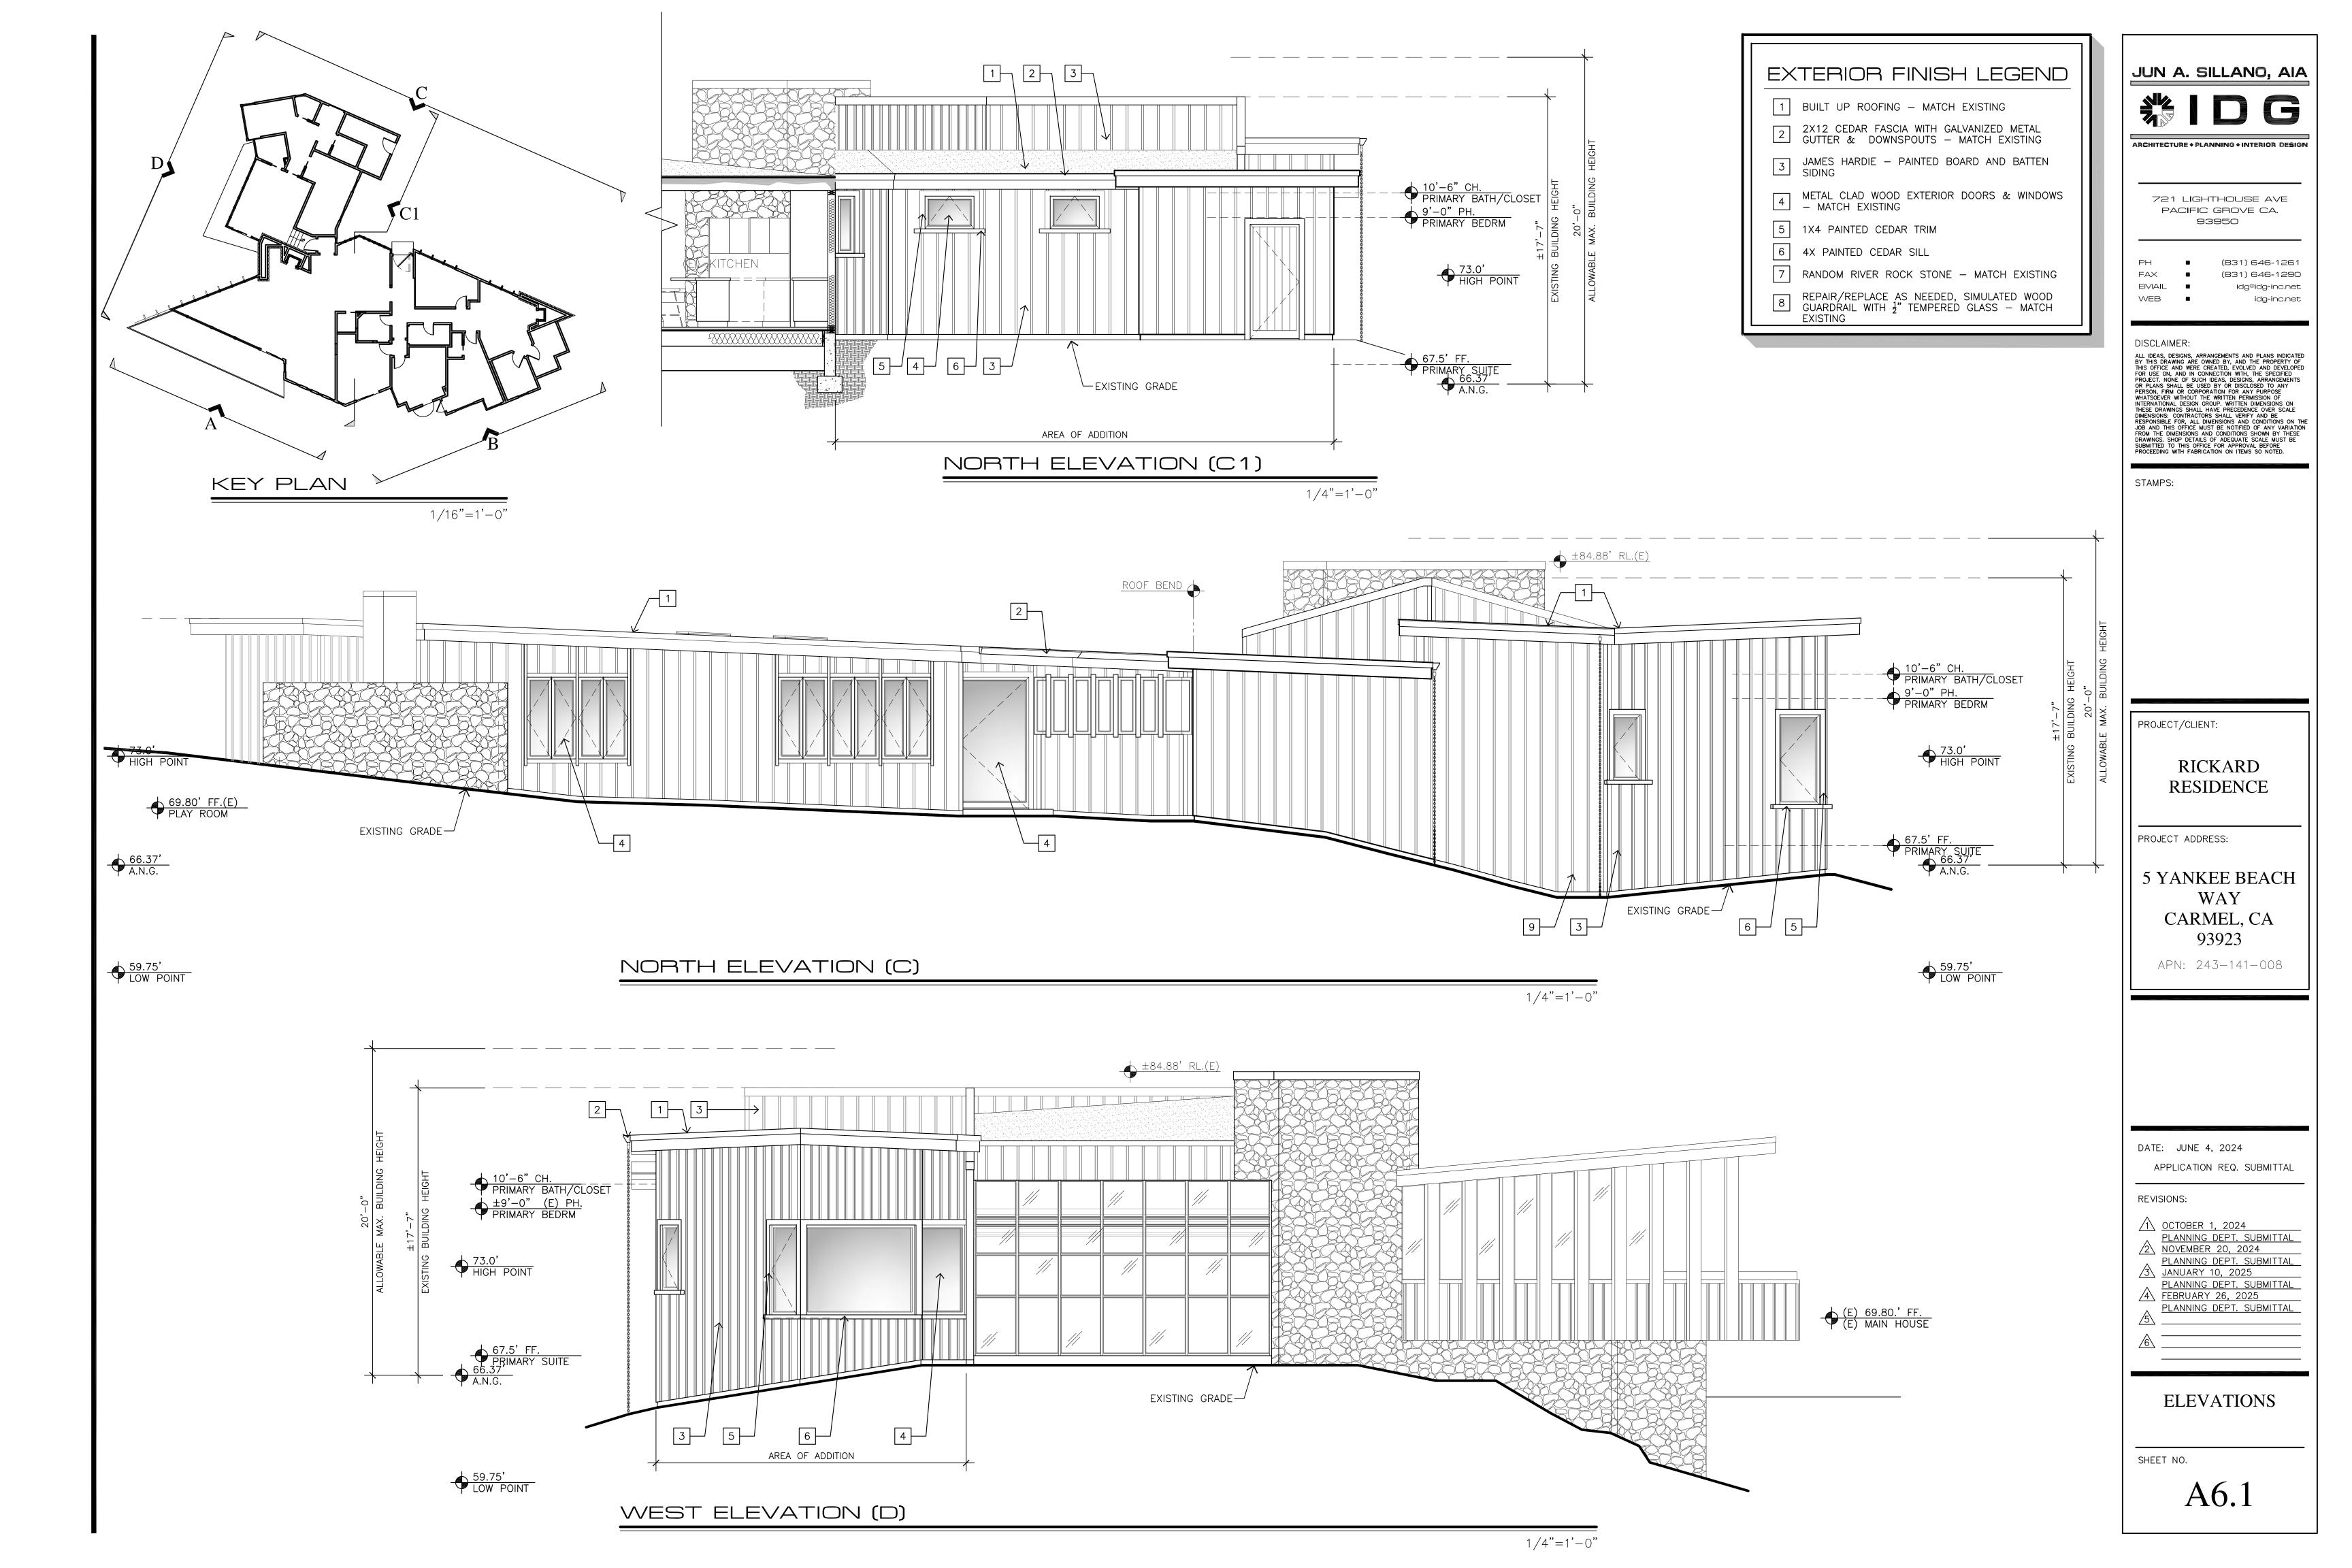
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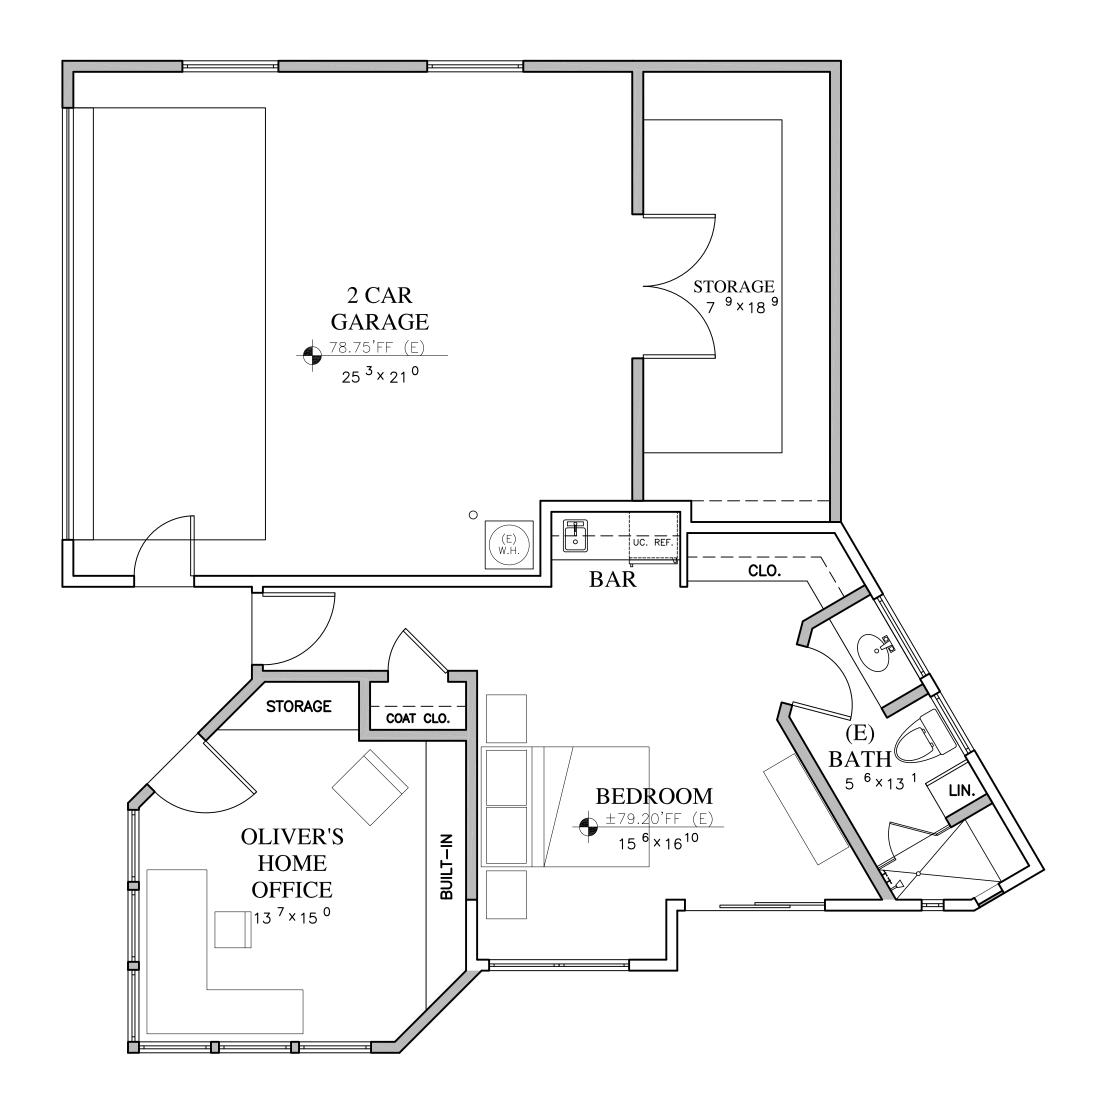
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ELEVATIONS

SHEET NO.

A6.0






GUESTHOUSE, OFFICE AND GARAGE - PROPOSED PLAN



1/4"=1'-0"

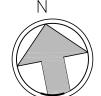

WALL LEGEND

2X EXISTING WALL TO REMAIN 2X6 EXTERIOR STUD FRAMED WALL 2X4 INTERIOR STUD FRAMED WALL, U.O.N. JUN A. SILLANO, AIA



721 LIGHTHOUSE AVE PACIFIC GROVE CA.

ARCHITECTURE + PLANNING + INTERIOR DESIGN

93950

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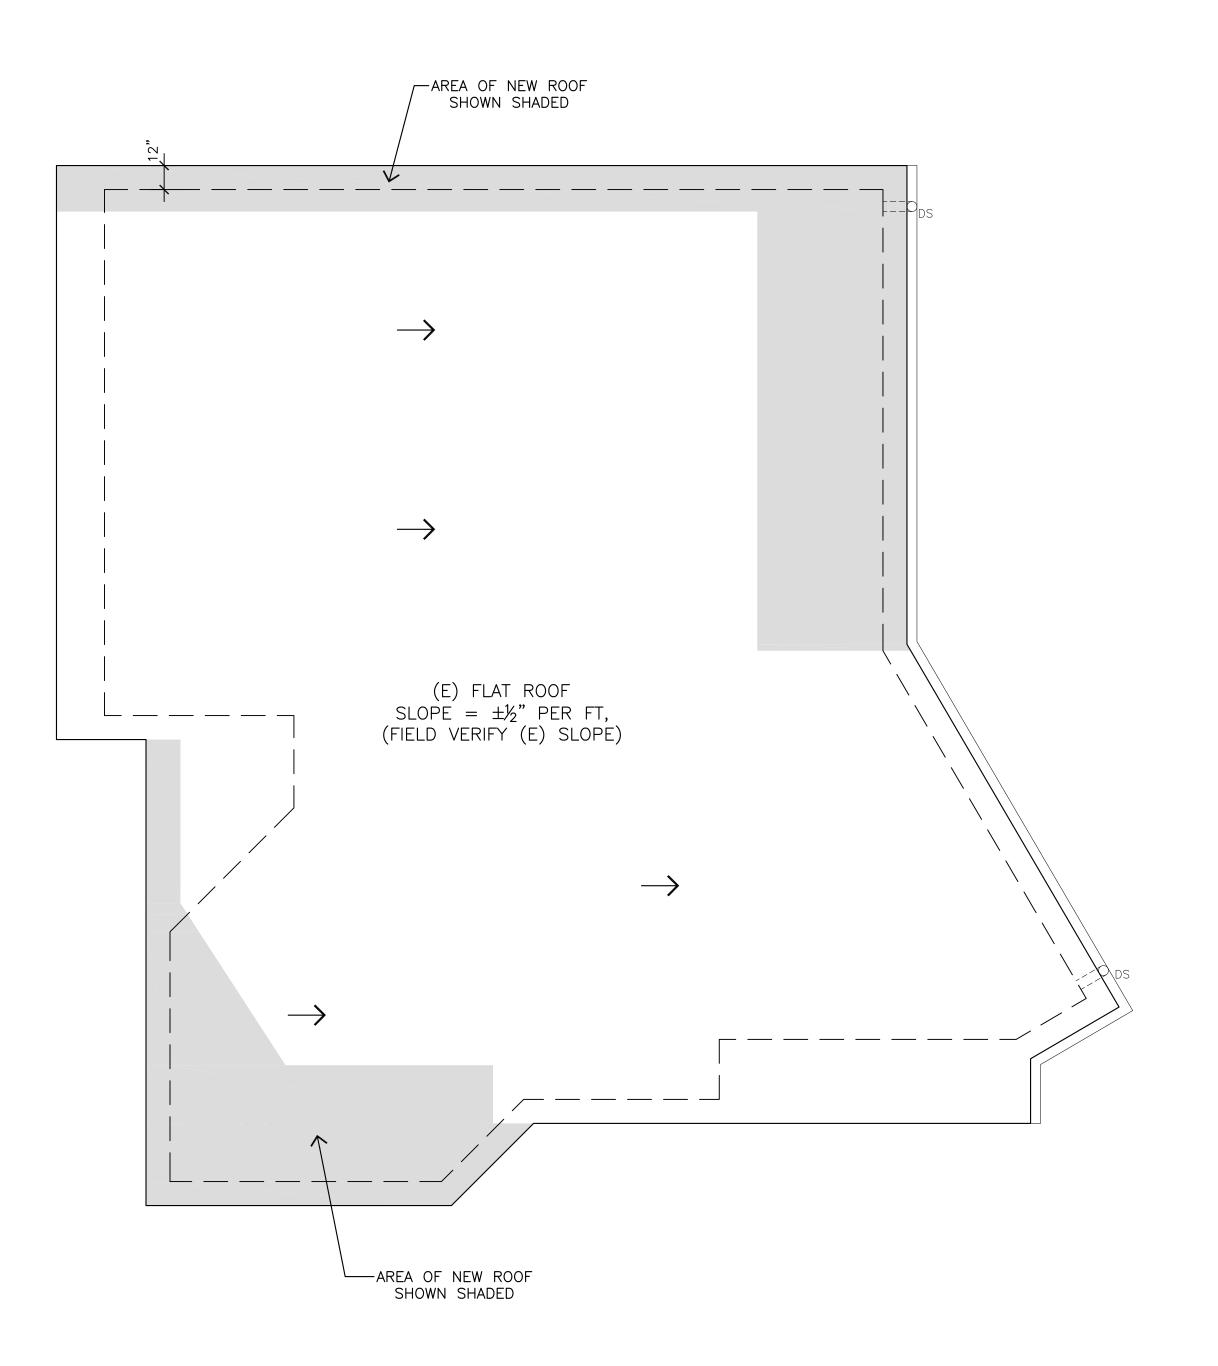
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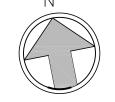
GUESTHOUSE, OFFICE AND GARAGE PLAN

SHEET NO.

GH2.0



GUESTHOUSE, OFFICE AND GARAGE - ROOF PLAN



1/4"=1'-0"

WALL LEGEND

2X EXISTING WALL TO REMAIN 2X6 EXTERIOR STUD FRAMED WALL 2X4 INTERIOR STUD FRAMED WALL, U.O.N.



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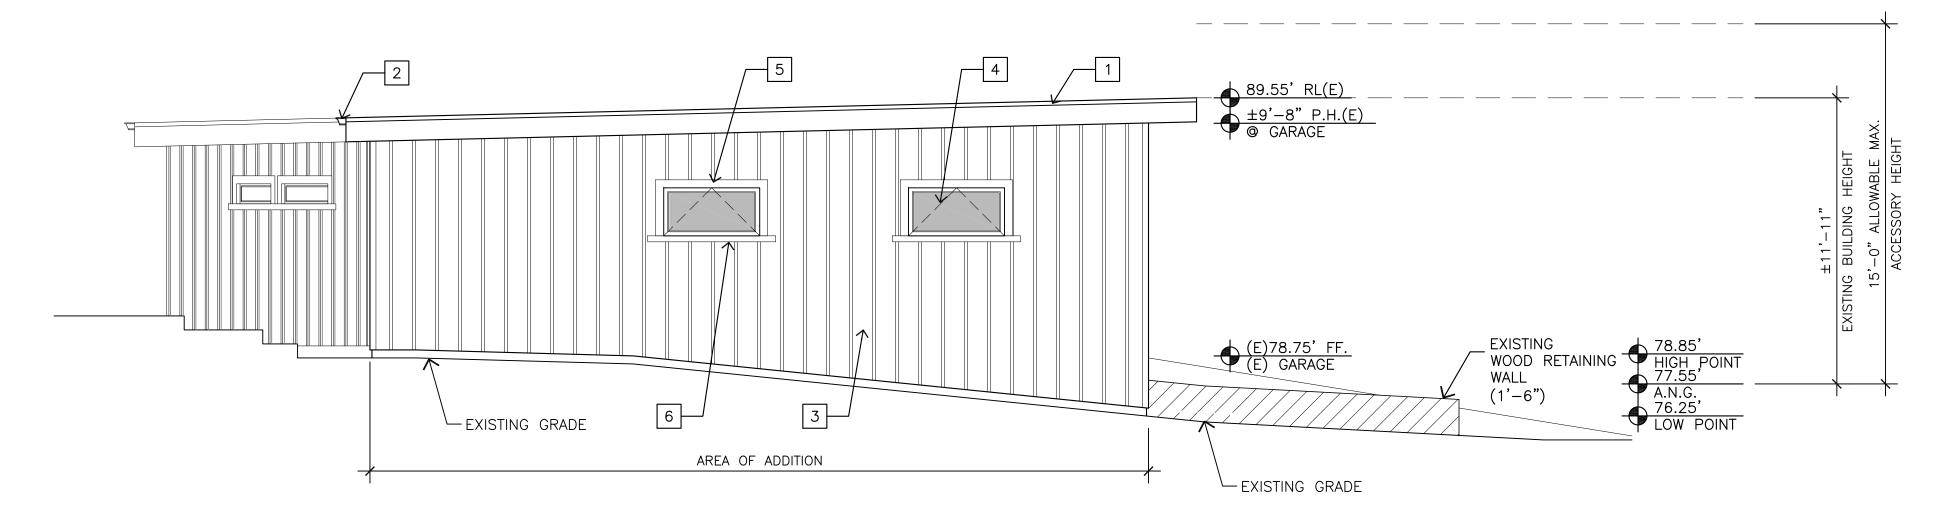
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GUESTHOUSE, OFFICE AND GARAGE **ROOF PLAN**


SHEET NO.

GH3.0



NORTH ELEVATION - GUESTHOUSE, OFFICE AND GARAGE

1/4"=1'-0"

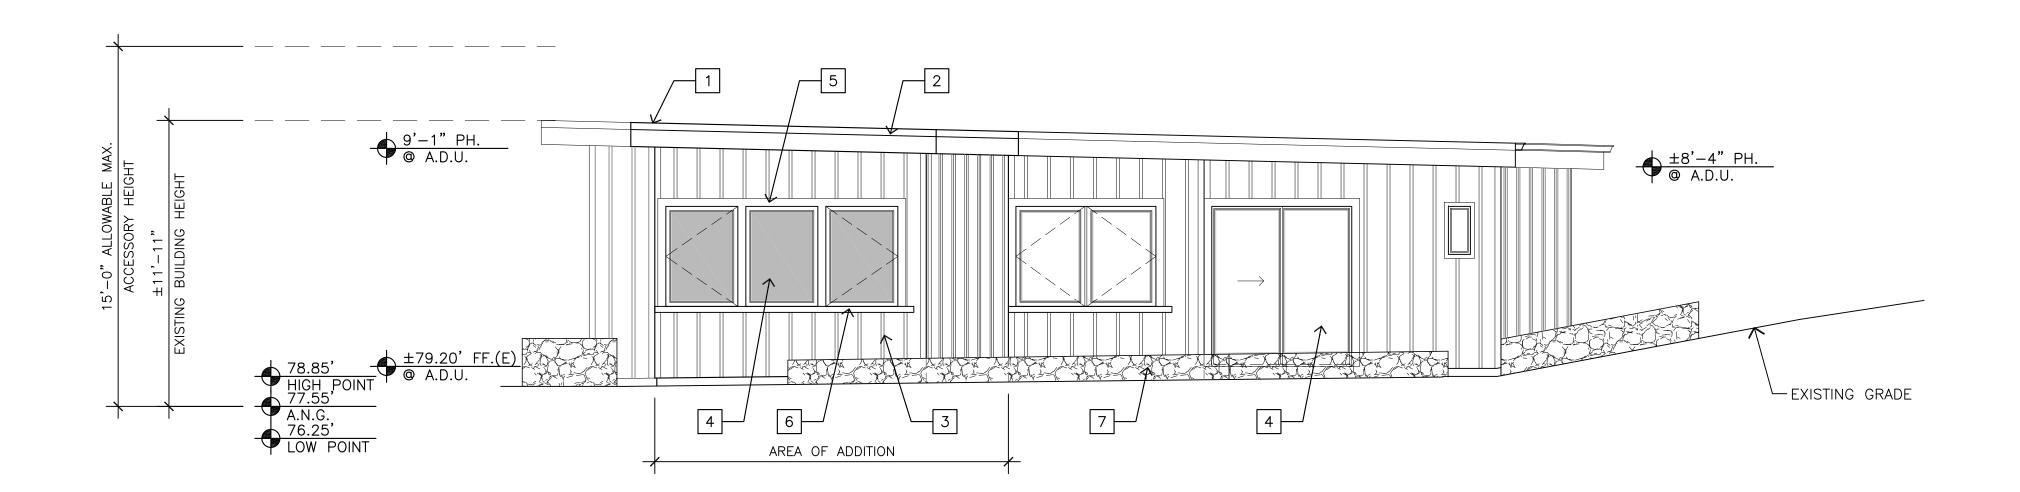

SOUTH ELEVATION - GUESTHOUSE, OFFICE AND GARAGE

1/4"=1'-0"

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STAMPS:

EXTERIOR FINISH LEGEND

1 BUILT UP ROOFING - MATCH EXISTING

5 1X4 PAINTED CEDAR TRIM

6 4X PAINTED CEDAR SILL

2X12 CEDAR FASCIA WITH GALVANIZED METAL GUTTER & DOWNSPOUTS — MATCH EXISTING

JAMES HARDIE - PAINTED BOARD AND BATTEN

METAL CLAD WOOD EXTERIOR DOORS & WINDOWS

- MATCH EXISTING

7 RANDOM RIVER ROCK STONE - MATCH EXISTING

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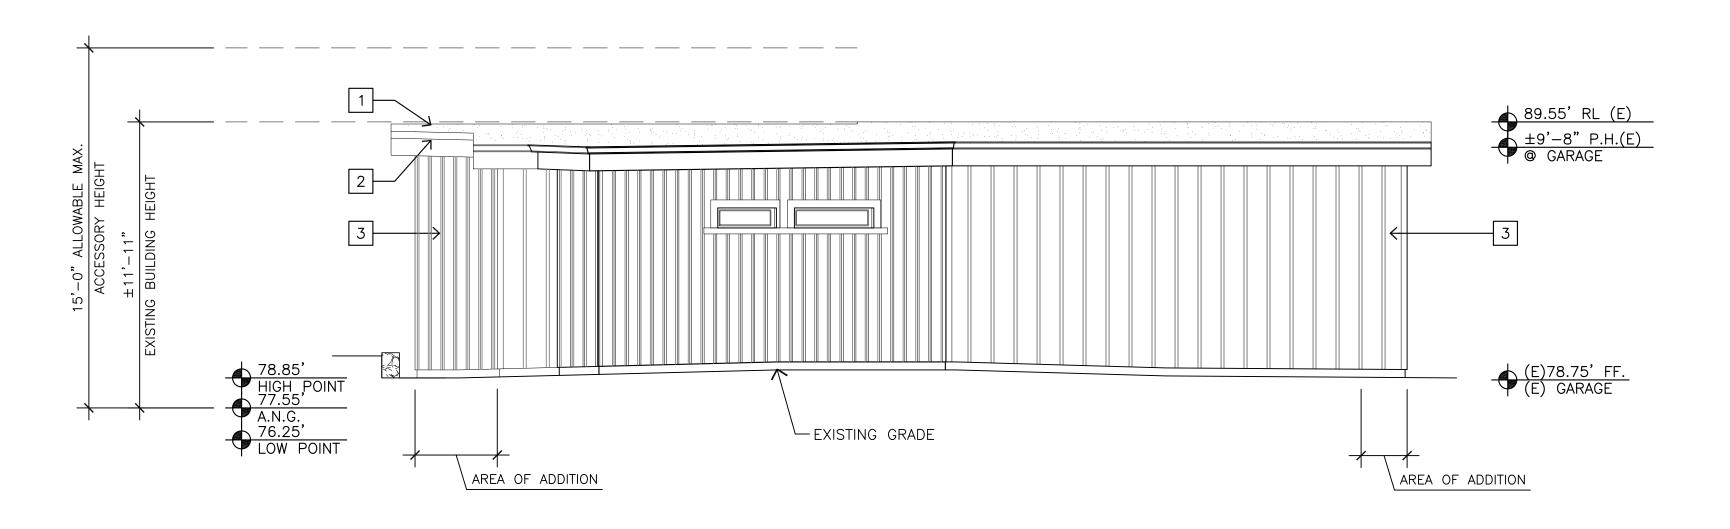
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GUESTHOUSE, OFFICE

AND GARAGE ELEV.


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GH4.0



EAST ELEVATION - GUESTHOUSE, OFFICE AND GARAGE

1/4"=1'-0"

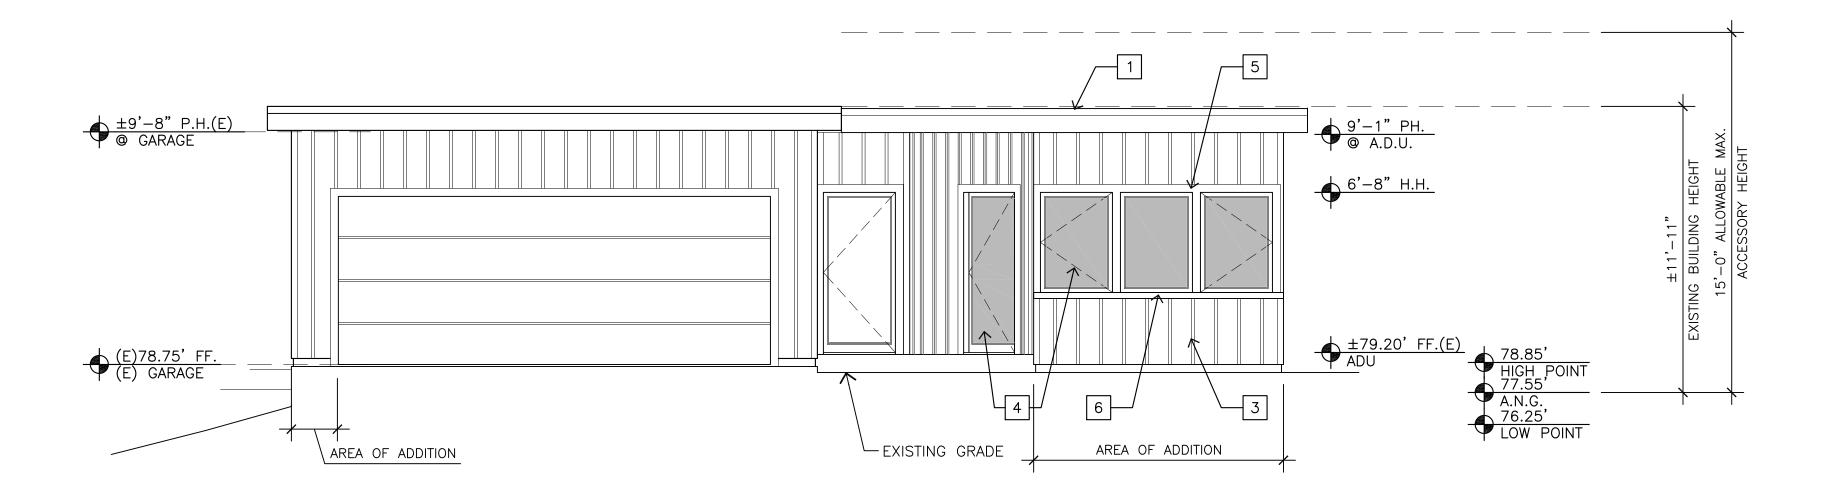

WEST ELEVATION - GUESTHOUSE, OFFICE AND GARAGE

1/4"=1'-0"





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JAMES HARDIE — PAINTED BOARD AND BATTEN SIDING

METAL CLAD WOOD EXTERIOR DOORS & WINDOWS

- MATCH EXISTING

RANDOM RIVER ROCK STONE - MATCH EXISTING

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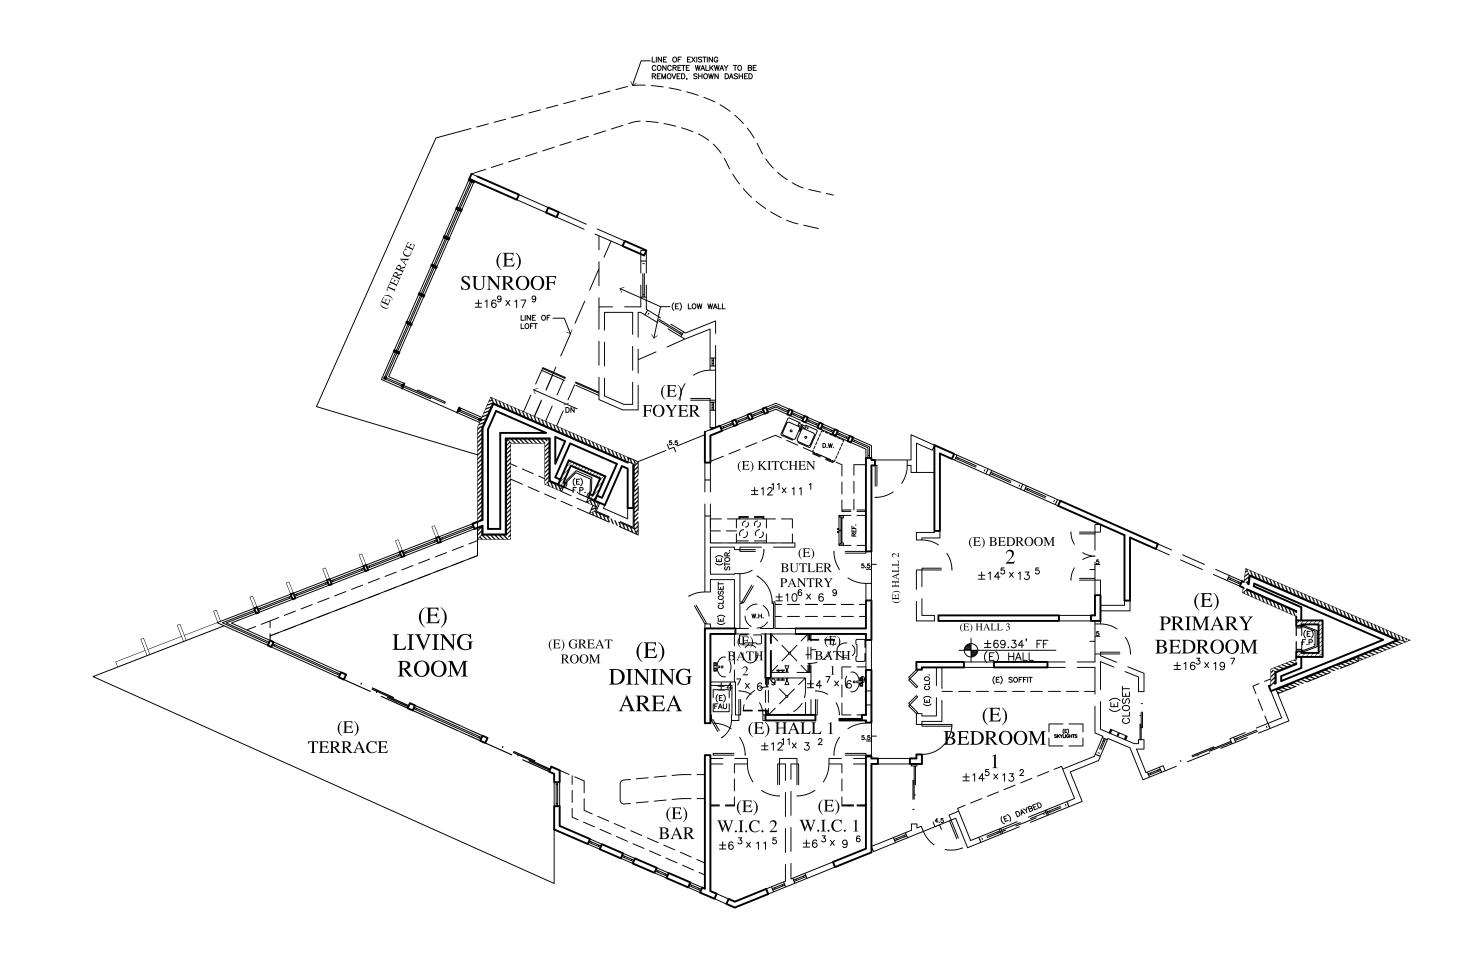
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GUESTHOUSE, OFFICE AND GARAGE ELEV.


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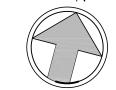


MAIN RESIDENCE EXISTING-DEMOLITION PLAN





GARAGE AND GUESTHOUSE EXISTING-DEMOLITION PLAN

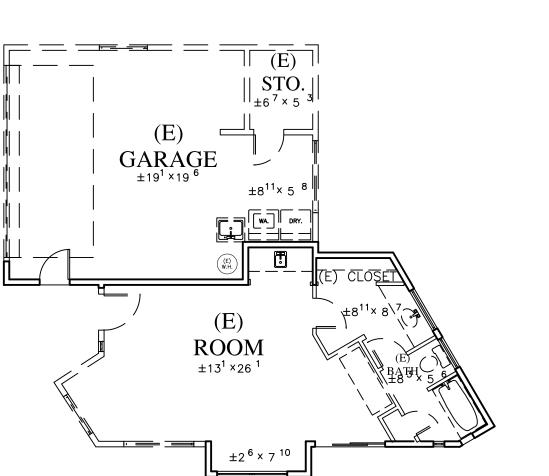

WALL LEGEND

2X EXISTING WALL TO REMAIN (E) DOOR OR WINDOW TO BE REMOVED □□□□□□ 2X EXISTING WALL TO BE REMOVED

JUN A. SILLANO, AIA



ARCHITECTURE + PLANNING + INTERIOR DESIGN

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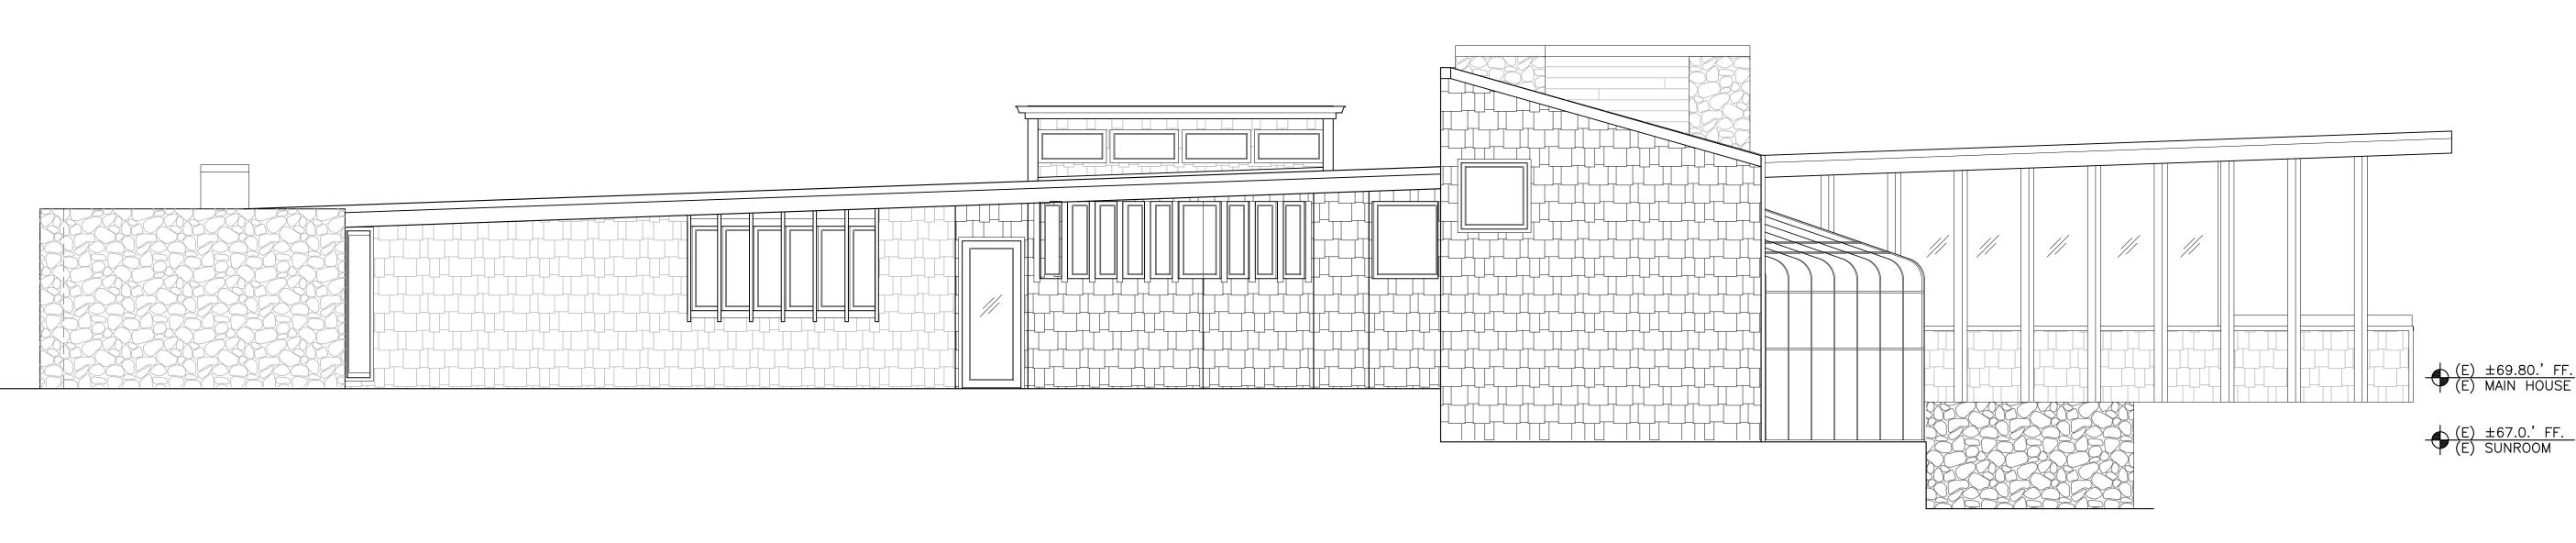
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MAIN & G.H. EXIST.-DEMO. PLAN


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D1.0



NORTH ELEVATION - MAIN HOUSE EXISTING

1/4"=1'-0"

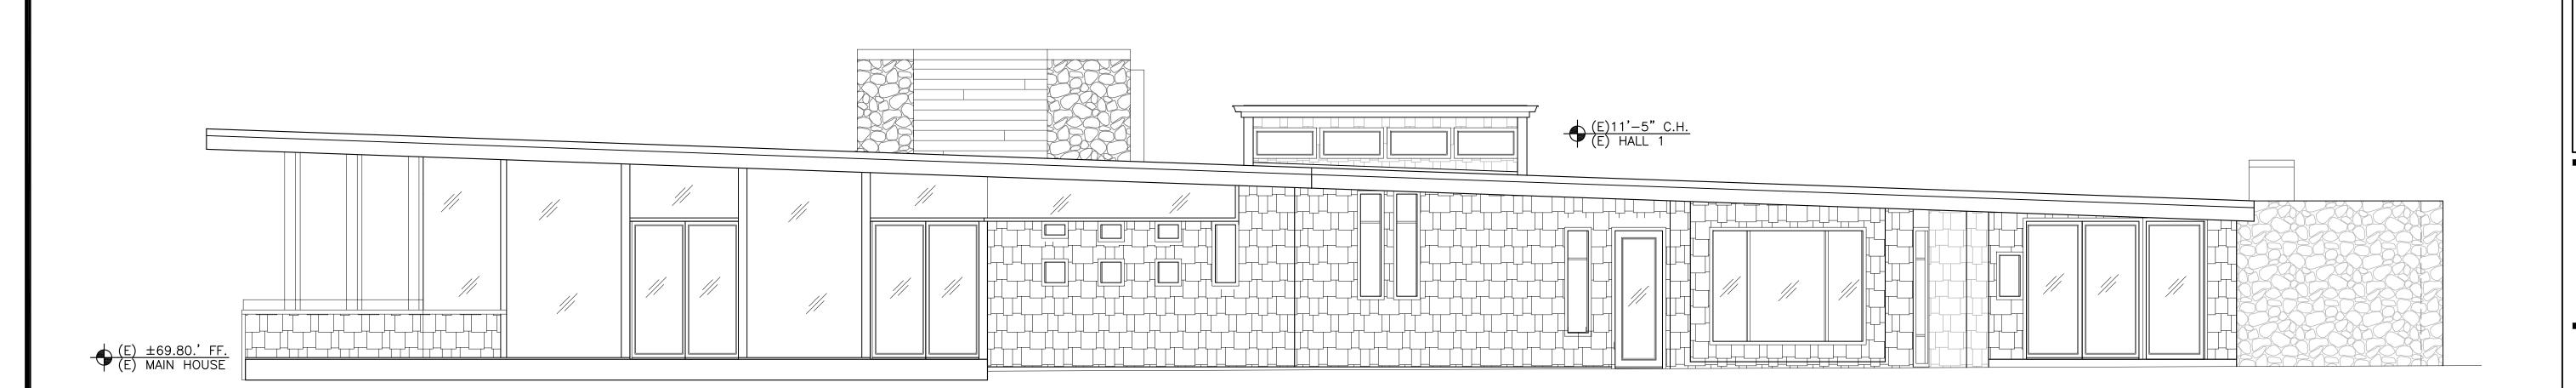

SOUTH ELEVATION - MAIN HOUSE EXISTING

1/4"=1'-0"

JUN A. SILLANO, AIA

SILLANO, AIA

ARCHITECTURE + PLANNING + INTERIOR DESIGN

721 LIGHTHOUSE AVE PACIFIC GROVE CA. 93950

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DISCLAIMER:

ALL IDEAS, DESIGNS, ARRANGEMENTS AND PLANS INDICATED BY THIS DRAWING ARE OWNED BY, AND THE PROPERTY OF THIS OFFICE AND WERE CREATED, EVOLVED AND DEVELOPED FOR USE ON, AND IN CONNECTION WITH, THE SPECIFIED PROJECT. NONE OF SUCH IDEAS, DESIGNS, ARRANGEMENTS OR PLANS SHALL BE USED BY OR DISCLOSED TO ANY PERSON, FIRM OR CORPORATION FOR ANY PURPOSE WHATSOEVER WITHOUT THE WRITTEN PERMISSION OF INTERNATIONAL DESIGN GROUP. WRITTEN DIMENSIONS ON THESE DRAWINGS SHALL HAVE PRECEDENCE OVER SCALE DIMENSIONS: CONTRACTORS SHALL VERIFY AND BE RESPONSIBLE FOR, ALL DIMENSIONS AND CONDITIONS ON THE JOB AND THIS OFFICE MUST BE NOTIFIED OF ANY VARIATION FROM THE DIMENSIONS AND CONDITIONS SHOWN BY THESE DRAWINGS. SHOP DETAILS OF ADEQUATE SCALE MUST BE SUBMITTED TO THIS OFFICE FOR APPROVAL BEFORE PROCEEDING WITH FABRICATION ON ITEMS SO NOTED.

STAMPS:

PROJECT/CLIENT:

RICKARD RESIDENCE

PROJECT ADDRESS:

5 YANKEE BEACH WAY CARMEL, CA 93923

APN: 243-141-008

DATE: JUNE 4, 2024

APPLICATION REQ. SUBMITTAL

REVISIONS:

OCTOBER 1, 2024
PLANNING DEPT. SUBMITTAL
NOVEMBER 20, 2024

PLANNING DEPT. SUBMITTAL

JANUARY 10, 2025

JANUARY 10, 2025

PLANNING DEPT. SUBMITTAL

FEBRUARY 26, 2025


PLANNING DEPT. SUBMITTAL

5 -

MAIN HOUSE EXISTING ELEVATION


SHEET NO.

D2.0

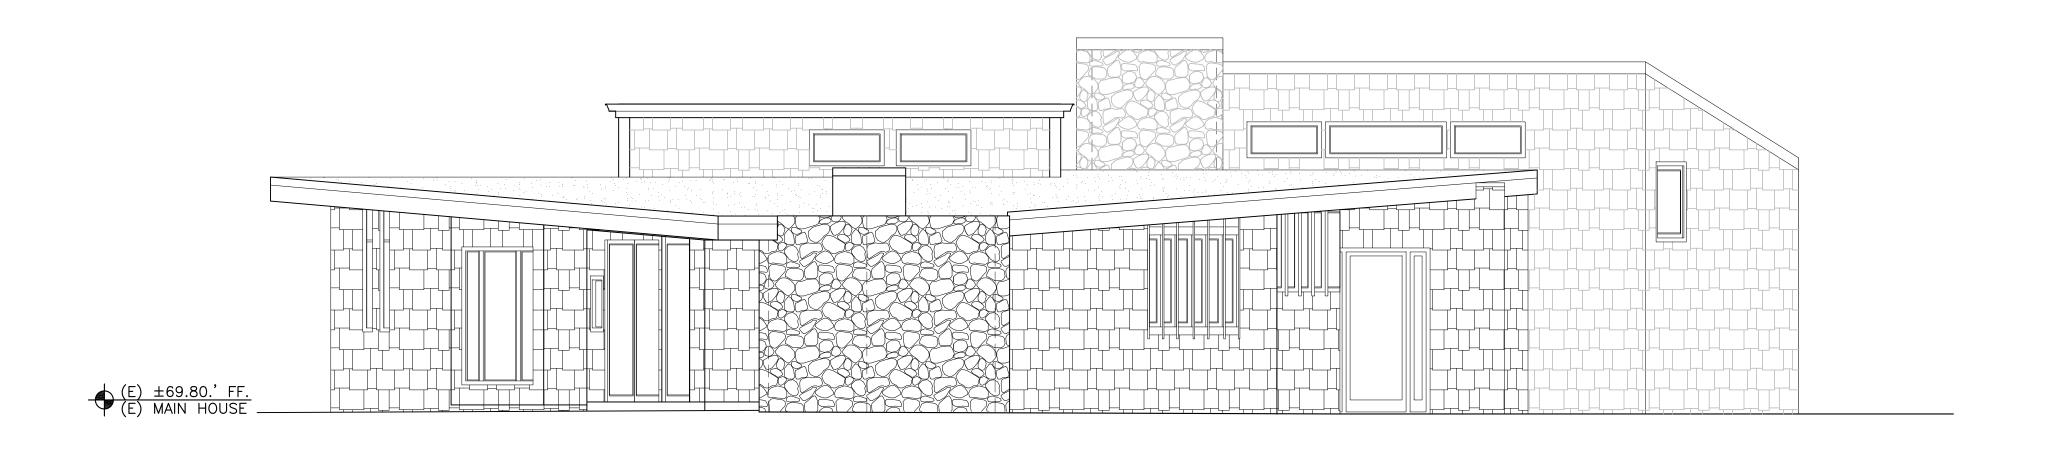

EAST ELEVATION - MAIN HOUSE EXISTING

1/4"=1'-0"

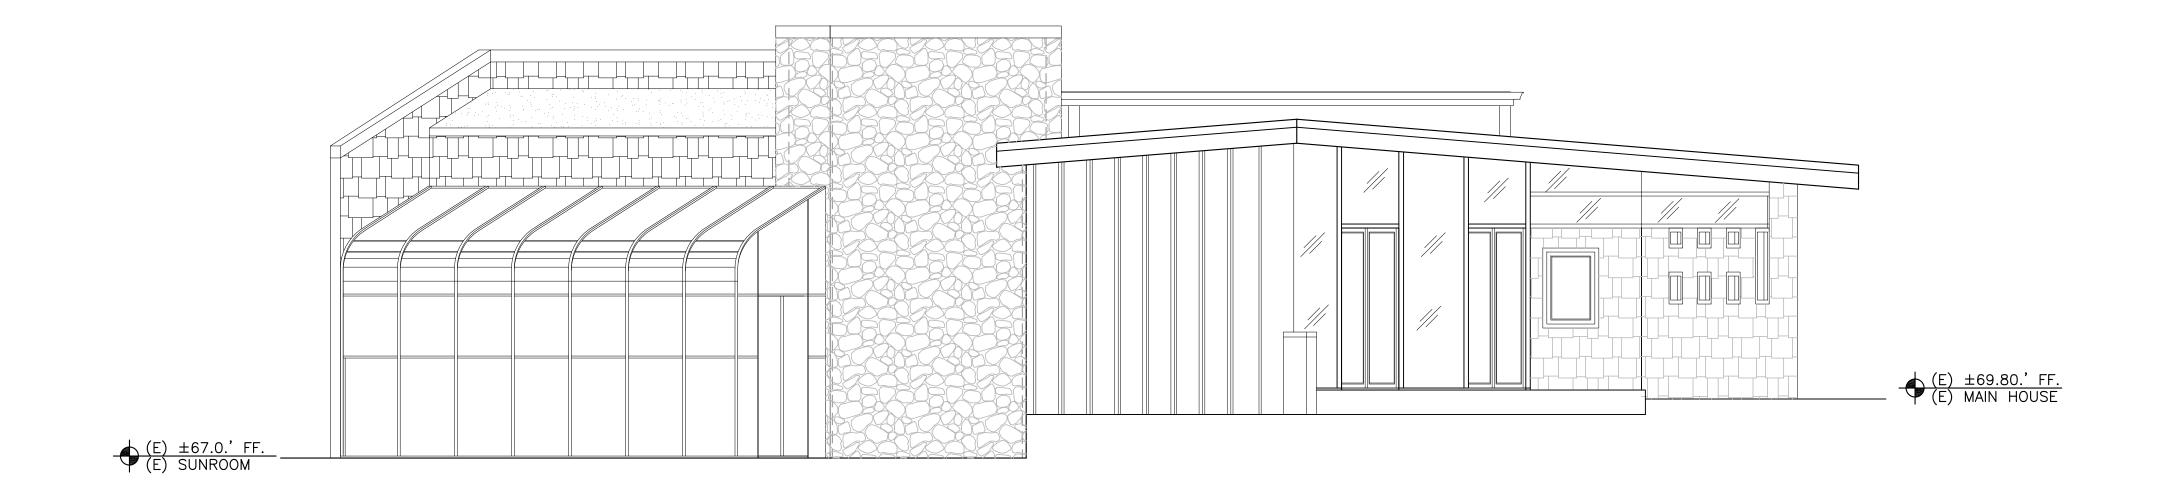

WEST ELEVATION - MAIN HOUSE EXISTING

1/4"=1'-0"

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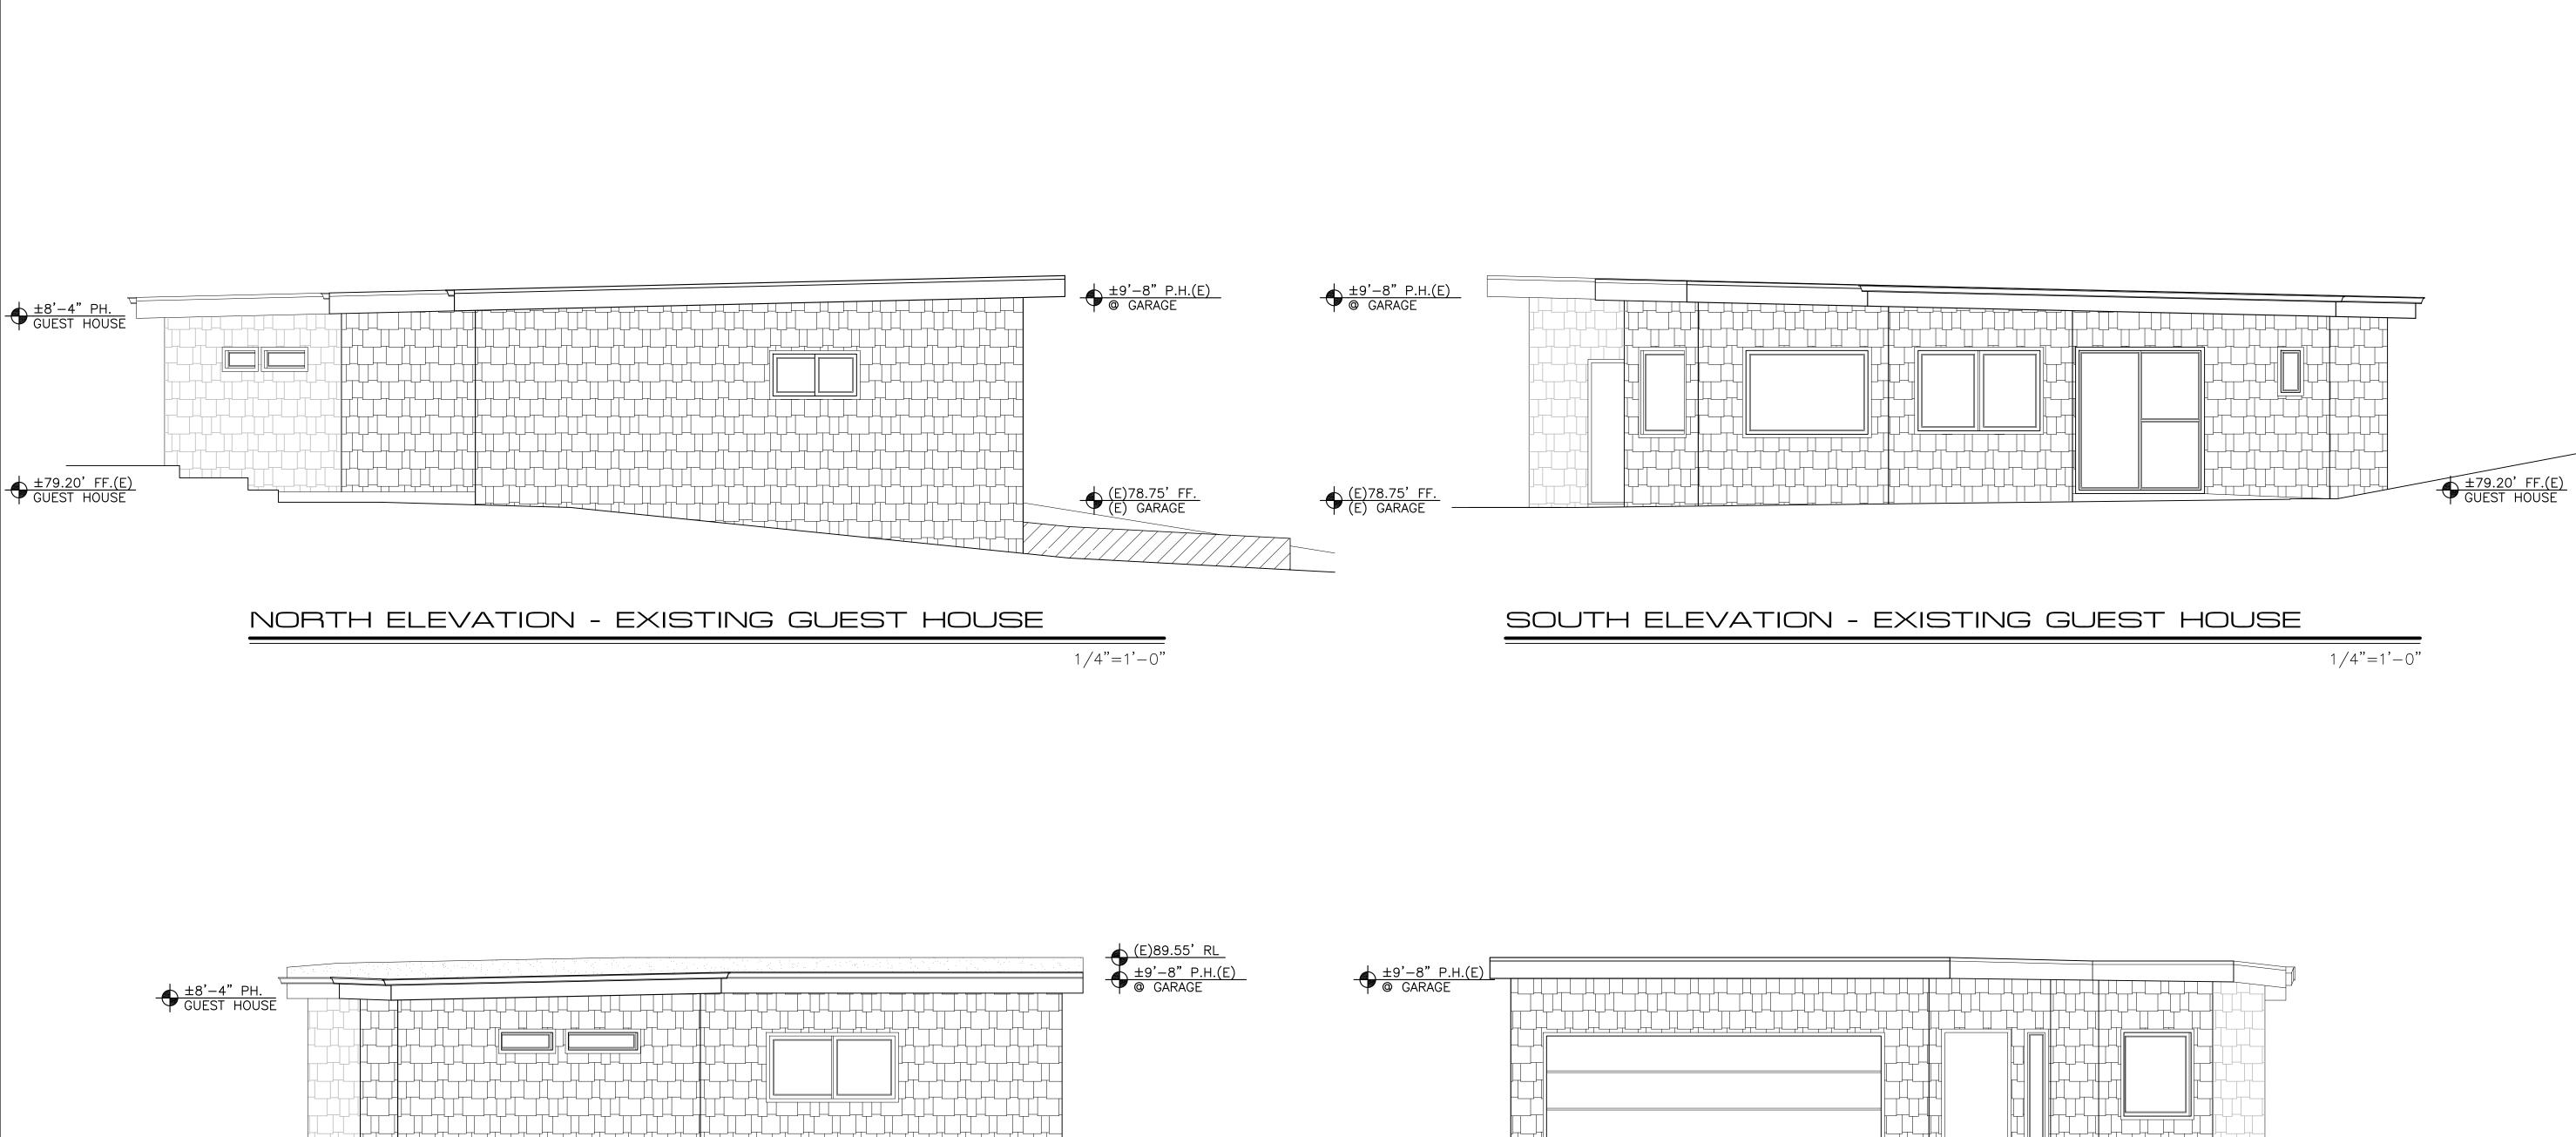
PLANNING DEPT. SUBMITTAL
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FEBRUARY 26, 2025
PLANNING DEPT. SUBMITTAL

PLANNING DEPT. SUBMITTAL

EXISTING ELEVATION MAIN HOUSE

SHEET NO.

D2.1



(E) 78.75' FF. (E) GARAGE

WEST ELEVATION - EXISTING GUEST HOUSE

(E) 78.75' FF. (E) GARAGE

1/4"=1'-0"

±79.20' FF.(E)
GUEST HOUSE -

EAST ELEVATION - EXISTING GUEST HOUSE

JUN A. SILLANO, AIA ARCHITECTURE + PLANNING + INTERIOR DESIGN 721 LIGHTHOUSE AVE PACIFIC GROVE CA. 93950 (831) 646-1261 (831) 646-1290 EMAIL idg@idg-inc.net WEB DISCLAIMER: ALL IDEAS, DESIGNS, ARRANGEMENTS AND PLANS INDICATED BY THIS DRAWING ARE OWNED BY, AND THE PROPERTY OF THIS OFFICE AND WERE CREATED, EVOLVED AND DEVELOPED FOR USE ON, AND IN CONNECTION WITH, THE SPECIFIED PROJECT. NONE OF SUCH IDEAS, DESIGNS, ARRANGEMENTS OR PLANS SHALL BE USED BY OR DISCLOSED TO ANY PERSON, FIRM OR CORPORATION FOR ANY PURPOSE WHATSOEVER WITHOUT THE WRITTEN PERMISSION OF INTERNATIONAL DESIGN GROUP. WRITTEN DIMENSIONS ON THESE DRAWINGS SHALL HAVE PRECEDENCE OVER SCALE DIMENSIONS: CONTRACTORS SHALL VERIFY AND BE RESPONSIBLE FOR, ALL DIMENSIONS AND CONDITIONS ON THE JOB AND THIS OFFICE MUST BE NOTIFIED OF ANY VARIATION FROM THE DIMENSIONS AND CONDITIONS SHOW BY THESE DRAWINGS. SHOP DETAILS OF ADEQUATE SCALE MUST BE SUBMITTED TO THIS OFFICE FOR APPROVAL BEFORE. STAMPS: PROJECT/CLIENT: RICKARD **RESIDENCE** PROJECT ADDRESS: 5 YANKEE BEACH WAY CARMEL, CA 93923 APN: 243-141-008

idg-inc.net

DATE: JUNE 4, 2024 APPLICATION REQ. SUBMITTAL

REVISIONS:

1/4"=1'-0"

1 OCTOBER 1, 2024 PLANNING DEPT. SUBMITTAL NOVEMBER 20, 2024

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EXISTING ELEVATION

GUEST HOUSE

SHEET NO.


D3.0

GRADING, DRAINAGE & EROSION CONTROL PLAN

RICKARD RESIDENCE

APN: 243-141-008

CARMEL, MONTEREY COUNTY, CALIFORNIA

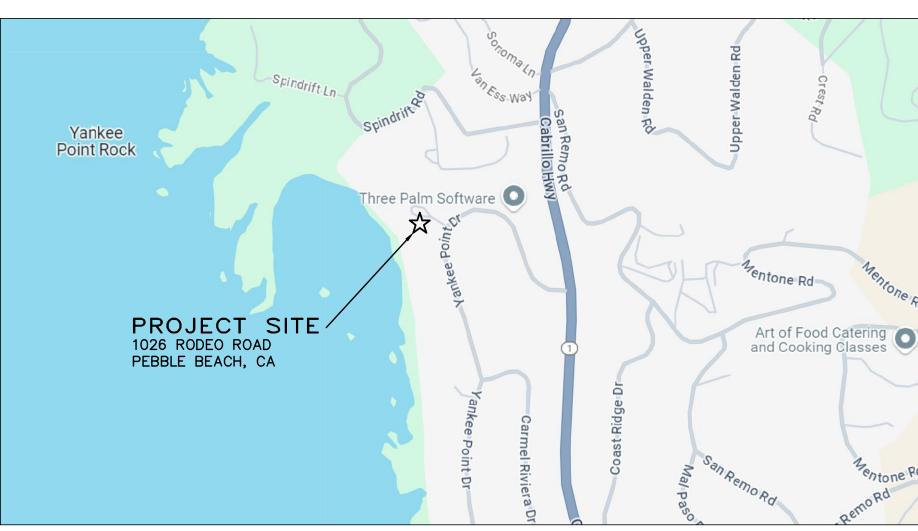

VICINITY MAP


GENERAL NOTES:

- 1) PROJECT DESIGN BASED ON INFORMATION PROVIDED AND SHOWN ON THE SITE PLAN FOR THE RICKARD RESIDENCE A1.0 PREPARED BY INTERNATIONAL DESIGN GROUP, DATED 06/20/24, AND THE BASE TOPOGRAPHIC INFORMATION PREPARED BY LANDSET ENGINEERS, INC. ON MAY 8, 2024.
- UNDERGROUND UTILITIES WERE LOCATED. ONLY VISIBLE FACILITIES ABOVE AND FLUSH WITH THE SURFACE ARE SHOWN. SUB-SURFACE UTILITY LINES DRAWN MAY NOT BE COMPLETE AND SHOULD BE VERIFIED BY FIELD RECONNAISSANCE. UNDERGROUND UTILITY LOCATIONS CAN BE OBTAINED FROM THE APPROPRIATE UTILITY COMPANIES, PUBLIC AGENCIES, OWNER'S AS-BUILT DRAWINGS, ETC., AND SHOULD BE THROUGHLY COMPILED AND DEEMED COMPLETE WITH THE PROJECT AREA, PRIOR TO ANY SITE DEVELOPMENT DESIGN AND/OR CONSTRUCTION.
- OR GEOLOGY INFORMATION, UNDERGROUND CONDITIONS, EASEMENTS, ZONING OR REGULATORY OR ANY OTHER ITEMS NOT SPECIFICALLY REQUESTED BY THE PROPERTY OWNER.
- 4) THIS MAP DOES NOT REPRESENT A BOUNDARY SURVEY.

GRADING & DRAINAGE NOTES:

- 1) ALL GRADING SHALL CONFORM TO THE MONTEREY COUNTY GRADING ORDINANCE AND EROSION CONTROL ORDINANCE, THE RECOMMENDATIONS FOUND IN THE PROJECT SOIL'S ENGINEERING INVESTIGATION, THE LATEST VERSION OF THE CALTRANS SPECIFICATIONS. THE GOVERNING PUBLIC AGENCIES. THE LATEST VERSION OF THE CALIFORNIA BUILDING CODE (CBC) AND THESE PLANS.
- 2) SURFACE ORGANICS SHALL BE STRIPPED AND STOCKPILED FOR LATER USE AS TOPSOIL MATERIAL ACTUAL GRADING SHALL BEGIN WITHIN 30 DAYS OF VEGETATION REMOVAL OR THE AREA SHALL BE PLANTED TO
- 3) NO ORGANIC MATERIAL SHALL BE PERMITTED IN FILLS EXCEPT AS TOPSOIL USED FOR SURFACE PLANT GROWTH ONLY AND WHICH DOES NOT EXCEED 4" IN DEPTH.
- 4) THERE ARE APPROXIMATELY 35 C.Y. OF CUT AND 10 C.Y. OF FILL WITH 25 C.Y. OF EXPORT. EXCAVATION SHALL BE USED FOR EMBANKMENT CONSTRUCTION, LANDSCAPE PURPOSES AND/OR HAULED OFF-SITE ON A LEGAL MANER. ADDITIONAL ON-SITE SPOILS GENERATED FROM FOUNDATIONS, UTILITY TRENCHES, SEPTIC CONSTRUCTION, ETC. IS NOT INCLUDED IN THE ABOVE REFERENCED QUANTITIES. IMPORT MATERIAL SHALL MEET THE REQUIREMENTS OF SELECT STRUCTURAL FILL AS NOTED IN THE SOIL'S

 17) ALL WORK IS SUBJECT TO APPROVAL BY THE PUBLIC WORKS SUPERINTENDENT INSPECTION AND REPORT AND BE APPROVED BY THE SOILS ENGINEER PRIOR TO PLACEMENT.
- 5) EMBANKMENT MATERIAL SHALL BE PLACED IN 8" LOOSE LIFTS, MOISTURE CONDITIONED, AND COMPACTED TO 90% MIN. REL. COMPACTION. ALL BASEROCK AND THE UPPER 12" OF SUBGRADE SHALL BE COMPACTED TO 95% MIN. REL. COMPACTION.
- 6) ALL CUT AND FILL SLOPES SHALL BE 2:1 OR FLATTER. STEEPER SLOPES MAY BE ALLOWED ONLY WITH THE PERMISSION OF THE SOIL'S ENGINEER.
- 7) PAD ELEVATIONS SHALL BE CERTIFIED TO 0.10', PRIOR TO DIGGING ANY FOOTINGS OR SCHEDULING ANY
- 8) DUST FROM GRADING OPERATIONS MUST BE CONTROLLED. CONTRACTOR SHALL PROVIDE ADEQUATE WATER TO CONTROL DUST DURING AND FOR GRADING OPERATIONS.
- 9) A COPY OF ALL COMPACTION TESTS AND FINAL GRADING REPORT SHALL BE SUBMITTED TO THE COUNTY OF MONTEREY PLANNING AND BUILDING INSPECTION DEPARTMENT AT SCHEDULED INSPECTIONS.
- 10) THE GROUND IMMEDIATELY ADJACENT TO FOUNDATIONS SHALL BE SLOPED AWAY FROM THE BUILDING AT 5% FOR A MINIMUM DISTANCE OF 10 FEET. IF PHYSICAL OBSTRUCTIONS OR LOT LINES PROHIBIT 10 FOOT OF HORIZONTAL DISTANCE, A 5% SLOPE SHALL BE PROVIDED TO AN APPROVED ALTERNATIVE METHOD OF DIVERTING WATER AWAY FROM THE FOUNDATION. SWALES USED FOR THIS PURPOSE SHALL BE SLOPED AT A MINIMUM OF 1% WHERE LOCATED WITHIN 5 FEET OF THE BUILDING FOUNDATION. IMPERVIOUS SURFACES WITHIN 10 FEET OF THE BUILDING FOUNDATION SHALL BE SLOPED AT A MINIMUM OF 2% AWAY FROM THE
- 11)ROOF DRAINAGE SHALL BE CONTROLLED BY GUTTER AND DOWN SPOUTS WITH SPLASH BLOCKS WHICH OUTLET INTO LANDSCAPE AREAS AND/OR CONNECTED INTO RAIN WATER LEADERS WHICH OUTLET INTO THE EXISTING STORM DRAIN SYSTEM. RAIN WATER LEADERS SHALL BE 4" PVC-SDR 35 PIPE, HAVE A MINIMUM SLOPE OF 1% AND A MINIMUM COVER OF 12". THE RAIN WATER LEADER TRENCHES SHOULD HAVE THEIR BEARING SURFACES FOUNDED BELOW AN IMAGINARY 1:1 (HORIZONTAL TO VERTICAL) LANE PROJECTED UPWARD FROM THE BOTTOM EDGE OF THE BUILDING FOOTINGS.
- 12) STORM WATER (SURFACE RUNOFF) SHALL BE KEPT ON ITS ORIGINAL STATE WITH EXISTING DRAINAGE PATTERNS MAINTAINED.
- 13) SUBSURFACE DRAINAGE FOR RETAINING WALLS IF REQUIRED WILL BE COLLECTED AND PIPED TO DAYLIGHT IN A NON-EROSIVE MANNER.

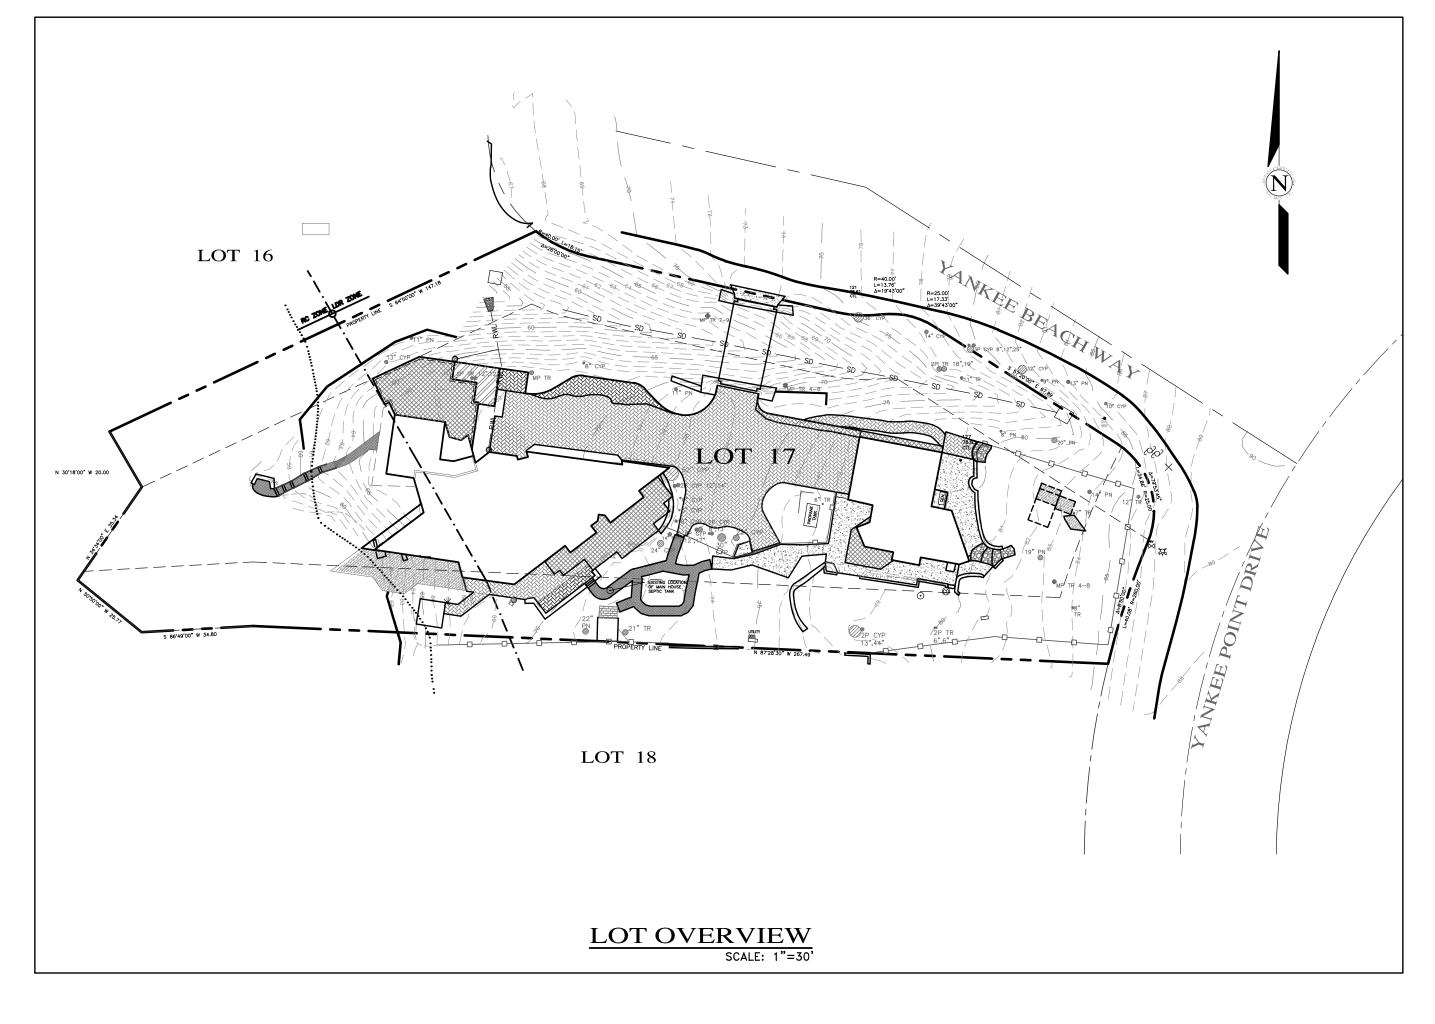

14) THE STORM DRAIN FACILITIES IF REQUIRED SHALL BE CHRISTY PRODUCTS OR APPROVED EQUAL. THE STORM DRAIN PIPE SHALL BE P.V.C. MIN. SDR 35.

15) ALL NEW UTILITY AND DISTRIBUTION LINES SHALL BE PLACED UNDERGROUND.

16) UTILITY TRENCHES WITHIN THE BUILDING PAD OR ANY NEW PAVED AREAS SHALL BE BACKFILLED WITH CLEAN, IMPORTED SAND AND THE TRENCH BACKFILL SHALL BE COMPACTED TO 95% MIN. RELATIVE COMPACTION. THE TOP 8" OF TRENCH SHALL BE CAPPED WITH NATIVE SOIL. IN NON-PAVED AREAS NATIVE BACKFILL SHALL BE USED AND COMPACTED TO 90% MIN. RELATIVE COMPACTION.

ACCEPTANCE.

18) NO LAND DISTURBING OR GRADING SHALL OCCUR ON THE SUBJECT PARCEL BETWEEN OCTOBER 15 AND APRIL 15 UNLESS AUTHORIZED BY THE DIRECTOR OF RMA — BUILDING SERVICES.

19) SPECIAL INSPECTIONS, BY A SPECIAL INSPECTOR, ARE REQUIRED DURING FILL PLACEMENT AND THAT PROPER MATERIALS AND PROCEDURES ARE USED IN ACCORDANCE WITH THE PROVISIONS OF THE APPROVED GEOTECHNICAL REPORT.

20) THE LOCATION, HEIGHT AND THE PLATE HEIGHTS OF THE NEW STRUCTURE MUST BE CERTIFIED BY A SURVEYOR TO BE IN CONFORMANCE WITH THE APPROVED PLANS.

21) IF DURING THE COURSE OF CONSTRUCTION, CULTURAL, ARCHAEOLOGICAL, HISTORICAL OR PALEONTOLOGICAL RESOURCES ARE UNCOVERED AT THE SITE (SURFACE OR SUBSURFACE RESOURCES) WORK SHALL BE HALTED IMMEDIATELY WITHIN 50 METERS (165 FEET) OF THE FIND UNTIL A QUALIFIED PROFESSIONAL ARCHAEOLOGIST CAN EVALUATE IT. MONTEREY COUNTY RMA - PLANNING DEPARTMENT AND A QUALIFIED ARCHAEOLOGIST SHALL BE IMMEDIATELY CONTACTED BY THE RESPONSIBLE INDIVIDUAL PRESENT ON-SITE. WHEN CONTACTED, THE PROJECT PLANNER AND THE ARCHAEOLOGIST SHALL IMMEDIATELY VISIT THE SITE TO DETERMINE THE EXTENT OF THE RESOURCES AND TO DEVELOP PROPER MITIGATION MEASURES REQUIRED FOR RECOVERY.

STORM WATER CONTROL NOTES:

- 1) THE PROJECT IS NOT LOCATED WITHIN THE MUNICIPAL GENERAL PERMIT BOUNDARY AS DEFINED BY THE CALIFORNIA STATE WATER QUALITY CONTROL BOARD ORDER No. 2013-0001-DWQ; THEREFORE, THE POST-CONSTRUCTION STORM WATER MANAGEMENT REQUIREMENTS (PCRs) FOR DEVELOPMENT PROJECTS IN THE CENTRAL COAST REGION DO NOT APPLY.
- 2) THIS PROJECT WILL CREATE AND/OR REPLACE COLLECTIVELY OVER THE ENTIRE PROJECT 1,206 SF OF IMPERVIOUS SURFACES AND WILL DISTURB A LAND AREA OF 1,656 SQ.FT.

LEGEND:

NEW:

- RWL --- RWL --- RWL --- RAIN-WATER LEADER 13.20 SPOT ELEVATION

ROOF DOWNSPOUT/SPLASH BLOCK

MAIN FLOOR HOUSE FOOTPRINT ADDITION PERMEABLE CONCRETE PAVER SURFACE

ROCK/BIOFILTRATION BASIN

PROJECT GEOTECHNICAL ENGINÉER THAT ALĹ DEVELOPMENT HAS BEEN CONSTRUCTED IN ACCORDANCE

NOTE: PRIOR TO FINAL INSPECTION, THE OWNER/APPLICANT SHALL PROVIDE CERTIFICATION FROM THE

WITH THE RECOMMENDATIONS IN THE PROJECT SOIL ENGINEERING INVESTIGATION.

Inspection item:	Who will conduct	When the Inspection	Inspection	Date comp
inspection item.	the inspection:	When the Inspection is to be completed:	completed by:	Date comp
Site stripping and clearing	Soil's Engineer	Beginning of Project		
Subexcavation, fill placement, and compaction	Soil's Engineer	Throughout grading operations		
Foundation Excavations	Soil's Engineer	Prior to placement of forms and reinforcing steel		
Surface and subsurface drainage improvements	Soil's Engineer	Prior to trench backfill		
Utility trench compaction	Soil's Engineer	During backfill operations		
Retaining wall backfill compaction	Soil's Engineer	During backfill operations		
Baserock subgrade compaction	Soil's Engineer	Prior to pavement installation		

TOTAL LOT AREA = 31,695 SQ.FT. TOTAL IMPERVIOUS AREA = 1,206 SQ.FT. TOTAL AREA OF DISTURBANCE = 1,656 SQ.FT.

GRADING QUANTITIES:

CUT = 35 C.Y.

NET = 25 C.Y. SURPLUS

FILL = 10 C.Y.

INDEX TO SHEETS

SHEET C2 TOPOGRAPHIC MAP/EXISTING CONDITIONS

EROSION & SEDIMENT CONTROL PLAN

ARREVIATIONS.

LOW POINT

<u>Ai</u>	BREVIATIONS:		
AB AC BLDG BRDY BOT CB CL C/L C CO DI DW ELEV EL EP EX (E) FC FD FF FG FDC FH	AGGREGATE BASE ASPHALT CONCRETE BUILDING BOUNDARY BOTTOM CATCH BASIN CENTERLINE CLEAN OUT DRAIN INLET DRIVEWAY ELEVATION EDGE OF PAVEMENT EXISTING FACE OF CURB FACE OF DIKE FINISHED FLOOR FINISHED FLOOR FINISHED GRADE FIRE DEPARTMENT CONNECTION FIRE HYDRANT FACE OF CURB	MIN (N) NO. NTS O.C. PL PL PVC R RAD R/W R.C. RCP REL RET WALL S D SHO SS LAT SSMH STA S/W TC TD TW TYP UP	PROPERTY LINE PUBLIC UTILITIES EASEMENT POLYVINYL CHLORIDE RADIUS RIGHT OF WAY RELATIVE COMPACTION REINFORCED CONCRETE PIPE RELATIVE RETAINING WALL SLOPE STORM DRAIN SHOULDER SANITARY SEWER SANITARY SEWER

WATER WATER SERVICE

SHEET C1 COVER SHEET

GRADING, DRAINAGE & UTILITY PLAN

CONSTRUCTION MANAGEMENT PLAN

CONTACT INFORMATION:


PRIMARY: OWNER
MR. & MRS. OLIVER & BROOKE RICKARD 1304 SUITTON DRIVE COLUMBIA, MO 65203


SECONDARY: ARCHITECT INTERNATIONAL DESIGN GROUP ATTN: MS. AMY L. DENNEY 721 LIGHT HOUSE AVE. PEBBLE BEACH, CA 93950 PH (831)646-1261

YANKEE BEACH WAY CARMEL, CA 93923

SCALE: AS SHOWN

12/20/24 AMS SITE PLAN UPDATE 12/12/24 AMS SITE PLAN UPDATE 10/04/24 AMS RELEASED TO CLIENT No. DATE BY REVISION DATE: OCTOBER 2024 JOB NO. 2761-02

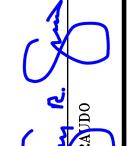


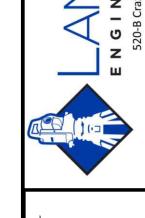



IOI

J.H.

OF 5 SHEETS

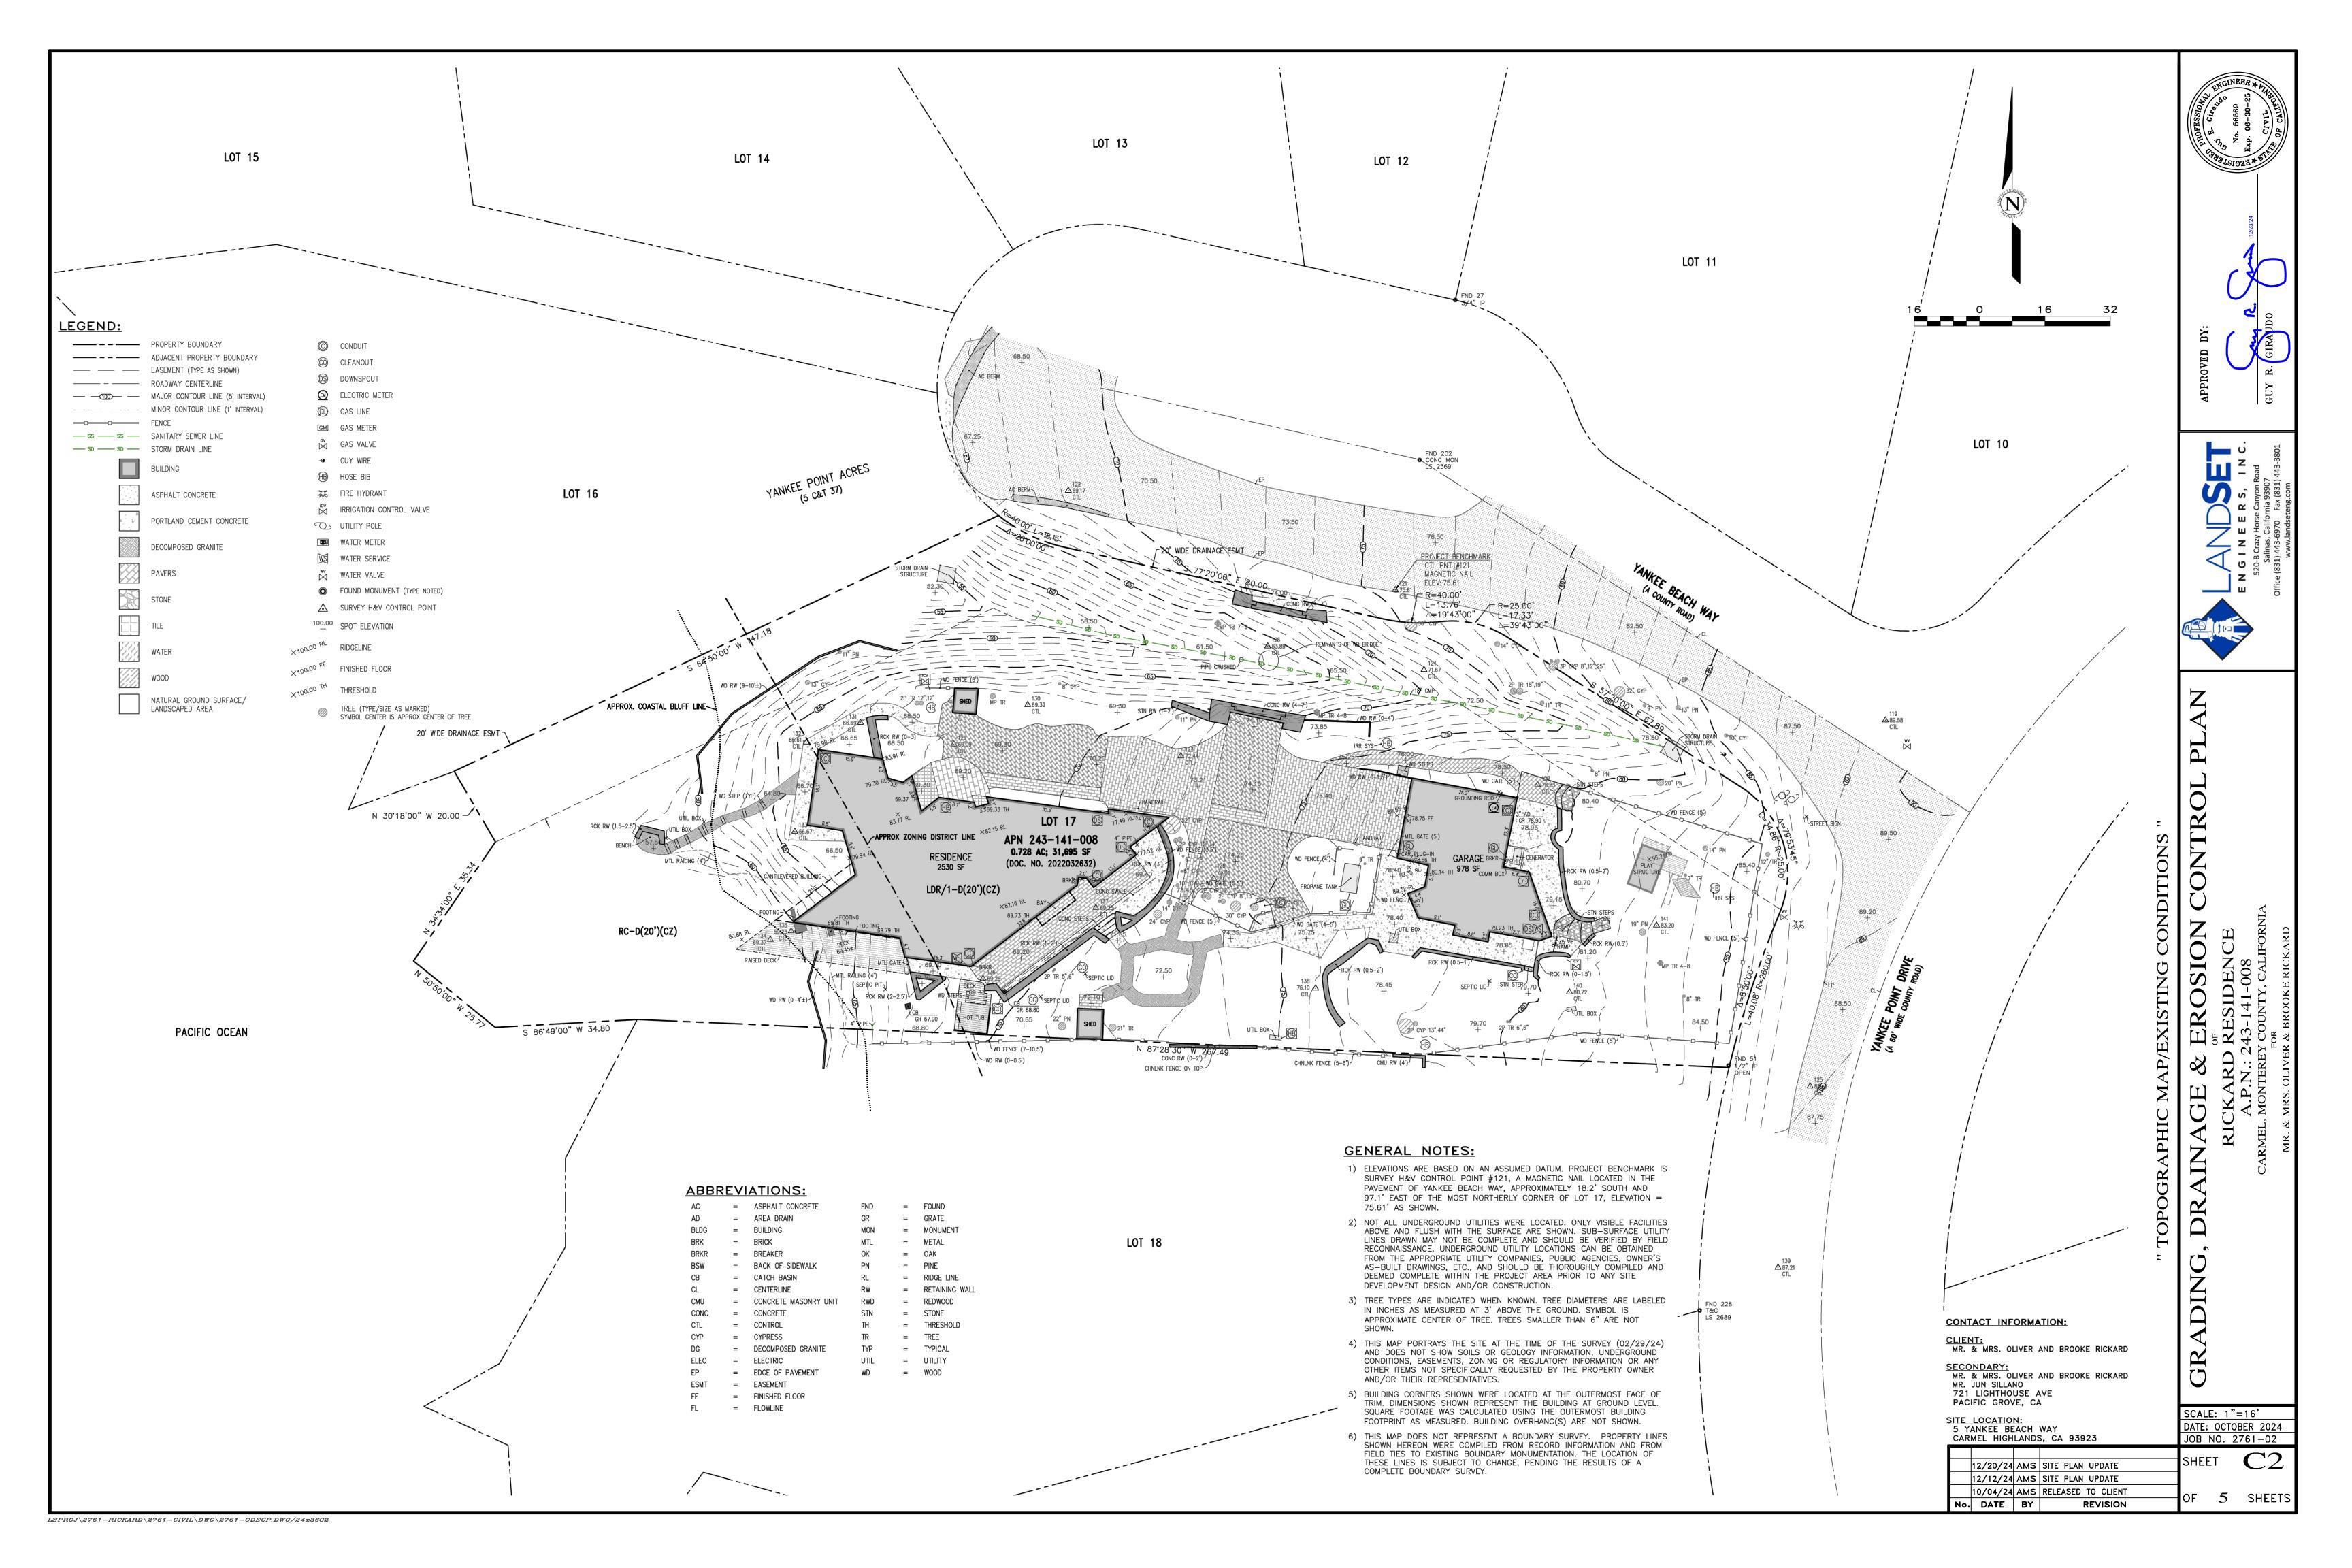

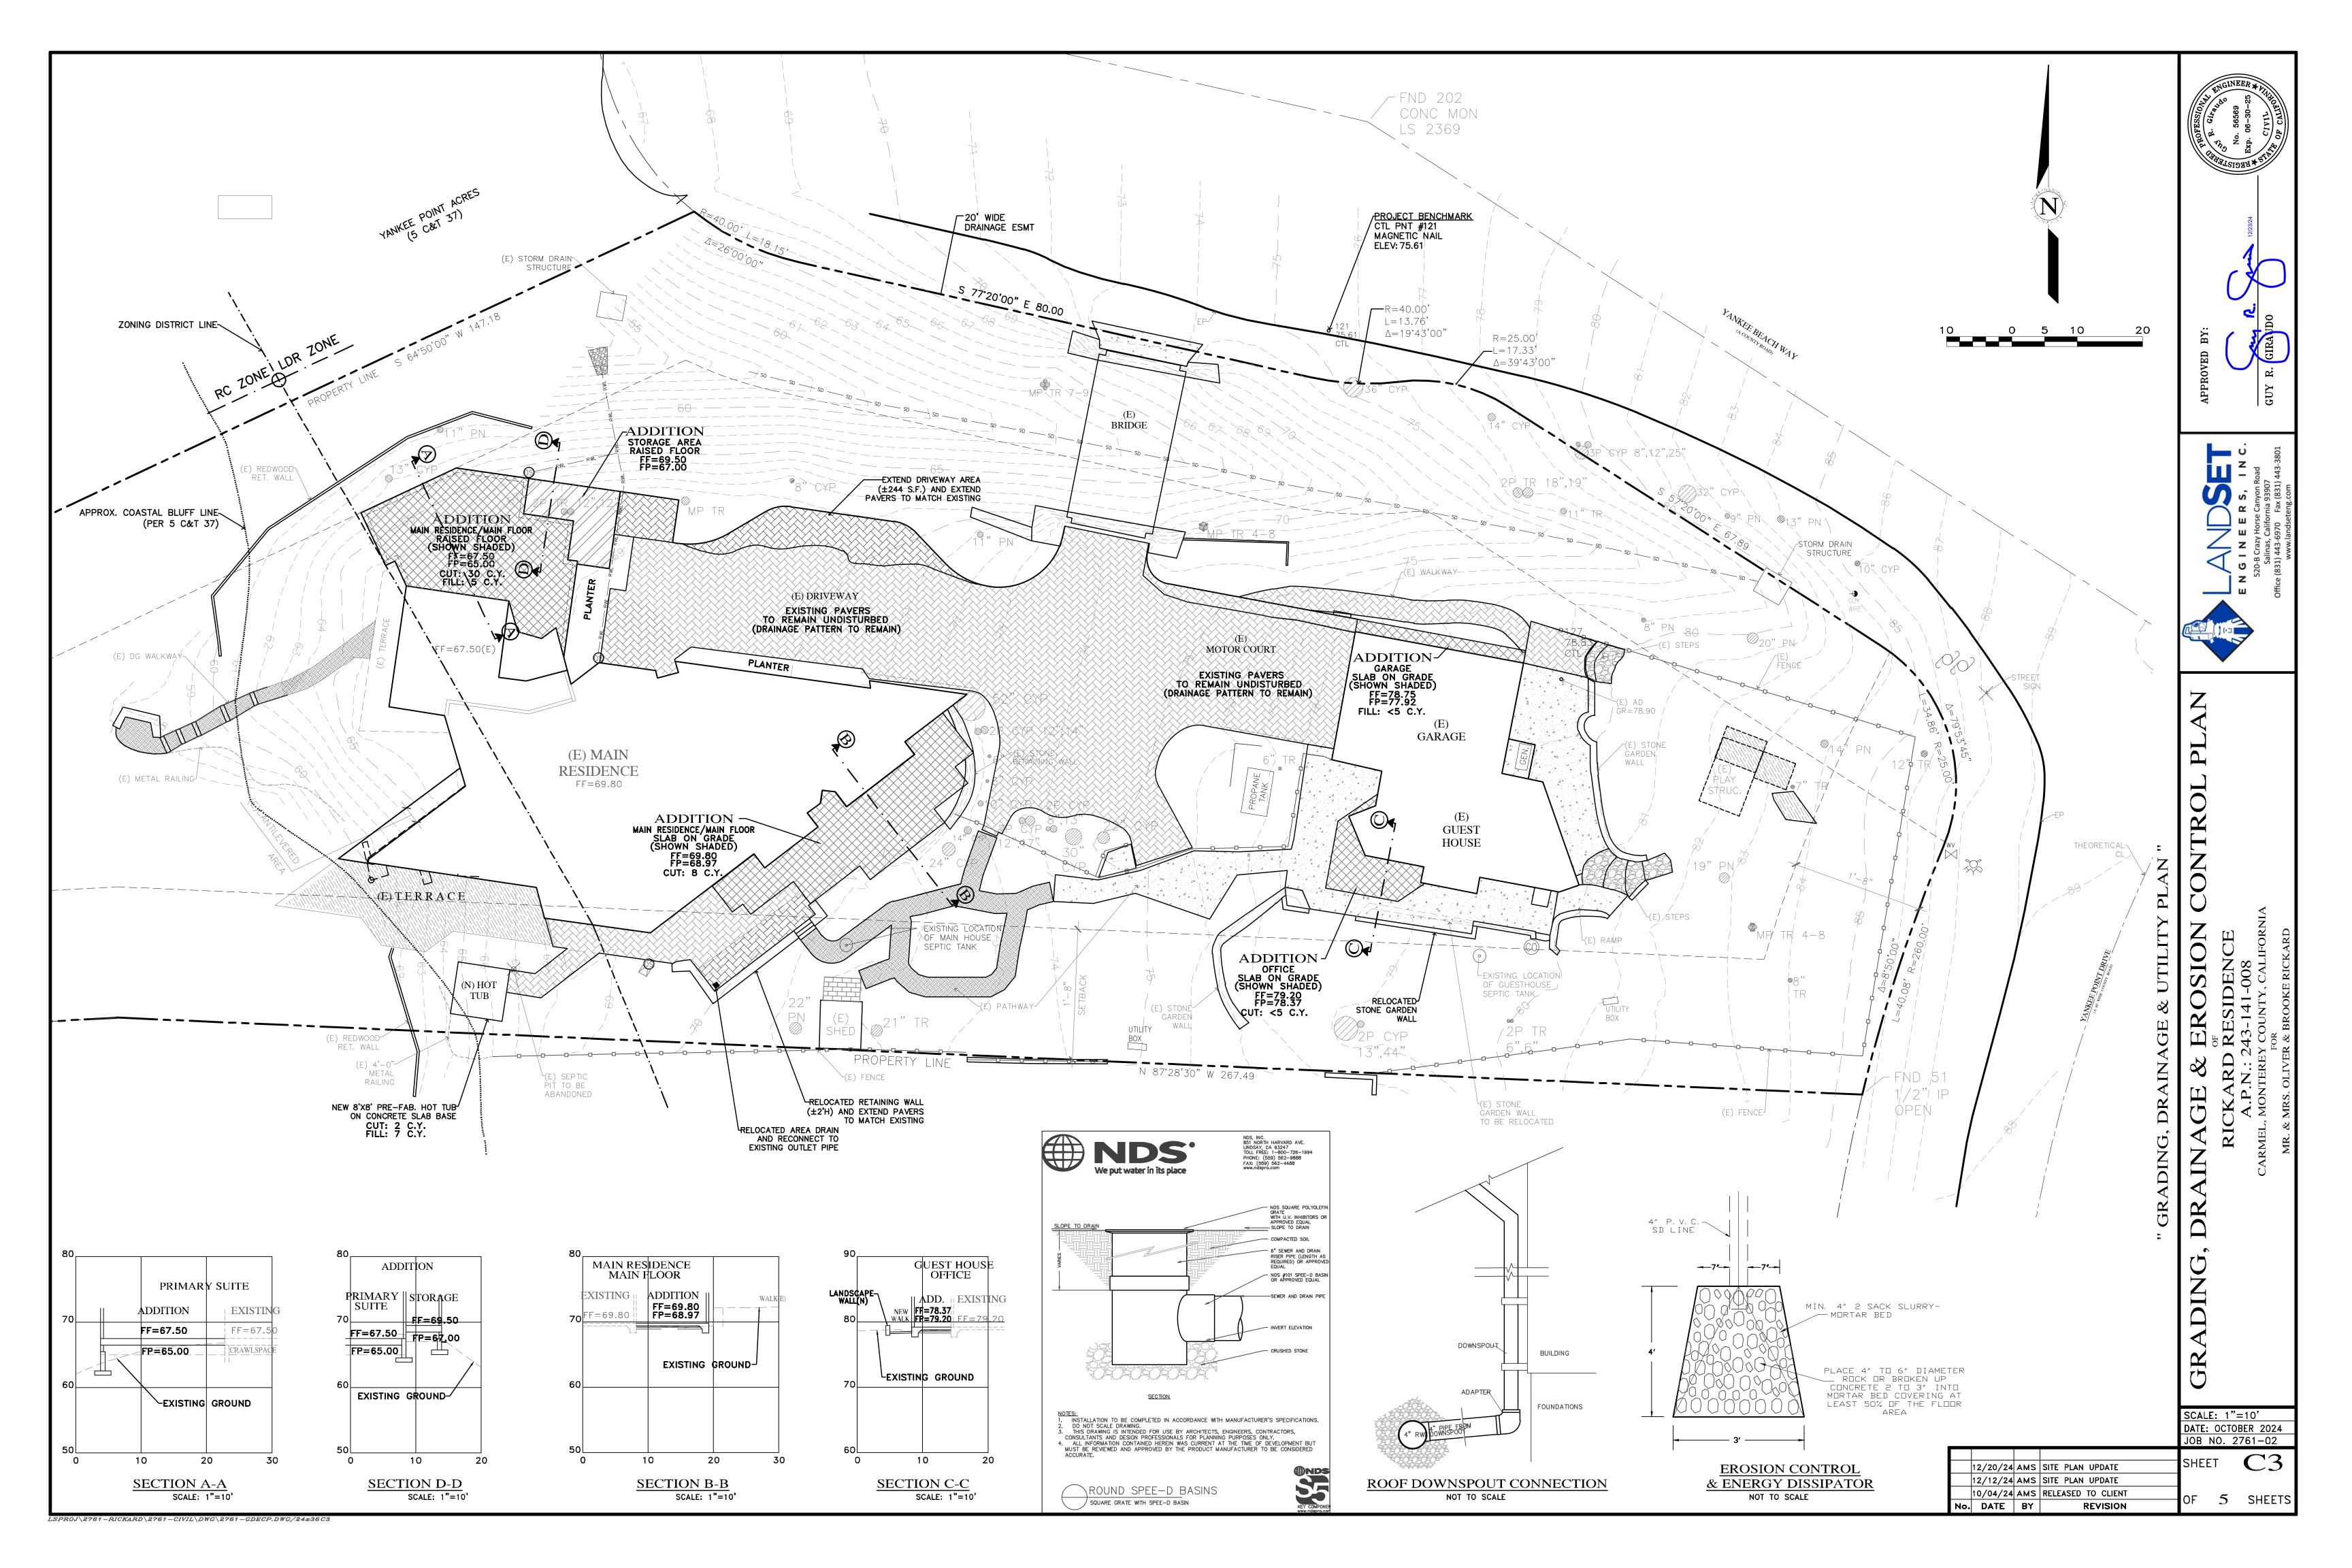

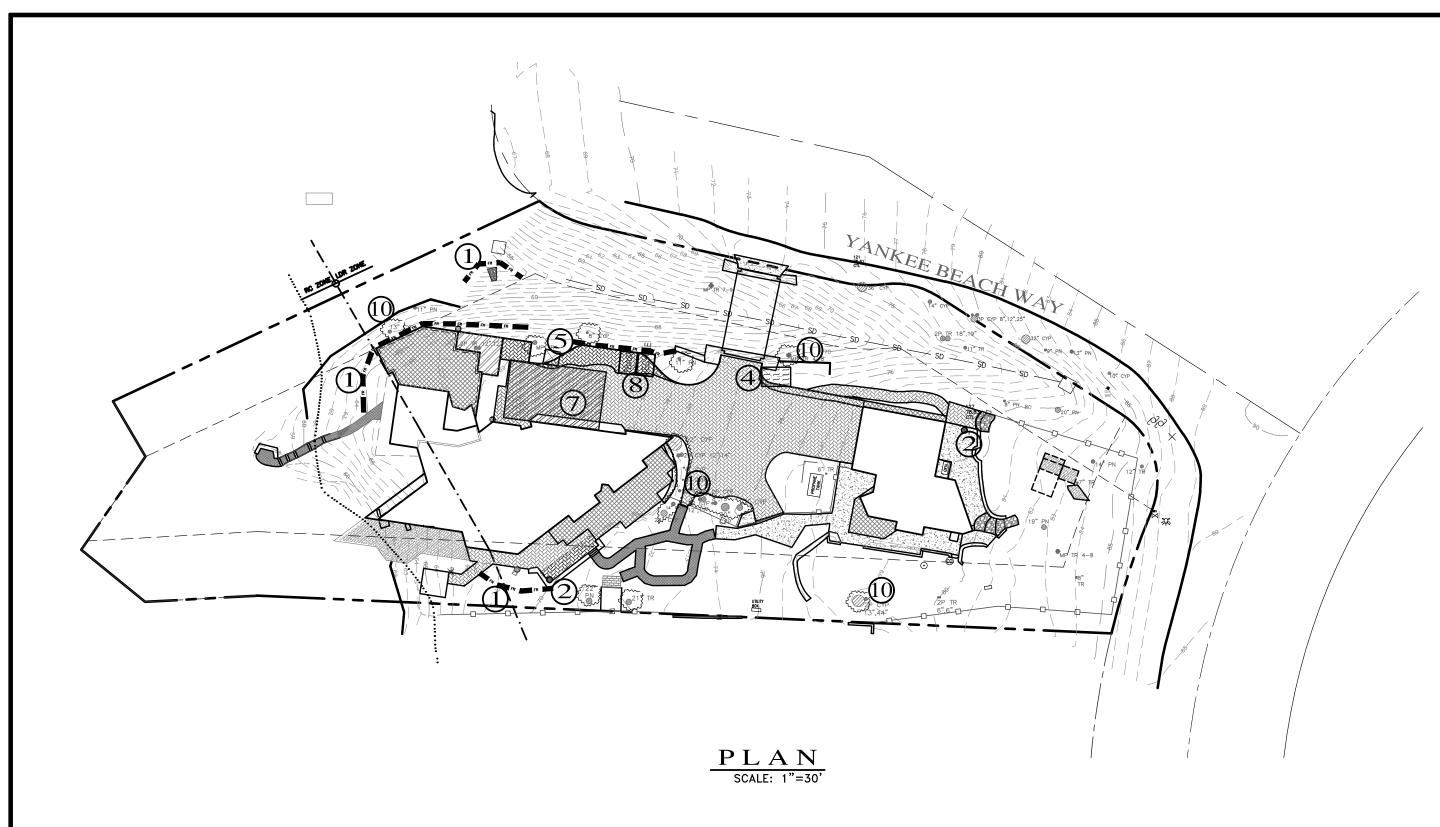

EROSION & SEDIMENT CONTROL NOTES:

- 1) ALL EROSION CONTROL MEASURES SHALL CONFORM WITH THE COUNTY OF MONTEREY EROSION
- 2) EROSION AND SEDIMENT CONTROL MEASURES SHALL BE IN EFFECT FOR ANY CONSTRUCTION DURING THE RAINY SEASON, APPROX. OCTOBER 15 TO APRIL 15. EROSION CONTROL PLAN SHALL BE PREPARED AND SUBMITTED FOR APPROVAL BY SEPT. 15 OF ANY OR EACH CALENDAR YEAR THAT CONSTRUCTION MAY EXTEND BEYOND OCTOBER 15.
- 3) ALL SLOPES SHALL BE PROTECTED WITH STRAW MULCH OR SIMILAR MEASURES TO PROTECT AGAINST EROSION UNTIL SUCH SLOPES ARE PERMANENTLY STABILIZED.
- 4) RUNOFF SHALL BE DETAINED OR FILTERED BY BERMS. VEGETATED FILTER STRIPS. AND/OR CATCH BASINS TO PREVENT THE ESCAPE OF SEDIMENT FROM THE SITE.
- 5) EROSION AND SEDIMENT CONTROL MEASURES SHALL BE IN PLACE AT THE END OF EACH DAY'S
- 6) EROSION CONTROL PLANTINGS AND MULCH SHALL BE CLOSELY MONITORED THROUGHOUT THE WINTER AND ANY RUNOFF PROBLEMS CORRECTED PROMPTLY. SEE LANDSCAPE ARCHITECT'S PLAN FOR PERMANENT PLANTINGS AND TREE SCHEDULES.
- 7) DISTURBED SURFACES NOT INVOLVED IN THE IMMEDIATE GRADING OPERATIONS MUST BE PROTECTED BY MULCHING AND/OR OTHER EFFECTIVE MEANS OF SOIL PROTECTION.
- 8) ALL ROADS AND DRIVEWAYS SHALL HAVE DRAINAGE FACILITIES SUFFICIENT TO PREVENT EROSION ON OR ADJACENT TO THE ROADWAY OR ON THE DOWNHILL PROPERTIES.
- 9) DRAINAGE CONTROL MEASURES SHALL BE MAINTAINED AND IN PLACE AT THE END OF EACH DAY AND CONTINUOUSLY THROUGHOUT THE LIFE OF THE PROJECT DURING WINTER OPERATIONS.
- 10) REVEGETATION SHALL CONSIST OF A MECHANICALLY APPLIED HYDROMULCH SLURRY OR HAND SEEDED WITH A STRAW MULCH COVER. MULCH SHALL BE ANCHORED BY AN APPROVED METHOD SUCH AS PUNCHING, TACKING, OR THE USE OF JUTE NETTING, AS DEEMED NECESSARY FOR THE SITE CONDITIONS TO ALLOW FOR GERMINATION AND ENABLE ADEQUATE GROWTH TO BE
- 11) CHECK DAMS, SILT FENCES, FIBER ROLLS OR OTHER DESIGNS SHALL BE INCORPORATED TO CATCH ANY SEDIMENT UNTIL AFTER THE NEWLY EXPOSED AREAS ARE REVEGETATED SUFFICIENTLY TO CONTROL EROSION, EROSION CONTROL PLANTINGS AND MULCH SHALL BE CLOSELY MONITORED THROUGHOUT THE WINTER AND ANY RUNOFF PROBLEMS SHALL BE CORRECTED PROMPTLY. ALL EROSION AND/OR SLIPPAGE OF THE NEWLY EXPOSED AREAS SHALL BE REPAIRED BY THE PERMITTEE AT THEIR EXPENSE.
- 12) THE GRASS SEED SHALL BE PROPERLY IRRIGATED UNTIL ADEQUATE GROWTH IS ESTABLISHED AND MAINTAINED TO PROTECT THE SITE FROM FUTURE EROSION DAMAGE. ALL NEWLY EXPOSED (DISTURBED) AREAS SHALL BE SEEDED WITH THE FOLLOWING EROSION CONTROL MIX: BROMUS CARINATUS (CALIFORNIA BROME), VULPIA MICROSTACHYS (NUTTALL'S FESCUE), ELYMUS GLAUCUS (BLUE WILD RYE), HORDEUM BRACHYANTHERUM (MEADOW BARLEY), FESTUCA RUNRA'MOLATE BLUE AND A MIXTURE OF LOCALLY NATIVE WILDFLOWERS.
- 13) THE DIRECTOR OF BUILDING INSPECTION (BUILDING OFFICIAL) SHALL STOP OPERATIONS DURING PERIODS OF INCLEMENT WEATHER IF HE OR SHE DETERMINÉS THAT EROSION PROBLEMS ARE NOT BEING CONTROLLED ADEQUATELY.
- 14) GENERAL CONTRACTOR SHALL BE RESPONSIBLE FOR EROSION AND SEDIMENT CONTROL BMP INSTALLATION AND MAINTENANCE AND SHALL PROVIDE FULL PARTICULARS TO COUNTY RMA-ENVIRONMENTAL SERVICES PRIOR TO BEG. WORK.

Material Delivery and Storage

Prevent, reduce, or eliminate the discharge of pollutants from

watercourses by minimizing the storage of hazardous materials

material delivery and storage to the stormwater system or

onsite, storing materials in watertight containers and/or a

containment, conducting regular inspections, and training

This best management practice covers only material delivery and storage. For other information on materials, see WM-2,


Material Use, or WM-4, Spill Prevention and Control. For


information on wastes, see the waste management BMPs in this

completely enclosed designated area, installing secondary

Description and Purpose

employees and subcontractors

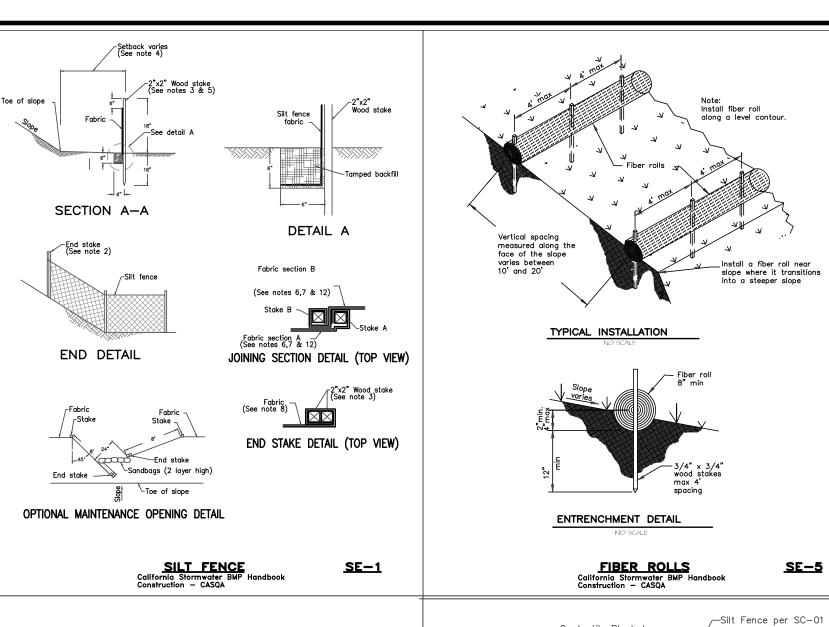

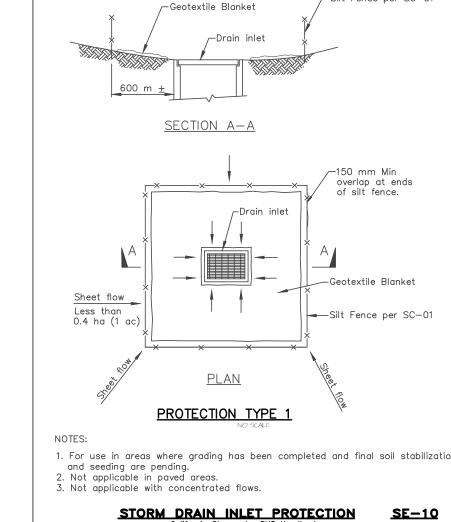

LEGEND:

FIBER ROLLS: THE CONTRACTOR SHALL MAINTAIN A STOCKPILE OF FIBER ROLLS ONSITE, AS THEY CAN BE USED ALONG ERODIBLE SLOPES, ALONG STOCKPILE PERIMETERS, DOWNSLOPE OF EXPOSED SOIL AREAS, AND TO DELINEATE/PROTECT STAGING AREAS. FIBER ROLLS MUST BE TRENCHED INTO THE SOIL AND STAKED (STAKES SPACED MAX. 4' ON CENTER). SEE DETAIL. INSTALL FIBER ROLLS ALONG LEVEL CONTOURS, AND TURN THE ENDS UPHILL. INSPECT WEEKLY AND REMOVE ACCUMULATED SEDIMENT REGULARLY.

DRAIN INLET PROTECTION: PLACE GEOTEXTILE FILTER FABRIC BENEATH INLET GRATE AND SURROUND ENTIRE INLET WITH GRAVEL BAGS (OVERLAP THE BAGS AND PACK THEM TIGHTLY TOGETHER - SEE DETAIL). INSPECT ALL INLET PROTECTION WEEKLY. REMOVE ACCUMULATED

STABILIZED CONSTRUCTION ACCESS: INSTALL STABILIZED CONSTRUCTION ACCESS PRIOR TO COMMENCEMENT OF EARTH MOVING OPERATIONS (SEE DETAIL). INSPECT ENTRANCE DAILY. AND ADD ADDITIONAL STONE AS TOP-DRESSING WHEN REQUIRED. USE FENCING OR BARRICADES TO PREVENT VEHICLE TRAFFIC FROM DRIVING AROUND THE STABILIZED ACCESS.

CONCRETE WASHOUT: WASHOUT MUST BE LOCATED A MINIMUM OF 50 FEET FROM STORM DRAINS, OPEN DITCHES, OR WATER BODIES. DISCONTINUE USE WHEN WASHOUT WASTES REACH 75% OF THE WASHOUT CAPACITY. ALLOW WASHOUT WASTES TO HARDEN, BE BROKEN UP, AND THEN DISPOSED OF PROPERLY.


MAINTAINED ONSITE FOR THE DURATION OF THE PROJECT. ALL PORTABLE TOILETS WILL BE

EQUIPPED WITH A SECONDARY CONTAINMENT TRAY, AND SHALL BE LOCATED A MINIMUM OF

50' FROM ALL OPERATIONAL STORM DRAIN INLETS. WEEKLY MAINTENANCE SHALL BE PROVIDED

SANITARY/SEPTIC WASTE MANAGEMENT: PORTABLE TOILETS WILL BE PROVIDED AND

WITH PLASTIC SHEETING OR COMPARABLE MATERIAL AND SURROUNDED BY A BERM..

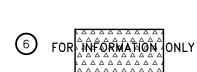

AND WASTES LEGALLY DISPOSED OF OFF-SITE STOCKPILE MANAGEMENT: SOIL STOCKPILES MUST BE COVERED OR STABILIZED (I.E. WITH SOIL BINDERS) IMMEDIATELY IF THEY ARE NOT SCHEDULED TO BE USED WITHIN 14 DAYS. ACTIVE SOIL STOCKPILES SHALL BE WATERED TWICE DAILY TO AVOID WIND EROSION. SURROUND ALL STOCKPILES WITH FIBER ROLLS OR SILT FENCE. STOCKPILES OF "COLD MIX", TREATED WOOD, AND BASIC CONSTRUCTION MATERIALS SHOULD BE PLACED ON AND COVERED



CONTRACTOR'S STAGING AREA: THE CONTRACTOR'S STAGING AREA SHALL BE SURROUNDED BY FIBER ROLLS. THE STAGING AREA WILL BE USED TO STORE DELIVERED MATERIALS, AND FOR OVERNIGHT EQUIPMENT PARKING/FUELING. STORED CONSTRUCTION MATERIALS SHALL BE MAINTAINED IN THEIR ORIGINAL CONTAINERS, AND COVERED AT ALL TIMES. PETROLEUM PRODUCTS AND HAZARDOUS MATERIALS SHALL BE STORED WITHIN SECONDARY CONTAINMENT STRUCTURES OR A STORAGE SHED. EQUIPMENT FUELING AND MAINTENANCE WILL ONLY OCCUR WITHIN THE DESIGNATED STAGING AREA. DRIP PANS OR ABSORBENT PADS MUST BE USED DURING ALL FUELING OR MAINTENANCE ACTIVITIES. AN AMPLE SUPPLY OF SPILL CLEANUP MATERIALS SHALL BE MAINTAINED IN THE STAGING AREA AT ALL TIMES.



WASTE MANAGEMENT: SOLID WASTES WILL BE LOADED DIRECTLY ONTO TRUCKS FOR OFF-SITE DISPOSAL. WHEN ON-SITE STORAGE IS NECESSARY, SOLID WASTES WILL BE STORED IN WATERTIGHT DUMPSTERS IN THE GENERAL STORAGE AREA OF THE CONTRACTOR'S YARD. DUMPSTERS AND/OR TRASH BINS SHALL BE COVERED AT THE END OF EACH WORK DAY. HAZARDOUS WASTES SHALL NOT BE STORED ONSITE. CONSTRUCTION DEBRIS AND GENERAL LITTER WILL BE COLLECTED DAILY AND WILL NOT BE ALLOWED NEAR DRAINAGE INLETS OR




MINIMUM OF 18" LONG X 12" WIDE X 3" THICK, FILLED WITH 1/2" - 1" CRUSHED ROCK. TIGHTLY ABUT BAGS AND CONSTRUCT CHECK DAM AT LEAST 3 BAGS WIDE X 2 BAGS HIGH. INSPECT CHECK DAM REGULARLY AND REMOVE ACCUMULATED SEDIMENT. TREE PROTECTION: TREE PROTECTION SHALL CONSIST OF ORANGE PLASTIC MESH FENCING,

POLYETHYLENE OR POLYAMIDE FABRIC, MIN. UNIT WEIGHT OF 40Z/SY. BAGS SHALL BE A

GRAVEL BAG CHECK DAM: GRAVEL BAGS SHALL CONSIST OF WOVEN POLYPROPYLENE,



AND SHALL BE INSTALLED PRIOR TO COMMENCEMENT OF EARTH-MOVING OPERATIONS (SEE DETAIL). INSTALL FENCING ALONG THE DRIP LINE OF TREES, AND INSTRUCT EMPLOYEES AND SUBCONTRACTORS TO HONOR PROTECTIVE DEVICES. TREE INJURIES SHALL BE ATTENDED TO BE A LICENSED AND CERTIFIED ARBORIST.

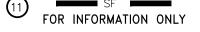

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SILT FENCE: SILT FENCE SHALL CONSIST OF WOVEN GEOTEXTILE FABRIC WITH A MINIMUM WIDTH OF 36 INCHES. WOOD STAKES SHALL BE COMMERCIAL QUALITY LUMBER, SPACED A MAXIMUM OF 6' APART AND DRIVEN SECURELY INTO THE GROUND (SEE DETAIL). FENCING FABRIC SHALL BE KEYED INTO THE SOIL AS PER MANUFACTURER'S RECOMMENDATIONS. INSTALL SILT FENCE ALONG LEVEL CONTOURS. TURN THE ENDS OF THE SILT FENCE UPHILL TO PREVENT WATER FROM FLOWING AROUND THE FENCE. INSPECT SILT FENCE DAILY, AND MAKE REPAIRS IMMEDIATELY.


#### TABLE 1706 6 DECLUDED VEDICICATION AND INSPECTION OF SOILS

| TABLE 1706.6 REQUIRED VERIFICATION AND INSPECTION OF SOILS                                                          |                                     |                                       |  |  |
|---------------------------------------------------------------------------------------------------------------------|-------------------------------------|---------------------------------------|--|--|
| VERIFICATION AND INSPECTION TASK                                                                                    | CONTINUOUS<br>DURING TASK<br>LISTED | PERIODICALLY<br>DURING TASK<br>LISTED |  |  |
| 1. Verify material below shallow foundations are adequate to achieve the design bearing capacity                    |                                     | ×                                     |  |  |
| 2. Verify excavations are extended to proper depth and have reached proper material                                 |                                     | Х                                     |  |  |
| 3. Perform classification and testing of compacted fill materials                                                   |                                     | Х                                     |  |  |
| 4. Verify use of proper materials, densities and lift sicknesses during placement and compaction of compacted fill. | Х                                   |                                       |  |  |
| 5. Prior to placement of compacted fill, observe subgrade and verify that site has been prepared properly.          |                                     | Х                                     |  |  |

# CONSTRUCTION INSPECTION REQUIREMENTS

- A-PRIOR TO COMMENCEMENT OF ANY LAND DISTURBANCE, THE OWNER/APPLICANT SHALL SCHEDULE AN INSPECTION WITH HCD-ENVIRONMENTAL SERVICES TO ENSURE ALL NECESSARY SEDIMENT CONTROLS ARE IN PLACE AND THE PROJECT IS COMPLIANT WITH MONTEREY COUNTY GRADING AND EROSION CONTROL REGULATIONS.
- B-DURING CONSTRUCTION THE OWNER/APPLICANT SHALL SCHEDULE AN INSPECTION WITH HCD-ENVIRONMENTAL SERVICES TO UPDATE COMPACTION TEST RECORDS, INSPECT DRAINAGE DEVICE INSTALLATION, REVIEW THE MAINTENANCE AND EFFECTIVENESS OF BMP's INSTALLED, AS WELL AS, TO VERIFY THAT POLLUTANTS OF CONCERN ARE NOT DISCHARGED FROM THE SITE.
- C-PRIOR TO FINAL INSPECTION, THE OWNER/APPLICANT SHALL SCHEDULE AN INSPECTION WITH HCD-ENVIRONMENTAL SERVICES TO CONDUCT A FINAL GRADING INSPECTION, COLLECT FINAL GEOTECHNICAL LETTER OF CONFORMANCE, ENSURE THAT ALL DISTURBED AREAS HAVE BEEN STABILIZED AND THAT ALL TEMPORARY EROSION AND SEDIMENT CONTROL MEASURES THAT ARE NO LONGER NEEDED HAVE BEEN REMOVED.

#### Solid Waste Management

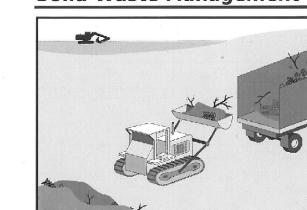

**Description and Purpose** Solid waste management procedures and practices are designed to prevent or reduce the discharge of pollutants to stormwater from solid or construction waste by providing designated waste collection areas and containers, arranging for regular disposal, and training employees and subcontractors.

Potential Alternatives

WM-1

Erosion Control

C Tracking Control

WE Wind Erosion Contro

Primary Category

Oil and Grease

Secondary Category

**Targeted Constituents** 

Non-Stormwater

Management Control

Waste Management and

Materials Pollution Control

SE Sediment Control

# **Targeted Constituents** Oil and Grease

Potential Alternatives

Organics

Categories

EC Erosion Control

SE Sediment Control

TC Tracking Control

WE Wind Erosion Control

Primary Category

Secondary Category

Non-Stormwater

Management Control

Waste Management and

Materials Pollution Control

EC Erosion Control

SE Sediment Control

TC Tracking Control

WE Wind Erosion Control

Non-Stormwater


☑ Primary Objective

Secondary Objective

Waste Management and

Materials Pollution Control


## Sanitary/Septic Waste Management WM-9

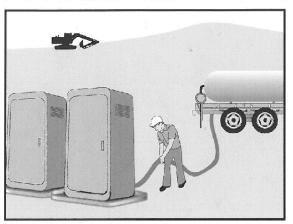

**Description and Purpose** Proper sanitary and septic waste management prevent the discharge of pollutants to stormwater from sanitary and septic waste by providing convenient, well-maintained facilities, and arranging for regular service and disposal.

Targeted Constituents Oil and Grease Organics **Potential Alternatives** 

## **Hazardous Waste Management**

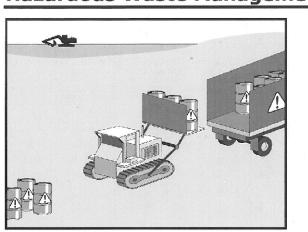

**Description and Purpose** Prevent or reduce the discharge of pollutants to stormwater from hazardous waste through proper material use, waste disposal, and training of employees and subcontractors.

**Targeted Constituents** Nutrients Oil and Grease

SE Sediment Control

TC Tracking Control

WE Wind Erosion Control

Primary Objective

■ Secondary Objective

Management Control

Waste Management and

Materials Pollution Contro

WM-6

Potential Alternatives

EC Erasian Control

SE Sediment Control

TC Tracking Control

NS Non-Stormwater

WE Wind Erosion Control

☑ Primary Objective


Secondary Objective

Management Control

Waste Management and

Materials Pollution Control

#### **Preservation Of Existing Vegetation EC-2**

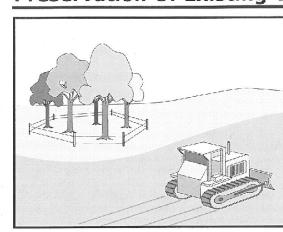

**Description and Purpose** Carefully planned preservation of existing vegetation minimizes the potential of removing or injuring existing trees, vines, shrubs, and grasses that protect soil from erosion.

**Targeted Constituents** Metals Oil and Grease

SCALE: AS SHOWN DATE: OCTOBER 2024


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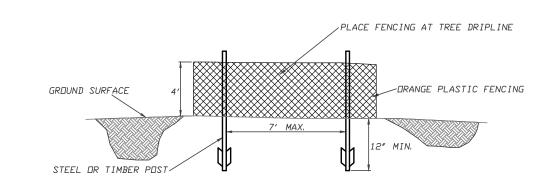
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JOB NO. 2761-02

12/20/24 AMS SITE PLAN UPDATE 12/12/24 AMS SITE PLAN UPDATE 10/04/24 AMS RELEASED TO CLIENT No. DATE BY REVISION





FENCING (ESA) DETAIL

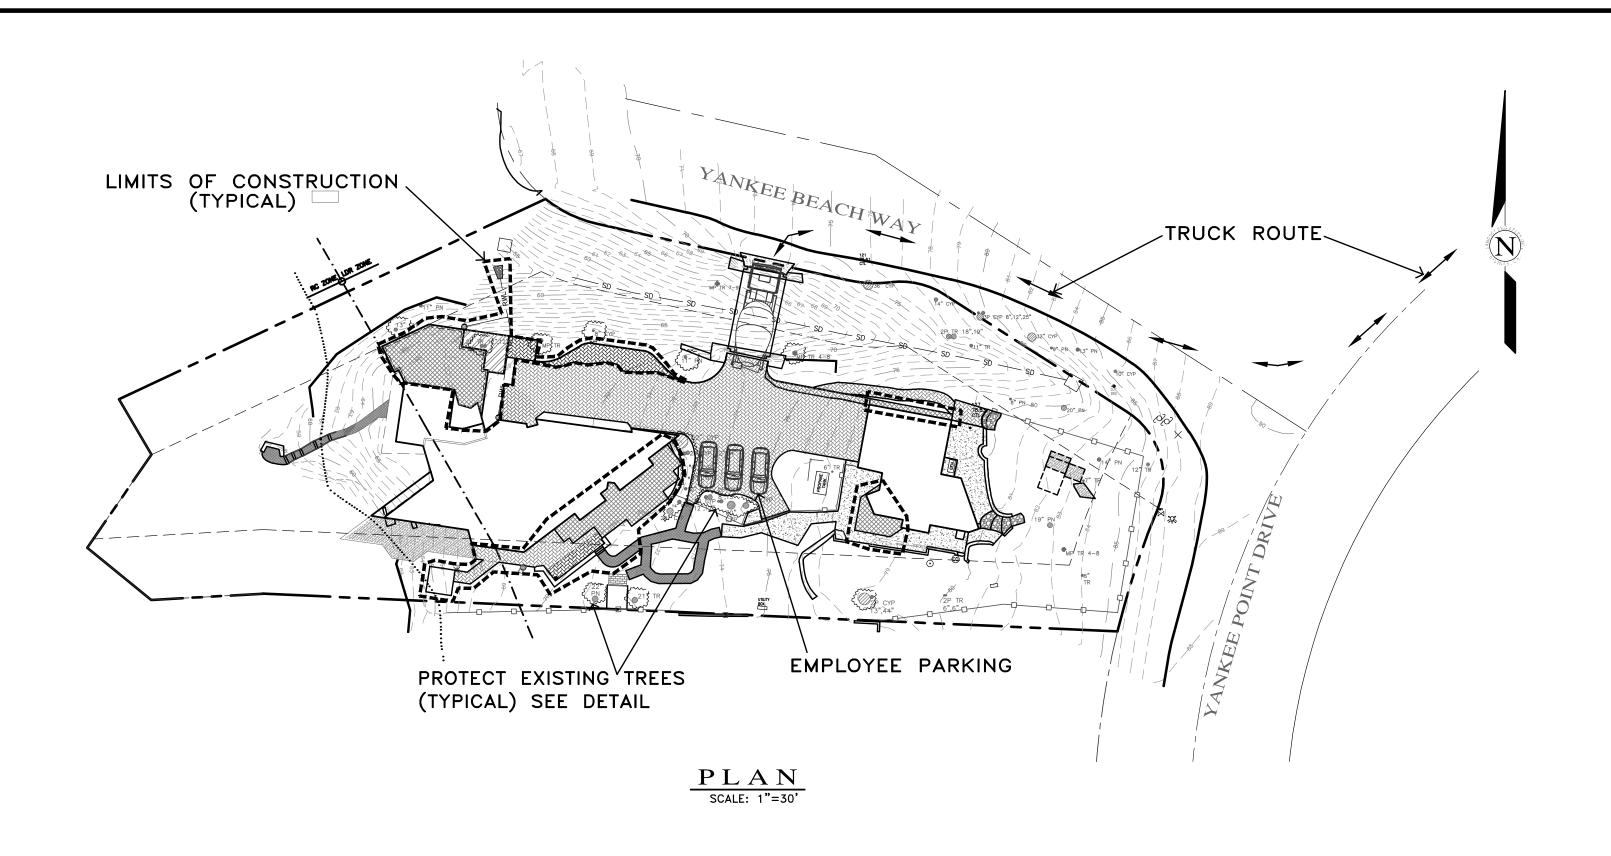EARTHWORK QUANTITIES PER CIVIL ENGINEERING PLANS BY LANDSET ENGINEERS, INC.: 10 CY FILL

DEMOLISH EXISTING HARDSCAPE AND OFFHAUL DEBRIS: EXISTING DRIVEWAY TO BE USED FOR EQUIPMENT STAGING AND TEMPORARY STOCKPILE AREA IF REQUIRED.

PERFORM MINOR GRADING, CONSTRUCT STRUCTURE ADDITIONS, AND INSTALL UNDERGROUND UTILITIES: EXISTING DRIVEWAY AREA TO BE USED FOR MATERIAL AND EQUIPMENT STAGING.

#### INSTALL NEW LANDSCAPING.

SEE ARCHITECTURAL AND CIVIL PLANS FOR EROSION CONTROL AND DEMOLITION NOTES.

CONSTRUCTION EQUIPMENT AND MATERIALS SHALL NOT BE STAGED ON YANKEE BEACH WAY AT ANY TIME DURING CONSTRUCTION. MATERIAL DELIVERIES SHALL BE SCHEDULED SUCH THAT THEY ARE USED PROMPTLY, AND MATERIAL STORAGE IS MINIMIZED. ALL CONSTRUCTION EQUIPMENT AND MATERIALS SHALL BE STORED IN A DESIGNATED AREA ON THE SUBJECT PROPERTY.

THE HAUL ROUTE TO THE SITE IS FROM HIGHWAY 1 TO YANKEE POINT DRIVE TO YANKEE BEACH WAY. (HAUL TRUCKS EXIT IN THE SAME FASHION.) VEHICLES SHALL NOT BE LEFT UNATTENDED WHILE IN QUEUE (IF NECESSARY) ON YANKEE BEACH WAY. CONTRACTOR TO ENSURE THAT HEIGHT RESTRICTIONS WITHIN THE DRIVEWAY AREA SHALL BE ADDRESSED BEFORE CONSTRUCTION VEHICLES ENTER THE SITE. SEE DETAILS B AND C, TRUCK ROUTING PLANS.

IN THE EVENT THAT MATERIAL DELIVERIES CAUSE ANY STREETS ALONG THE HAUL ROUTE TO BE PARTIALLY BLOCKED BY DELIVERY TRUCKS OR LOADING/UNLOADING OPERATIONS, A FLAGMAN SHALL BE PRESENT TO DIRECT TRAFFIC AROUND THE LANE OBSTRUCTION. THE FLAGMAN SHALL BE PRESENT AT ALL TIMES DURING WHICH DELIVERY/CONSTRUCTION OPERATIONS MAY IMPACT TRAFFIC ON THE HAUL ROUTE AND SURROUNDING STREETS.

LIMITED EMPLOYEE PARKING ON-SITE. EMPLOYEES SHALL USE PUBLIC PARKING LOTS AND CARPOOL TO JOBSITE IF POSSIBLE. ON-SITE PARKING SHALL BE IN LEGAL SPACES ALONG YANKEE BEACH WAY, OBEYING ALL PARKING LAWS. PARKING IS PROHIBITED IN ALL NATURAL AREAS WHICH ARE NOT CURRENTLY PAVED OR GRAVEL.

<u>LIMITS OF CONSTRUCTION:</u> ALL CONSTRUCTION SHALL TAKE PLACE WITHIN THE BORDER AS SHOWN. EXISTING CYPRESS, PINE, AND OAK TREES LOCATED WITHIN THE LIMITS SHOWN SHALL BE SURROUNDED BY ORANGE PROTECTIVE FENCING (SEE DETAIL).

#### TRUCK TRIP GENERATION CHART:

| CATEGORY                           | NO. OF TRUCK<br>TRIPS | TOTAL DAYS |
|------------------------------------|-----------------------|------------|
| DEMOLITION/CLKEARING               | 4                     | 2          |
| GRADING & SOIL<br>REMOVAL (EXPORT) | 4                     | 2          |
| ENGINEERING<br>MATERIALS (IMPORT)  | 2                     | 2          |
| TOTALS                             | 10                    | 6          |

#### 8TRUCK TRIP GENERATION NOTES:

1. TRUCK TRIPS FOR THE GRADING/SOIL REMOVAL IS BASED UPON 8 CUBIC YARDS PER TRUCKLOAD WITH AN AVERAGE OF 5 TRUCK LOADS PER DAY. 2. THERE IS NOT SURPLUS SOIL MATERIAL THAT WILL BE EXPORTED OFF THE


3. GRADING OPERATIONS SHALL TAKE APPROXIMATELY 2 WORKING DAYS TO

4. THE AMOUNT OF GRADING PER DAY WILL VARY, THE AVERAGE BETWEEN 10 & 50 CUBIC YARDS.

#### NUMBER OF EMPLOYEES/DAY: 4-10

#### HOURS OF OPERATION/DAY: 8

PROJECT SCHEDULING: PROJECTED START DATE 6 JANUARY 2025, 2 WORKING DAYS TO COMPLETE GRADING, MONDAY THRU FRIDAY, 8:00 A.M. - 4:30 P.M. TOTAL PROJECT DURATION IS APPROXIMATELY

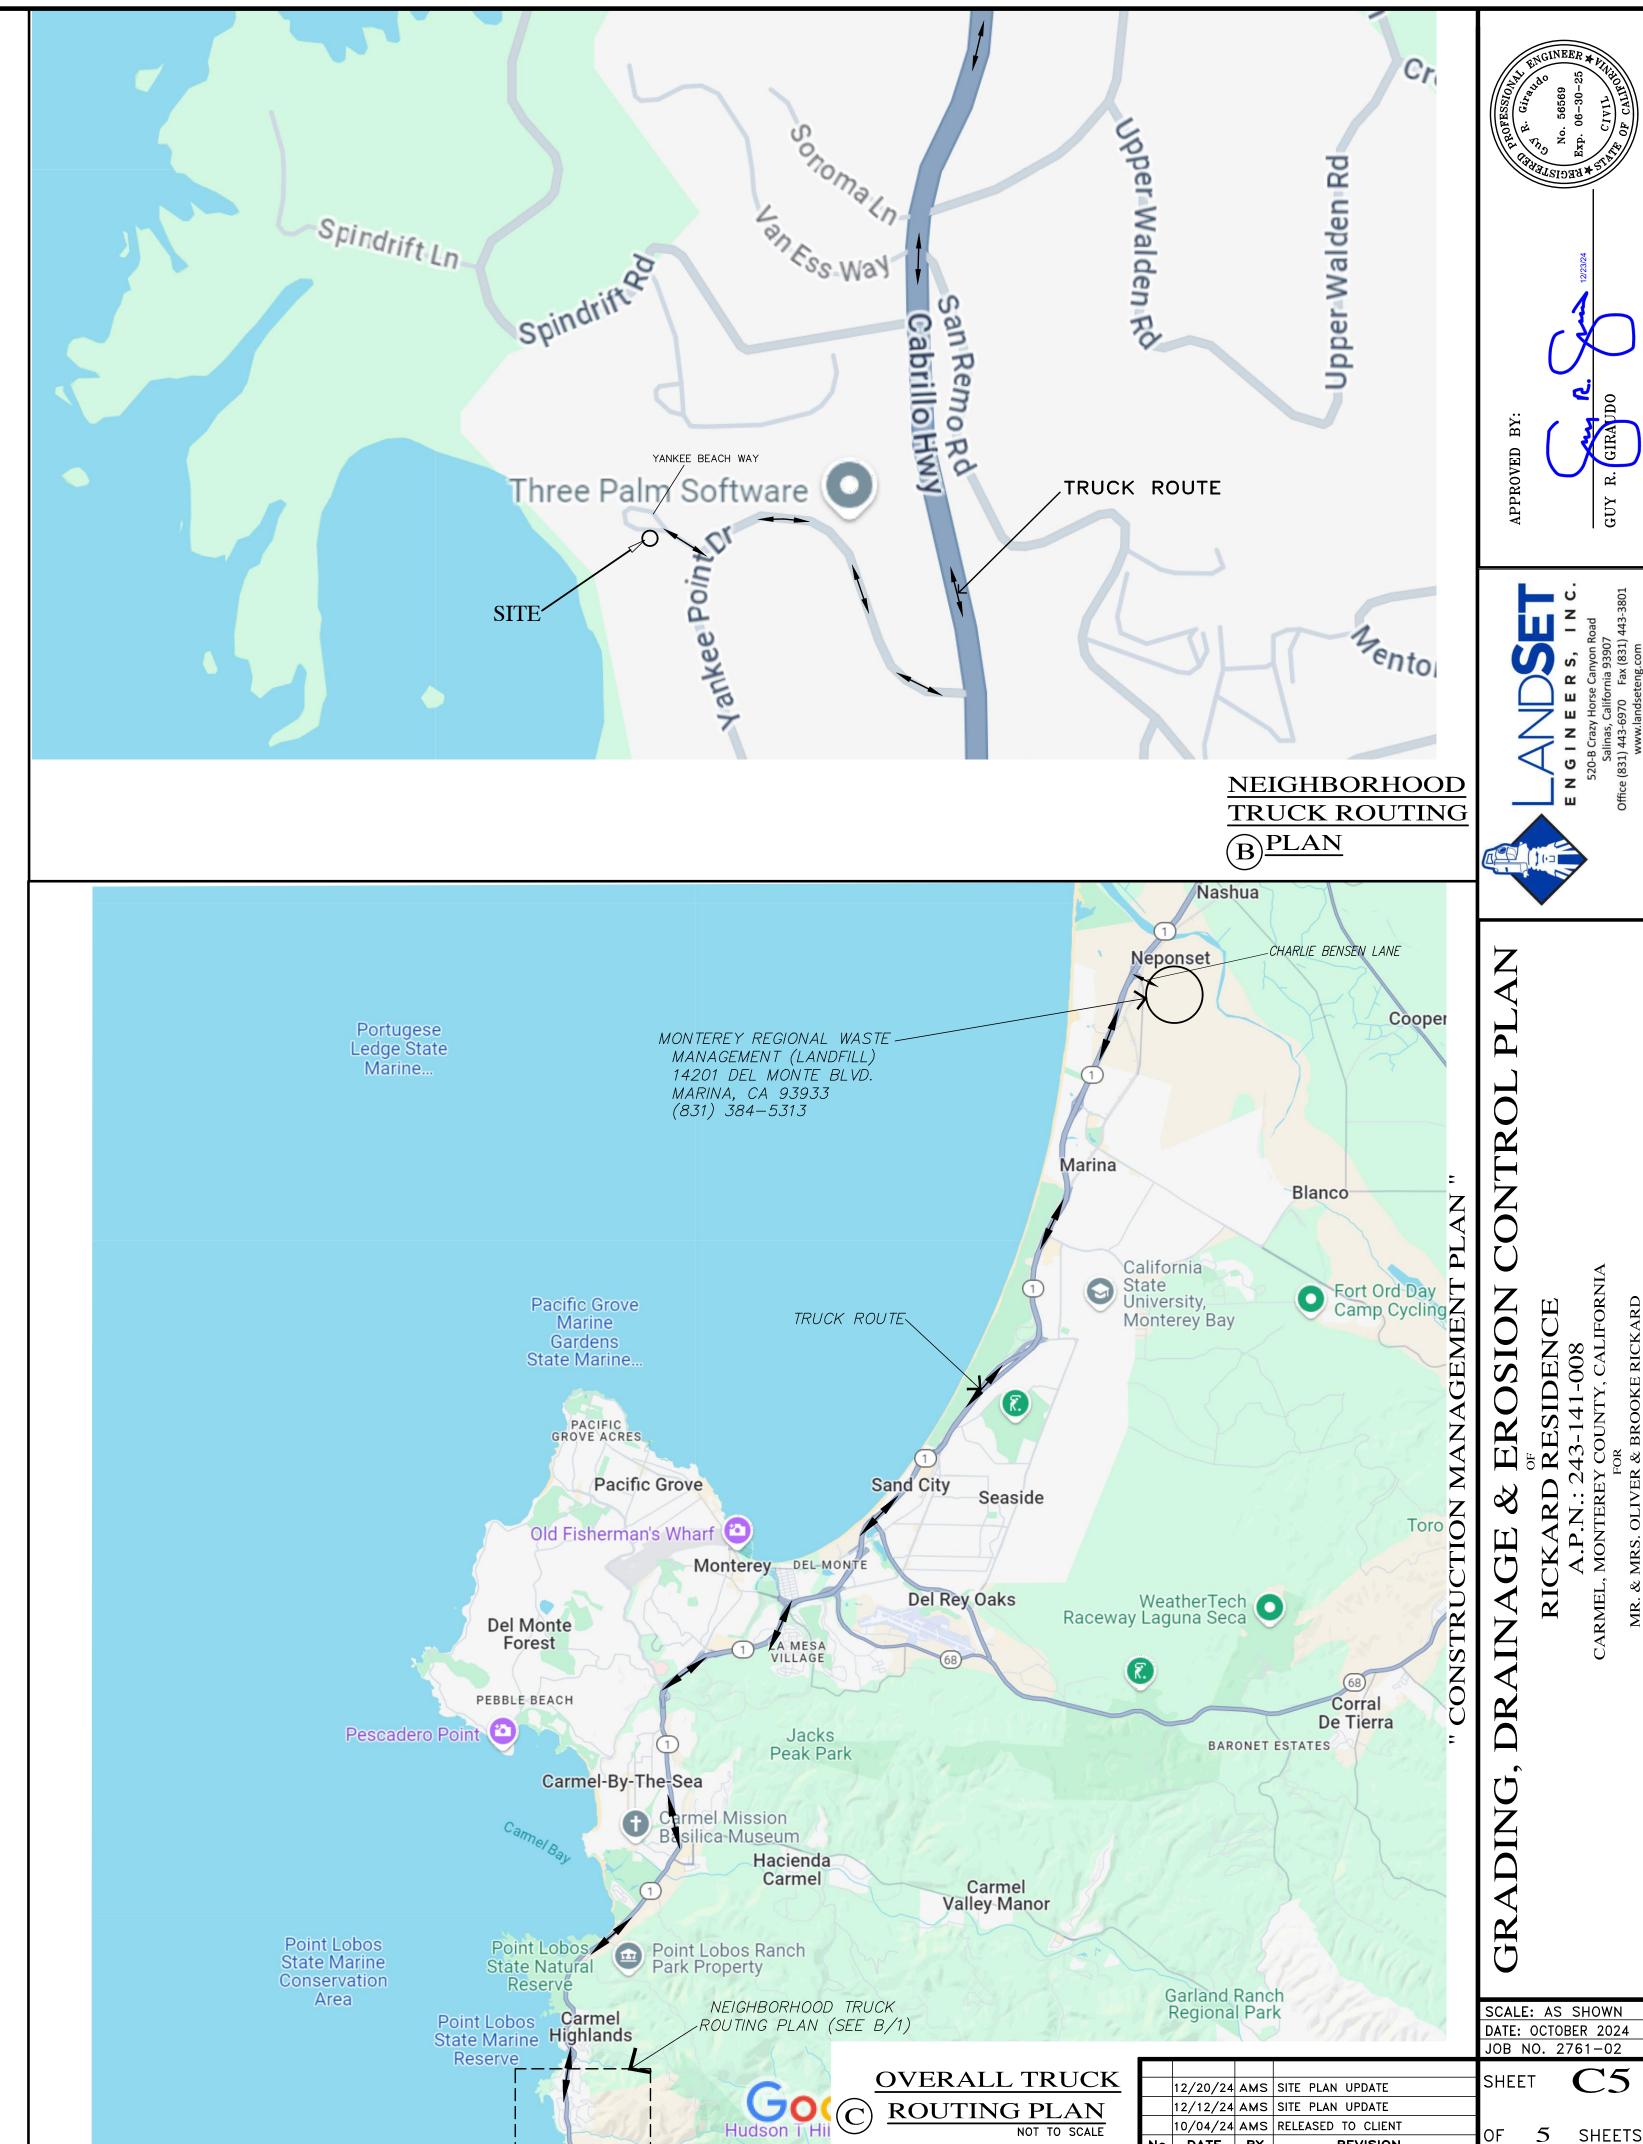

No. DATE BY