

Attachment D

This page intentionally left blank.

**Before the Zoning Administrator
in and for the County of Monterey, State of California**

In the matter of the application of:

SCHWARTZ MAL (PLN200192)

RESOLUTION NO. 21 - 025

Resolution by the Monterey County Zoning
Administrator:

- 1) Finding that the project qualifies as a Class 3 Categorical Exemption pursuant to Section 15303 of the CEQA Guidelines, and there are no exceptions pursuant to Section 15300.2; and
- 2) Approving a design approval to amend PLN170572 to permit expanding the studio addition from 355 square feet to 531 square feet and a 63 square foot landing; modifying the roof of the studio addition to have (2) skylights instead of (1) skylight; an interior remodel of the southeastern portion of the home, including conversion of the garage to living space and removal and replacement of the garage door with lap siding; construction of a new 447 square foot attached two-car carport; re-finishing the chimney with a Carmel Stone to address the presently unpermitted white “swiss coffee” smooth stucco finish, and; construction of a 4 foot tall to 6 foot tall cedar fence. The project also includes retro-active design approval for: painting the exterior of the primary residence a white “swiss coffee” color, and; adding a metal flue cap and spark arrester to the top of the chimney, subject to six (6) conditions of approval.

[Schwartz, 24980 Outlook Drive, Carmel, Carmel Valley Master Plan (APN: 015-522-008-000)]

The Schwartz application (PLN200192) came on for a public hearing before the Monterey County Zoning Administrator on April 29, 2021 and May 13, 2021. Having considered all the written and documentary evidence, the administrative record, the staff report, oral testimony, and other evidence presented, the Zoning Administrator finds and decides as follows:

FINDINGS

1. **FINDING:** **CONSISTENCY** - The proposed project, as conditioned, is consistent with the policies of the Monterey County 2010 General Plan, Carmel Valley Master Plan, and Monterey County Zoning Ordinance (Title 21).

EVIDENCE: a) The proposed project involves the addition of a 531 square foot studio with (2) skylights and a 63 square foot landing to an existing 2,645 square foot single-family residence. The project also includes a remodel of the plan southeastern portion of the residence, including the conversion of the existing garage to habitable space. As part of this scope the garage door will be removed, and the opening will be replaced with lap siding to match the existing finish of the home. A new 447 square foot attached two-car carport will be built in the front of the home, and a new cedar fence ranging from 4 feet to 6 feet in height will be added to the plan eastern property line. The Chimney will be re-finished with Carmel Stone to address the current non-permitted white “swiss coffee” smooth coat stucco. A light stone finish called out at “Heath Ceramics Diamond Tile or Similar” is indicated on the plans for PLN170572, and a Carmel stone finish is indicated on the approved building permit plans 17CP03455. The tone of the stone is clarified in the project plans. The request also includes retro-active approval to paint the exterior of the primary residence a white “swiss coffee” color, and to add a metal flue cap to the top of the chimney. The project grading is approximately 20 cubic yards of cut and 20 cubic yards of fill.

This design approval is an amendment of the previously approved PLN170572, which had approved of a 355 square foot studio addition with a skylight, addition of a 1,236 square foot deck, and replacement of the of the exterior siding, doors, and windows.

The change scope between the original PLN170572 and this permit (PLN200192) is the addition of an additional 176 square feet of studio addition, addition of a 63 square foot landing, the addition of the remodel scope in the southeastern portion of the residence, the addition of the 447 square foot 2-car car-port, the addition of the cedar fence, a request for approval to re-finish the chimney with the tan Carmel stone, a request for retro-active approval to re-paint the exterior of the residence, and a request for retro-active approval to add a metal flue-cap. The addition of the 1,236 square foot deck and the replacement of the exterior siding, doors, and windows for the primary residence (excepting the modifications to the southeastern portion of the residence) have also already been executed under PLN170572.

- b) The property is located at 24980 Outlook Drive, Carmel (APN: 015-522-008-000), Carmel Valley Master Plan. The parcel is zoned Low Density Residential, with Building Site, Design Control, Site Plan Review, and Residential Allocation zoning overlays or “LDR/B-6-D-S-RAZ”.
- c) The project has been reviewed for consistency with the text, policies, and regulations in:
 - the 2010 Monterey County General Plan;

- The Carmel Valley Master Plan; and
 - Monterey County Zoning Ordinance (Title 21).
- d) Communications were received during the course of review of the project indicating inconsistencies with the text, policies, and regulations in the applicable documents. Staff reviewed these communications and has addressed these inconsistencies. Refer to evidences “e”, “f”, and “g”, as well as Finding No. 6.
- e) Process. The project has both Site Plan Review (S) and Design Control (D) overlay zones.
- Pursuant to Title 21 Section 21.45.050(C), the Director of Planning, or the Zoning Administrator, may approve “small development projects such as structure additions, accessory structures, decks, fences... and minor modifications to previously approved projects” in the Site Plan Review overlay zone without the benefit of an administrative permit.
 - Pursuant to Title 21 Section 21.44.040, the Director of Planning may approve Design Approvals for “small structures such as additions, accessory structures and similar minor structure and minor modifications to previously approved development projects...” in the Design Control overlay zone.

In accordance with these two code sections, staff reviewed an Administrative Design Approval for PLN200192. A Notice of Pending Approval was distributed on September 29, 2020, indicating that the Director of Planning would take action to approve the permit on October 12, 2020, unless a written request to schedule the application for a public hearing was received by Friday, October 9, 2020.

On October 3, 2020 Robert A. Kahn submitted a request via email that this application be referred to a public hearing. On October 9, 2020, Christine G. Kemp submitted a subsequent request that this application be referred to a public hearing before the Planning Commission. In her October 9, 2020 request, Ms. Kemp indicates that the project requires a Variance or Use Permit for development within the Side and Rear Yard setback, and that the Planning Commission would be the appropriate authority to consider such a request as a Combined Development Permit. However, while a small portion of the existing garage is within the side setback area, pursuant to Title 21 Section 21.68.020(A), the enlargement, extension, reconstruction or structural alteration of a nonconforming structure nonconforming only as to height and yard regulations may be allowed provided that the alteration conforms to all regulations of the district they are located in:

- The alteration of the southeastern portion of the residence within the setback does not expand the existing nonconformity.
- All new structural expansion occurs within the allowable setbacks of the properties zoning, and the setback exceptions detailed in the zoning ordinance, so a variance is not required

in this case. Refer to subsequent evidence “g” for detailed discussion of the setbacks.

- The use is allowable under the base zoning district, and none of the other criteria requiring a use permit are met, so a use permit is not required in this case. As the use allowable under the base zoning district, and not a legal nonconforming use of a structure, Title 21 Section 21.68.030 does not apply. Refer to subsequent evidence “f” for discussion of the use.

In addition, the October 9, 2020 request indicated that there were multiple code violations on the property that must be addressed prior to taking action on the permit:

- Unpermitted painting of the exterior of the home white.
- Unpermitted modification of the chimney.
- Unpermitted modification of the shed rear yard.

The applicant revised their original application to request retro-active approval for the paint color of the primary home and to modify the chimney. Staff researched the existing shed, and were able to determine that the finish and skylights were in line with their original approval, but were not able to verify the height prior to the hearing. At the hearing, representatives of the applicants confirmed that the shed was twelve feet, higher than its originally approved height of eight feet in DA190154. While unhabitable accessory structures are permitted up to fifteen feet in height under the base zoning, this is a violation of the original conditions of design approval DA190154, and is addressed in condition 6. The applicant is also pursuing necessary permits with Building & Safety to permit addition of electrical power to the shed. All of these are discussed in Finding No. 6.

As neither a Use Permit nor Variance are required, the appropriate entitlement for this project is an Administrative Design Approval. The County is in receipt of 2 written requests to refer this application to a public hearing, therefore, pursuant to Title 21 Section 21.70.060, this Administrative design approval is being referred to the Zoning Administrator for their consideration.

- f) Allowable Use. Pursuant to Title 21 Section 21.14.030, allowable uses in the LDR zone include “The first single family dwelling per lot;” and “Non-habitable accessory structures and accessory uses to any permitted use;”
- The addition of the studio and the remodel of the southeastern portion of the home are additions to the living space of the first single family dwelling on the lot, and as such are an allowable use.
 - The 2-car carport and fence are both non-habitable accessory structures to the single-family home, and as such are allowable uses.
 - The existing shed was permitted as a storage shed in DA190154. The applicants intend to convert this shed to an art studio through the addition of electrical. Both a storage

shed and an art studio are non-habitable accessory structures, and as such are allowable uses.

- g) Review of Development Standards. The development standards for the base LDR zoning district are identified in Title 21 Section 21.14.060, and the development standards of the building site B-6 zoning district are identified in Title 21 Section 21.42.030. Pursuant to Title 21 Section 21.42.020, the regulations of the B-6 zoning overlay shall be applied “in lieu of the building site area and setbacks in the combining district...”

The allowable setbacks per Title 21 Section 21.42.030(F)(2) are as follows:

- The minimum front setback shall be 30 feet. As shown on sheet A1.0 of the proposed project plans, the proposed studio addition is outside of this setback area. The attached 2-car carport encroaches into this setback, however, pursuant to Section 21.62.040(N). encroachment into this setback may be permitted for attached carports in cases where, “the elevation of the front half of the lot at a point 50 feet from the centerline of the traveled roadway is seven feet above or below the grade of said centerline,...” In this case the elevation at a point at the centerline of Outlook Drive is 85 feet and 6 inches, while the elevation 50’ from centerline drive is approximately 95 feet. This is greater than 7 feet higher than the centerline of Outlook Drive, and therefore this setback exception is allowable.
- The minimum side setback shall be 10% of the lot width. As the width of the property is 123 feet and 10 ½ inches, the allowable side setback is 12 feet and 4 ½ inches. As shown on the site plan A1.0, the proposed 531 square foot studio addition is within this allowable setback.
 - o The 63 square foot deck for this addition does encroach into the setback, however, such encroachments are permitted within the Height and Setback Exception detailed in Title 21 Section 21.62.040(D).
 - o The 4 foot tall to six foot tall fence also runs along the plan east property line. However, pursuant to the definition of structures in Title 21 Section 21.06.1220, a fence under six feet in height is not a “structure” and is therefore not subject to the setback requirement.
- The minimum rear yard setback shall be 20 feet. As shown on sheet A1.0 of the proposed project plans, the scope of work for the project is outside of this setback area.

Pursuant to Title 21 Section 21.14.060(C)(1)(b), the maximum allowable main structure height is 30 feet. The proposed highest point of the main structure is 14 feet and 11 ¾ inches.

Pursuant to Title 21 Section 21.14.060(E), the maximum allowable lot coverage on lots greater than 20,000 square feet (25,114 square

feet in this case) is 25%, or 6,278 square feet. The proposed lot coverage is 16.7%, or 4,199 square feet.

Therefore, as proposed, the project meets all required development standards.

- h) Design. See Finding No. 2.
- i) Cultural Resources. The project site is in an area identified in County records as having a moderate archaeological sensitivity, however, the area of proposed development has been disturbed by previous structural, hardscape, and landscape development. Therefore, there is no evidence that any cultural resources would be disturbed, and the potential for inadvertent impacts to cultural resources is limited and will be controlled by application of the County's standard project condition (Condition No. 3), which requires the contractor to stop work if previously unidentified resources are discovered during construction.
- j) The project was referred to the Carmel Valley Land Use Advisory Committee (LUAC) for review. Based on the LUAC Procedure guidelines adopted by the Monterey County Board of Supervisors, this application warranted referral to the LUAC because the project is a Design Approval subject to review by the Zoning Administrator. The LUAC, at a duly-noticed public meeting on April 19, 2021, voted 6 – 0 to recommend approval of the project with change the following changes:
 - That the skylights include shades.
 - That the skylights be non-reflective.
 - That the Carmel stone on the chimney be a muted tan.

To address these recommendations, the applicant has modified their proposal to:

- Include shades for the skylight.
- Specify that the glass be a Low-E glass, which have a slight greyish tint.
- Include a tan Carmel stone finish for the chimney.

To ensure that these changes are executed, a special condition "PDSP001" is being included, which requires that the applicant furnish evidence that the shades, glass, and Carmel Stone were installed as specified, prior to building final.

- k) The application, plans, and supporting materials submitted by the project applicant to Monterey County HCD-Planning for the proposed development found in project file PLN200192.

2. **FINDING:** **DESIGN** – The design of the proposed project assures protection of the public viewshed, is consistent with neighborhood character, and assures visual integrity without imposing undue restrictions on private property.

EVIDENCE: a) The Applicant proposes involves the addition of a 531 square foot studio with (2) skylights and a 63 square foot landing to an existing 2,645 square foot single-family residence. The project also includes a remodel of the plan southeastern portion of the residence, including

the conversion of the existing garage to habitable space. As part of this scope the garage door will be removed, and the opening will be replaced lap siding to match the existing finish of the home. A new 447 square foot cedar attached two-car carport will be built in the front of the home, and a new cedar fence ranging from 4 to 6 feet in height will be added to the plan eastern property line. The request also includes a retro-active approval to paint the exterior of the primary residence a white “swiss coffee” color, to re-finish the chimney with a tan Carmel Stone, and to add a metal flue cap to the top of the chimney.

- b) Pursuant to Section 21.44, Title 21 (Zoning Ordinance) of the Monterey County Code (MCC), the proposed project site and surrounding area are designated as a Design Control Combining District (D District), which regulates the location, size, configuration, materials, and colors of structures and fences to assure the protection of the public viewshed and neighborhood character.
- c) Neighborhood Character. The neighborhood is composed of single-family homes of a variety of traditional materials and styles. The proposed addition is in scale with the other homes in the neighborhood and is consistent with the designs in the area. Refer to evidence d) for discussion of the finishes.
- d) Material and Color Finishes. The proposed material finishes include lap siding painted a white “swiss coffee” color, for both the addition and primary residence, a tan Carmel Stone for the chimney, a metal flue cap on the chimney, and a stained cedar for the carport and fence. Both lap siding and smooth coat stucco are traditional building materials consistent with the material textures of other homes in the neighborhood. The white is a neutral color, consistent with the material finish of other homes along Outlook Drive, and the Carmel Stone is a tan earth tone, in line with other residence in the area. The metal flue cap is an appurtenance common to gas fireplaces and is an appropriate addition to the existing chimney, similar to other residences in the area. The cedar is a natural wood tone, compatible with the surrounding natural environment and neighborhood.
- e) Visual Resources. The project site is within an area of high visual sensitivity, as designated on Figure 14 (Greater Monterey Peninsula Scenic Highway Corridors and Visual Sensitivity Map) of the 2010 Monterey County General Plan. The proposed project is an addition to an existing single-family residence, well below the allowable building site coverage, below the height approved in the previous design approval PLN170572, and including finish changes to white, a neutral color, a tan natural stone, and cedar which is a natural color. Therefore, as proposed, the project would not result in substantial adverse visual impacts, and the project is consistent with the applicable scenic resource policies of the 2010 General Plan and the Carmel Valley Master Plan.
- f) Carmel Valley Master Plan Policy CV-1.20. Refer to Finding No. 3.
- g) The project planner reviewed the application materials, plans, and County GIS records to verify that the proposed project on the subject parcel conforms to the applicable plans and MCC, and will not

adversely impact the neighborhood character or scenic/visual resources.

- h) The project planner conducted a site inspection on April 1, 2021, and reviewed the project site, revised finishes, location of the proposed addition, and other homes within the neighborhood. Based on this visual inspection the project planner verified that the proposed project is consistent with the criteria for design approval established in Design Control District.
- i) Based on the evidence described above, the proposed structure and use are consistent with the surrounding residential neighborhood character (i.e., structural design features, colors, and material finishes). The proposed development would also not have a significant impact on a public viewshed. As proposed, the project assures protection of the public viewshed, is consistent with neighborhood character, and assures visual integrity.
- j) The application, plans, and supporting materials submitted by the project applicant to Monterey County HCD-Planning for the proposed development found in project file PLN200192.

3. **FINDING:** **CARMEL VALLEY MASTER PLAN POLICY CV-1.20** – The project, as proposed and conditioned, is consistent with Land-use Policy CV-1.20 of the Carmel Valley Master Plan.

- EVIDENCE:**
- a) The Carmel Valley Master Policy CV-1.20 indicates that proposed development conspicuous from outside of the property consider several guidelines. These are considered in evidence “b” through “h” below.
 - b) The proposed development encourages and furthers the letter and spirit of the Master Plan. No inconsistencies were identified in the review process indicating that the proposed development does not further the letter and spirit of the master plan.
 - c) The development is visually compatible with the character of the valley and immediate surrounding. The immediate surrounding environment within the valley for the proposed project is a developed single-family neighborhood. The proposed project is compatible with the character of this neighborhood. Reference Finding No. 2, Evidence “c” and “d”.
 - d) Materials and colors selected for use in construction are compatible with the structural system of the building and with the appearance of the building’s natural and man-made surroundings. The stained wood finish of the carport and fence blends with the natural environment, while the white finish of the home is compatible with the single-family homes in the neighborhood and the existing shed, which was previously approved Design Approval (File No. DA190154). The Carmel stone selected is a tan, intended to be more muted in tone than the existing white and based on the Carmel Valley Land Use Advisory Committee’s recommendation.
 - e) “Structures should be controlled in height and bulk in order to retain an appropriate scale.” The height and bulk of the structure are in appropriate scale for the homes in the neighborhood. The change in roof profile reduces the height of the building from the previously approved PLN170572, the studio addition follows plane of the front

section of the home, and the attached carport is a single story below the height of the existing roof. The spark arrestor and flue cap is a small mechanical appurtenance required by building safety codes. It is appropriate in scale with the building and similar to other flue caps on chimney's in the neighborhood.

- f) "Development, including road cuts as well as structures, should be located in a manner that minimizes disruption of views from existing homes." The location of the chimney is unchanged, so the location of the flue cap is most appropriate on the existing chimney. The studio addition is being expanded closer to the adjoining property line with the east property owner, however, the extent of this expansion is in plane with the front portion of the structure, and the overall height of this addition is being reduced from the approved PLN170572.
- g) The project minimizes erosion and/or modification of landforms. With the exception of the property fence, all development takes place in areas previously disturbed by development, which minimizes modifications to landforms and potential erosion. The studio addition is replacing an existing concrete patio, while the new 2-car carport is being installed in a paved driveway. Erosion is also controlled through the inclusion of an erosion control / construction management plan, which is shown on sheet G1.6 of the project plans.
- h) "Minimize grading through the use of step and pole foundations." The foundation is a continuation of the existing foundation of the home. Grading has been minimized to approximately 20 cubic yards of cut and 20 cubic yards of fill.

4. **FINDING:**

ENVIRONMENTAL REVIEW – The project is categorically exempt from environmental review and no unusual circumstances were identified to exist for the proposed project.

EVIDENCE:

- a) California Environmental Quality Act (CEQA) Guidelines Section 15303 categorically exempts new construction and conversion of small structures.
- b) The project consists of the remodel of and addition to an existing single-family dwelling, and construction of accessory structures (a 2-car carport and a fence) to a residentially zoned parcel within a developed neighborhood. Therefore, the proposed development is consistent with CEQA Guidelines Section 15303.
- c) None of the exceptions under CEQA Guidelines Section 15300.2 apply to this project. There is no substantial evidence of an unusual circumstance because there is no feature or condition of the project that distinguishes the project from the exempt class. The project does not involve a designated historical resource, a hazardous waste site, development located near or within view of a scenic highway. There is no substantial evidence that would support a fair argument that the project has a reasonable possibility of having a significant effect on the environment or that it would result in a cumulative significant impact.
- d) No adverse environmental effects were identified during staff review of the development application.

5. **FINDING:** **HEALTH AND SAFETY** – The establishment, maintenance, or operation of the project applied for will not under the circumstances of this particular case be detrimental to the health, safety, peace, morals, comfort, and general welfare of persons residing or working in the neighborhood of such proposed use, or be detrimental or injurious to property and improvements in the neighborhood or to the general welfare of the County.

- EVIDENCE:**
- a) The project has been reviewed by HCD-Planning, and conditions have been recommended, where appropriate, to ensure that the project will not have an adverse effect on the health, safety, and welfare of persons either residing or working in the neighborhood.
 - b) Necessary public facilities are available. The existing single-family dwelling has public water and sewer connections provided by the California American Water Company and the Carmel Area Wastewater District, respectively, and the new residence will continue to use these same connections.
 - c) The application, plans, and supporting materials submitted by the project applicant to Monterey County HCD-Planning for the proposed development found in project file PLN200192.

6. **FINDING:** **NO VIOLATIONS** – The subject property is not in compliance with all rules and regulations pertaining to zoning uses, subdivision, and any other applicable provisions of the County’s zoning ordinance. Three zoning violations exist on the property, which will be partially remedied by approval of this permit. As this permit partially remedies the zoning violations on the property, it is part of the administrative remedy for the violation, and as such may be issued pursuant to MCC. 21.84.120. These are addressed in evidences “a”, “b”, and “c” below. No other zoning violations or are known to exist on the property and no notice of violation is recorded on the property.

- EVIDENCE:**
- a) Primary Home Color. The primary home was painted a white “swiss coffee color” without the benefit of permit. The applicant has modified their application to request permission for this change.
 - b) Chimney. The chimney was re-finished with a smooth coat stucco and painted white without the benefit of permit. The applicant has modified their application to request include finishing the chimney in a tan Carmel stone. A metal mechanical flue cap and spark arrestor was also installed on top of the chimney. While a mechanical cap is shown on the project plans, it differs in form from the metal cap installed. The applicant has also modified their request to include permission for this change.
 - c) Shed. In correspondence received by members of the public, it was indicated that the height, structure, and finishes of an existing shed on the property were different from and in violation of their original planning approval, DA190154. In researching this approval, county staff reviewed the elevations and finish materials attached to the approval resolution for DA190154 and identified that the finishes and the skylights were installed per the original approval. Staff did not independently verify whether the height of the shed was higher than its originally approved height of eight feet prior to the hearing. At the hearing, the applicants representatives confirmed that the height of

the shed was twelve feet, four feet higher than its original approval. While the underlying zoning permits unhabitable accessory structures up to fifteen feet, being installed higher than originally approved is not in compliance with the conditions of the original permit DA190154, and as such is a violation of the provisions of the zoning ordinance. To address this, a project specific condition, "PDSP002", has been incorporated, which will require the applicant to either:

- secure the necessary land use entitlements to legalize the shed prior to the issuance of building permits, or;
- remove the shed and furnish evidence of its removal to the chief of planning prior to the issuance of building permits.

In her October 9, 2020 request, Ms. Kemp also indicates that electrical had been added to the shed without the benefit of permit. Code enforcement staff contacted the property owner, who verified this. This violation is being processed through code enforcement case 21CE00023. The property owner has since disconnected the electrical. However, to abate this violation the applicant will need to secure a building permit for either the demolition of the electrical or a building permit to legalize it. The applicant has indicated their desire is to convert this shed into an art studio with power, and as such the addition of electrical is shown on the site plan on sheet A1.0. This change does not impact the Design of the structures, and as such is not subject to Design Approval. Additionally, both a tool shed and an art studio with electrical power are non-habitable accessory structures, which are an allowable use in the LDR zone. Therefore, no planning entitlement is necessary for this change.

- d) The project planner conducted a site inspection on April 1, 2021.
- e) The application, plans, and supporting materials submitted by the project applicant to Monterey County HCD-Planning for the proposed development found in project file PLN200192.

7. **FINDING:** **APPEALABILITY** - The decision on this project may be appealed to the Monterey County Board of Supervisors.
- EVIDENCE:** Pursuant to Section 21.44.070 of the Monterey County Zoning Ordinance (Title 21), the Board of Supervisors shall consider appeals to any action taken by an Appropriate Authority, in this case the Zoning Administrator.

DECISION


NOW, THEREFORE, based on the above findings and evidence, the Zoning Administrator does hereby:

- A. Find that the project qualifies as a Class 3 Categorical Exemption pursuant to Section 15303 of the CEQA Guidelines, and there are no exceptions pursuant to Section 15300.2; and
- B. Approve a design approval to amend PLN170572 to permit expanding the studio addition from 355 square feet to 531 square feet and a 63 square foot landing; modifying the roof of the studio addition to have (2) skylights instead of (1) skylight; an interior remodel of the southeastern portion of the home, including conversion of

the garage to living space and removal and replacement of the garage door with lap siding; construction of a new 447 square foot attached two-car carport; re-finishing the chimney with a Carmel Stone to address the presently unpermitted white “swiss coffee” smooth stucco finish, and; construction of a 4 foot tall to 6 foot tall cedar fence. The project also includes retro-active design approval for: painting the exterior of the primary residence a white “swiss coffee” color, and; adding a metal flue cap and spark arrestor to the top of the chimney.

All of which are in general conformance with the attached sketch and subject to 6 conditions of approval.

PASSED AND ADOPTED this 13th day of May, 2021.

DocuSigned by:

E8D855FE840144F...

John Dugan, FAICP, Monterey County Zoning Administrator

COPY OF THIS DECISION MAILED TO APPLICANT ON **5/20/21**

THIS APPLICATION IS APPEALABLE TO THE BOARD OF SUPERVISORS. IF ANYONE WISHES TO APPEAL THIS DECISION, AN APPEAL FORM MUST BE COMPLETED AND SUBMITTED TO THE CLERK OF THE BOARD ALONG WITH THE APPROPRIATE FILING FEE ON OR BEFORE **6/1/21**

This decision, if this is the final administrative decision, is subject to judicial review pursuant to California Code of Civil Procedure Sections 1094.5 and 1094.6. Any Petition for Writ of Mandate must be filed with the Court no later than the 90th day following the date on which this decision becomes final.

NOTES

1. You will need a building permit and must comply with the Monterey County Building Ordinance in every respect.

Additionally, the Zoning Ordinance provides that no building permit shall be issued, nor any use conducted, otherwise than in accordance with the conditions and terms of the permit granted or until ten days after the mailing of notice of the granting of the permit by the appropriate authority, or after granting of the permit by the Board of Supervisors in the event of appeal.

Do not start any construction or occupy any building until you have obtained the necessary permits and use clearances from Monterey County HCD-Planning and HCD-Building Services Department office in Salinas.

Monterey County RMA Planning

Conditions of Approval/Implementation Plan/Mitigation Monitoring and Reporting Plan

PLN200192

1. DESIGN APPROVAL - SPECIFIC USES ONLY

Responsible Department: RMA-Planning

Condition/Mitigation Monitoring Measure: This permit was approved in accordance with County ordinances and land use regulations subject to the terms and conditions described in the project file. Neither the uses nor the construction allowed by this permit shall commence unless and until all of the conditions of this permit are met to the satisfaction of the Director of RMA - Planning. Any use or construction not in substantial conformance with the terms and conditions of this permit is a violation of County regulations and may result in modification or revocation of this permit and subsequent legal action. No use or construction other than that specified by this permit is allowed unless additional permits are approved by the appropriate authorities. (RMA - Planning)

Compliance or Monitoring Action to be Performed: The Owner/Applicant shall adhere to conditions and uses specified in the permit on an ongoing basis unless otherwise stated.

2. PD002 - NOTICE PERMIT APPROVAL

Responsible Department: RMA-Planning

Condition/Mitigation Monitoring Measure: The applicant shall record a Permit Approval Notice. This notice shall state:
"A Design Approval (Resolution Number 21-025) was approved by Monterey County Zoning Administrator for Assessor's Parcel Number 015-522-008-000 on May 13, 2021. The permit was granted subject to 6 conditions of approval which run with the land. A copy of the permit is on file with Monterey County RMA - Planning."

Proof of recordation of this notice shall be furnished to the Director of RMA - Planning prior to issuance of grading and building permits, Certificates of Compliance, or commencement of use, whichever occurs first and as applicable. (RMA - Planning)

Compliance or Monitoring Action to be Performed: Prior to the issuance of grading and building permits, certificates of compliance, or commencement of use, whichever occurs first and as applicable, the Owner/Applicant shall provide proof of recordation of this notice to the RMA - Planning.

3. PD003(A) - CULTURAL RESOURCES NEGATIVE ARCHAEOLOGICAL REPORT

Responsible Department: RMA-Planning

Condition/Mitigation Monitoring Measure: If, during the course of construction, cultural, archaeological, historical or paleontological resources are uncovered at the site (surface or subsurface resources) work shall be halted immediately within 50 meters (165 feet) of the find until a qualified professional archaeologist can evaluate it. Monterey County RMA - Planning and a qualified archaeologist (i.e., an archaeologist registered with the Register of Professional Archaeologists) shall be immediately contacted by the responsible individual present on-site. When contacted, the project planner and the archaeologist shall immediately visit the site to determine the extent of the resources and to develop proper mitigation measures required for recovery.
(RMA - Planning)

Compliance or Monitoring Action to be Performed: The Owner/Applicant shall adhere to this condition on an on-going basis.

Prior to the issuance of grading or building permits and/or prior to the recordation of the final/parcel map, whichever occurs first, the Owner/Applicant shall include requirements of this condition as a note on all grading and building plans. The note shall state "Stop work within 50 meters (165 feet) of uncovered resource and contact Monterey County RMA - Planning and a qualified archaeologist immediately if cultural, archaeological, historical or paleontological resources are uncovered."

When contacted, the project planner and the archaeologist shall immediately visit the site to determine the extent of the resources and to develop proper mitigation measures required for the discovery.

4. PDSP001 - ADDITIONAL EVIDENCE OF INC. LUAC RECOMMENDATIONS

Responsible Department: RMA-Planning

Condition/Mitigation Monitoring Measure: The applicant shall provide specific evidence that the project changes incorporated based on the Land Use Advisory Committee's recommendations have been executed.

Compliance or Monitoring Action to be Performed: Prior to building final, the owner/applicant shall furnish evidence to the Chief of Planning that the specified tan carmel stone, skylight shades, and low-e skylight glass have been installed as proposed. The Chief of Planning shall review the adequacy of the submitted evidence.

5. CC01 INDEMNIFICATION AGREEMENT

Responsible Department: County Counsel-Risk Management

Condition/Mitigation Monitoring Measure: The property owner agrees as a condition and in consideration of approval of this discretionary development permit that it will, pursuant to agreement and/or statutory provisions as applicable, including but not limited to Government Code Section 66474.9, defend, indemnify and hold harmless the County of Monterey or its agents, officers and employees from any claim, action or proceeding against the County or its agents, officers or employees to attack, set aside, void or annul this approval, which action is brought within the time period provided for under law, including but not limited to, Government Code Section 66499.37, as applicable. The property owner will reimburse the County for any court costs and attorney's fees which the County may be required by a court to pay as a result of such action. The County may, at its sole discretion, participate in the defense of such action; but such participation shall not relieve applicant of his/her/its obligations under this condition. An agreement to this effect shall be recorded upon demand of County Counsel or concurrent with the issuance of building permits, use of property, filing of the final map, recordation of the certificates of compliance whichever occurs first and as applicable. The County shall promptly notify the property owner of any such claim, action or proceeding and the County shall cooperate fully in the defense thereof. If the County fails to promptly notify the property owner of any such claim, action or proceeding or fails to cooperate fully in the defense thereof, the property owner shall not thereafter be responsible to defend, indemnify or hold the County harmless. (County Counsel-Risk Management)

Compliance or Monitoring Action to be Performed: Upon demand of County Counsel or concurrent with the issuance of building permits, use of the property, recording of the final/parcel map, or recordation of Certificates of Compliance, whichever occurs first and as applicable, the Owner/Applicant shall submit a signed and notarized Indemnification Agreement to the Office of County Counsel-Risk Management for review and signature by the County.

Proof of recordation of the Indemnification Agreement, as outlined, shall be submitted to the Office of County Counsel-Risk Management

6. PDSP002 - SHED

Responsible Department: RMA-Planning


Condition/Mitigation Monitoring Measure: The existing shed on the property, permitted through DA190154, is higher than its originally approved height. The applicant must remedy this condition prior to the issuance of building permits.

Compliance or Monitoring Action to be Performed: Either:
Secure the necessary planning entitlements to legalize the increased height of the shed prior to the issuance of building permits,

or;

Remove the shed from the property. Furnish evidence to the Chief of Planning that the shed has been removed prior to building permit issuance.

ARCHITECTURAL SYMBOLS

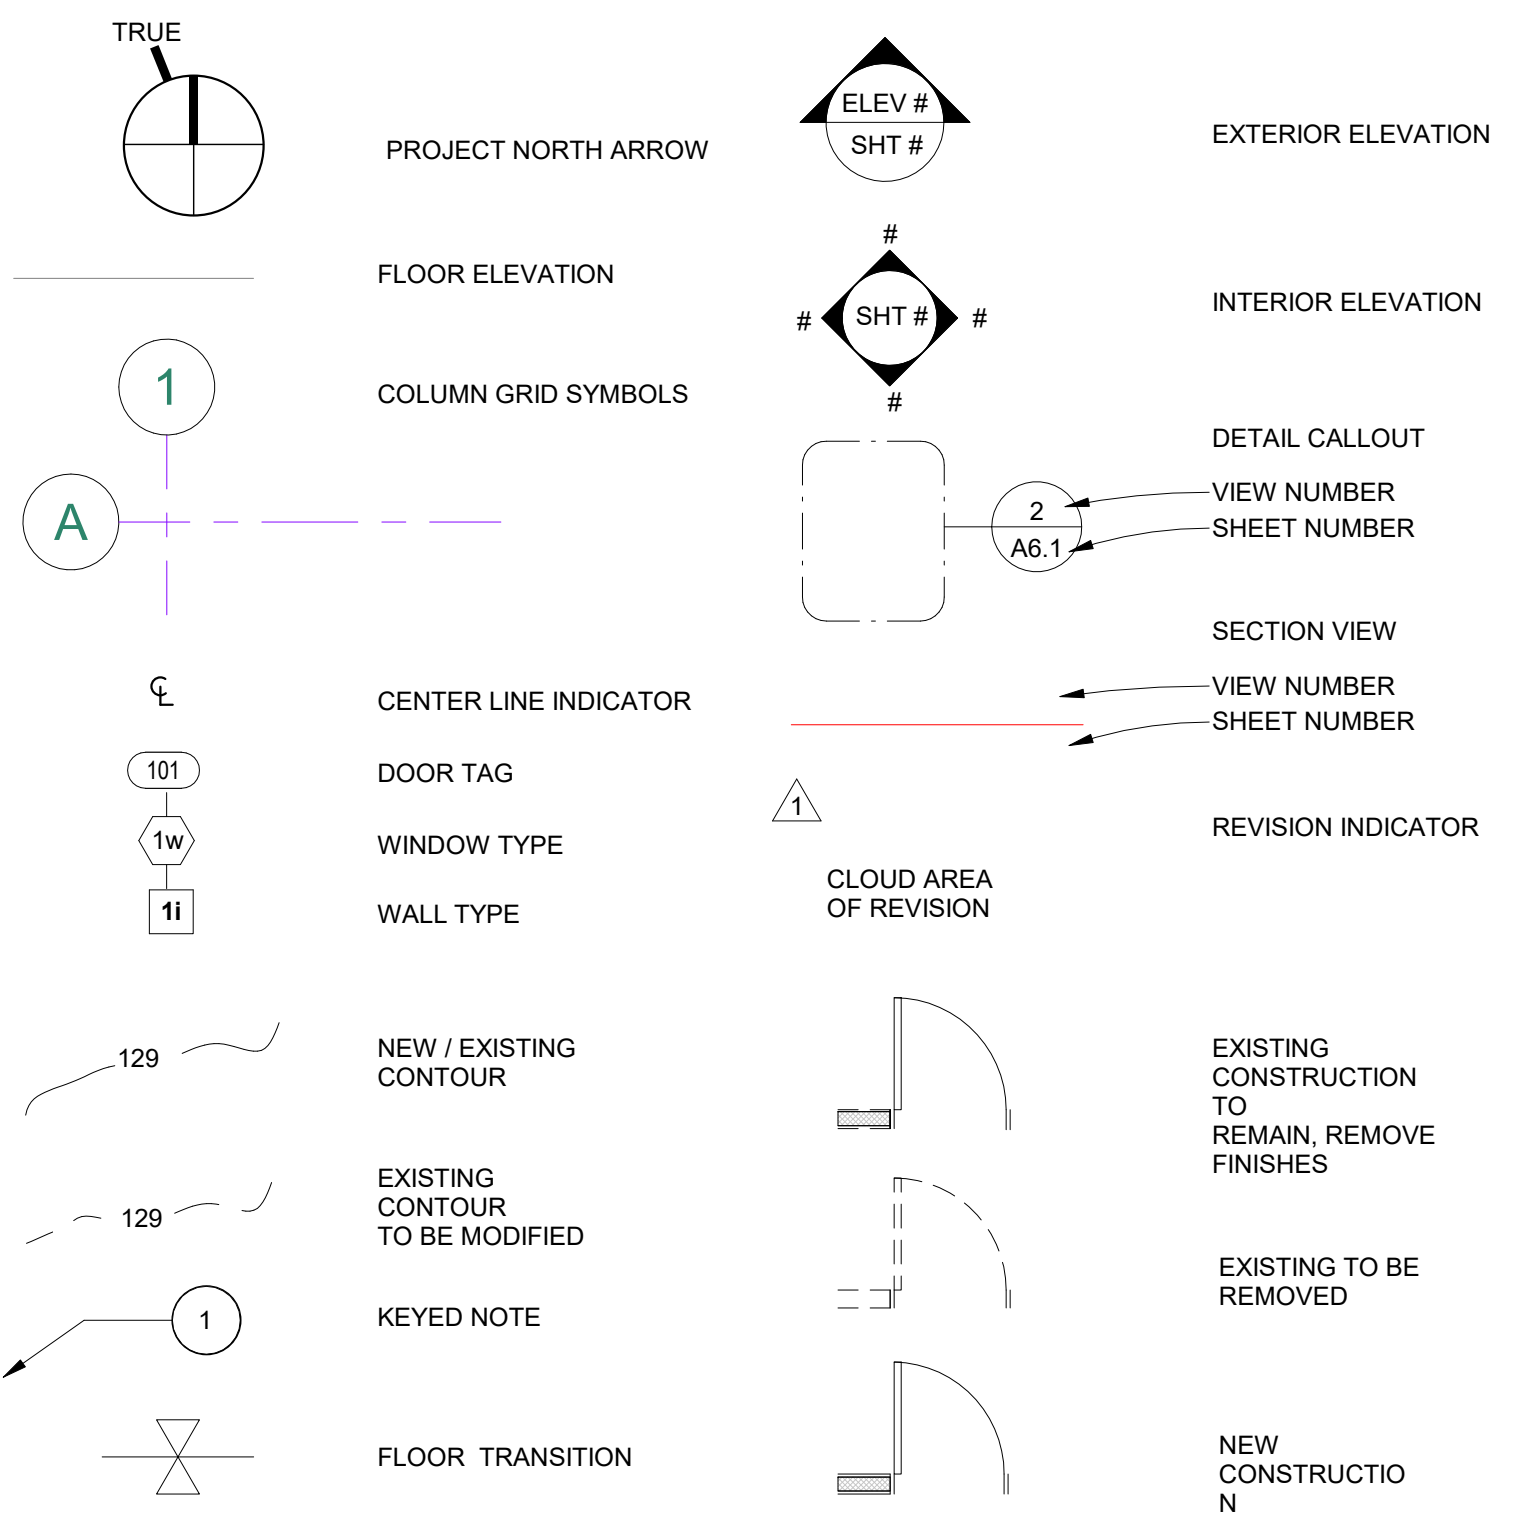


SCOPE OF WORK

PLN170572 SCOPE OF WORK: REMODEL OF AN (E) 2,645 SF SINGLE STORY RESIDENCE AND THE CONSTRUCTION OF A 355 SF ADDITION WITH SKYLIGHT. SCOPE OF WORK ALSO INCLUDES THE REPLACEMENT OF EXTERIOR SIDING, DOORS, AND WINDOWS. PROPOSED GRADING WILL INCLUDE THE IMPORT OF 113.2 CU YDS OF FILL. 4 FRUIT TREES ARE PROPOSED AND PLANTERS FOR HERB GARDEN.

PLN200192 SCOPE OF WORK: ENLARGEMENT OF THE PREVIOUSLY APPROVED STUDIO ADDITION FROM 355 SF TO 531 SF WITH (2) SKYLIGHTS AND A 63 SF LANDING. REVISED FLOOR PLAN FOR BATHROOM 3, BEDROOM 3, LAUNDRY AND PANTRY. NEW BEDROOM 4 AND MECHANICAL ROOM WITHIN EXISTING GARAGE. ADDITION OF CARPORT WITH (2) PARKING SPACES. 20 CU YDS OF GRADING TO BE BALANCED ON SITE. AFTER THE FACT APPROVAL TO PAINT THE EXTERIOR OF A SINGLE FAMILY RESIDENCE WITH KELLY-MOORE SWISS COFFEE & CLAD A BRICK CHIMNEY IN CARMEL STONE VENEER. PROVIDE POWER TO AN EXISTING SHED. NEW 6' CEDAR FENCE.

PARCEL MAP

PROJECT SITE

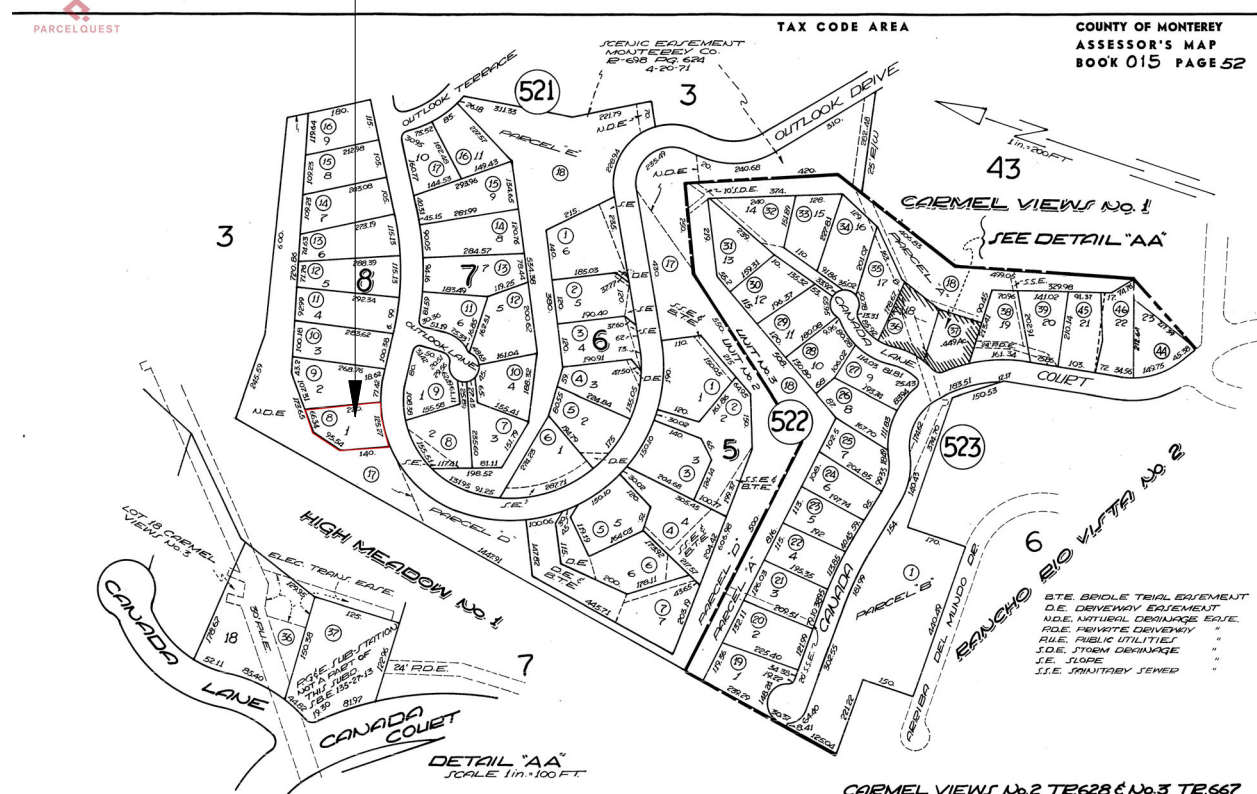


ARCHITECTURAL ABBREVIATIONS

& AND ANGLE	E EAST	JAN JANITOR	R RADIUS / RISER
@ AT	(E) EXISTING	JT. JOINT	R.A. RETURN AIR
Ø DIA. DIAMETER	EA. EACH	L. ANGLE	R.D. ROOF DRAIN
2CP 2 COAT PLASTER	EJ. ENTRY CLOSET	LB. POUND	REF. REFRIGERATOR
3CP 3 COAT PLASTER	E.L. EXPANSION JOINT	LG. LONG LENGTH	REINF. REINFORCED
AB AGGREGATE BASE	ELEC. ELECTRICAL	LAV. LAVATORY	RES. RESIN
A.B.T. ANCHOR BOLT	ELEV. ELEVATION	LLV. LONG LEG VERT.	REV. REVISION
AC. AIRCONDITIONER	EMER. EMERGENCY	LVV. LONG LEG VERT.	REQD. REQUIRED
ACD. ACCESS DOOR	E.M.R. ELEVATOR MACHINE RM.	L(T)G. LIGHTING	RM. ROOM
ACT. ACoustic TILE	ENCL. ENCLOSURE, ENCLOSED	LVR. LOUVER	R.O. ROUGH OPENING
AD. AREA DRAIN	ENGR. ENGINEER		
A.D.A. AMERICANS WITH DISABILITIES ACT	ENTR. ENTRANCE		
ADJ. ADJUSTABLE	EQU. EQUIPMENT	MACH. MACHINE	S. SOUTH
A.F.F. ABOVE FINISH FLOOR	EST. ESTIMATE	MAX. MAXIMUM	SAFB SOUND ATTENUATION FIRE BLANKET
AL ALUMINUM	EX. EXISTING	MC. MEDICINE CABINET	SC. SCHEDE
ANOD. ANODIZED	EXH. EXHAUST	MEMB. MEMBRANE	SCH. SKIM COAT PLASTER
A.P. ACCESS PANEL	EXP. EXPANSION	MEZZ. MEZZANINE	SEC. SECTION
ARCH. ARCHITECTURAL	EXT. EXTERIOR	MFR. MANUFACTURER	S.F. SQUARE FEET
AVG. AVERAGE	F.A.I. FRESH AIR INTAKE	MH. MAN HOLE	SHT. SHEET
	F.D. FLOOR DRAIN	MIN. MINIMUM	SIG. SOUND INSULATING GLASS
	F.F. FINISH FLOOR OR FINISHED FACE	MISC. MISCELLANEOUS	SIM. SIMILAR
	F.G. FINISH GRADE	MND. MOUNTED	SIP. STRUCTURAL INSULATED PANEL
	FGL. FIBERGLASS	MTG. MEETING	S.J. SCORED JOINT
	F.H. FIRE HYDRANT, FLAT HEAD	N. NORTH	SPKLR. SPEAKER
	F.F.C. FIRE HOSE CABINET	NAT. NATURAL	SPKR. SPEAKER
	FIN. FINISH	N.I.C. NOT IN CONTRACT	SQ. SQUARE
	FLR. FLOOR	NO. NUMBER	S.S. STAINLESS STEEL
	FL. FLUORESCENT	NOM. NOMINAL	SMI. SEE MANUFACTURERS INSTRUCTIONS
	F.O. FACE OF	NRC. NOISE REDUCTION COEFFICIENT	SED. SEE ENGINEERING DRAWINGS
	F.O.C. FACE OF CONC.	N.T.S. NOT TO SCALE	SSD. SEE STRUCTURAL DRAWINGS
	F.O.M. FACE OF MASONRY		ST. STONE TILE / STONE
	F.O.S. FACE OF STUD		STL. STEEL
CAB. CABINET	F.P. FIRE PROOFING	O. OVER	STC. SOUND TRANSMISSION COEFFICIENT
CAP. CAPACITY	FR. FRAME / FIRE RATED	O.C. ON CENTER	STD. STANDARD
CAT. CATALOG	F.S. FULL SIZE-SCALE	O.D. OUTSIDE DIAMETER	STRUC. STRUCTURAL
C.C.F.I. CLOSED CELL FOAM INSULATION	F.F.T. FOOTING	OFF. OFFICE	SUSP. SUSPENDED
C.B. CATCH BASIN	FTG. FOOTING	O.H. OPPOSITE HAND	SW. STAINED WOOD
CE. CEDAR	FXTR. FIXTURE	OPG. OPENING	T. TREAD
CEM. CEMENTITIOUS	GA. GAUGE	OPP. OPPOSITE	TB. TILE BACKER BOARD
CER. CERAMIC	GALV. GALVANIZED	OVHD. OVERHEAD	T.C. TERRA COTTA
CFM. CUBIC FEET MIN.	G.C. GENERAL CONTRACTOR		TEL. TELEPHONE
C.I. CAST IRON	GEN. GENERAL		TEMP. TEMPORARY
C.L. CENTERLINE	GFCI. GROUND FAULT CIRCUIT INTERRUPTER		TERR. TERRACE
CLG. CEILING	G.I. GALVANIZED IRON		T&G. TONGUE AND GROOVE
CLOS. CLOSET	GL. GLASS		THK. THICK
CLR. CLEAR	GLJ. GUELJAM		THRU. THROUGH
CL.W. CLEAR FINISH WOOD	GLZ. GLAZING		TMPD. TEMPERED
C.J. CONTROL JOINT	GMT. GLASS MOSIAC TILE		TL. TILE
CMU. CONC. MASONRY UNIT	GR. GRADE		(T) TEMPERED
CNTR. COUNTER	GT. GLASS TILE		T.O.P. TOP OF PLATE
C.O. CLEANOUT	GWB. GYPSUM WALL BOARD		T.O.S. TOP OF SLAB
CONF. CONFERENCE	GYP. GYPSUM		T.O.W. TOP OF WALL
COL. COLUMN	HC. HOLLOW CORE		T.S.S. TOP OF STRUCTURAL STEEL
COMM. COMMUNICATION	HD(R). HEAD(ER)		TP. TYPICAL
CONC. CONCRETE	HDWD. HARDWOOD		TZ. TERRAZZO
CONST. CONSTRUCTION	HWR. HARDWARE		
CONT. CONTINUOUS	H.M. HOLLOW MTL		
CORR. CORRIDOR	HORIZ. HORIZONTAL		
CPT. CARPET	HR. HOUR		
CRS. COURSE	H.S. HEADED STUD		
CT. CERAMIC TILE	HT. HEIGHT		
CTR. CENTER	HTC. HEATING		
CW. COLD WATER	HTR. HEATER		
	HVAC. HEATING VENTILATION & AIR CONDITIONING		
DBL. DOUBLE	HW. HOT WATER		
DEMO. DEMOLITION	IB. IMPERIAL BOARD		
DET. DETAIL	I.D. INSIDE DIAMETER		
DF. DOUGLAS FIR	IN. INCHES		
DIA. DIAMETER	INSL. INSULATION		
DIAG. DIAGONAL	INV. INVERT		
DIM. DIMENSION			
DKG. DECKING			
DN. DOWN			
DR. DOWNPOUT			
D.O. DOOR OPENING			
D.R. DOOR			
D.S. DOWNSPOUT			
DTL. DETAIL			
DWG. DRAWING			

VICINITY MAP

PROJECT SITE

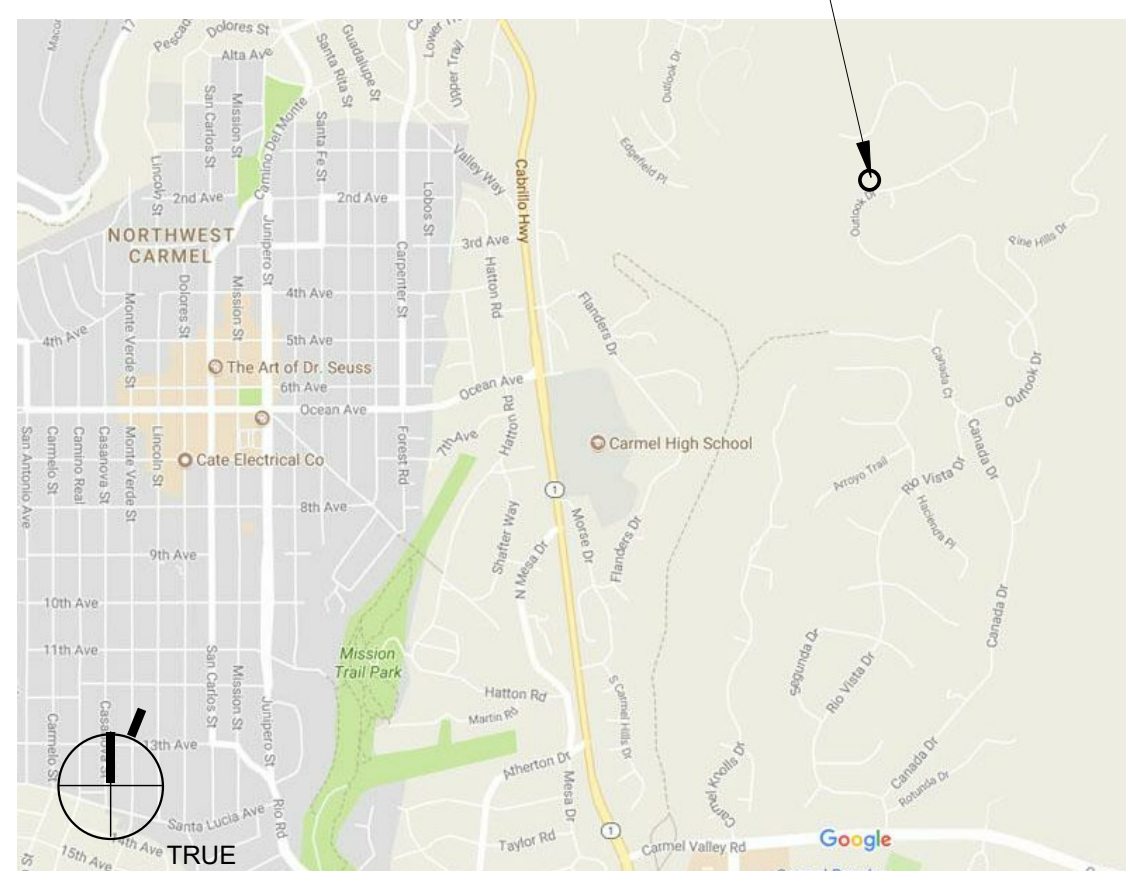

SHEET INDEX

G1.0	COVER SHEET
G1.1	GENERAL NOTES
G1.2	SURVEY
G1.5	EROSION CONTROL / CONSTRUCTION MGMT PLAN
G1.6	EROSION CONTROL / CONSTRUCTION MGMT NOTES
G1.7	GRADING/SLOPE MAP & DRAINAGE PLAN
A1.0	SITE PLAN
A2.0	EXISTING/ PHASE 2 DEMO FLOOR PLAN
A2.1	PROPOSED PHASE 2 FLOOR PLAN
A2.3	PROPOSED ROOF PLAN
A3.2	EXTERIOR ELEVATIONS
A3.3	EXTERIOR ELEVATIONS
A3.4	CARPOT PLAN & ELEVATIONS
A3.5	BUILDING & WALL SECTIONS

PROJECT TEAM

OWNER	MAL SCHWARTZ & LAURA TRYON C/O ARCHITECT
ARCHITECT	STUDIO CARVER ARCHITECTS P.O. Box 2684, Carmel, CA 93921 Phone: (831) 624-2304 Fax: (831) 624-0364 E-mail: Robert@StudioCarver.com Contact: Robert Carver, AIA, LEED AP
SURVEYOR	MONTEREY BAY ENGINEERS, INC. 607 Charles Ave. Suite B Seaside, CA 93955 Phone: (831) 899-7899 Fax: (831) 899-7879 E-mail: mbayengr@mbay.net
STRUCTURAL	SEZEN & MOON STRUCTURAL ENGINEERING, INC. 274 E. Hamilton Avenue, Suite C Campbell, CA 95008 Phone: (408) 871-7273 E-mail: smseinc@aol.com
MECHANICAL	MONTEREY ENERGY GROUP 26465 Carmel Rancho Blvd. #8 Carmel, CA 93923 Phone: (831) 372-8328 E-mail: dave@meg4.com

BUILDING CODE INFO

THIS PROJECT SHALL COMPLY WITH THE FOLLOWING:
 THE 2019 CALIFORNIA RESIDENTIAL CODE (CRC),
 THE 2019 CALIFORNIA MECHANICAL CODE (CMC)
 THE 2019 CALIFORNIA PLUMBING CODE (CPC)
 THE 2019 CALIFORNIA ELECTRICAL CODE (CEC)
 THE 2019 CALIFORNIA ENERGY CODE (CEC)

PROJECT INFORMATION

PROPERTY ADDRESS	24980 OUTLOOK DR., CARMEL, CA 93923
APN	015-522-008-000
ZONING	LDR/B-6-D-S-RAZ
GENERAL PLAN LAND USE DESIGNATION	RESIDENTIAL
TYPE OF CONSTRUCTION	TYPE V-B
OCCUPANCY GROUP	R-3 / SINGLE FAMILY RESIDENCE U / GARAGE
WILDLAND URBAN INTERFACE AREA (ALL MATERIALS & CONSTRUCTION TO COMPLY WITH CHAPTER 7A OF THE 2016 CBC)	YES
AVERAGE NATURAL GRADE	ELEV. = 98' - 5"
ALLOWED HEIGHT LIMIT ABOVE A.N.G	30' - 0" ELEV. = 128' - 5"
(E) HEIGHT ABOVE A.N.G.	13' - 6" ELEV. = 111' - 11"
(P) HEIGHT ABOVE A.N.G	14' - 9 1/2" ELEV. = 113' - 2 1/2"
PLANNING PERMIT BUILDING PERMIT	PLN170572 PLN200192 17CP03455 21CP00166

BUILDING AREA

(E) BUILDING AREA:		
(E) GARAGE	375	SF
(E) RESIDENCE	2,295	SF
TOTAL	2,670	SF
(E) DECKS (24" abv grade)	551	SF
(P) ADDITION		
PROPOSED ADDITION	531	SF
REMODELED BUILDING AREA:		
REMODELED RESIDENCE	3,201	SF
(E) DECKS (24" abv grade)	551	SF

LOT COVERAGE

LOT SIZE	.57651 ACRES (25,113 SF)
ALLOWABLE LOT COVERAGE	25% OR 6,278 SF
(E) LOT COVERAGE:	
(E) GARAGE	375 SF
(E) RESIDENCE	2,295 SF
(E) DECKS (24" abv grade)	551 SF
TOTAL	3,221 SF OR 12.8%
NEW LOT COVERAGE	
REMODELED RESIDENCE	3,201 SF
CARPOT	447 SF
EXISTING & NEW DECKS (24" abv grade)	551 SF
TOTAL	4,199 SF OR 16.7%

GRADING ESTIMATES

GRADING CUT	20 CU.YDS.
GRADING FILL	20 CU.YDS.
GRADING NET IMPORT	0 CU.YDS.

MISCELLANEOUS


WATER SOURCE	CAL AM
SEWER SYSTEM	CAWD
TREES TO BE REMOVED	0
REQUIRED PARKING	2 SPACES/UNIT
PROPOSED PARKING	4 SPACES (2 COVERED)

BUILDING CODE DATA

SPRINKLERS	YES
-------------------	-----

SCHWARTZ TRYON REMODEL


24980 OUTLOOK DR., CARMEL, CA 93923

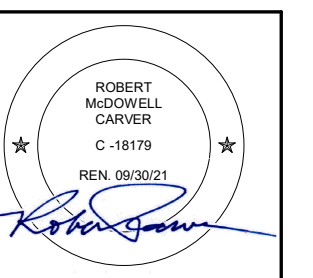

PLANNING DEPARTMENT SUBMITTAL

PO BOX 2684 - CARMEL CA 93921 - USA
 T:831.622.2837 F:831.624.0364
 WWW.STUDIOCARVER.COM

STUDIO CARVER ARCHITECTURE + PLANNING + INTERIOR DESIGN

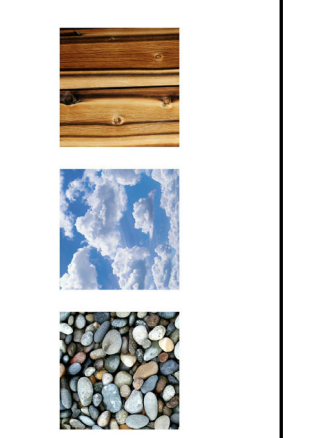

REVISION #

1	1/08/18	PLAN REVIEW COMMENTS
2	8/6/2020	PLN170572 REVISION
3	3/24/2021	Revision 3
4	4/1/2021	FENCE

ARCHITECTURAL COVER SHEET

Scale: 1/8" = 1'-0"
 @ 24x36
 Drawn By: DP
 Job: 1713

G1.0
 5/4/2021 4:07:38 PM

Use of these plans and specifications shall be restricted to the original site for which they were prepared and publication thereof is expressly limited to such use. Reproduction or publication by any method, in whole or in part, is prohibited. This to the plans and specifications remains with the architect without prejudice. Visual contact with these plans and specifications shall constitute prima facie evidence of the acceptance of these restrictions.

GENERAL FIRE DEPARTMENT NOTES

- FIRE007 - DRIVEWAYS DRIVEWAYS SHALL NOT BE LESS THAN 12 FEET WIDE UNOBSTRUCTED... FIRE011 - ADDRESSES FOR BUILDINGS ALL BUILDINGS SHALL BE ISSUED AN ADDRESS IN ACCORDANCE WITH MONTEREY COUNTY ORDINANCE NO. 1241... FIRE019 - DEFENSIBLE SPACE REQUIREMENTS (STANDARD) REMOVE COMBUSTIBLE VEGETATION FROM WITHIN A MINIMUM OF 30 FEET OF STRUCTURES... FIRE021 - FIRE PROTECTION EQUIPMENT & SYSTEMS - FIRE SPRINKLER SYSTEM (STANDARD) THE BUILDING(S) AND ATTACHED GARAGE(S) SHALL BE FULLY PROTECTED WITH AUTOMATIC FIRE SPRINKLER SYSTEMS... FIRE025 - SMOKE ALARMS (SINGLE FAMILY DWELLING) WHERE A HOUSEHOLD FIRE WARNING SYSTEM OR COMBINATION FIRE/BURGULAR ALARM SYSTEM IS INSTALLED... FIRE026 - ROOF CONSTRUCTION (STANDARD) ALL NEW STRUCTURES AND ALL EXISTING STRUCTURES RECEIVING NEW ROOFING OVER 50 PERCENT OR MORE OF THE EXISTING ROOF SURFACE WITHIN A ONE-YEAR PERIOD, SHALL REQUIRE A MINIMUM OF ICBO CLASS B ROOF CONSTRUCTION.

GENERAL NOTES

- 1. SPECIAL INSPECTIONS, BY GEOTECH ENGINEER, ARE REQUIRED FOR EXISTING SITE SOIL CONDITIONS, FILL PLACEMENT AND LOAD-BEARING REQUIREMENTS... 2. DEVELOPMENT AND RELATED CONSTRUCTION ACTIVITIES SUCH AS SITE CLEANING, GRADING, SOIL REMOVAL OR PLACEMENT WHICH CHANGE A PERMANENT CHANGE TO EXISTING SITE CONDITIONS ARE PROHIBITED ON SLOPES GREATER THAN OR EQUAL TO 30%... 3. THE SLOPE OF CUT AND FILL SURFACES SHALL BE NO STEEPER THAN IS SAFE FOR THE INTENDED USE... 4. FILL MATERIAL SHALL NOT INCLUDE ORGANIC, FROZEN OR OTHER DELETERIOUS MATERIALS... 5. ALL FILL MATERIAL SHALL BE COMPACTED TO 90 PERCENT OF MAXIMUM DENSITY AS DETERMINED BY ASTM D 1557... 6. A "FINAL SOILS LETTER" FROM THE GEOTECHNICAL ENGINEER STATING THAT ALL EARTHWORK COMPLETED WAS IN ACCORDANCE WITH THE RECOMMENDATIONS STATED IN THE GEOTECHNICAL REPORT SHALL BE SUBMITTED PRIOR TO FINAL INSPECTION... 13. CALIFORNIA BUILDING STANDARDS CODE, 2019 EDITION: AS APPLICABLE, ALL MATERIALS, WORKMANSHIP, AND METHODS SHALL COMPLY WITH THE CALIFORNIA BUILDING STANDARDS CODE... 30. ALL EXTERIOR SWINGING EXIT DOORS SHALL HAVE A THRESHOLD NOT EXCEED 1-1/2" IN HEIGHT.

GENERAL ELECTRICAL NOTES

- 1. AFCI PROTECTION IS REQUIRED FOR ALL RECEPTACLES EXCEPT FOR THOSE LOCATED OUTSIDE, IN BATHROOMS, GARAGES, ATTICS AND BASEMENTS... 2. A MINIMUM OF ONE-20 AMP BRANCH CIRCUIT SHALL BE PROVIDED TO SUPPLY RECEPTACLE OUTLETS IN THE LAUNDRY ROOM... 3. A MINIMUM OF ONE-20 AMP BRANCH CIRCUIT SHALL BE PROVIDED TO SUPPLY RECEPTACLE OUTLETS IN THE BATHROOMS... 4. RECEPTACLES INSTALLED IN A KITCHEN TO SERVE COUNTERTOP SURFACES SHALL BE SUPPLIED BY NOT FEWER THAN TWO 20 AMP SMALL-APPLIANCE BRANCH CIRCUITS... 5. AT LEAST ONE GFCI RECEPTACLE OUTLET SHALL BE INSTALLED IN BATHROOMS WITHIN 3' OF THE OUTSIDE EDGE OF EACH BASIN AND LOCATED ON A WALL OR PARTITION THAT IS ADJACENT TO THE BASIN OR INSTALLED NO LESS THAN 12" BELOW COUNTERTOP AT BASIN CABINET... 10. PROVIDE SEPARATE 20-AMP BRANCH CIRCUITS FOR FIXED APPLIANCES SUCH AS FOOD WASTE GRINDERS, DISHWASHERS WASHING MACHINES, DRYERS, BUILT-IN REFRIGERATORS OR FREEZERS, FURNACES, AC UNITS, OR ANY OTHER FIXED APPLIANCE WITH A MOTOR OF 1/4 HP. OR LARGER... 13. KITCHEN RECEPTACLE OUTLETS SERVING COUNTERTOPS, INCLUDING ISLAND & PENINSULA COUNTERTOPS, SHALL: • HAVE GROUND PROTECTION • BE INSTALLED IN EACH COUNTER WALL 12 INCHES OR WIDER SO NO POINT ALONG THE WALL IS MORE THAN 24 INCHES... 14. GFCI PROTECTION REQUIRED FOR RECEPTACLES LOCATED OUTDOORS, IN BATHROOMS, UNFINISHED BASEMENTS, CRAWL SPACES, KITCHEN AND WET BAR COUNTERTOP SURFACES, GARAGES, ACCESSORY BUILDINGS NOT INTENDED AS HABITABLE ROOMS... 23. AT LEAST ONE LIGHT IN BATHROOMS, GARAGES, LAUNDRY AND UTILITY ROOMS SHALL BE CONTROLLED BY A VACANCY SENSOR CERTIFIED TO COMPLY WITH SECTION 119(D) THAT DOES NOT TURN ON AUTOMATICALLY OR HAVE AN ALWAYS ON OPTION, (150(K)3)

GENERAL PLUMBING NOTES


- 1. ALL PLUMBING FIXTURES ARE REQUIRED TO BE LISTED BY AN ACCEPTABLE NATIONALLY RECOGNIZED TESTING LABORATORY... 2. THIS IS A PARTIAL LIST OF PRIMARY PLUMBING FIXTURES, AND IS NOT INTENDED AS A COMPREHENSIVE LIST OF ALL PLUMBING FIXTURES... 3. PLUMBING FIXTURES AND FITTINGS SHALL BE INSTALLED IN ACCORDANCE WITH THE CALIFORNIA PLUMBING CODE, AND SHALL MEET THE APPLICABLE STANDARDS REFERENCED IN TABLE 1401.1 OF THE CALIFORNIA PLUMBING CODE... 4. PLUMBING FIXTURES AND FITTINGS SHALL COMPLY WITH THE SPECIFIED PERFORMANCE REQUIREMENTS OF SECTION 4.303.3 OF CGBS... 5. CPC 402.5 SETTING, NO WATER CLOSET OR BIDET SHALL BE SET CLOSER THAN 15 INCHES FROM ITS CENTER TO A SIDE WALL OR OBSTRUCTION NOR CLOSER THAN 30 INCHES CENTER TO CENTER TO A SIMILAR FIXTURE... 6. CPC 408.6 SHOWER COMPARTMENTS, SHOWER COMPARTMENTS, REGARDLESS OF SHAPE, SHALL HAVE A MINIMUM FINISHED INTERIOR OF 1024 SQUARE INCHES AND SHALL ALSO BE CAPABLE OF ENCOMPASSING A 30 INCH CIRCLE AND A 22-INCH CLEAR OPENING/DOOR... 7. CPC 408.3 INDIVIDUAL SHOWER AND TUB-SHOWER COMBINATION CONTROL VALVES, SHOWERS AND TUB-SHOWER COMBINATIONS SHALL BE PROVIDED WITH INDIVIDUAL CONTROL VALVES OF THE PRESSURE BALANCE, THERMOSTATIC, OR COMBINATION PRESSURE BALANCE/THERMOSTATIC MIXING VALVE TYPE THAT PROVIDE SCALD AND THERMAL SHOCK PROTECTION FOR THE RATED FLOW RATE OF THE INSTALLED SHOWERHEAD... 8. CPC 408.9 LOCATION OF VALVES AND HEADS, CONTROL VALVES AND SHOWERHEADS SHALL BE LOCATED ON THE SIDEWALL OF SHOWER COMPARTMENTS OR OTHERWISE ARRANGED SO THAT THE SHOWERHEAD DOES NOT DISCHARGE DIRECTLY AT THE ENTRANCE TO THE COMPARTMENT SO THAT THE BATHER CAN ADJUST THE VALVES PRIOR TO STEPPING INTO THE SHOWER SPRAY... 9. EXTERIOR HOSE BIBS: PROVIDE ANTI-SIPHON DEVICE AT ALL HOSE BIBS, ALL HOSE BIBS SHALL BE PROTECTED BY A LISTED NON-REMOVABLE HOSE BIB TYPE BACKFLOW PREVENTER OR WITH A LISTED ATMOSPHERIC VACUUM BREAKER... 10. SHOWER WALLS SHALL BE FINISHED WITH A NON-ABSORBENT SURFACE TO A MINIMUM HEIGHT OF 72" ABOVE DRAIN INLET... TOILET 1.28 GAL SINK FAUCET 1.2 GPM SHOWER VALVE 2.0 GPM KITCHEN FAUCET 1.8 GPM DISHWASHER 2.0 GPM CLOTHES WASHER 2.0 GPM

GENERAL CAL GREEN NOTES

- 1. MINIMUM 65% OF THE NON-HAZARDOUS CONSTRUCTION OR DEMOLITION DEBRIS SHALL BE RECYCLED AND/OR SALVAGED, UNLESS A LOCAL CONSTRUCTION AND DEMOLITION WASTE MANAGEMENT ORDINANCE IS MORE STRINGENT... 2. AT THE TIME OF FINAL INSPECTION, AN "OPERATION AND MAINTENANCE MANUAL" SHALL BE PLACED IN THE BUILDING THAT CONTAINS THE APPLICABLE ITEMS LISTED IN CGBSC SECTION 4.410.1... 3. LOW VOC ADHESIVES, SEALANTS, PAINTS, COATINGS, CARPET SYSTEMS, LOW FORMALDEHYDE WOOD, LOW VOC RESILIENT FLOORING SHALL COMPLY WITH CGBSC SECTION 4.504... 4. CAL GREEN 4.106.4.1 NEW ONE- AND TWO-FAMILY DWELLINGS AND TOWNHOUSES WITH ATTACHED PRIVATE GARAGES... 5. BUILDING MATERIALS WITH VISIBLE SIGNS OF WATER DAMAGE SHALL NOT BE INSTALLED. WALL AND FLOOR FRAMING SHALL NOT BE ENCLOSED WHEN THE FRAMING MEMBERS EXCEED 19 PERCENT MOISTURE CONTENT (4.505.3 CGBSC) A. MOISTURE CONTENT MUST BE VERIFIED IN COMPLIANCE WITH ALL OF THE FOLLOWING: a. MOISTURE CONTENT MUST BE DETERMINED WITH EITHER A PROBE-TYPE OR CONTACT TYPE MOISTURE METER; b. MOISTURE READINGS SHALL BE TAKEN AT A POINT 2 TO 4 FEET FROM THE GRADE STAMPED END TO BE VERIFIED; c. AT LEAST THREE RANDOM MOISTURE READINGS SHALL BE PERFORMED ON WALL AND FLOOR FRAMING WITH DOCUMENTATION ACCEPTABLE TO INSPECTOR. INSPECTOR MUST APPROVE MOISTURE CONTENT READING PRIOR TO ENCLOSING THE WALL AND FLOOR FRAMING.

SCHWARTZ TRYON REMODEL


24980 OUTLOOK DR., CARMEL, CA 93923

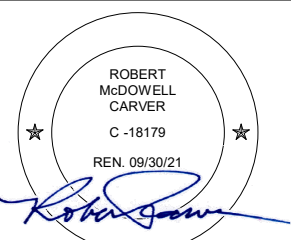

PLANNING DEPARTMENT SUBMITTAL

PO BOX 2884, CARMEL CA 93921 - USA, T:831.622.7837, F:831.624.0364, WWW.STUDIOCARVER.COM

STUDIO CARVER ARCHITECTURE + PLANNING + INTERIOR DESIGN

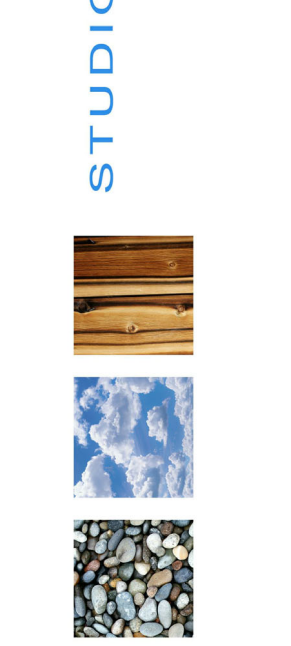


REVISION #

ARCHITECTURAL GENERAL NOTES

Scale: 1/2" = 1'-0" @ 24x36 Drawn By: DP Job: 1713

G1.1 5/4/2021

NOT FOR CONSTRUCTION

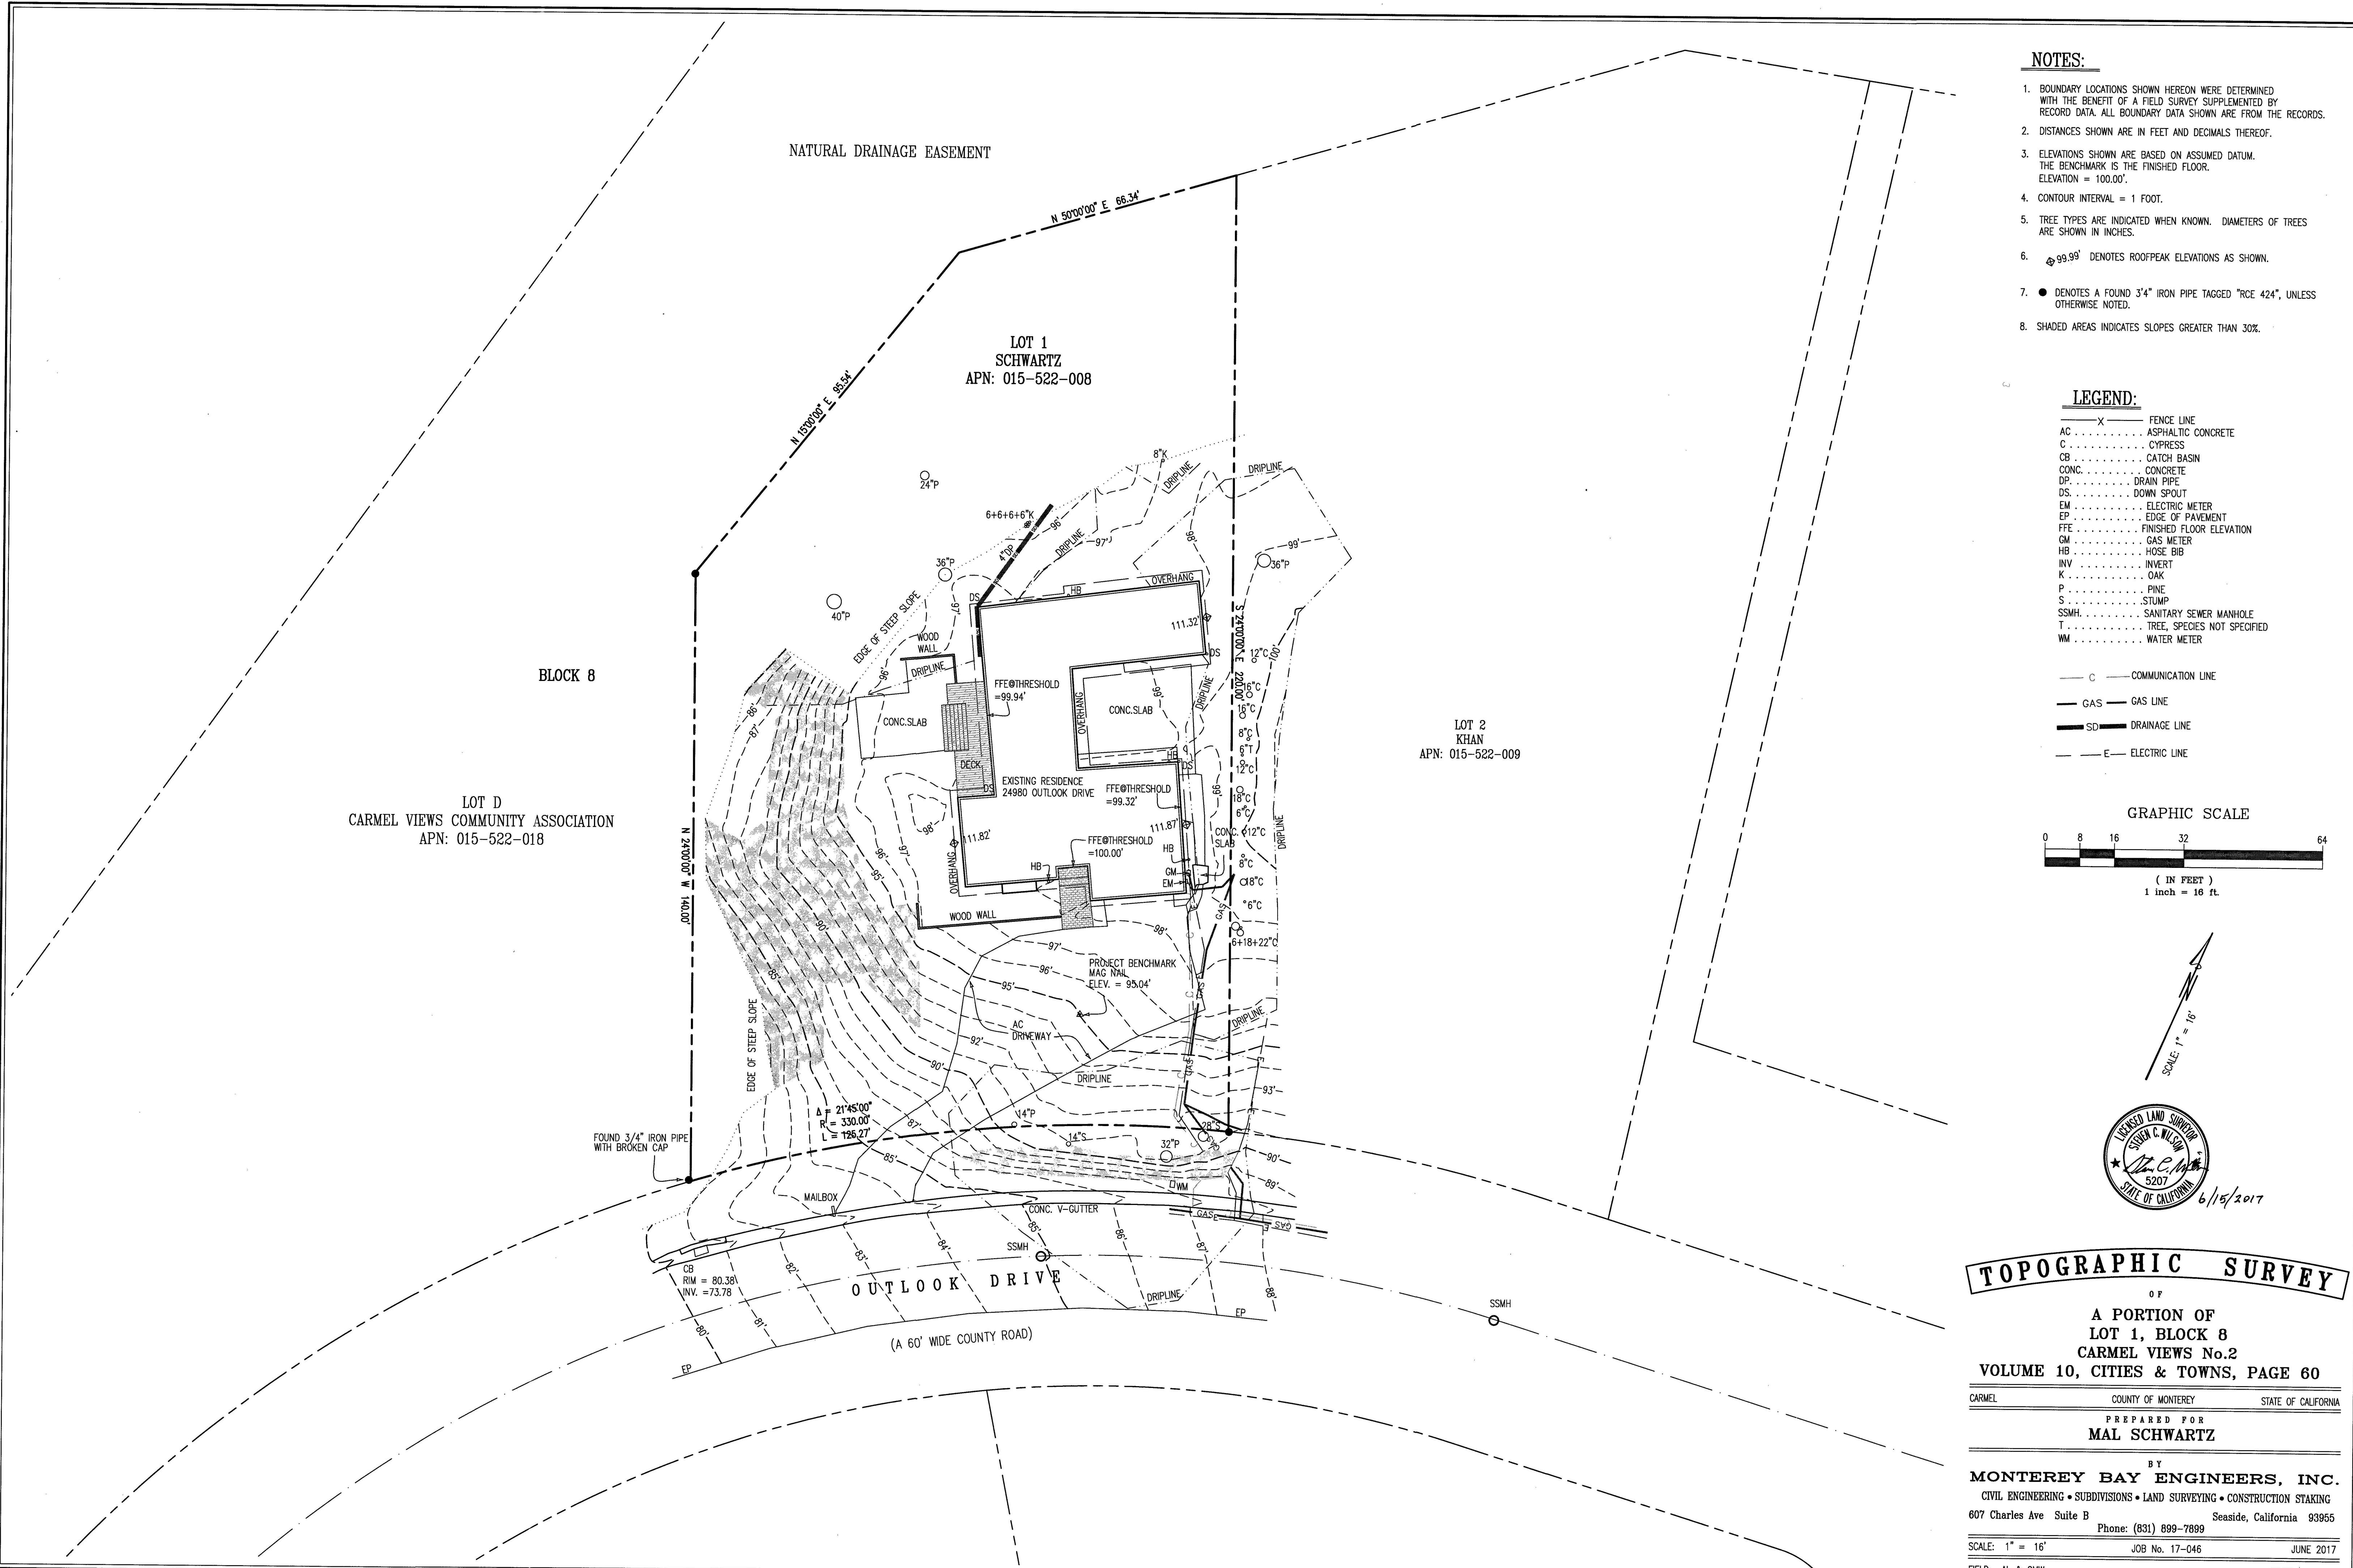



NOTES:

1. BOUNDARY LOCATIONS SHOWN HEREON WERE DETERMINED WITH THE BENEFIT OF A FIELD SURVEY SUPPLEMENTED BY RECORD DATA. ALL BOUNDARY DATA SHOWN ARE FROM THE RECORDS.
2. DISTANCES SHOWN ARE IN FEET AND DECIMALS THEREOF.
3. ELEVATIONS SHOWN ARE BASED ON ASSUMED DATUM. THE BENCHMARK IS THE FINISHED FLOOR. ELEVATION = 100.00'.
4. CONTOUR INTERVAL = 1 FOOT.
5. TREE TYPES ARE INDICATED WHEN KNOWN. DIAMETERS OF TREES ARE SHOWN IN INCHES.
6. \odot 99.99' DENOTES ROOFPEAK ELEVATIONS AS SHOWN.
7. \bullet DENOTES A FOUND 3/4" IRON PIPE TAGGED "RCE 424", UNLESS OTHERWISE NOTED.
8. SHADED AREAS INDICATES SLOPES GREATER THAN 30%.

LEGEND:

- X FENCE LINE
 - AC ASPHALTIC CONCRETE
 - C CYPRESS
 - CB CATCH BASIN
 - CONC. CONCRETE
 - DP DRAIN PIPE
 - DS DOWN SPOUT
 - EM ELECTRIC METER
 - EP EDGE OF PAVEMENT
 - FFE FINISHED FLOOR ELEVATION
 - GM GAS METER
 - HB HOSE BIB
 - INV INVERT
 - K OAK
 - P PINE
 - S STUMP
 - SSMH SANITARY SEWER MANHOLE
 - T TREE, SPECIES NOT SPECIFIED
 - WM WATER METER
-
- C COMMUNICATION LINE
 - GAS GAS LINE
 - SD DRAINAGE LINE
 - E ELECTRIC LINE

GRAPHIC SCALE

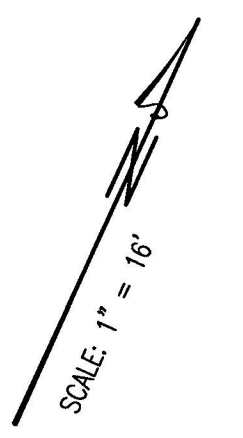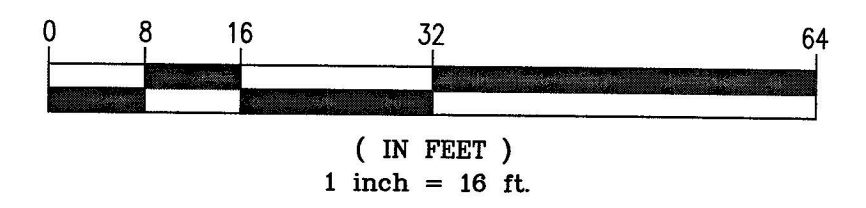

TOPOGRAPHIC SURVEY


OF
A PORTION OF
LOT 1, BLOCK 8
CARMEL VIEWS No.2
VOLUME 10, CITIES & TOWNS, PAGE 60

CARMEL COUNTY OF MONTEREY STATE OF CALIFORNIA
 PREPARED FOR
MAL SCHWARTZ

BY
MONTEREY BAY ENGINEERS, INC.
 CIVIL ENGINEERING • SUBDIVISIONS • LAND SURVEYING • CONSTRUCTION STAKING
 607 Charles Ave Suite B Seaside, California 93955
 Phone: (831) 899-7899

SCALE: 1" = 16'
 JOB No. 17-046 JUNE 2017
 FIELD: AL & CMW DRAWN BY: AL

Use of these plans and specifications shall be restricted to the original site for which they were prepared and publication thereof is expressly limited to such use. Reproduction or publication by any method, in whole or in part, is prohibited. Title to the plans and specifications remains with the architect without prejudice. Visual contact with these plans and specifications shall constitute prima facie evidence of the acceptance of these restrictions.

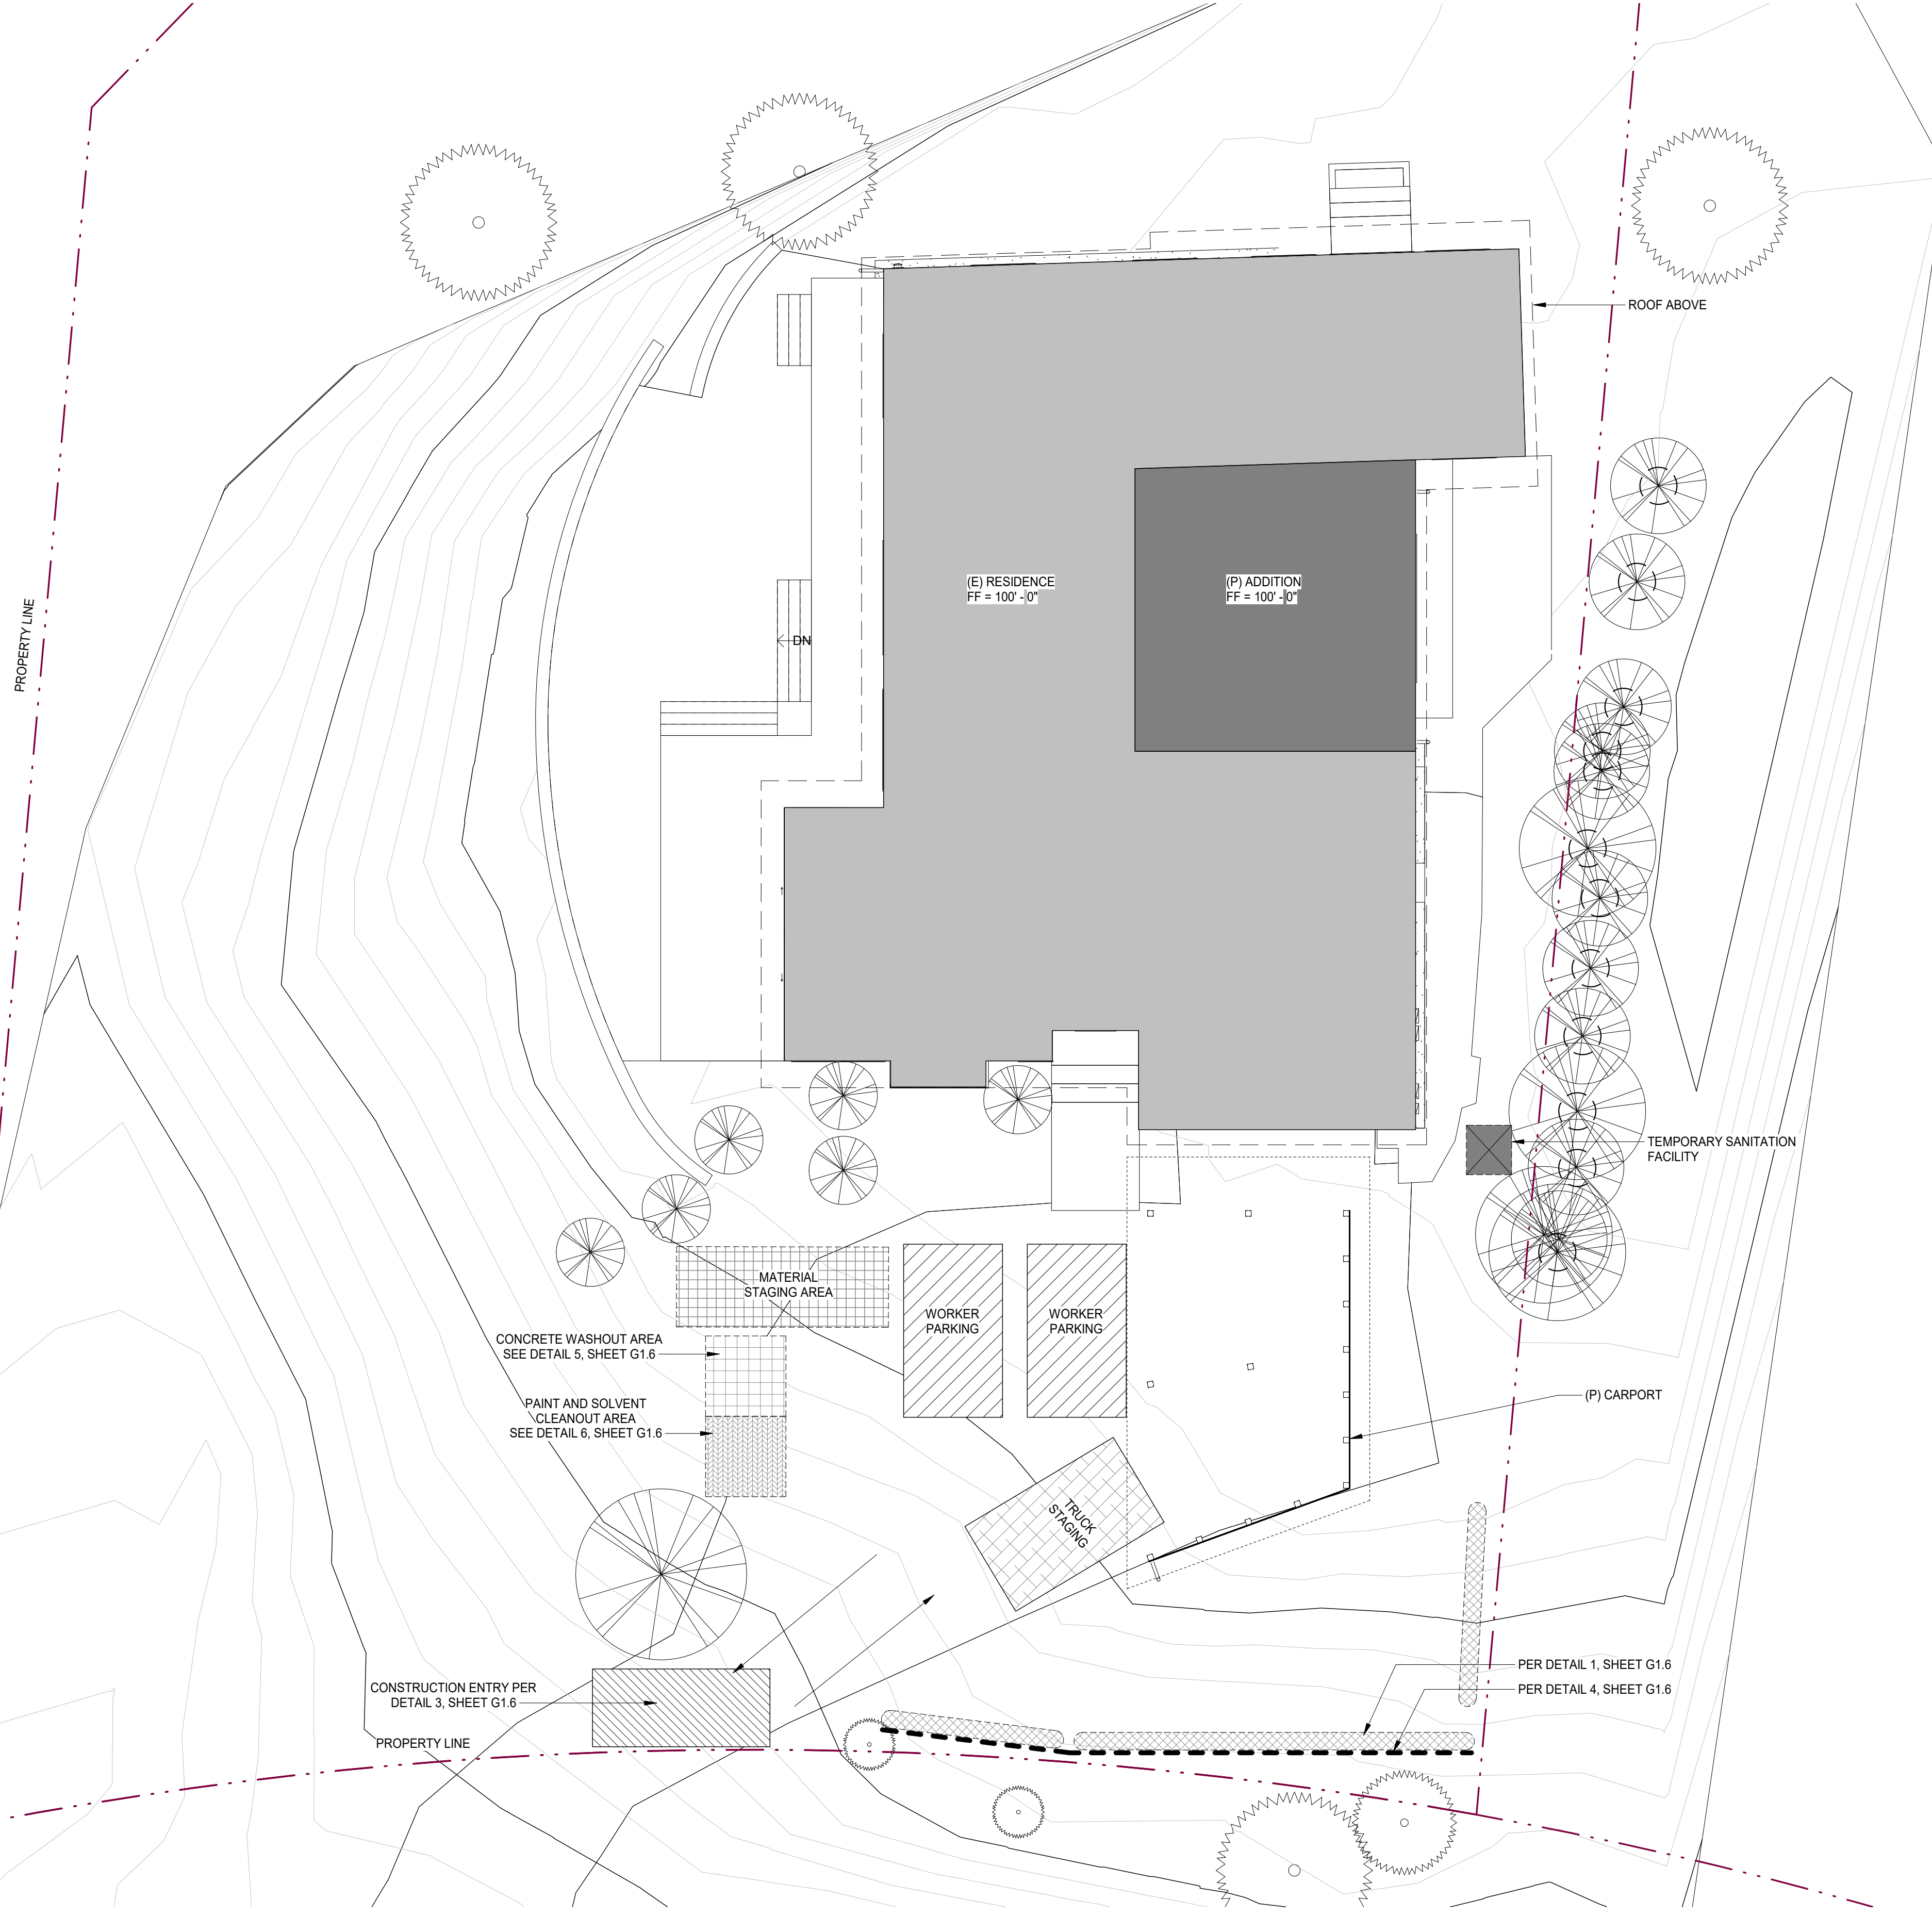

CONSTRUCTION MANAGEMENT NOTES:


- DURATION OF CONSTRUCTION IS ESTIMATED TO BE 6-8 MONTHS STARTING FROM THE DATE PERMITS ARE ISSUED.
- WORK SHALL BE PERFORMED ON WEEKDAYS BETWEEN THE HOURS OF 7 AM AND 7 PM AND ON SATURDAYS FROM 8 AM TO 6 PM. WORK PERFORMED BEFORE 8AM SHALL BE NON-CONSTRUCTION ACTIVITY (QUIET HOUR).
- TRUCKS WILL BE ROUTED TO AND FROM THE SITE USING CARMEL VALLEY ROAD VIA OUTLOOK DR.
- THE NUMBER OF WORKERS WILL VARY THROUGH OUT THE CONSTRUCTION. WORKERS ONSITE WILL RANGE FROM 2 TO 12.
- EROSION CONTROL PROTECTION TO BE INSTALLED PER THE PERMITTED PLANS PRIOR TO THE START OF CONSTRUCTION.
- STERILE STRAW WATTLES SHALL BE PLACED BEFORE AND DURING RAIN STORM EVENTS TO CONTAIN STORM WATER AND EROSION DURING CONSTRUCTION.
- ALL ON AND OFF-ROAD DIESEL EQUIPMENT SHALL NOT IDLE FOR MORE THAN 5 MINUTES.
- SUBSTITUTE GASOLINE-POWERED IN PLACE OF DIESEL-POWERED EQUIPMENT, WHERE FEASIBLE.
- USE ALTERNATIVELY FUELED CONSTRUCTION EQUIPMENT ON-SITE WHERE FEASIBLE, SUCH AS COMPRESSED NATURAL GAS (CNG), LIQUEFIED NATURAL GAS (LNG), PROPANE OR BIODIESEL.
- CONSTRUCTION TRUCK TRIPS WILL BE SCHEDULED DURING NON-PEAK HOURS TO REDUCE PEAK HOUR EMISSIONS.
- DUST CONTROL MEASURES WILL BE IMPLEMENTED INCLUDING THE USE WATER TRUCKS OR SPRINKLER SYSTEMS IN SUFFICIENT QUANTITIES TO PREVENT AIRBORNE DUST FROM LEAVING THE SITE. WATERING FREQUENCY SHALL BE INCREASED WHENEVER WIND SPEEDS EXCEED 15 MPH. RECLAIMED (NON-POTABLE) WILL BE USED WHENEVER POSSIBLE.
- ALL TRUCKS HAULING DIRT, SAND, SOIL, OR OTHER LOOSE MATERIALS ARE TO BE COVERED OR SHOULD MAINTAIN AT LEAST TWO FEET OF FREEBOARD (MINIMUM VERTICAL DISTANCE BETWEEN TOP OF LOAD AND TOP OF TRAILER) IN ACCORDANCE WITH CVC SECTION 23114.

STORMWATER DRAINAGE LEGEND

- CONSTRUCTION ENTRY
- WORKER PARKING
- EQUIPMENT PARKING AND MATERIAL STAGING AREA
- TRUCK STAGING
- PAINT AND SOLVENT CLEANOUT AREA
- CONCRETE WASHOUT AREA
- TREE AND ROOT PROTECTION MEASURES PER ARBORIST
- STRAW WATTLE EROSION CONTROL
- TRAFFIC
- SILT FENCE

**SCHWARTZ
TRYON
REMODEL**

24980 OUTLOOK DR.,
CARMEL, CA 93923

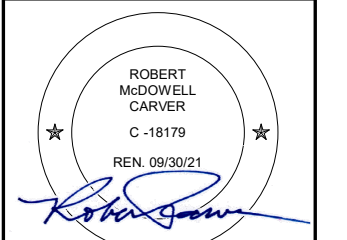

**PLANNING
DEPARTMENT
SUBMITTAL**

PO BOX 2884 -
CARMEL CA 93921 - USA
T:831.622.7837 - F:831.624.0364
WWW.STUDIOCARVER.COM

STUDIO CARVER
ARCHITECTURE + PLANNING + INTERIOR DESIGN




REVISION #	DATE	DESCRIPTION
2	8/5/2020	PLN170572 REVISION
5	4/23/2021	BUILDING CORRECTIO NS

**ARCHITECTURAL
EROSION
CONTROL /
CONSTRUCTION
MGMNT PLAN**

Scale: As indicated
@ 24x36
Drawn By: DP
Job: 1713

G1.5
5/4/2021 4:07:50 PM

1 EROSION CONTROL & CONSTRUCTION MANAGEMENT PLAN
1/8" = 1'-0"

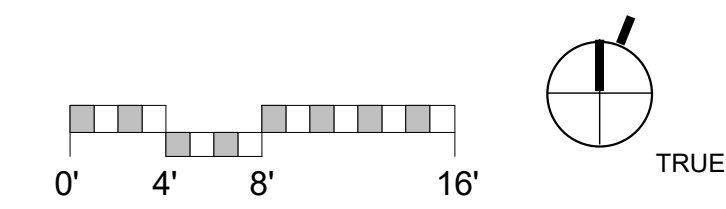

Use of these plans and specifications shall be restricted to the original site for which they were prepared and publication thereof is expressly limited to such use. Reproduction or publication by any method, in whole or in part, is prohibited. Title to the plans and specifications remains with the architect without prejudice. Visual contact with these plans and specifications shall constitute prima facie evidence of the acceptance of these restrictions.

EROSION CONTROL NOTES:

EROSION AND SEDIMENT CONTROL MEASURES

- THE FACILITIES SHOWN ON THE EROSION CONTROL PLAN ARE DESIGNED TO CONTROL EROSION AND SEDIMENT DURING THE RAINY SEASON, OCTOBER 15 TO APRIL 15. FACILITIES ARE TO BE OPERABLE PRIOR TO OCTOBER 1 OF ANY YEAR. GRADING OPERATIONS DURING THE RAINY SEASON, WHICH LEAVE DENUDED SLOPES SHALL BE PROTECTED WITH EROSION CONTROL MEASURES IMMEDIATELY FOLLOWING GRADING ON THE SLOPES.
- THIS PLAN COVERS ONLY THE FIRST WINTER FOLLOWING GRADING WITH ASSUMED SITE CONDITIONS AS SHOWN ON THE EROSION CONTROL PLAN. PRIOR TO SEPTEMBER 15, THE COMPLETION OF SITE IMPROVEMENT SHALL BE EVALUATED AND REVISIONS MADE TO THIS PLAN AS NECESSARY WITH THE APPROVAL OF THE ENGINEER.
- CONSTRUCTION ENTRANCES SHALL BE INSTALLED PRIOR TO COMMENCEMENT OF GRADING. ALL CONSTRUCTION TRAFFIC ENTERING ONTO THE PAVED ROADS MUST CROSS THE STABILIZED CONSTRUCTION ENTRANCEWAYS.
- CONTRACTOR SHALL MAINTAIN STABILIZED ENTRANCE AT EACH VEHICLE ACCESS POINT TO EXISTING PAVED STREETS. ANY MUD OR DEBRIS TRACKED ONTO PUBLIC STREETS SHALL BE REMOVED DAILY AND AS REQUIRED BY THE COUNTY.
- APPLY STRAW WITH TACKIFIER TO ALL DISTURBED AREAS, AFTER SEEDING. ANCHOR STRAW IN SLOPES BY TRACK ROLLING, AS SHOWN ON THIS SHEET.
- IF HYDROSEEDING IS NOT USED OR IS NOT EFFECTIVE, BY OCTOBER 10, THEN OTHER IMMEDIATE METHODS SHALL BE IMPLEMENTED, SUCH AS EROSION CONTROL BLANKETS, OR A THREE-STEP APPLICATION OF 1) SEED, MULCH, FERTILIZER; 2) BLOWN STRAW; 3) TACKIFIER AND MULCH.
- INLET PROTECTION SHALL BE INSTALLED AT OPEN INLETS TO PREVENT SEDIMENT FROM ENTERING THE STORM DRAIN SYSTEM. INLETS USED IN CONJUNCTION WITH EROSION CONTROL ARE TO BE BLOCKED TO PREVENT ENTRY OF SEDIMENT.
- THIS EROSION AND SEDIMENT CONTROL PLAN MAY NOT COVER ALL THE SITUATIONS THAT MAY ARISE DURING CONSTRUCTION DUE TO UNANTICIPATED FIELD CONDITIONS. VARIATIONS AND ADDITIONS MAY BE MADE TO THIS PLAN IN THE FIELD. NOTIFY THE COUNTY REPRESENTATIVE OF ANY FIELD CHANGES.

EMPLOYEE TRAINING

- STORM WATER POLLUTION PREVENTION TRAINING SHALL BE PROVIDED AT THE BEGINNING OF CONSTRUCTION AND REGULARLY DURING CONSTRUCTION FOR ALL EMPLOYEES WORKING ON THE JOB SITE. TRAINING SHALL BE PROVIDED BY THE CONTRACTOR'S WATER POLLUTION CONTROL MANAGER. TOPICS SHALL INCLUDE, BUT ARE NOT LIMITED TO:
 - SPILL PREVENTION AND RESPONSE;
 - LOCATIONS AND FUNCTIONS OF SEDIMENT/EROSION CONTROL DEVICES;
 - GOOD HOUSEKEEPING;
 - FINES AND PENALTIES;
 - MATERIAL MANAGEMENT PRACTICES.

OBSERVATION AND MAINTENANCE

- VISUALLY OBSERVE AND MAINTAIN BMPs AS FOLLOWS:
 - INSPECT BMPs:
 - WEEKLY, AND
 - WITHIN 48 HOURS PRIOR TO EACH STORM EVENT, AND
 - WITHIN 48 HOURS AFTER EACH STORM EVENT.
 - REPAIR DAMAGED BMPs WITHIN 48 HOURS OF OBSERVATION.
 - SEDIMENT SHALL BE REMOVED FROM SEDIMENT CONTROL BMPs BEFORE SEDIMENT HAS ACCUMULATED TO A DEPTH OF ONE THIRD THE HEIGHT OF THE SEDIMENT BARRIER OR SUMMIT, IF NOT OTHERWISE SPECIFIED IN THE SPECIAL PROVISIONS OR BY THE BMP SUPPLIER OR MANUFACTURER.
 - TRASH AND DEBRIS SHALL BE REMOVED FROM BMPs DURING SCHEDULED INSPECTIONS.
 - REMOVED SEDIMENT SHALL BE PLACED AT AN APPROVED LOCATION AND IN SUCH A MANNER THAT IT WILL NOT ERODE, OR SHALL BE DISPOSED OFF-SITE.
 - REPAIR RILLS AND GULLIES BY RE-GRADING AND THEN TRACKWALKING PERPENDICULAR TO THE SLOPE; PROVIDE TEMPORARY SOIL COVER IF NECESSARY.

NON-STORM WATER DISCHARGES

- NON-STORM WATER DISCHARGES INCLUDE A WIDE VARIETY OF SOURCES, INCLUDING IMPROPER DUMPING, SPILLS, OR LEAKAGE FROM STORAGE TANKS OR TRANSFER AREAS. NON-STORM WATER DISCHARGES MAY CONTRIBUTE SIGNIFICANT POLLUTANT LOADS TO RECEIVING WATERS, AND AS SUCH ARE PROHIBITED.
- MEASURES TO CONTROL SPILLS, LEAKAGE, AND DUMPING, AND TO PREVENT ILLICIT CONNECTIONS DURING CONSTRUCTION, MUST BE TAKEN.
- HOWEVER, CERTAIN NON-STORM WATER DISCHARGES MAY BE AUTHORIZED FOR THE COMPLETION OF CONSTRUCTION. AUTHORIZED NON-STORM WATER DISCHARGES MAY INCLUDE THOSE FROM DECHLORINATED POTABLE WATER SOURCES SUCH AS:
 - FIRE HYDRANT FLUSHING,
 - IRRIGATION OF VEGETATIVE EROSION CONTROL MEASURES,
 - PIPE FLUSHING AND TESTING,
 - WATER TO CONTROL DUST,
 - UNCONTAMINATED GROUND WATER FROM DEWATERING,
 - OTHER DISCHARGES NOT SUBJECT TO A SEPARATE GENERAL NPDES PERMIT ADOPTED BY A REGIONAL WATER BOARD.
- THE DISCHARGE OF NON-STORM WATER IS AUTHORIZED UNDER THE FOLLOWING CONDITIONS:
 - THE DISCHARGE DOES NOT CAUSE OR CONTRIBUTE TO A VIOLATION OF ANY WATER QUALITY STANDARD
 - THE DISCHARGE DOES NOT VIOLATE ANY OTHER PROVISION OF THE GENERAL PERMIT
 - THE DISCHARGE IS NOT PROHIBITED BY THE APPLICABLE BASIN PLAN
 - THE DISCHARGER HAS INCLUDED AND IMPLEMENTED SPECIFIC BMPs REQUIRED BY THE GENERAL PERMIT TO PREVENT OR REDUCE THE CONTACT OF THE NONSTORM WATER DISCHARGE WITH CONSTRUCTION MATERIALS OR EQUIPMENT
 - THE DISCHARGE DOES NOT CONTAIN TOXIC CONSTITUENTS IN TOXIC AMOUNTS OR (OTHER) SIGNIFICANT QUANTITIES OF POLLUTANTS
 - THE DISCHARGE IS MONITORED AND MEETS THE APPLICABLE NALS AND NELS
 - THE DISCHARGER REPORTS THE SAMPLING INFORMATION IN THE ANNUAL REPORT
- IF ANY OF THE ABOVE CONDITIONS ARE NOT SATISFIED, THE DISCHARGE IS NOT AUTHORIZED.

- ALL SURFACES EXPOSED OR EXPECTED TO BE EXPOSED DURING GRADING ACTIVITIES SHALL BE PREPARED AND MAINTAINED THROUGHOUT THE LENGTH OF THE ENTIRE PROJECT TO PROTECT AGAINST EROSION.
- ACTUAL GRADING SHALL BEGIN WITHIN 30 DAYS OF VEGETATION REMOVAL OR THE AREA SHALL BE PLANTED TO CONTROL EROSION. VEGETATION REMOVAL BETWEEN OCTOBER 15TH AND APRIL 15TH SHALL NOT PRECEDE SUBSEQUENT GRADING OR CONSTRUCTION ACTIVITIES BY MORE THAN 15 DAYS

- THE FOLLOWING PROVISIONS SHALL APPLY BETWEEN OCTOBER 15 AND APRIL 15.
 - DISTURBED SURFACES NOT INVOLVED IN THE IMMEDIATE OPERATIONS MUST BE PROTECTED BY APPLYING STRAW MULCH AT 2000 LBS. PER ACRE AND ANCHORED BY TRACK-WALKING TO PREVENT MOVEMENT DURING WATER FLOW.
 - SOIL EXCAVATED IN TRENCHING SHOULD BE PLACED ON THE UPSHILL OR FLOW SIDE OF THE ROLL TO PREVENT WATER FROM UNDER CUTTING THE ROLL.
 - CONSTRUCTION TRAFFIC ENTERING ONTO THE PAVED ROADS MUST CROSS THE STABILIZED CONSTRUCTION ENTRANCEWAYS.
 - CONTRACTOR SHALL MAINTAIN STABILIZED ENTRANCE AT EACH VEHICLE ACCESS POINT TO EXISTING PAVED STREETS. ANY MUD OR DEBRIS TRACKED ONTO PUBLIC STREETS SHALL BE REMOVED DAILY AND AS REQUIRED BY THE COUNTY.
 - APPLY STRAW WITH TACKIFIER TO ALL DISTURBED AREAS, AFTER SEEDING. ANCHOR STRAW IN SLOPES BY TRACK ROLLING, AS SHOWN ON THIS SHEET.
 - IF HYDROSEEDING IS NOT USED OR IS NOT EFFECTIVE, BY OCTOBER 10, THEN OTHER IMMEDIATE METHODS SHALL BE IMPLEMENTED, SUCH AS EROSION CONTROL BLANKETS, OR A THREE-STEP APPLICATION OF 1) SEED, MULCH, FERTILIZER; 2) BLOWN STRAW; 3) TACKIFIER AND MULCH.
 - INLET PROTECTION SHALL BE INSTALLED AT OPEN INLETS TO PREVENT SEDIMENT FROM ENTERING THE STORM DRAIN SYSTEM. INLETS USED IN CONJUNCTION WITH EROSION CONTROL ARE TO BE BLOCKED TO PREVENT ENTRY OF SEDIMENT.
 - THIS EROSION AND SEDIMENT CONTROL PLAN MAY NOT COVER ALL THE SITUATIONS THAT MAY ARISE DURING CONSTRUCTION DUE TO UNANTICIPATED FIELD CONDITIONS. VARIATIONS AND ADDITIONS MAY BE MADE TO THIS PLAN IN THE FIELD. NOTIFY THE COUNTY REPRESENTATIVE OF ANY FIELD CHANGES.

- AT ALL TIMES DURING CONSTRUCTION AND UNTIL FINAL COMPLETION, THE CONTRACTOR, WHEN HE OR HIS SUBCONTRACTORS ARE OPERATING EQUIPMENT ON THE SITE, SHALL PREVENT THE FORMATION OF AN AIRBORNE DUST NUISANCE BY WATERING AND/OR TREATING THE SITE OF THE WORK IN SUCH A MANNER THAT WILL CONFINE DUST PARTICLES TO THE IMMEDIATE SURFACE OF THE WORK. THE CONTRACTOR WILL BE RESPONSIBLE FOR ANY DAMAGE DONE BY DUST FROM HIS OR HER SUBCONTRACTOR.
- THIS PLAN IS INTENDED TO BE USED FOR INTERIM EROSION AND SEDIMENT CONTROL ONLY AND IS NOT TO BE USED FOR FINAL ELEVATIONS OR PERMANENT IMPROVEMENTS.
- CONTRACTOR SHALL BE RESPONSIBLE FOR MONITORING EROSION AND SEDIMENT CONTROL PRIOR, DURING, AND AFTER STORM EVENTS.

- REASONABLE CARE SHALL BE TAKEN WHEN HAULING ANY EARTH, SAND, GRAVEL, STONE, DEBRIS, PAPER OR ANY OTHER SUBSTANCE OVER ANY PUBLIC STREET, ALLEY OR OTHER PUBLIC PLACE. SHOULD ANY BLOW, SPILL, OR TRACK OVER AND UPON SAID PUBLIC OR ADJACENT PRIVATE PROPERTY, AN IMMEDIATE REMEDY SHALL OCCUR.
- SANITARY FACILITIES SHALL BE MAINTAINED ON THE SITE.
- DURING THE RAINY SEASON, ALL PAVED AREAS SHALL BE KEPT CLEAR OF EARTH MATERIAL AND DEBRIS. THE SITE SHALL BE MAINTAINED SO AS TO MINIMIZE SEDIMENT LADEN RUNOFF TO ANY STORM DRAINAGE SYSTEMS, INCLUDING EXISTING DRAINAGE SWALES AND WATER COURSES.

- CONSTRUCTION OPERATIONS SHALL BE CARRIED OUT IN SUCH A MANNER THAT EROSION AND WATER POLLUTION WILL BE MINIMIZED. STATE AND LOCAL LAWS CONCERNING POLLUTION ABATEMENT SHALL BE COMPLIED WITH.
- CONTRACTORS SHALL PROVIDE DUST CONTROL AS REQUIRED BY THE APPROPRIATE FEDERAL, STATE, AND LOCAL AGENCY REQUIREMENTS.
- WITH THE APPROVAL OF THE ENGINEER, EROSION AND SEDIMENT CONTROLS MAYBE REMOVED AFTER AREAS ABOVE THEM HAVE BEEN STABILIZED.

- ALL DISTURBED SURFACES SHALL BE PREPARED AND MAINTAINED TO CONTROL EROSION AND TO ESTABLISH NATIVE OR NATURALIZED VEGETATIVE GROWTH COMPATIBLE WITH THE AREA. THIS CONTROL SHALL CONSIST OF:
 - EFFECT TEMPORARY PLANTING SUCH AS RYE GRASS, SOME OTHER FAST-GERMINATION SEED, AND MULCHING WITH STRAW AND/OR OTHER SLOPE STABILIZATION MATERIAL.
 - PERMANENT PLANTING OF NATIVE OR NATURALIZED DROUGHT RESISTANT SPECIES OF SHRUBS, TREES OR OTHER VEGETATION, PURSUANT TO THE COUNTY'S LANDSCAPE CRITERIA, WHEN THE PROJECT IS COMPLETED;
 - MULCHING, FERTILIZING, WATERING OR OTHER METHODS MAY BE REQUIRED TO ESTABLISH NEW VEGETATION, ON SLOPES LESS THAN 20% TOPSOIL SHOULD BE STOCKPILED AND REAPPLIED.
- GRADING SHALL BEGIN WITHIN 30 DAYS OF VEGETATION REMOVAL OR THAT AREA SHALL BE PLANTED UNDER THE PROVISIONS OF SECTION 16.08.340 TO CONTROL EROSION (MCC 16.08.300 C.1)

- NO VEGETATION REMOVAL OR GRADING WILL BE ALLOWED WHICH WILL RESULT IN SILTATION OF WATER COURSES OR UNCONTROLLABLE EROSION (MCC 6.08.300 C.2)
- DUST FROM GRADING OPERATIONS MUST BE CONTROLLED. THE OWNER OR CONTRACTOR MAY BE REQUIRED TO KEEP ADEQUATE EQUIPMENT ON THE GRADING SITE TO PREVENT DUST PROBLEMS.
- IT SHALL BE THE RESPONSIBILITY OF THE OWNER AND THE PERMITTEE TO ENSURE THAT EROSION DOES NOT OCCUR FROM AN ACTIVITY DURING OR AFTER PROJECT CONSTRUCTION. ADDITIONAL MEASURES, BEYOND THOSE SPECIFIED, MAY BE REQUIRED AS DEEMED NECESSARY TO CONTROL ACCELERATED EROSION. (MCC 16.12.100)

- LAND CLEARING SHALL BE KEPT TO A MINIMUM. VEGETATION REMOVAL SHALL BE KEPT TO THAT AMOUNT NECESSARY FOR BUILDING, ACCESS AND CONSTRUCTION AS SHOWN ON THE APPROVED EROSION CONTROL PLAN.
- THE GROUND SURFACE SHALL BE PREPARED TO RECEIVE FILL BY REMOVING VEGETATION, TOPSOIL AND OTHER UNSUITABLE MATERIALS, AND SCARIFYING THE GROUND TO PROVIDE A BOND WITH THE FILL MATERIAL. (MCC 16.08.310 D)
- PRIOR TO COMMENCEMENT OF ANY LAND DISTURBANCE, THE OWNER/APPLICANT SHALL SCHEDULE AN INSPECTION WITH RMA-ENVIRONMENTAL SERVICES TO ENSURE ALL NECESSARY SEDIMENT CONTROLS ARE IN PLACE AND THE PROJECT IS COMPLIANT WITH MONTEREY COUNTY REGULATIONS.


- DURING CONSTRUCTION, THE OWNER/APPLICANT SHALL SCHEDULE AN INSPECTION WITH RMA-ENVIRONMENTAL SERVICES TO INSPECT DRAINAGE DEVICE INSTALLATION, REVIEW THE MAINTENANCE AND EFFECTIVENESS OF BMPs INSTALLED, AND TO VERIFY THAT POLLUTANTS OF CONCERN ARE NOT DISCHARGED FROM THE SITE. AT THE TIME OF THE INSPECTION, THE APPLICANT SHALL PROVIDE CERTIFICATION THAT ALL NECESSARY GEOTECHNICAL INSPECTIONS HAVE BEEN COMPLETED TO THAT POINT.
- PRIOR TO FINAL INSPECTION, THE OWNER/APPLICANT SHALL SCHEDULE AN INSPECTION WITH RMA-ENVIRONMENTAL SERVICES TO ENSURE THAT ALL DISTURBED AREAS HAVE BEEN STABILIZED AND THAT ALL TEMPORARY EROSION AND SEDIMENT CONTROL MEASURES THAT ARE NO LONGER NEEDED HAVE BEEN REMOVED.

EROSION CONTROL MAINTENANCE NOTES

- MAINTENANCE IS TO BE PERFORMED AS FOLLOWS:
 - REPAIR DAMAGES CAUSED BY SOIL EROSION OR CONSTRUCTION AT THE END OF EACH WORKING DAY.
 - SWALES SHALL BE INSPECTED PERIODICALLY AND MAINTAINED AS NEEDED.
 - SEDIMENT TRAPS, BERMS, AND SWALES ARE TO BE INSPECTED AFTER EACH STORM AND REPAIRS MADE AS NEEDED.
 - SEDIMENT SHALL BE REMOVED AND SEDIMENT TRAPS RESTORED TO ORIGINAL DIMENSIONS WHEN SEDIMENT HAS ACCUMULATED TO A DEPTH OF ONE FOOT.
 - SEDIMENT REMOVED FROM TRAP SHALL BE DEPOSITED IN A SUITABLE AREA AND IN SUCH A MANNER THAT IT WILL NOT ERODE.
 - RILLS AND GULLIES MUST BE REPAIRED.
- STRAW BAILE INLET PROTECTION SHALL BE CLEANED OUT WHENEVER SEDIMENT DEPTH IS ONE HALF THE HEIGHT OF ONE FOOT.

SCHWARTZ TRYON REMODEL

24980 OUTLOOK DR.
CARMEL, CA 93923

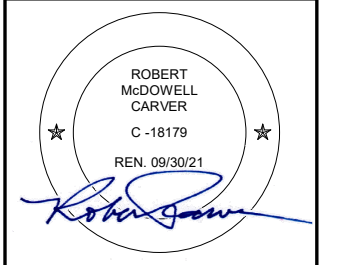

PLANNING DEPARTMENT SUBMITTAL

PD 0509 2024
CARMEL, CA 93921 - USA
TEL: 831.622.7837 - FAX: 831.624.0384
WWW.STUDIOCARVER.COM

ARCHITECTURE + INTERIOR DESIGN
STUDIO CARVER





REVISION

1 108/18 PLAN REVIEW COMMENTS


ARCHITECTURAL EROSION CONTROL / CONSTRUCTION MGMT NOTES

Scale: As indicated @ 24x36
Drawn By: DP
Job: 1713


G16
5/4/2021

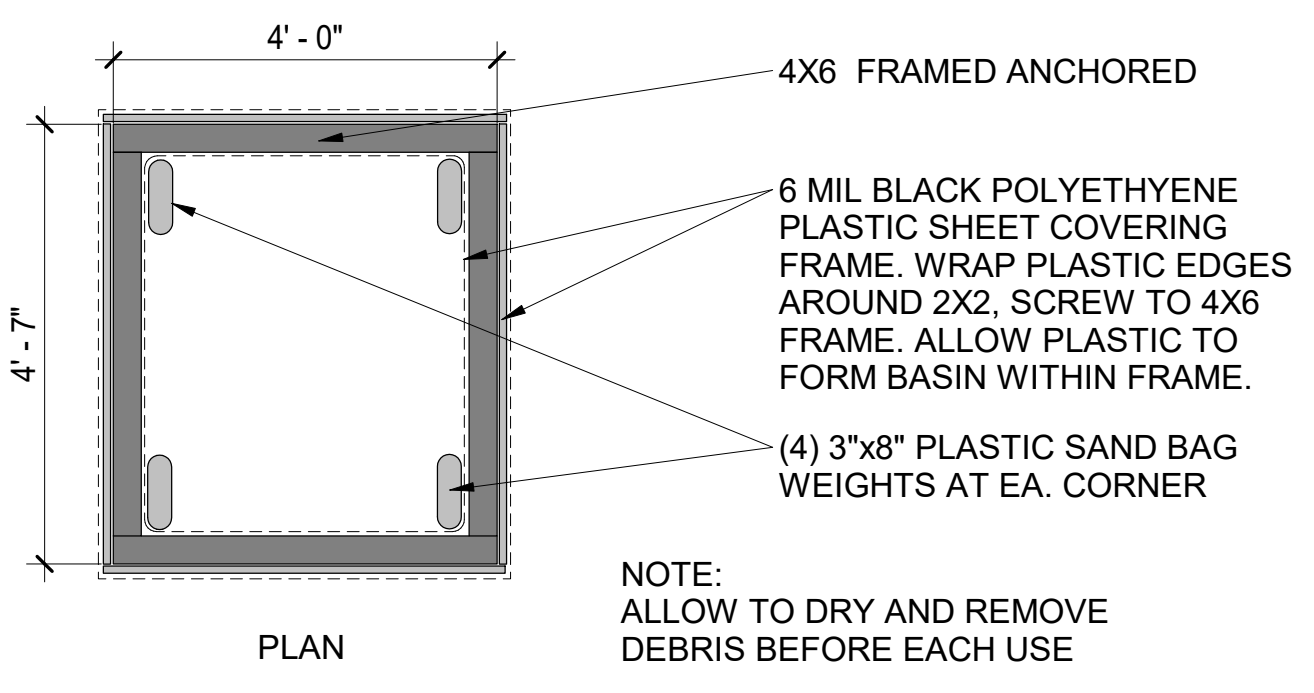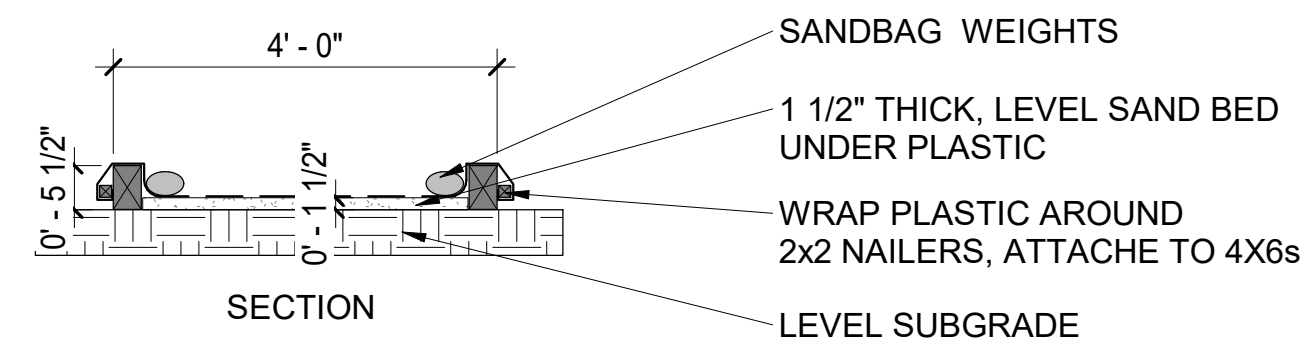


NOTE:
ALLOW TO DRY AND REMOVE
DEBRIS BEFORE EACH USE

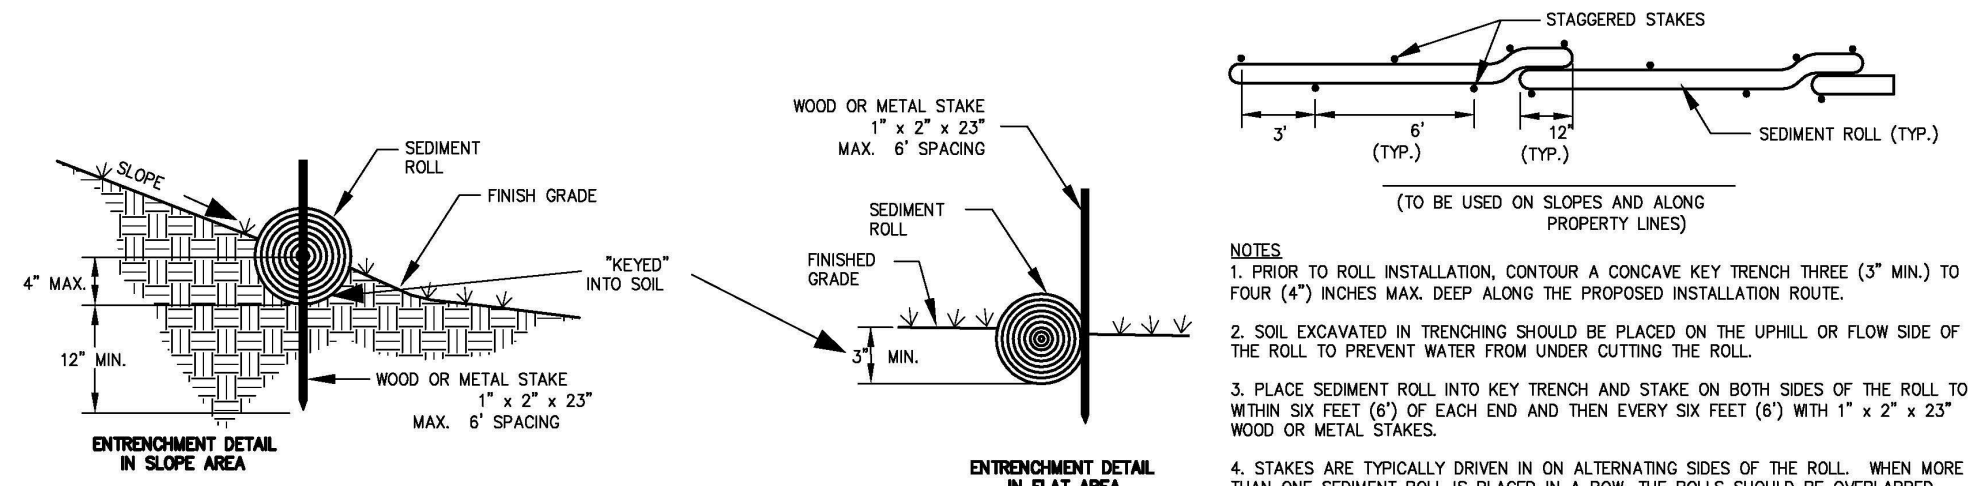

1 SEDIMENT ROLL DETAILS
NO SCALE




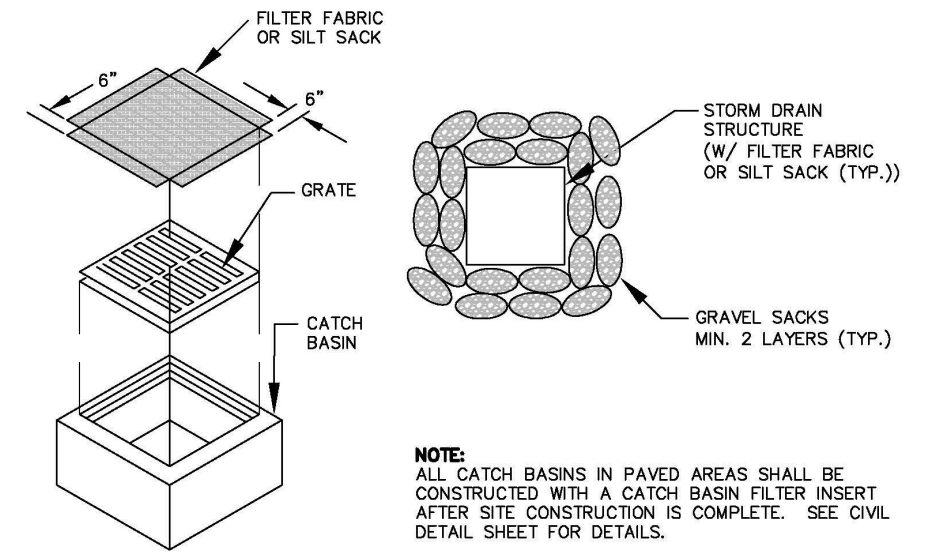


2 FABRIC INLET PROTECTION
NO SCALE

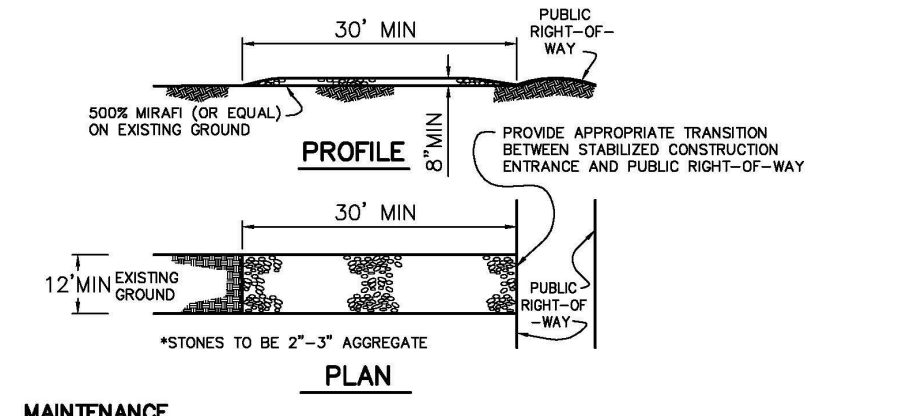


3 CONSTRUCTION ENTRANCE
NO SCALE

6 PAINT AND SOLVENT CLEANOUT AREA 1/2" = 1'-0"

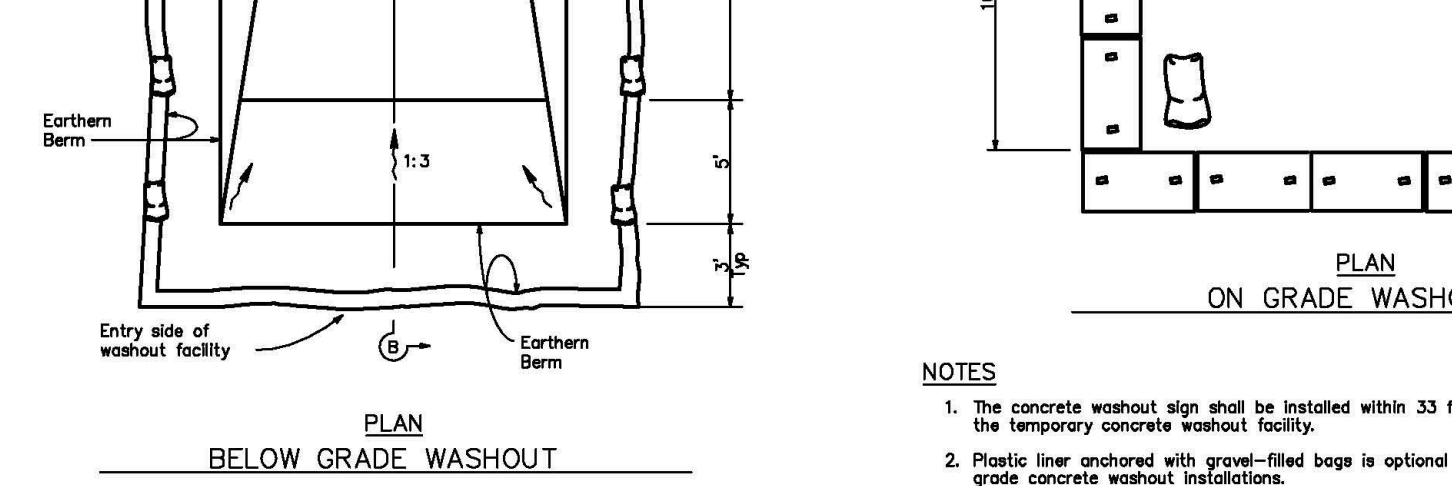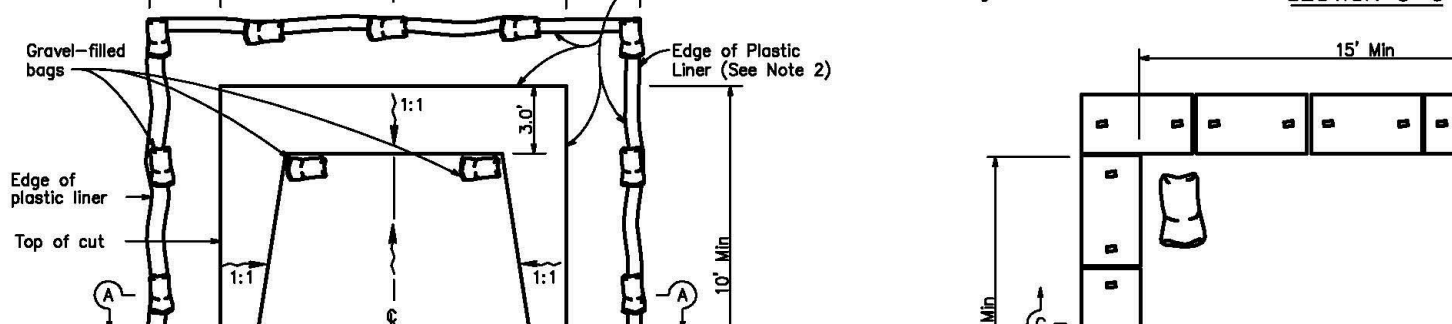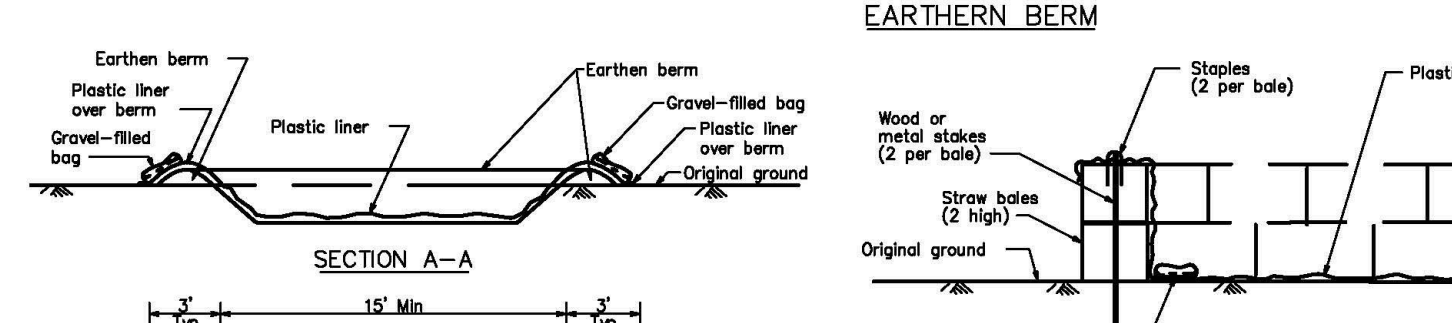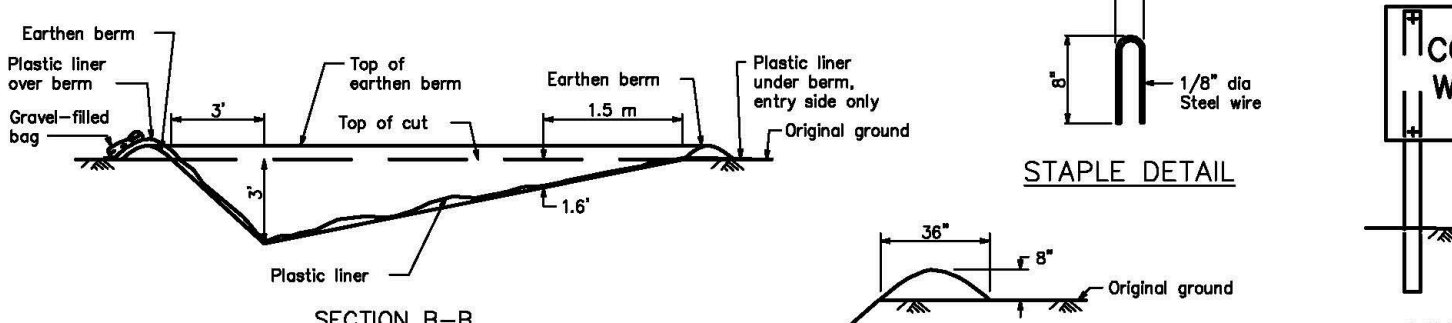

5 CONCRETE WASHOUT AREA NO SCALE

NOTES
1. The concrete washout sign shall be installed within 33 feet of the temporary concrete washout facility.
2. Plastic liner anchored with gravel-filled bags is optional for below grade concrete washout installations.

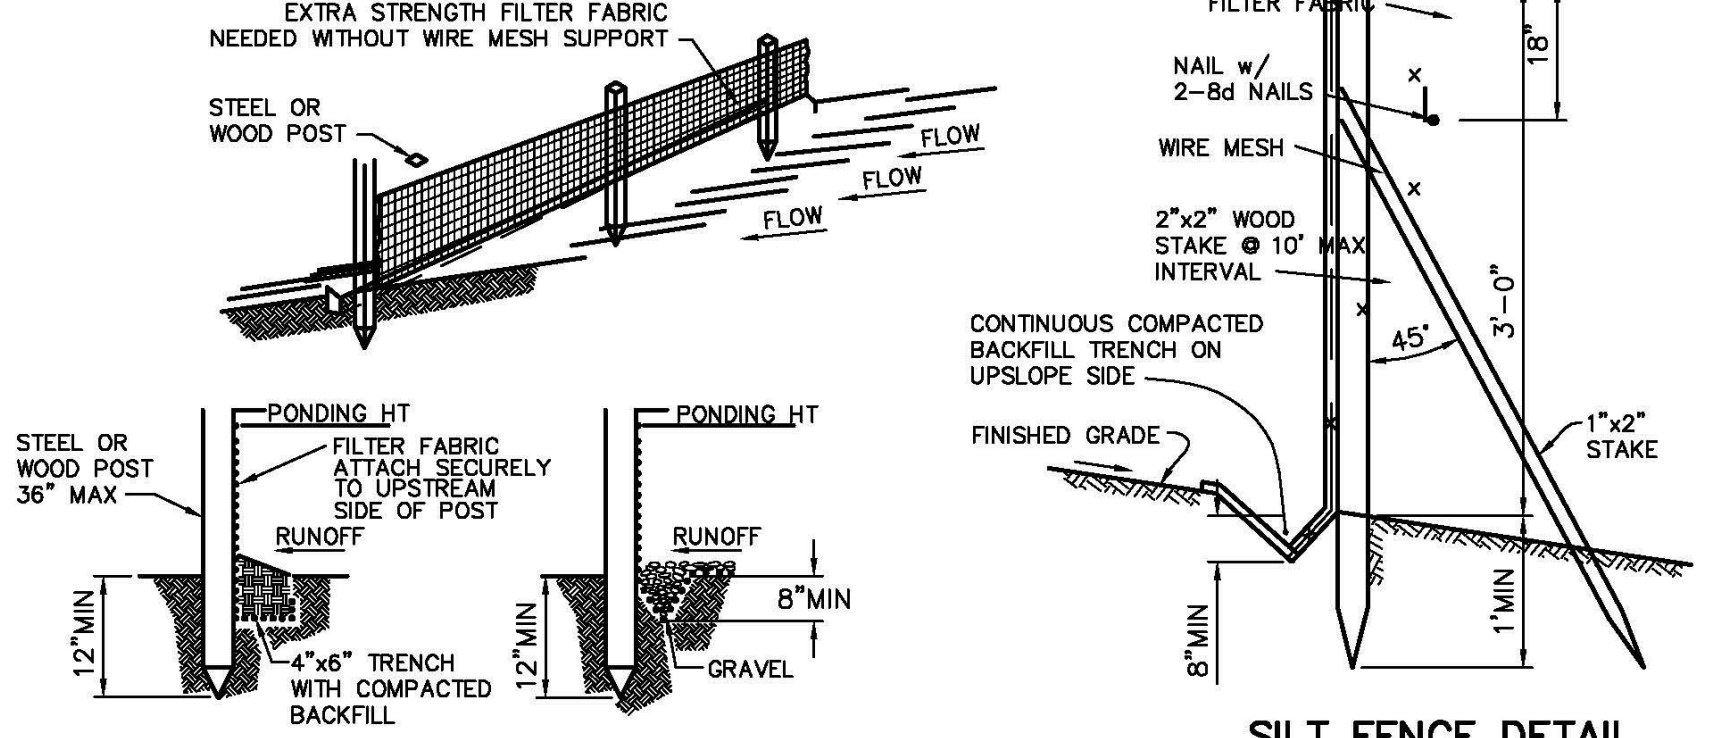


4 SILT FENCE DETAIL
NO SCALE

MAINTENANCE
- SILT FENCE AND FILTER BARRIERS SHALL BE INSPECTED DURING AND IMMEDIATELY AFTER EACH RAINFALL, AND AT LEAST DAILY DURING PROLONGED RAINFALL. ANY REQUIRED REPAIRS SHALL BE MADE IMMEDIATELY.
- SHOULD THE FABRIC ON A SILT FENCE OR FILTER BARRIER DECOMPOSE OR BECOME INEFFECTIVE DURING THE TIME THE FENCE OR BARRIER IS STILL NECESSARY, THE FABRIC SHALL BE REPLACED PROMPTLY.
- SEDIMENT DEPOSITS SHALL BE REMOVED WHEN DEPOSITS REACH APPROXIMATELY ONE-THIRD THE HEIGHT OF THE BARRIER.
- ANY SEDIMENT DEPOSITS REMAINING IN PLACE AFTER THE SILT FENCE OR FILTER BARRIER IS NO LONGER REQUIRED SHALL BE DRESSED TO CONFORM WITH THE EXISTING GRADE, PREPARED, AND SEEDED.
- SILT BUILDUPS MUST BE REMOVED WHEN BULGES DEVELOP IN THE FENCE REGARDLESS OF DEPTH OF DEPOSITION.

USE OF THESE PLANS AND SPECIFICATIONS SHALL BE RESTRICTED TO THE ORIGINAL SITE FOR WHICH THEY WERE PREPARED AND PUBLICATION THEREOF IS EXPRESSLY LIMITED TO SUCH USE. REPRODUCTION OR PUBLICATION BY ANY METHOD, IN WHOLE OR IN PART, IS PROHIBITED. TITLE TO THE PLANS AND SPECIFICATIONS REMAINS WITH THE ARCHITECT WITHOUT PREJUDICE. VISUAL CONTACT WITH THESE PLANS AND SPECIFICATIONS SHALL CONSTITUTE PRIMA FACIE EVIDENCE OF THE ACCEPTANCE OF THESE RESTRICTIONS.

Use of these plans and specifications shall be restricted to the original site for which they were prepared and publication thereof is expressly limited to such use. Reproduction or publication by any method, in whole or in part, is prohibited. Title to the plans and specifications remains with the architect without prejudice. Visual contact with these plans and specifications shall constitute prima facie evidence of the acceptance of these restrictions.

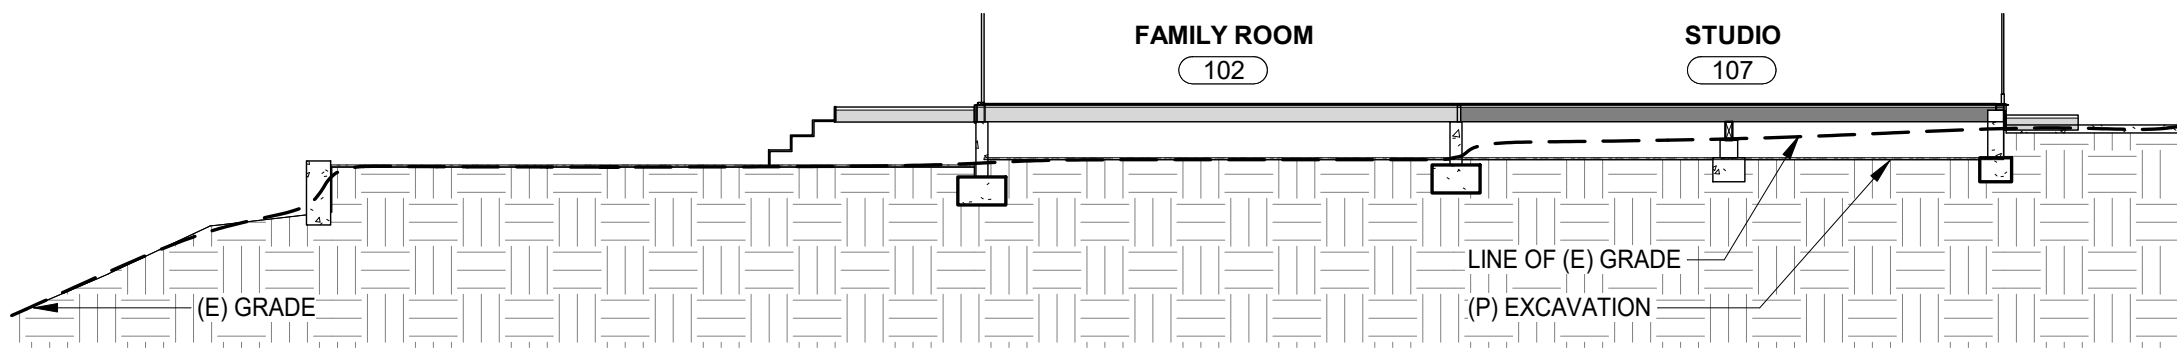


2 GRADING SECTION
1/8" = 1'-0"

LEGEND:

- 30% SLOPE OR GREATER
- MAN-MADE SLOPE 30% OR GREATER
- PROPOSED CUT
- PROPOSED FILL
- ASPHALT DRIVEWAY
- WATER FLOW
- SILT FENCING
- STRAW WATTLE

PROPERTY LINE

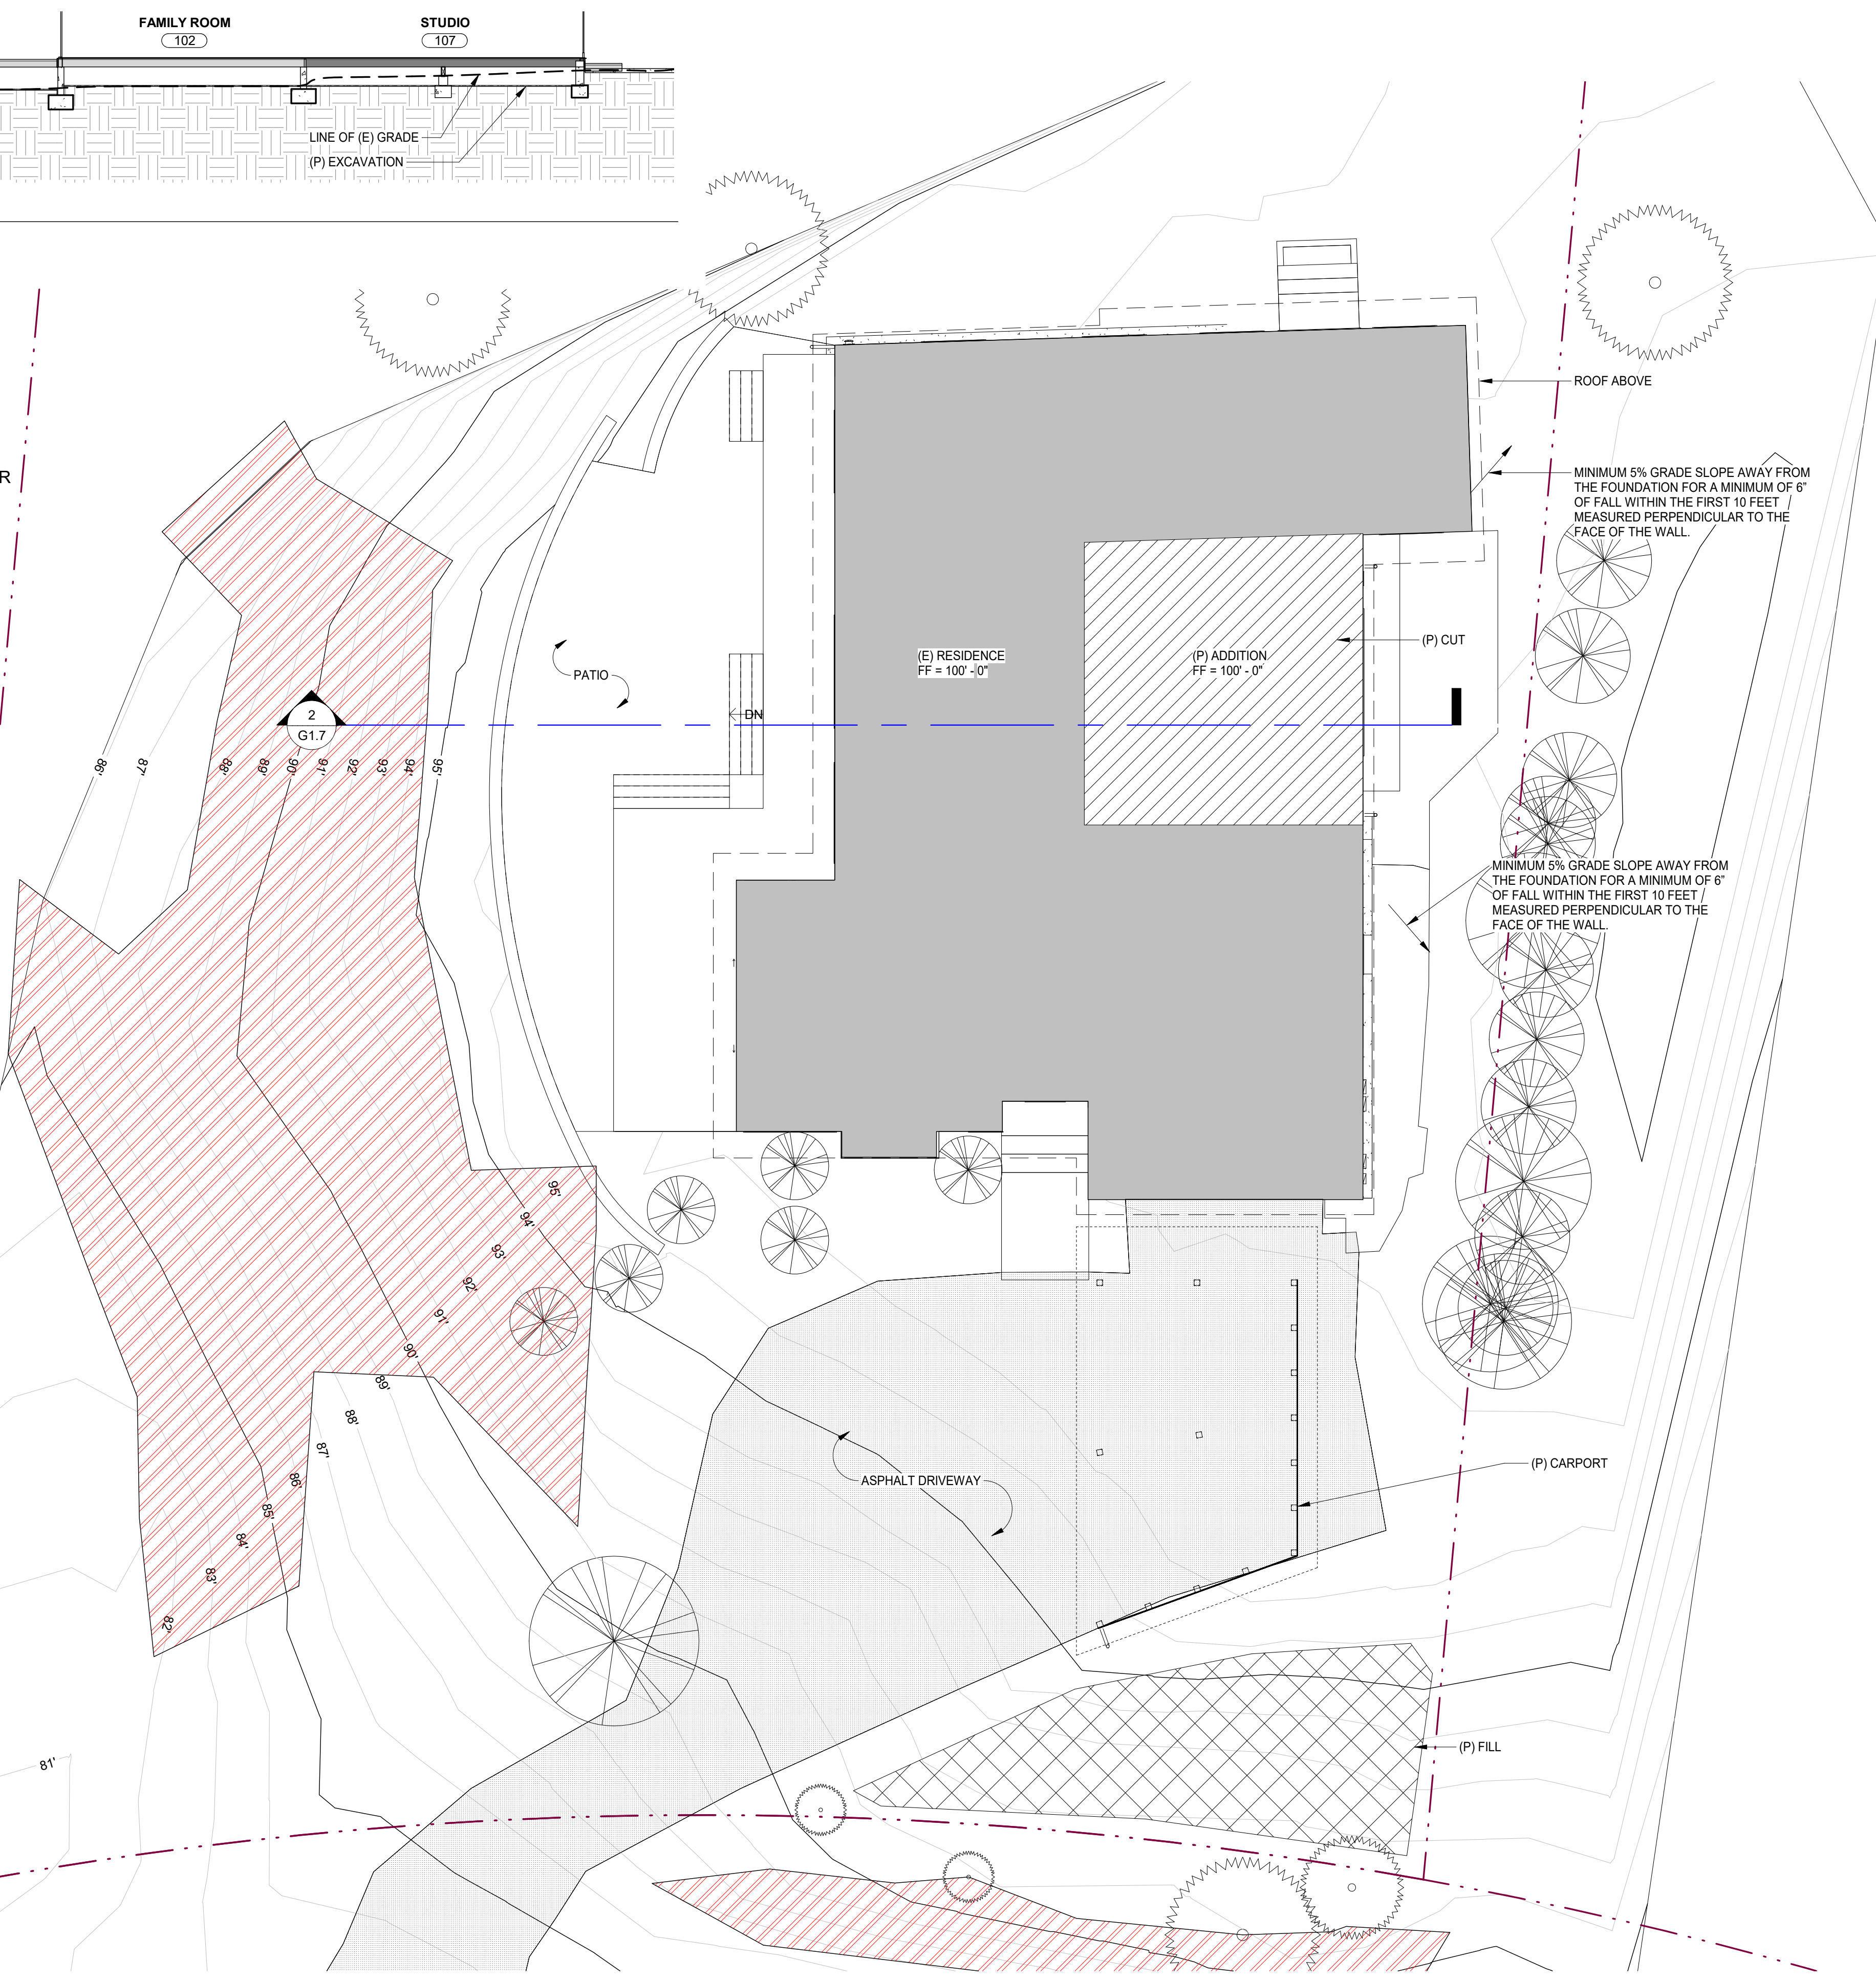

1 GRADING / SLOPE / DRAINAGE PLAN
1/8" = 1'-0"

GENERAL NOTES

1. CONTRACTOR TO FIELD VERIFY EXISTING CONDITIONS PRIOR TO CONSTRUCTION AND NOTIFY ARCHITECT IN WRITING OF ANY DISCREPANCIES.
2. CONTRACTOR SHALL PROTECT EXISTING TREES AND ROOT SYSTEM. ALL EXCAVATION AROUND EXISTING TREES SHALL BE MADE BY HAND.
3. CULTURAL, ARCHAEOLOGICAL, HISTORICAL OR PALEONTOLOGICAL RESOURCES NOTIFICATION: "STOP WORK WITHIN 50 METERS (165 FEET) OF UNCOVERED RESOURCE AND CONTACT MONTEREY COUNTY RMA-PLANNING AND A QUALIFIED ARCHAEOLOGIST IMMEDIATELY IF CULTURAL, ARCHAEOLOGICAL, HISTORICAL OR PALEONTOLOGICAL RESOURCES ARE UNCOVERED."
4. TOPOGRAPHY WAS PREPARED BY MONTEREY BAY ENGINEERS, INC.
5. THE EXISTENCE, LOCATION AND ELEVATION OF ANY UNDERGROUND FACILITIES ARE SHOWN ON THESE PLANS AS REFERENCE ONLY. NOT ALL UTILITIES MAY BE SHOWN. IT IS MANDATORY THAT THE CONTRACTOR EXPOSE AND VERIFY THE TOP AND BOTTOM OF ALL UTILITIES PRIOR TO ANY WORK. IT IS THE RESPONSIBILITY OF THE CONTRACTOR TO MAKE THE FINAL DETERMINATION AS TO THE EXISTENCE, LOCATION AND ELEVATION OF ALL UTILITIES. AND TO BRING ANY DISCREPANCY TO THE ATTENTION OF THE ARCHITECT.

GEOTECHNICAL ENGINEER INSPECTION SCHEDULE

When the inspection is to be completed	Who will conduct the inspection	Description of the required inspection	Name	Date
Pre-Construction Meeting	Geotechnical Engineer			
Completion of Over-Excavation	Geotechnical Engineer	Observation and testing		
Placement of Fill	Geotechnical Engineer	Observation and testing		

GEOTECHNICAL ENGINEER INSPECTION SCHEDULE

INSPECTION - PRIOR TO LAND DISTURBANCE
PRIOR TO LAND DISTURBANCE, THE APPLICANT SHALL SCHEDULE AN INSPECTION WITH RMA-ENVIRONMENTAL SERVICES TO ENSURE ALL NECESSARY SEDIMENT CONTROLS ARE IN PLACE AND THE PROJECT IS COMPLIANT WITH MONTEREY COUNTY GRADING AND EROSION CONTROL REGULATIONS.

INSPECTION - DURING ACTIVE CONSTRUCTION
DURING CONSTRUCTION, THE OWNER/APPLICANT SHALL SCHEDULE AN INSPECTION WITH RMA-ENVIRONMENTAL SERVICES TO INSPECT DRAINAGE DEVICE INSTALLATION, REVIEW THE MAINTENANCE AND EFFECTIVENESS OF BMP'S INSTALLED, AND TO VERIFY THAT POLLUTANTS OF CONCERN ARE NOT DISCHARGED FROM THE SITE. AT THE TIME OF THE INSPECTION, THE APPLICANT SHALL PROVIDE CERTIFICATION THAT ALL NECESSARY GEOTECHNICAL INSPECTIONS HAVE BEEN COMPLETED TO THAT POINT.



INSPECTION - FOLLOWING ACTIVE CONSTRUCTION
PRIOR TO FINAL INSPECTION, THE OWNER/APPLICANT SHALL SCHEDULE AN INSPECTION WITH RMA-ENVIRONMENTAL SERVICES TO INSPECT DRAINAGE DEVICE INSTALLATION, REVIEW THE MAINTENANCE AND EFFECTIVENESS OF BMP'S INSTALLED, AND TO VERIFY THAT POLLUTANTS OF CONCERN ARE NOT DISCHARGED FROM THE SITE. AT THE TIME OF THE INSPECTION, THE APPLICANT SHALL PROVIDE CERTIFICATION THAT ALL NECESSARY GEOTECHNICAL INSPECTIONS HAVE BEEN COMPLETED TO THAT POINT.

INSPECTION - FOLLOWING ACTIVE CONSTRUCTION
PRIOR TO FINAL INSPECTION, THE OWNER/APPLICANT SHALL SCHEDULE AN INSPECTION WITH RMA-ENVIRONMENTAL SERVICES TO ENSURE THAT ALL DISTURBED AREAS HAVE BEEN STABILIZED AND THAT ALL TEMPORARY EROSION AND SEDIMENT CONTROL MEASURES THAT ARE NO LONGER NEEDED HAVE BEEN REMOVED.

GEOTECHNICAL CERTIFICATION
PRIOR TO FINAL INSPECTION, THE APPLICANT SHALL PROVIDE A LETTER FROM A LICENSED PRACTITIONER CERTIFYING THAT ALL DEVELOPMENT HAS BEEN CONSTRUCTED IN ACCORDANCE WITH THE RECOMMENDATIONS IN THE PROJECT GEOTECHNICAL REPORT.


GRADING ESTIMATES

GRADING CUT	20	CU. YDS.
GRADING FILL	20	CU. YDS.
GRADING NET IMPORT	0	CU. YDS.

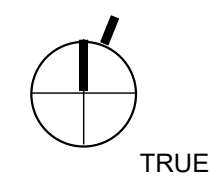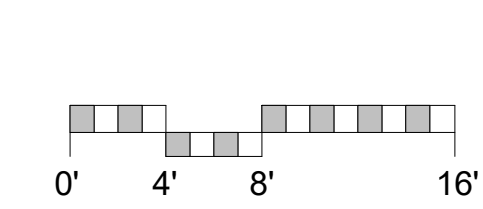

**SCHWARTZ
TRYON
REMODEL**

24980 OUTLOOK DR.,
CARMEL, CA 93923

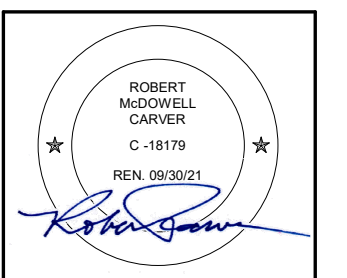

**PLANNING
DEPARTMENT
SUBMITTAL**

PO BOX 2884 -
CARMEL CA 93921 - USA
T:831.622.7837 - F:831.624.0364
WWW.STUDIOCARVER.COM

STUDIO CARVER
ARCHITECTURE + PLANNING + INTERIOR DESIGN



REVISION #


1	1/08/18	PLAN REVIEW COMMENTS
2	8/6/2020	PLN170572 REVISION
5	4/23/2021	BUILDING CORRECTIO NS

**ARCHITECTURAL
GRADING/SLOPE
MAP & DRAINAGE
PLAN**

Scale: As indicated
@ 24x36
Drawn By: DP
Job: 1713

G1.7
5/4/2021 4:08:04 PM

Use of these plans and specifications shall be restricted to the original site for which they were prepared and publication thereof is expressly limited to such use. Reproduction or publication by any method, in whole or in part, is prohibited. Title to the plans and specifications remains with the architect without prejudice. Visual contact with these plans and specifications shall constitute prima facie evidence of the acceptance of these restrictions.

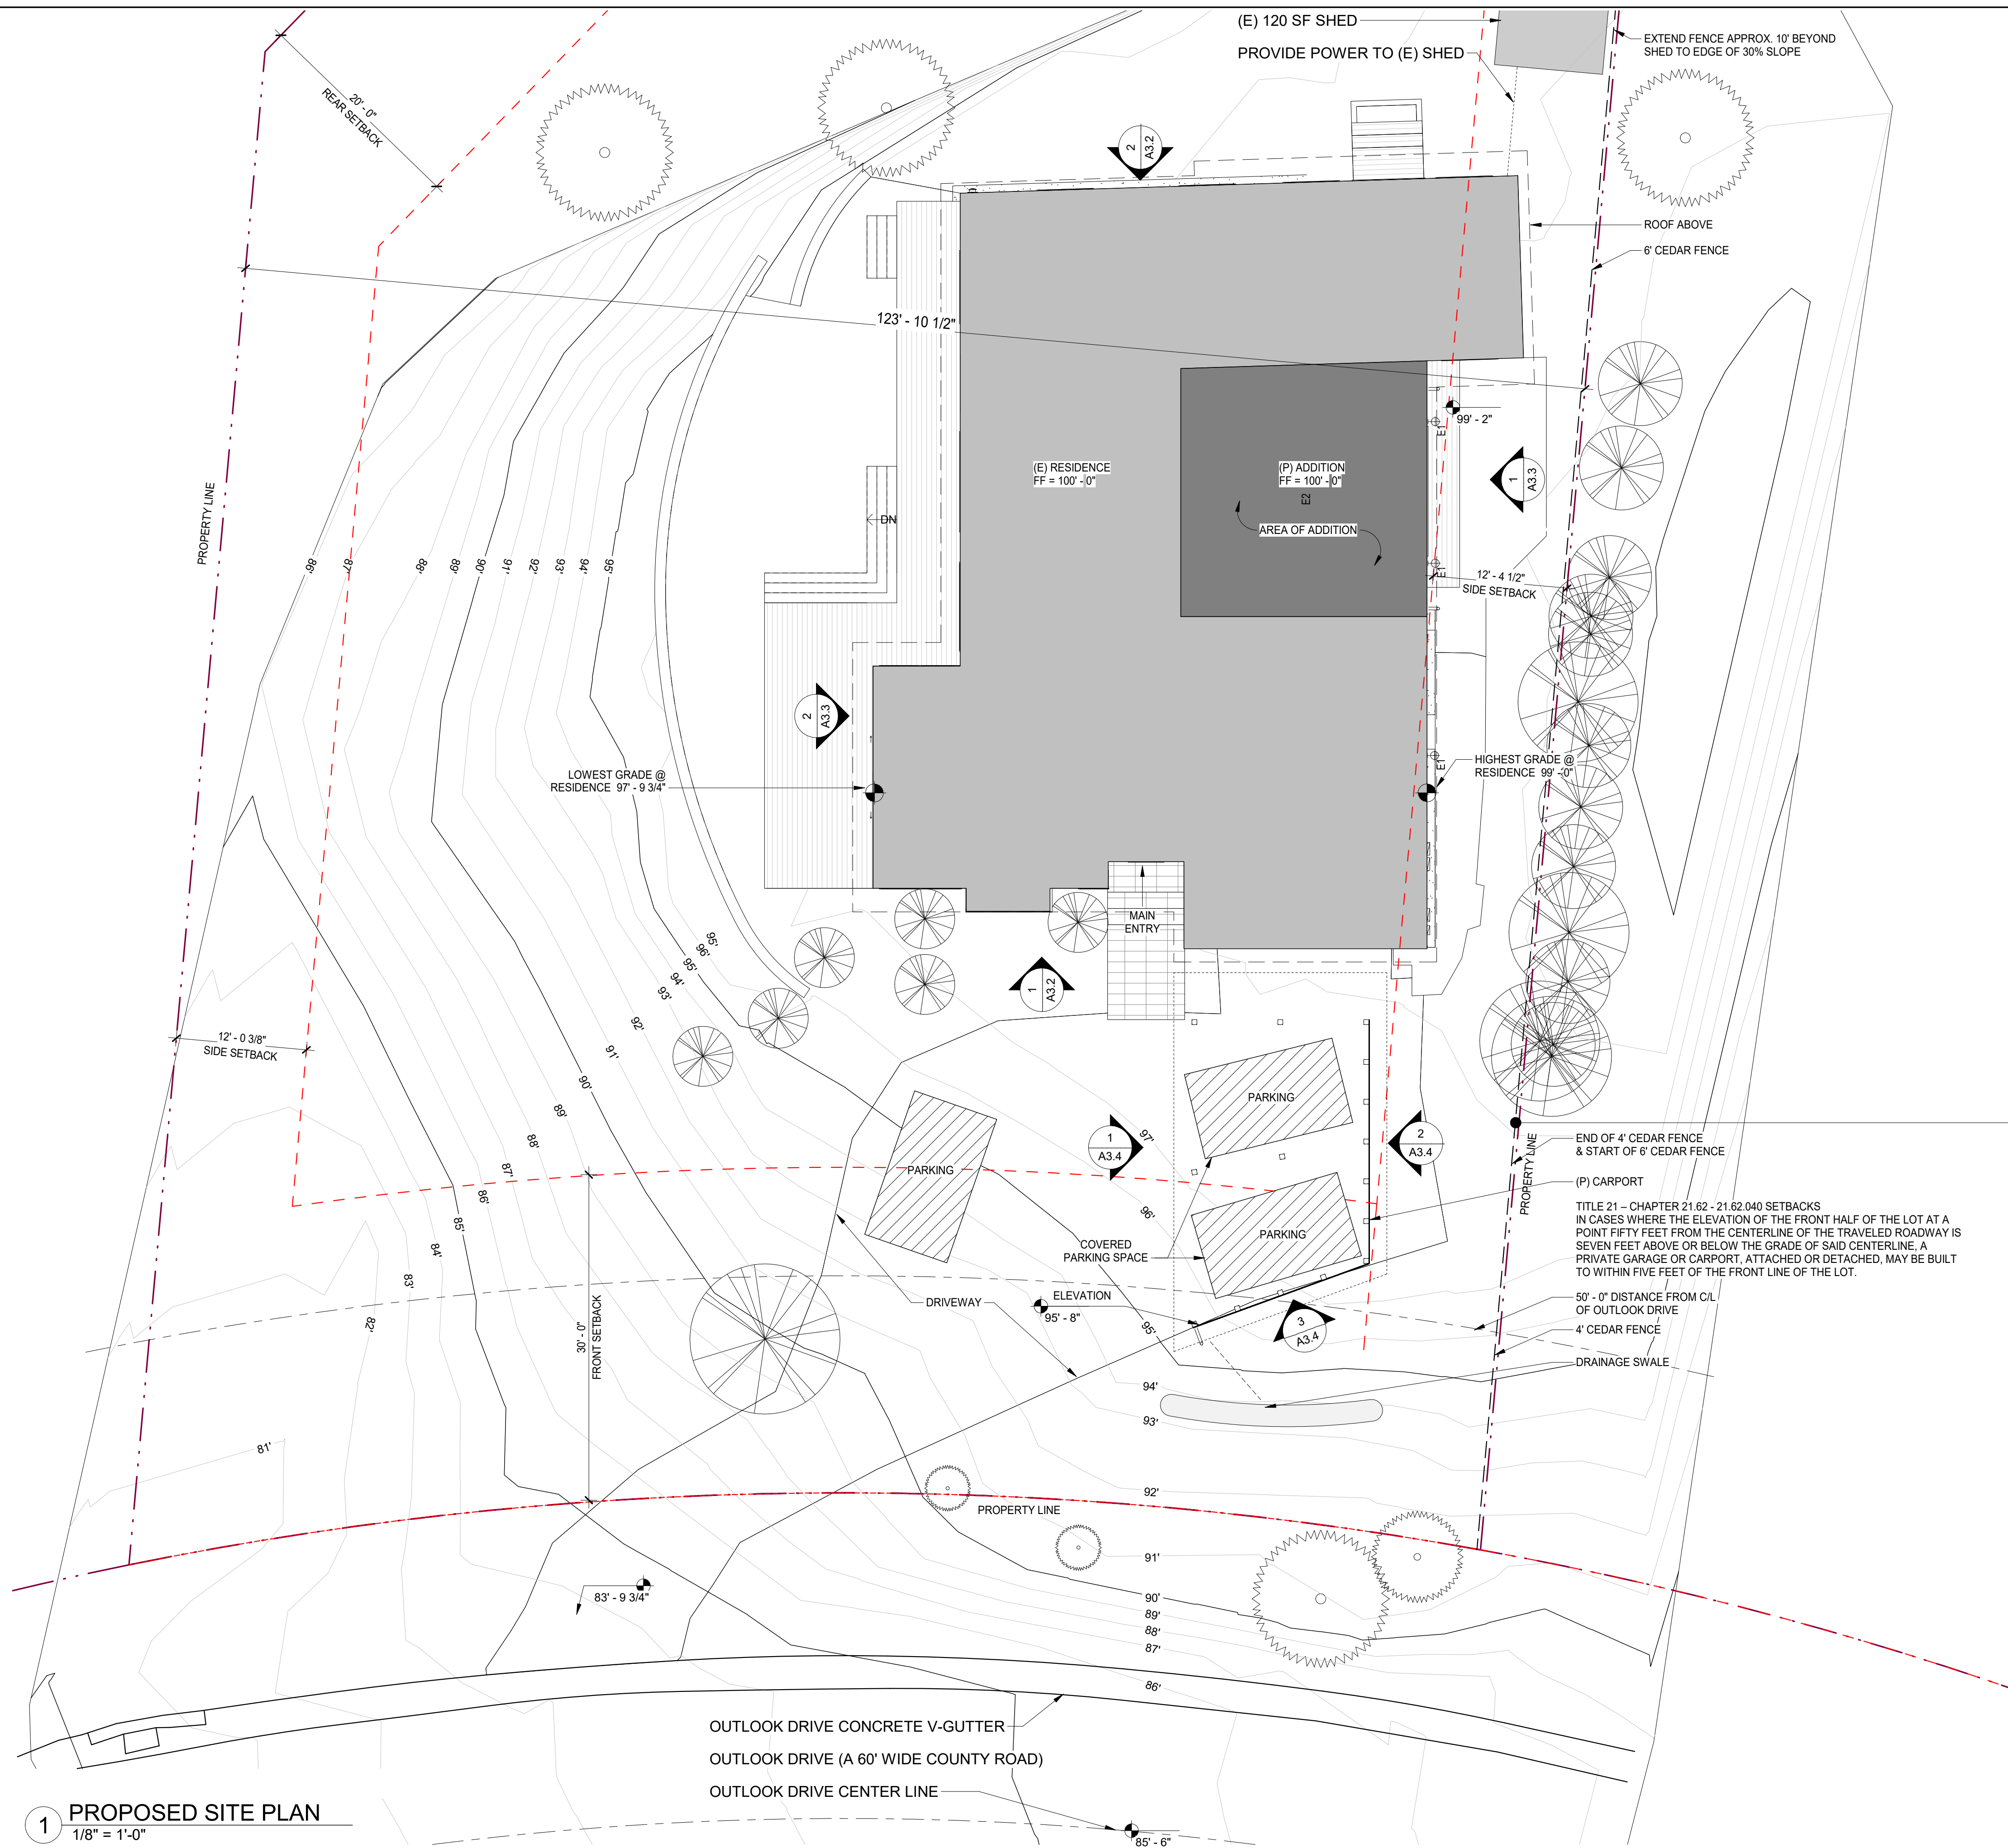


GENERAL NOTES

1. CONTRACTOR TO FIELD VERIFY EXISTING CONDITIONS PRIOR TO CONSTRUCTION AND NOTIFY ARCHITECT IN WRITING OF ANY DISCREPANCIES.
2. CONTRACTOR SHALL PROTECT EXISTING TREES AND ROOT SYSTEM. ALL EXCAVATION AROUND EXISTING TREES SHALL BE MADE BY HAND.
3. ALL EXTERIOR SWINGING EXIT DOORS SHALL HAVE A THRESHOLD THAT SHALL NOT EXCEED 1-1/2" IN HEIGHT.
4. CULTURAL, ARCHAEOLOGICAL, HISTORICAL OR PALEONTOLOGICAL RESOURCES NOTIFICATION: "STOP WORK WITHIN 50 METERS (165 FEET) OF UNCOVERED RESOURCE AND CONTACT MONTEREY COUNTY PBA-PLANNING AND A QUALIFIED ARCHAEOLOGIST IMMEDIATELY IF CULTURAL, ARCHAEOLOGICAL, HISTORICAL OR PALEONTOLOGICAL RESOURCES ARE UNCOVERED".

EXTERIOR LIGHTING FIXTURES


- E1 EXTERIOR ULTRA NARROW BEAM LED WALL MOUNTED LIGHT QUANTITY = 3

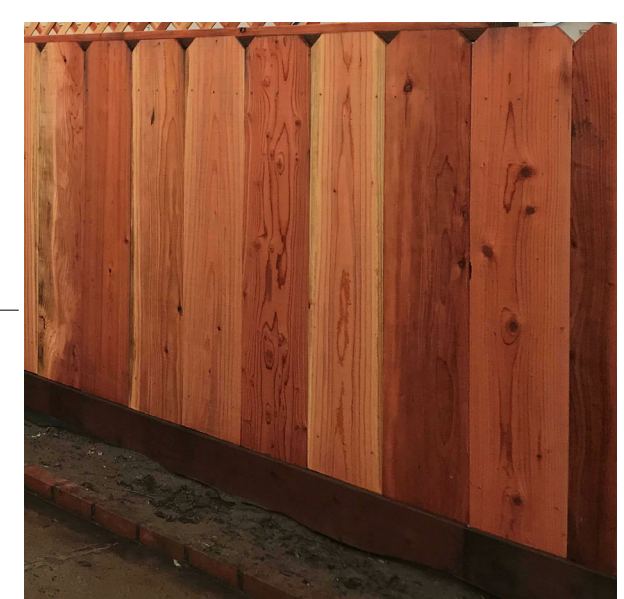

PROPOSED FENCE

**SCHWARTZ
TRYON
REMODEL**

24980 OUTLOOK DR.,
CARMEL, CA 93923

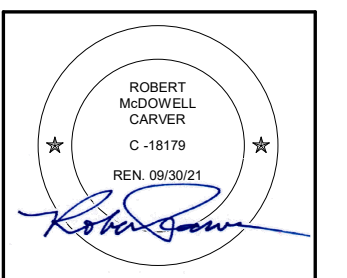

**PLANNING
DEPARTMENT
SUBMITTAL**

PO BOX 2884 -
CARMEL CA 93921 - USA
T:831.622.7837 - F:831.624.0364
WWW.STUDIOCARVER.COM

STUDIO CARVER
ARCHITECTURE + PLANNING + INTERIOR DESIGN




REVISION #	DATE	DESCRIPTION
2	8/5/2020	PLN170572 REVISION
3	3/24/2021	Revision 3
4	4/1/2021	FENCE

**ARCHITECTURAL
SITE PLAN**


Scale: 1/8" = 1'-0"
@ 24x36
Drawn By: DP
Job: 1713

A1.0
5/4/2021 4:07:30 PM

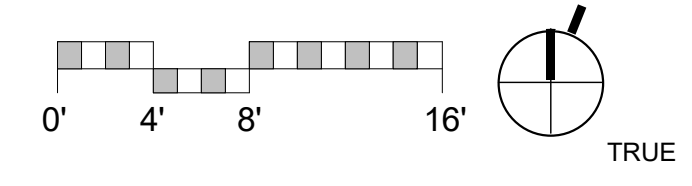

1 PROPOSED SITE PLAN
1/8" = 1'-0"

Use of these plans and specifications shall be restricted to the original site for which they were prepared and publication thereof is expressly limited to such use. Reproduction or publication by any method, in whole or in part, is prohibited. Title to the plans and specifications remains with the architect without prejudice. Visual contact with these plans and specifications shall constitute prima facie evidence of the accuracy of these restrictions.

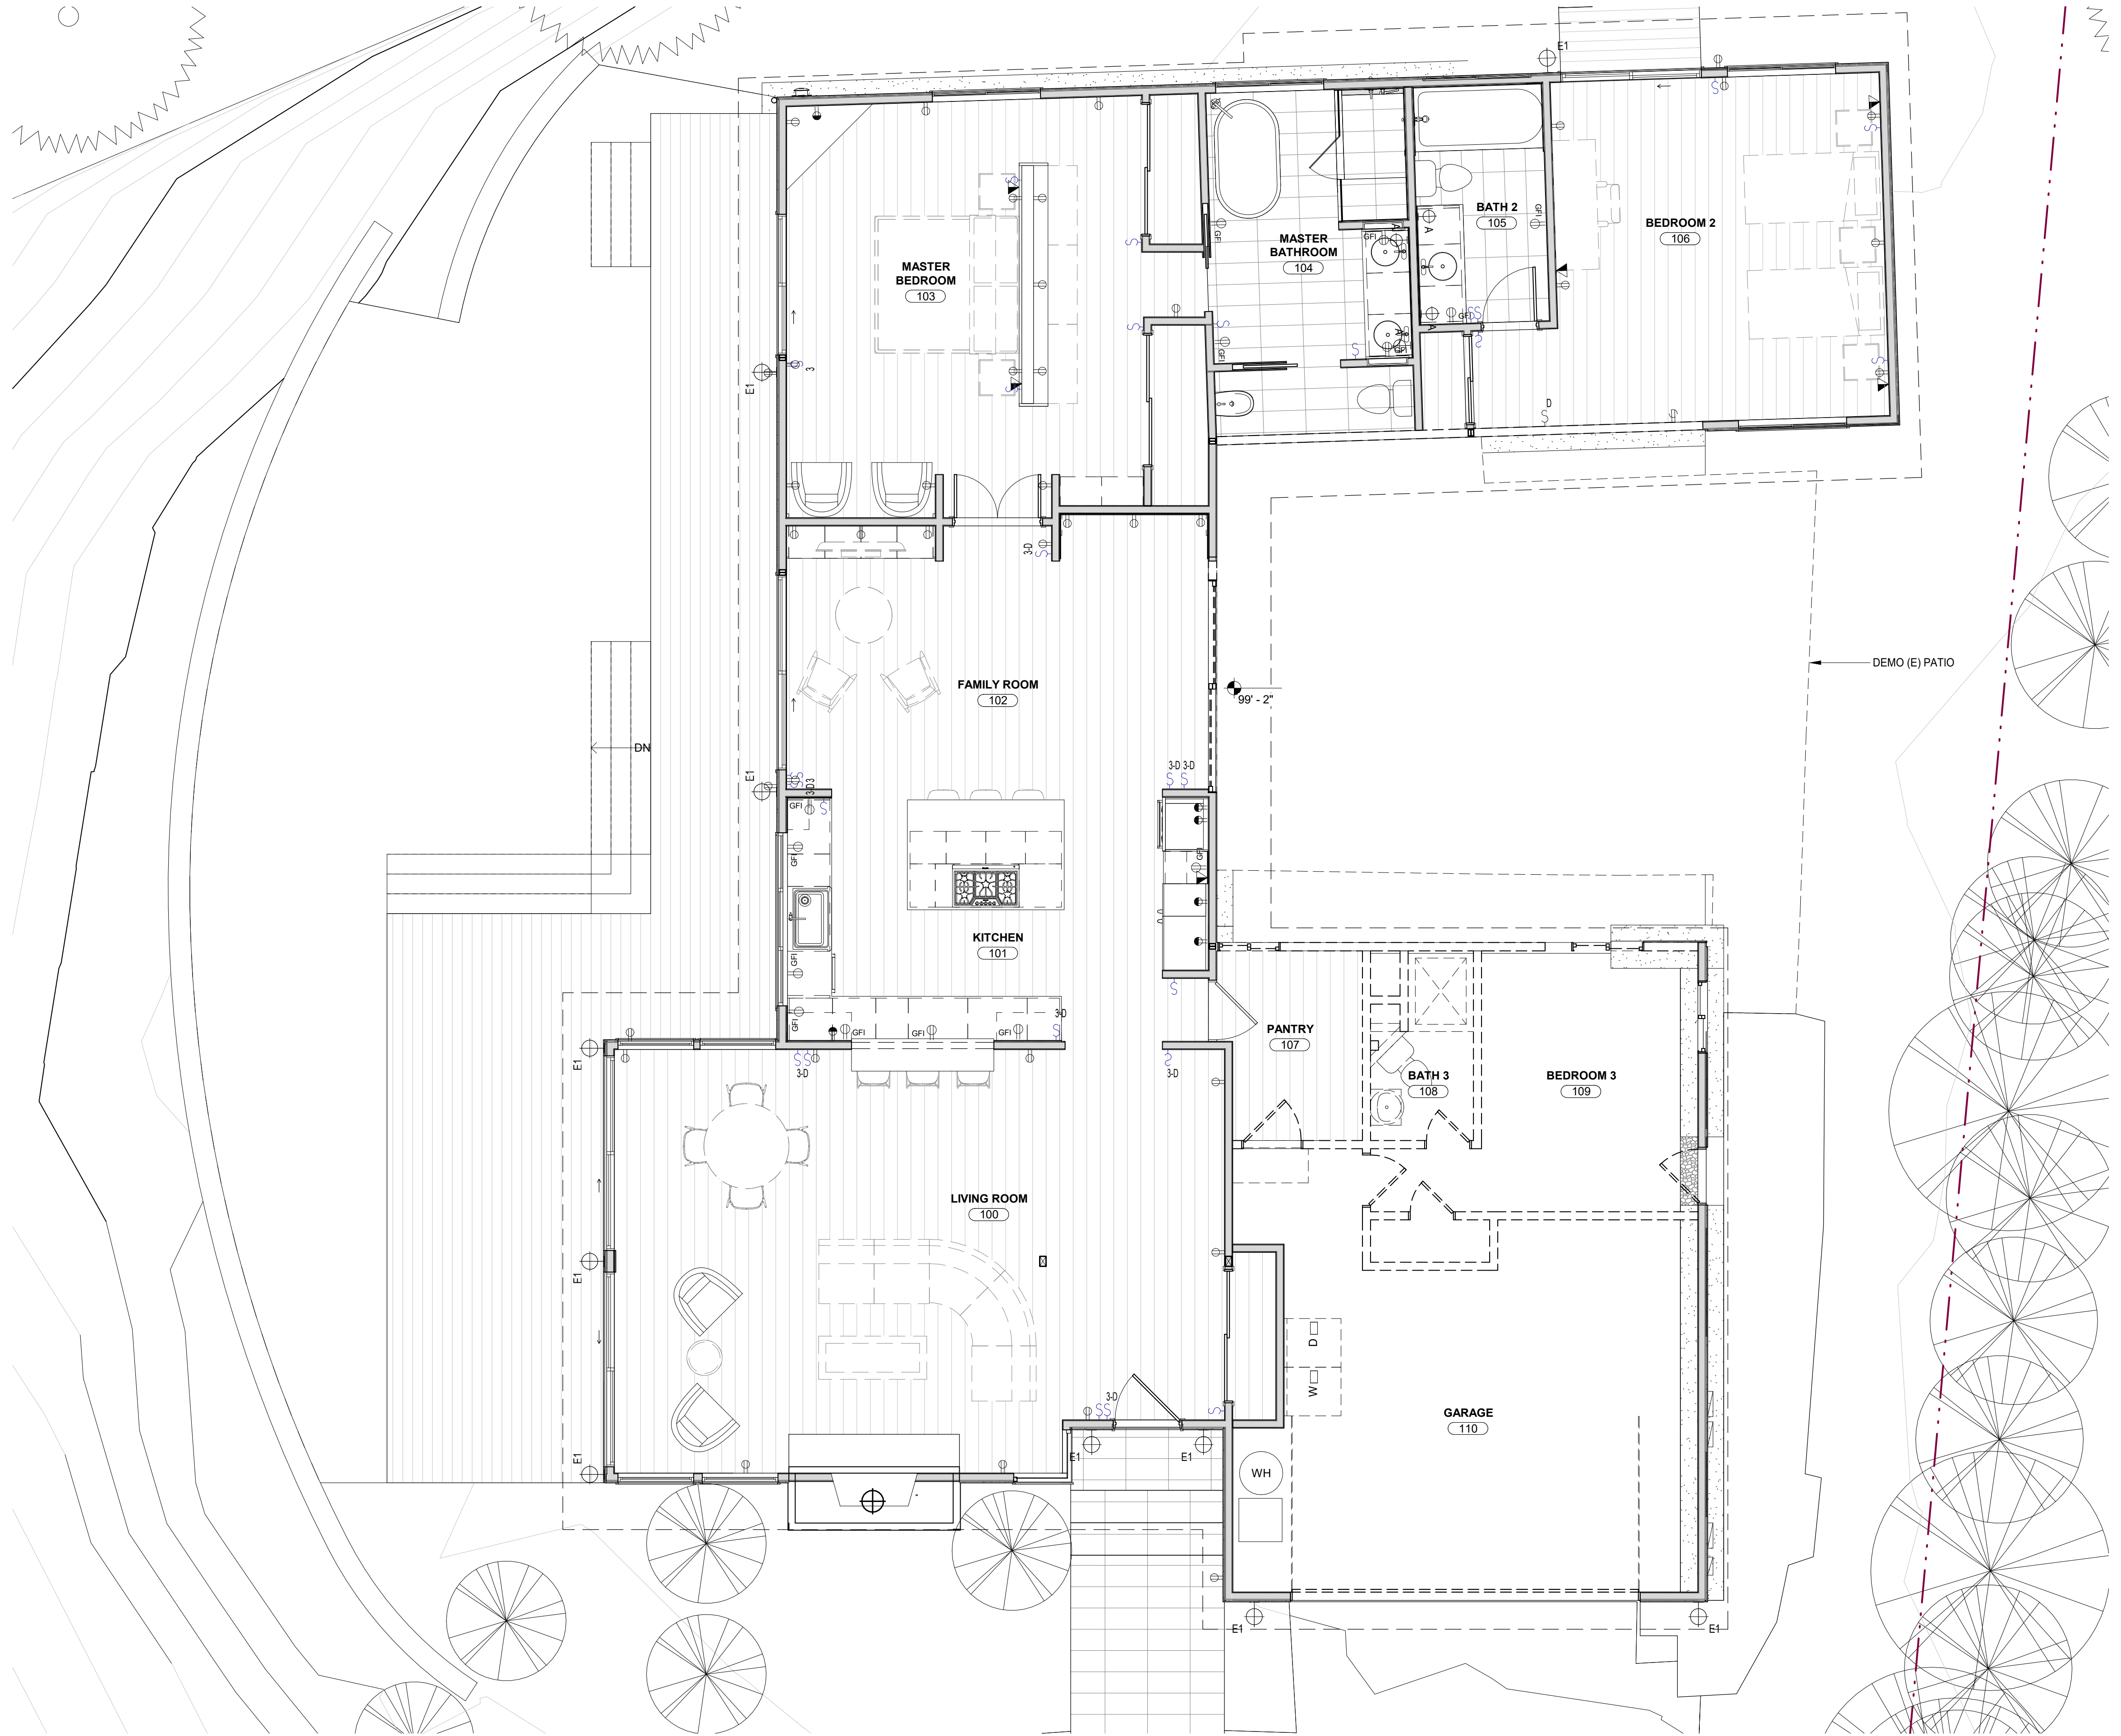

GENERAL NOTES

1. CONTRACTOR TO FIELD VERIFY EXISTING CONDITIONS PRIOR TO CONSTRUCTION AND NOTIFY ARCHITECT IN WRITING OF ANY DISCREPANCIES.
2. CONTRACTOR SHALL PROTECT EXISTING TREES AND ROOT SYSTEM. ALL EXCAVATION AROUND EXISTING TREES SHALL BE MADE BY HAND.
3. CULTURAL, ARCHAEOLOGICAL, HISTORICAL OR PALEONTOLOGICAL RESOURCES NOTIFICATION: "STOP WORK WITHIN 50 METERS (165 FEET) OF UNCOVERED RESOURCE AND CONTACT MONTEREY COUNTY RMA-PLANNING AND A QUALIFIED ARCHAEOLOGIST IMMEDIATELY IF CULTURAL, ARCHAEOLOGICAL, HISTORICAL OR PALEONTOLOGICAL RESOURCES ARE UNCOVERED."
4. MINIMUM 50% OF THE NON-HAZARDOUS CONSTRUCTION OR DEMOLITION DEBRIS SHALL BE RECYCLED AND/OR SALVAGED, UNLESS A LOCAL CONSTRUCTION AND DEMOLITION WASTE MANAGEMENT ORDINANCE IS MORE STRINGENT. WHERE THE LOCAL JURISDICTION DOES NOT HAVE A CONSTRUCTION AND WASTE MANAGEMENT ORDINANCE, A CONSTRUCTION AND WASTE MANAGEMENT PLAN COMPLYING WITH CGSBC SECTION 4.408.2 SHALL BE SUBMITTED FOR APPROVAL.


DEMOLITION LEGEND

- EXISTING WALL TO REMAIN
- EXISTING DOOR TO REMAIN
- EXISTING WALL TO BE DEMOLISHED
- EXISTING DOOR TO BE DEMOLISHED

1 LEVEL 1 - PHASE 2 DEMO
1/4" = 1'-0"

**SCHWARTZ
TRYON
REMODEL**

24980 OUTLOOK DR.,
CARMEL, CA 93923

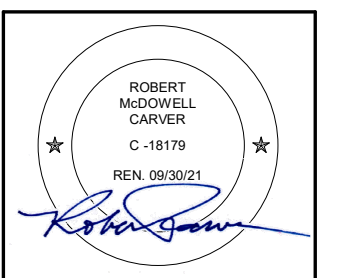

**PLANNING
DEPARTMENT
SUBMITTAL**

PO BOX 2884 -
CARMEL CA 93921 - USA
T:831.622.7837 - F:831.624.0364
WWW.STUDIOCARVER.COM

STUDIO CARVER
ARCHITECTURE + PLANNING + INTERIOR DESIGN




REVISION #	DATE	DESCRIPTION
1	1/08/18	PLAN REVIEW COMMENTS
2	8/5/2020	PLN170572 REVISION

**ARCHITECTURAL
EXISTING/ PHASE
2 DEMO FLOOR
PLAN**


Scale: 1/4" = 1'-0"
@ 24x36
Drawn By: DP
Job: 1713

A2.0
5/4/2021 4:07:24 PM

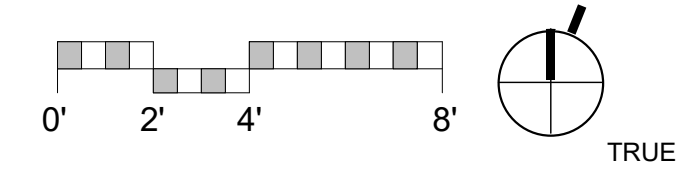

Use of these plans and specifications shall be restricted to the original site for which they were prepared and publication thereof is expressly limited to such use. Reproduction or publication by any method, in whole or in part, is prohibited. Title to the plans and specifications remains with the architect without prejudice. Visual contact with these plans and specifications shall constitute prima facie evidence of the acceptance of these restrictions.

1 LEVEL 1 - PHASE 2
1/4" = 1'-0"

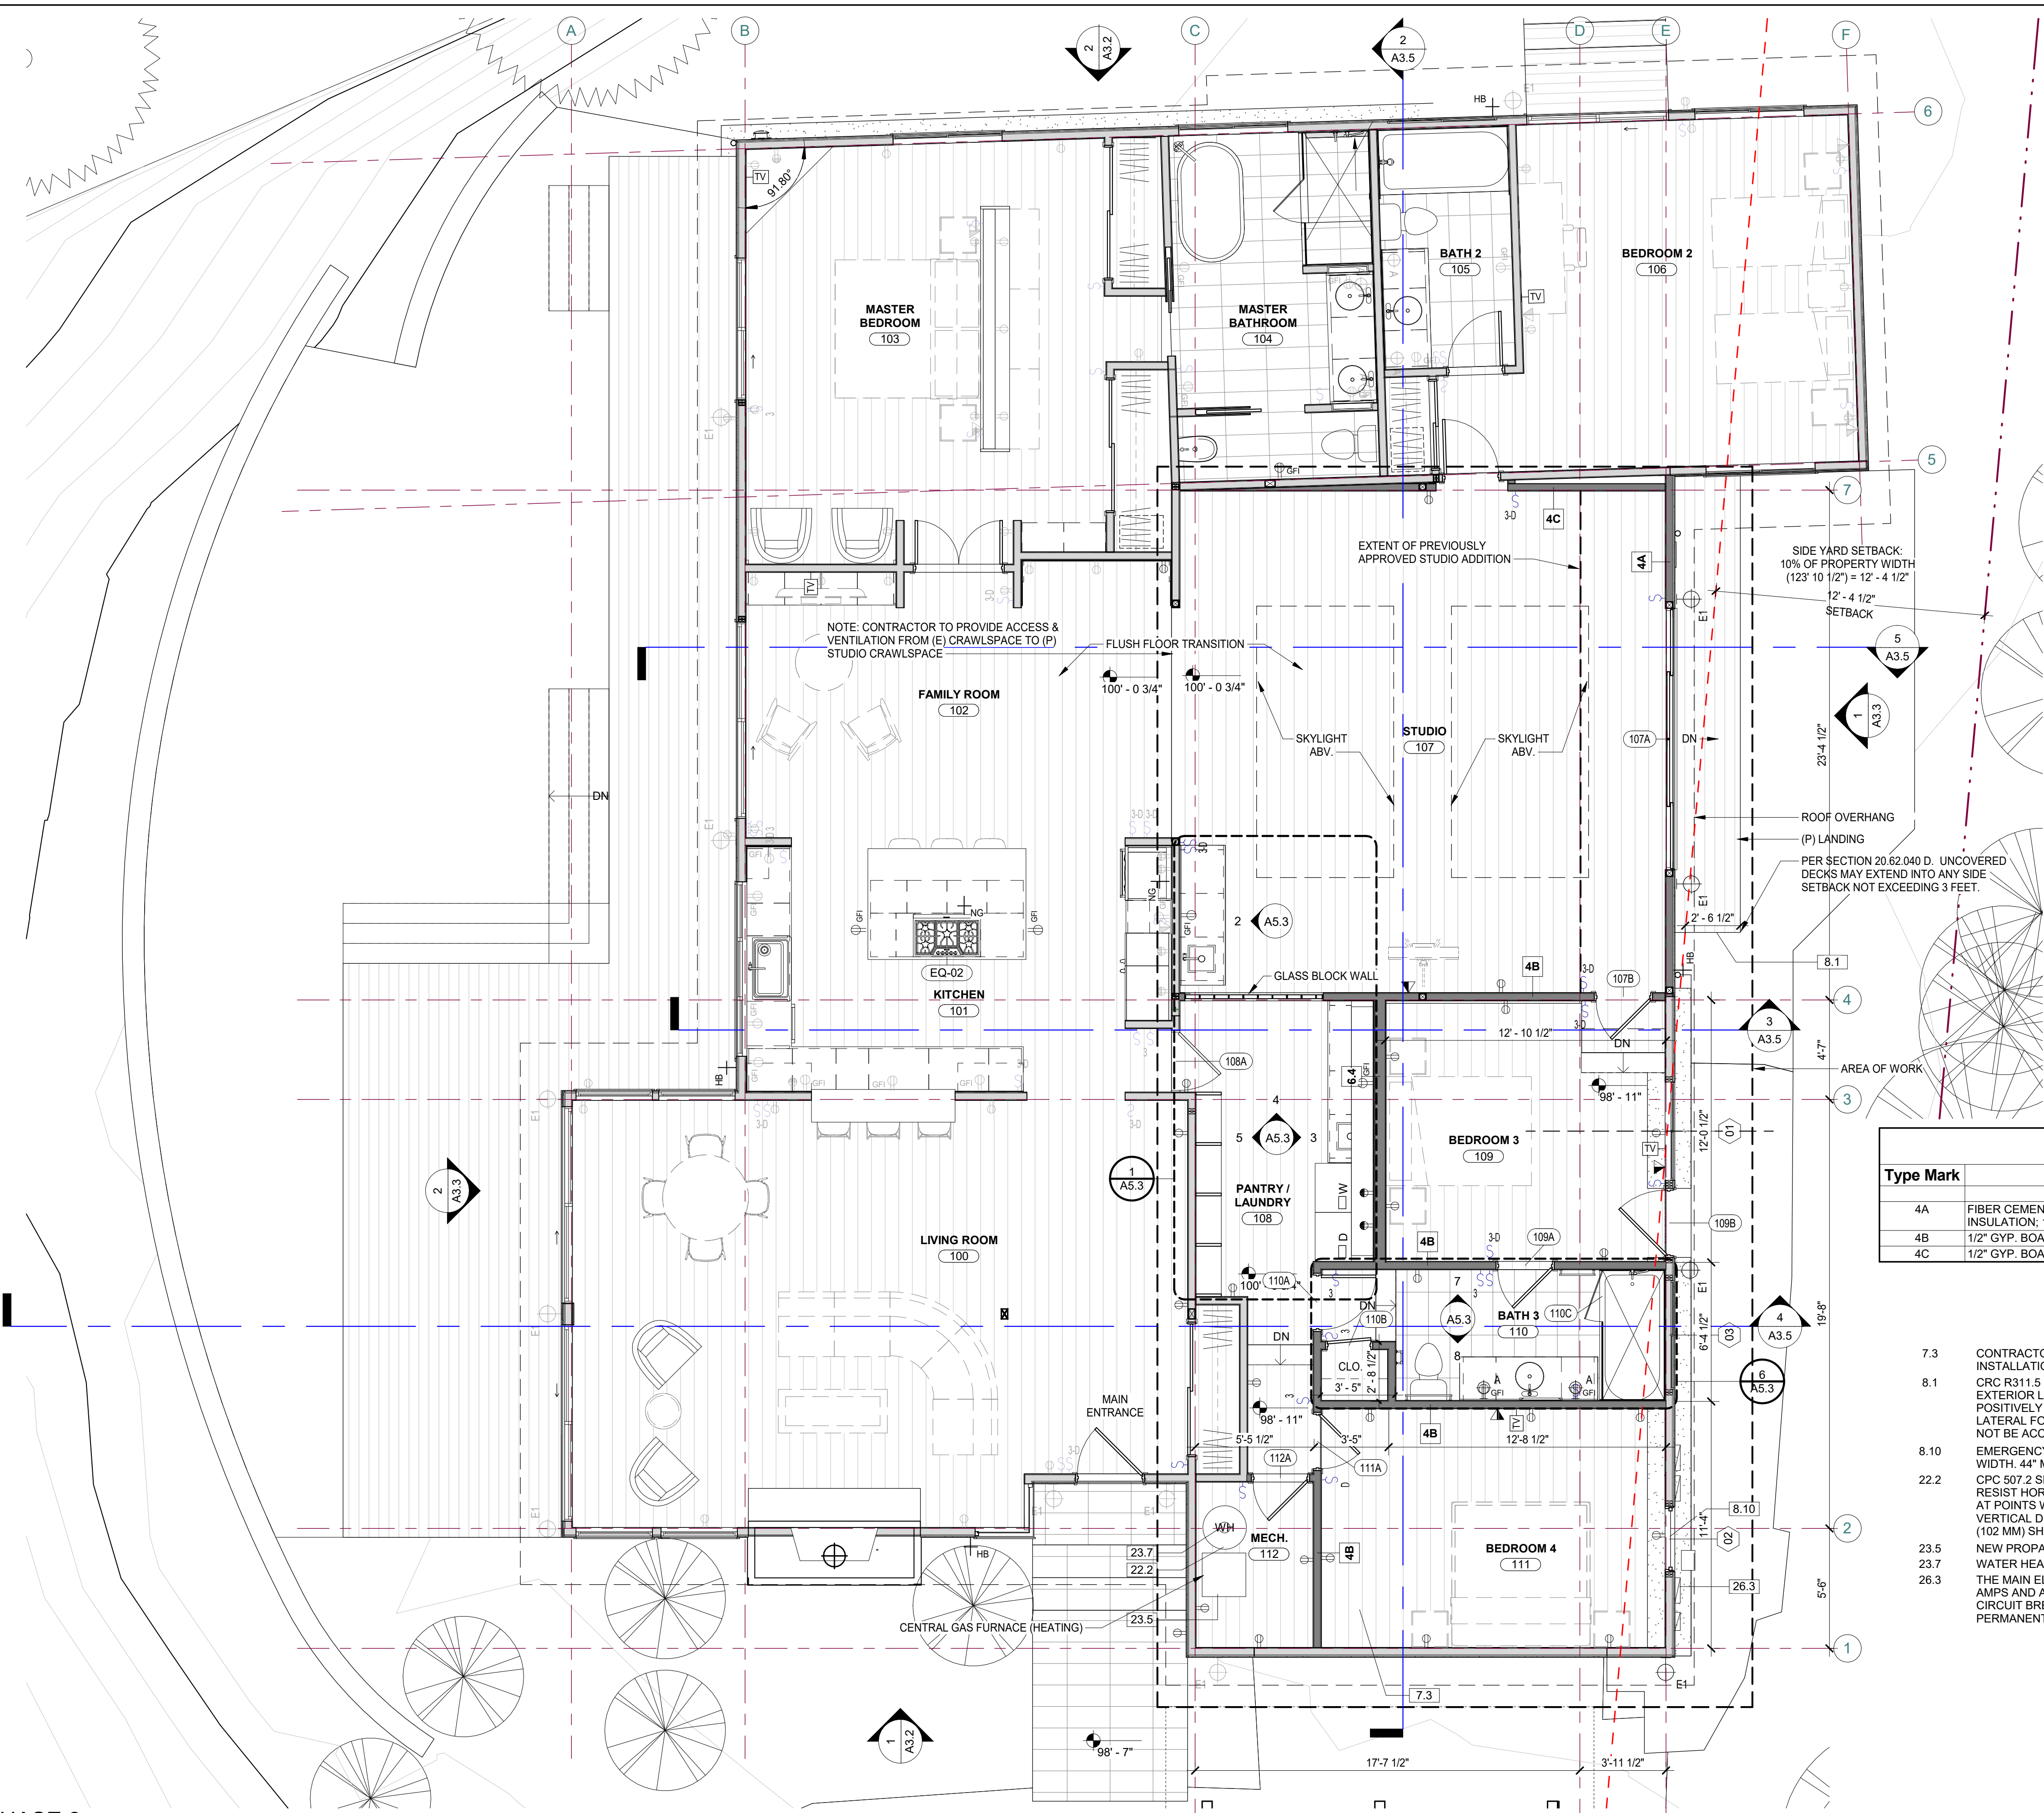

NEW EXTERIOR WALL
 NEW INTERIOR WALL
 EXISTING WALL TO REMAIN

ELECTRICAL SYMBOL LEGEND

- TAMPER RESISTANT DUPLEX OUTLET
- TAMPER RESISTANT TRIPLEX OUTLET
- GROUND FAULT CIRCUIT INTERRUPT OUTLET / TAMPER RESISTANT
- WATER PROOF EXTERIOR OUTLET / TAMPER RESISTANT
- SWITCHED OUTLET / TAMPER RESISTANT
- DEDICATED OUTLET - VERIFY W/ EQUIP. MFG. TAMPER RESISTANT
- DUAL CATSE / TELEPHONE JACK
- CABLE TV JACK
- HOSE BIBB
- NATURAL GAS VALVE

UNDERFLOOR VENTILATION CALCULATIONS

TOTAL CRAWL SPACE FLOOR AREA	2,673 SF
VENTING CODE	15F PER 150 SF OF FLOOR AREA
REQUIRED VENTING	17.82 SF
PROPOSED VENTING:	
(21) 8"X16" VENTS	18.66 SF
TOTAL VENTING	18.66 SF


WALL SCHEDULE

Type Mark	Description
4A	FIBER CEMENT SIDING; WRB; 1/2" PLYWOOD; 2x4 STUDS @ 16" O.C. W/ R=13 BATT INSULATION; 1/2" GYP. BOARD
4B	1/2" GYP. BOARD; 2X4 STUDS @ 16" O.C.; 1/2" GYP. BOARD
4C	1/2" GYP. BOARD; 2X4 STUDS @ 16" O.C.

KEYNOTE LEGEND

- 7.3 CONTRACTOR TO APPLY LATICRETE HYDROBAN TO (E) SLAB AND WALLS PRIOR TO INSTALLATION OF PROPOSED FLOOR
- 8.1 CRC R311.5 LANDING, DECK, BALCONY AND STAIR CONSTRUCTION AND ATTACHMENT - EXTERIOR LANDINGS, DECKS, BALCONIES, STAIRS AND SIMILAR FACILITIES SHALL BE POSITIVELY ANCHORED TO THE PRIMARY STRUCTURE TO RESIST BOTH VERTICAL AND LATERAL FORCES OR SHALL BE DESIGNED TO BE SELF-SUPPORTING. ATTACHMENT SHALL NOT BE ACCOMPLISHED BY USE OF TOENAILS OR NAILS SUBJECT TO WITHDRAWAL.
- 8.10 EMERGENCY ESCAPE OPENING. MIN NET CLEAR OPENING OF 5.7 SF. MIN 24" NET CLEAR WIDTH. 44" MAX SILL HEIGHT A.F.F.
- 22.2 CPC 507.2 SEISMIC PROVISIONS - WATER HEATERS SHALL BE ANCHORED OR STRAPPED TO RESIST HORIZONTAL DISPLACEMENT DUE TO EARTHQUAKE MOTION. STRAPPING SHALL BE AT POINTS WITHIN THE UPPER ONE-THIRD (1/3) AND LOWER ONE-THIRD (1/3) OF ITS VERTICAL DIMENSIONS. AT THE LOWER POINT, A MINIMUM DISTANCE OF FOUR(4) INCHES (102 MM) SHALL BE MAINTAINED ABOVE THE CONTROLS WITH THE STRAPPING.
- 23.5 NEW PROPANE FURNACE-PROVIDE PROPANE DRAIN AND DAYLIGHT TO EXTERIOR
- 23.7 WATER HEATER VENT TERMINATION PER CPC 510.1 & 510.5.2
- 26.3 THE MAIN ELECTRICAL SERVICE PANEL SHALL HAVE A MINIMUM BUSBAR RATING OF 200 AMPS AND A RESERVED SPACE TO ALLOW FOR THE INSTALLATION OF A DOUBLE POLE CIRCUIT BREAKER FOR SOLAR ELECTRIC INSTALLATION. THE RESERVED SPACE SHALL BE PERMANENTLY MARKED AS "FOR FUTURE SOLAR ELECTRIC".

**SCHWARTZ
TRYON
REMODEL**
24980 OUTLOOK DR.,
CARMEL, CA 93923

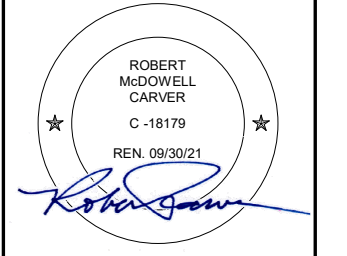

**PLANNING
DEPARTMENT
SUBMITTAL**

PO BOX 2884 -
CARMEL CA 93921 - USA
T:831.622.7837 - F:831.624.0364
WWW.STUDIOCARVER.COM

STUDIO CARVER
 ARCHITECTURE + PLANNING + INTERIOR DESIGN




REVISION #	DATE	DESCRIPTION
1	1/08/18	PLAN REVIEW COMMENTS
2	8/6/2020	PLAN 170572 REVISION
5	4/23/2021	BUILDING CORRECTIO NS


**ARCHITECTURAL
PROPOSED
PHASE 2 FLOOR
PLAN**

Scale: 1/4" = 1'-0"
@ 24x36
Drawn By: DP
Job: 1713

A2.1
5/4/2021 4:07:29 PM

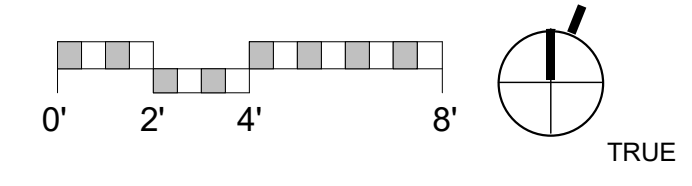


Use of these plans and specifications shall be restricted to the original site for which they were prepared and publication thereof is expressly limited to such use. Reproduction or publication by any method, in whole or in part, is prohibited. Title to the plans and specifications remains with the architect without prejudice. Visual contact with these plans and specifications shall constitute prima facie evidence of the acceptance of these restrictions.

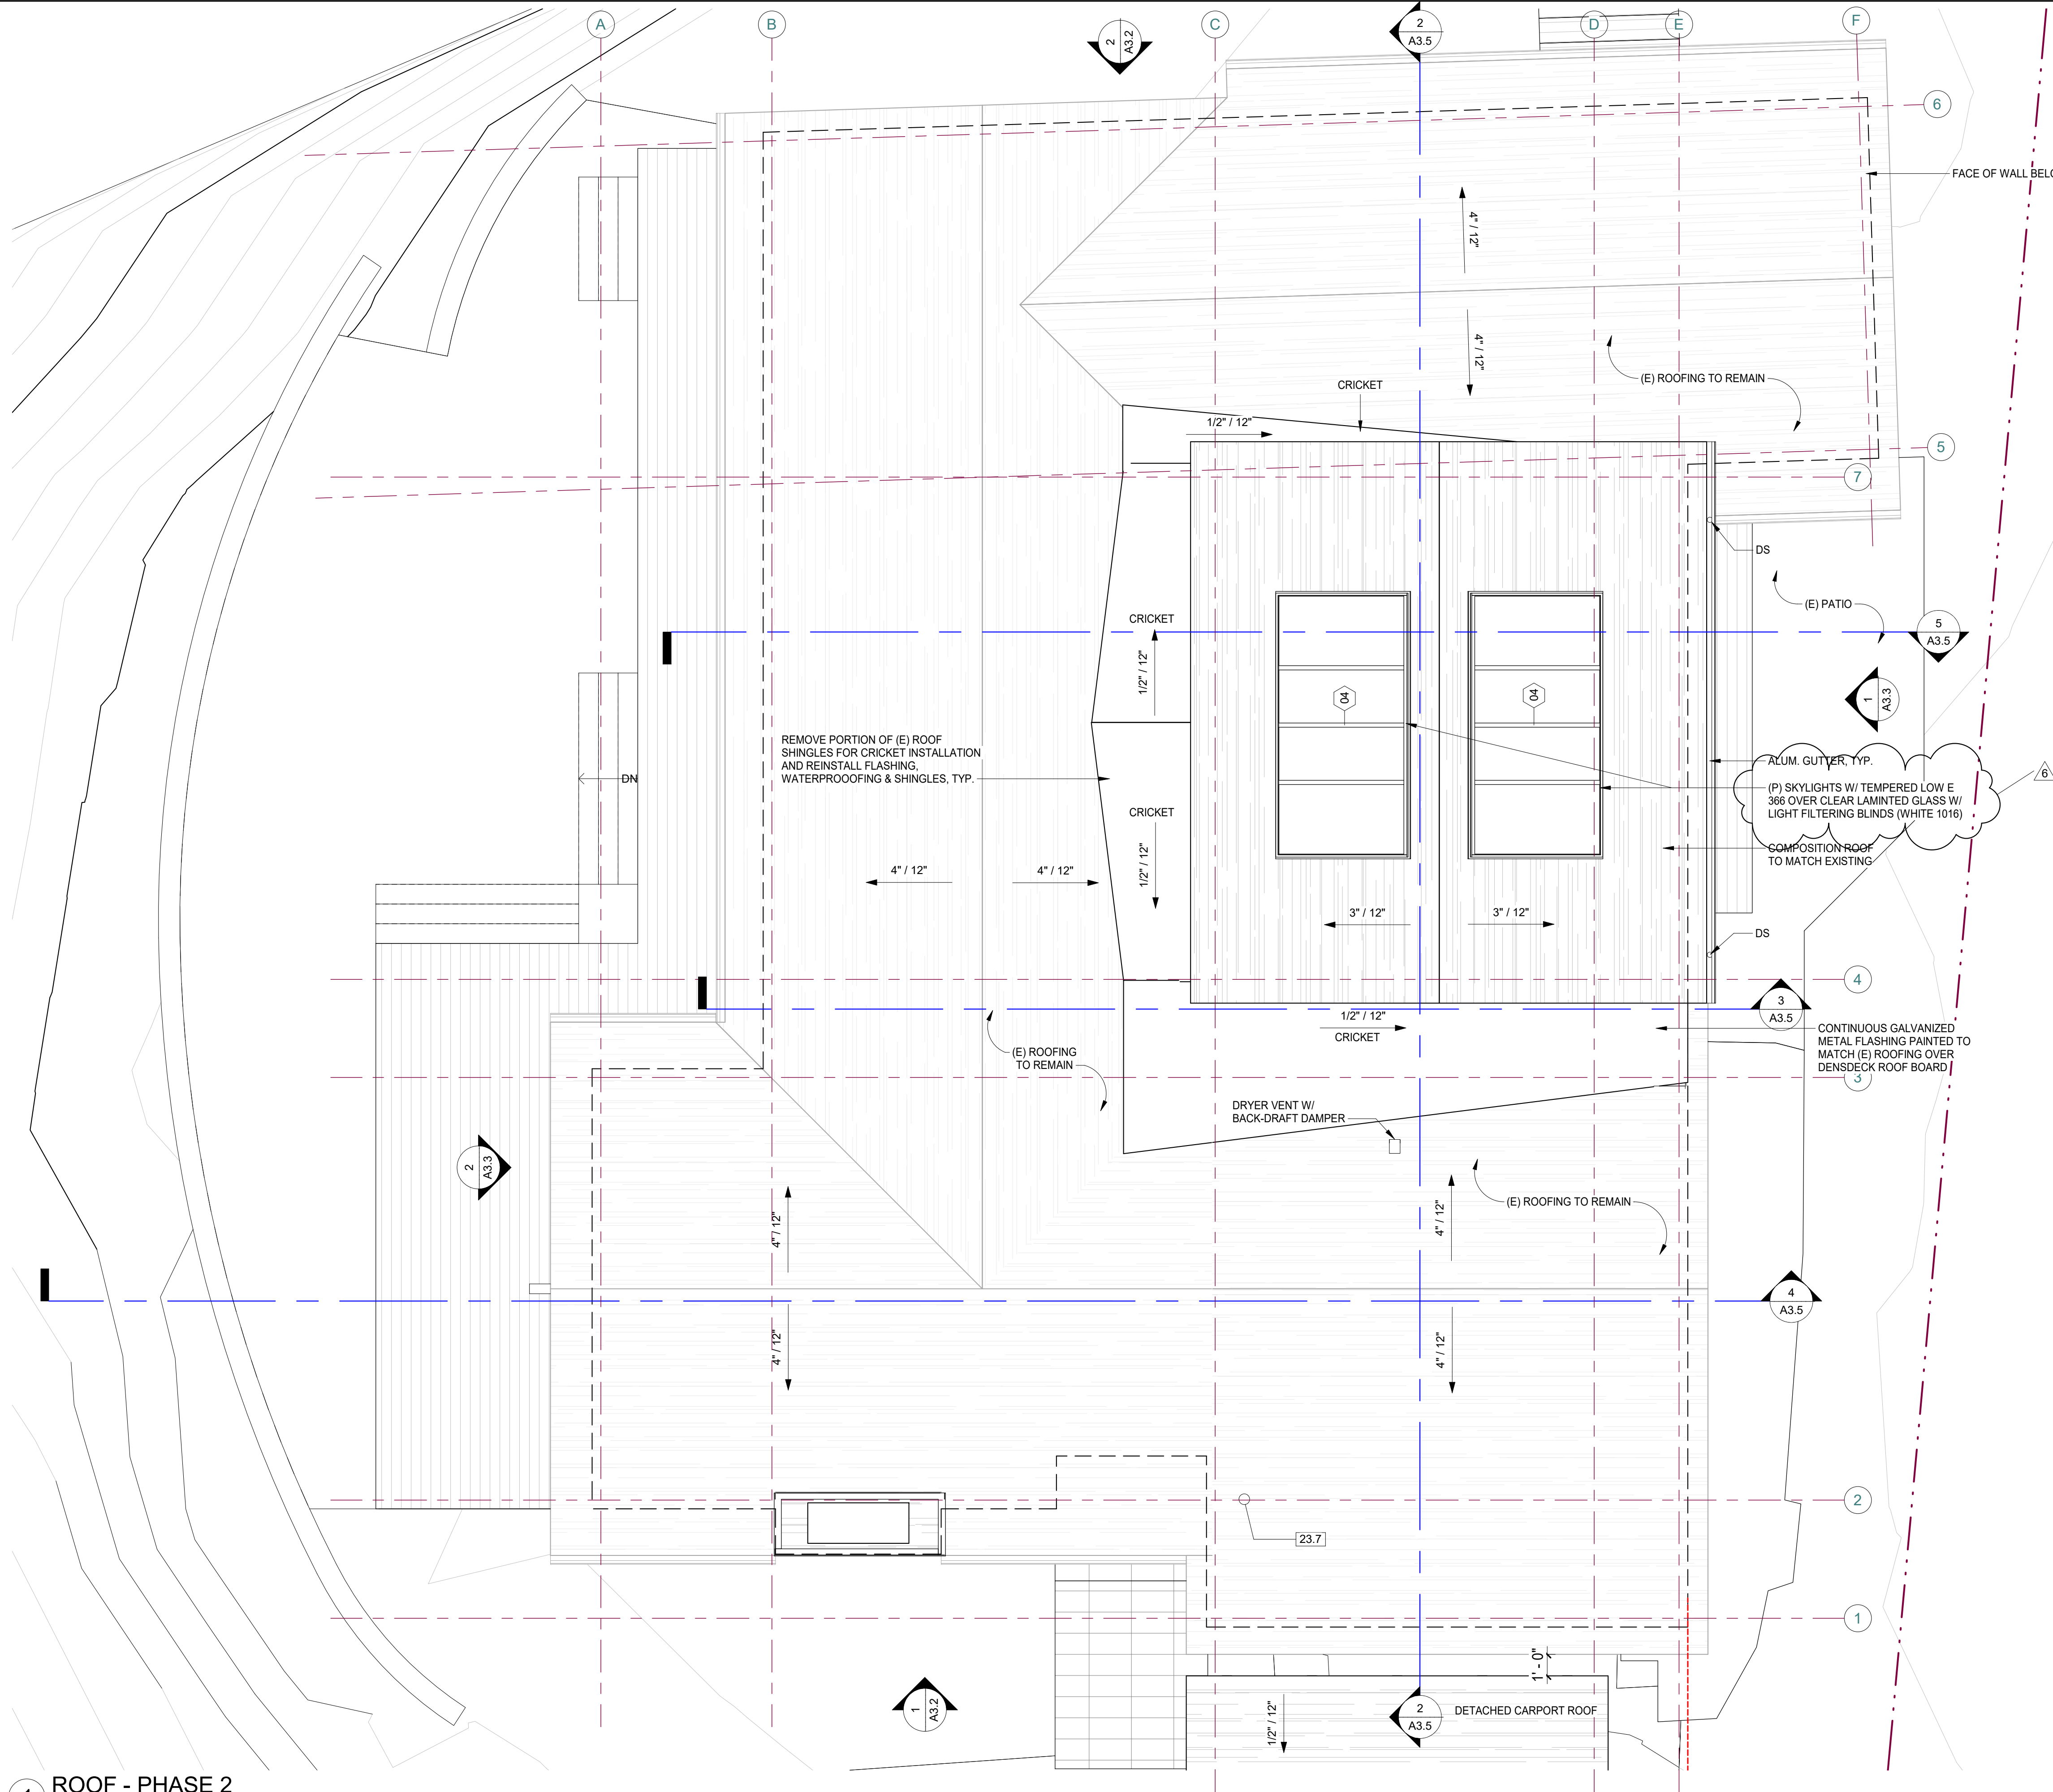

KEYNOTE LEGEND
 23.7 WATER HEATER VENT TERMINATION PER CPC 510.1 & 510.5.2

**SCHWARTZ
 TRYON
 REMODEL**
 24980 OUTLOOK DR.,
 CARMEL, CA 93923

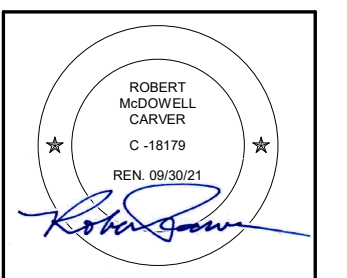

**PLANNING
 DEPARTMENT
 SUBMITTAL**

PO BOX 2884 -
 CARMEL CA 93921 - USA
 T:831.622.7837 - F:831.624.0364
 WWW.STUDIOCARVER.COM

STUDIO CARVER
 ARCHITECTURE + PLANNING + INTERIOR DESIGN




REVISION #	DATE	DESCRIPTION
1	1/08/18	PLAN REVIEW COMMENTS
2	8/6/2020	PLN170572 REVISION
5	4/23/2021	BUILDING CORRECTIO NS
6	5/3/2021	Planning

**ARCHITECTURAL
 PROPOSED
 ROOF PLAN**


Scale: 1/4" = 1'-0"
 @ 24x36
 Drawn By: DP
 Job: 1713

A2.3
 5/4/2021
 5/4/2021 4:07:30 PM


1 ROOF - PHASE 2
 1/4" = 1'-0"

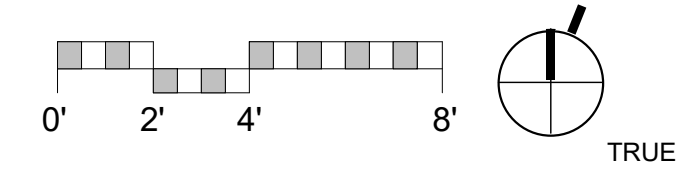

Use of these plans and specifications shall be restricted to the original site for which they were prepared and publication thereof is expressly limited to such use. Reproduction or publication by any method, in whole or in part, is prohibited. Title to the plans and specifications remains with the architect without prejudice. Visual contact with these plans and specifications shall constitute prima facie evidence of the acceptance of these restrictions.

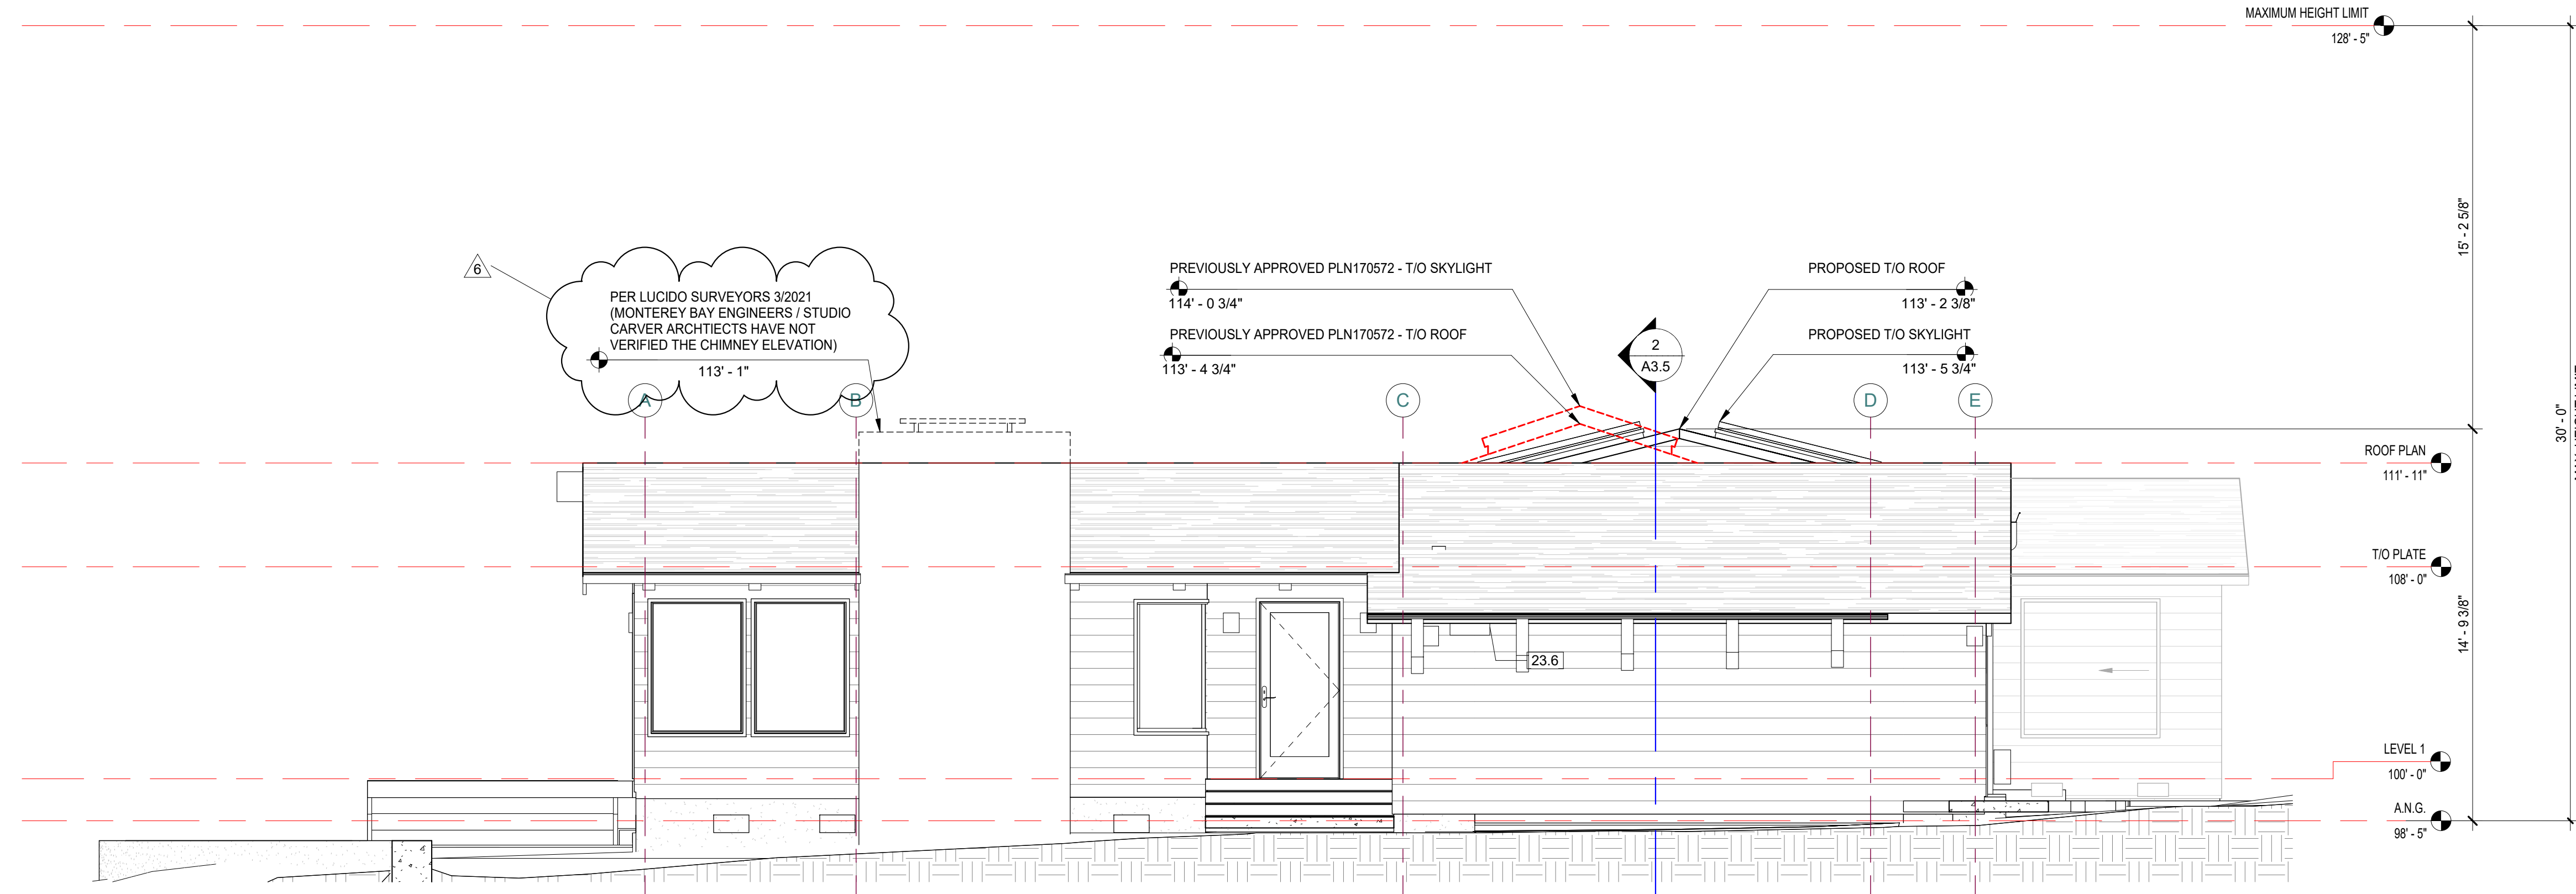


1 PHASE 2 - SOUTH ELEVATION
1/4" = 1'-0"

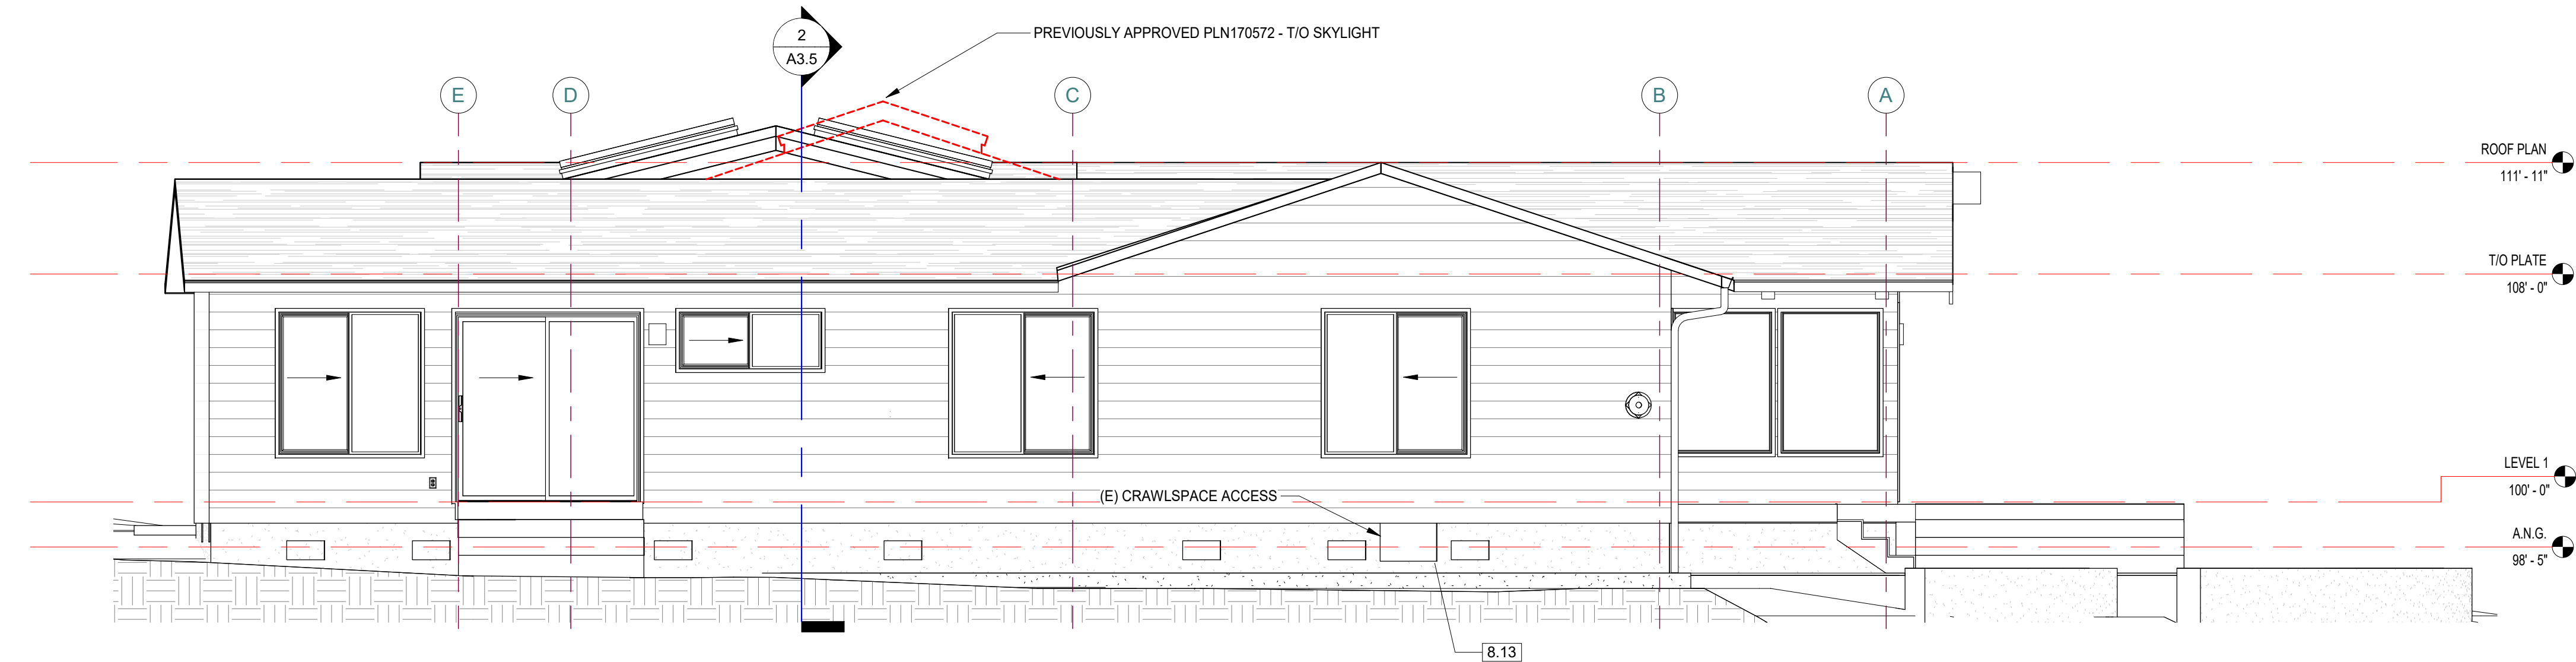

2 PHASE 2 - NORTH ELEVATION
1/4" = 1'-0"


KEYNOTE LEGEND

- 8.13 CRC R408.4 - ACCESS SHALL BE PROVIDED TO ALL UNDER-FLOOR SPACES. ACCESS OPENINGS THROUGH THE FLOOR SHALL BE A MINIMUM OF 18 INCHES BY 24 INCHES.
- 23.6 CMC 701.6 OUTDOOR COMBUSTION AIR - OUTDOOR COMBUSTION AIR SHALL BE PROVIDED THROUGH OPENING(S) TO THE OUTDOORS. THE DIMENSION OF AIR OPENINGS SHALL BE NOT LESS THAN 3 INCHES. 701.6.2 ONE PERMANENT OPENING METHOD - ONE PERMANENT OPENING, COMMENCING WITHIN 12 INCHES OF THE TOP OF THE ENCLOSURE, SHALL BE PROVIDED. THE APPLIANCE SHALL HAVE CLEARANCES OF NOT LESS THAN 1 INCH FROM THE SIDES AND BACK AND 6 INCHES FROM THE FRONT OF THE APPLIANCE. THE OPENING SHALL DIRECTLY COMMUNICATE WITH THE OUTDOORS OR SHALL COMMUNICATE THROUGH A VERTICAL OR HORIZONTAL DUCT TO THE OUTDOORS OR SPACES THAT FREELY COMMUNICATE WITH THE OUTDOORS AND SHALL HAVE A FREE AREA NOT LESS THAN THE FOLLOWING: ONE SQUARE INCH PER 3000 BTU/H / NOT LESS THAN THE SUM OF THE AREAS OF VENT CONNECTORS IN THE SPACE.

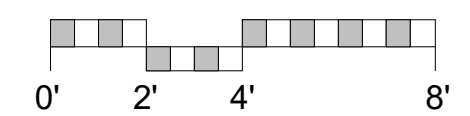

**SCHWARTZ
TRYON
REMODEL**


24980 OUTLOOK DR.,
CARMEL, CA 93923

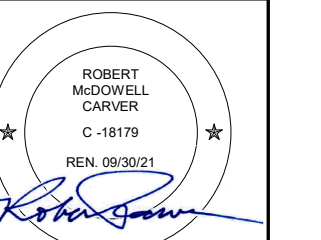

**PLANNING
DEPARTMENT
SUBMITTAL**

PO BOX 2884 -
CARMEL CA 93921 - USA
T:831.622.7837 - F:831.624.0364
WWW.STUDIOCARVER.COM

STUDIO CARVER
ARCHITECTURE + PLANNING + INTERIOR DESIGN

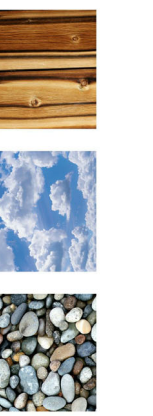

REVISION #

REVISION #	DATE	DESCRIPTION
1	1/08/18	PLAN REVIEW COMMENTS
2	8/6/2020	PLN170572 REVISION
5	4/23/2021	BUILDING CORRECTIO NS
6	5/3/2021	Planning


**ARCHITECTURAL
EXTERIOR
ELEVATIONS**

Scale: 1/4" = 1'-0"
@ 24x36
Drawn By: DP
Job: 1713

A3.2


5/4/2021 4:07:31 PM

Use of these plans and specifications shall be restricted to the original site for which they were prepared and publication thereof is expressly limited to such use. Reproduction or publication in whole or in part is prohibited. Title to the plans and specifications remains with the architect without prejudice. Visual contact with these plans and specifications shall constitute prima facie evidence of the acceptance of these restrictions.

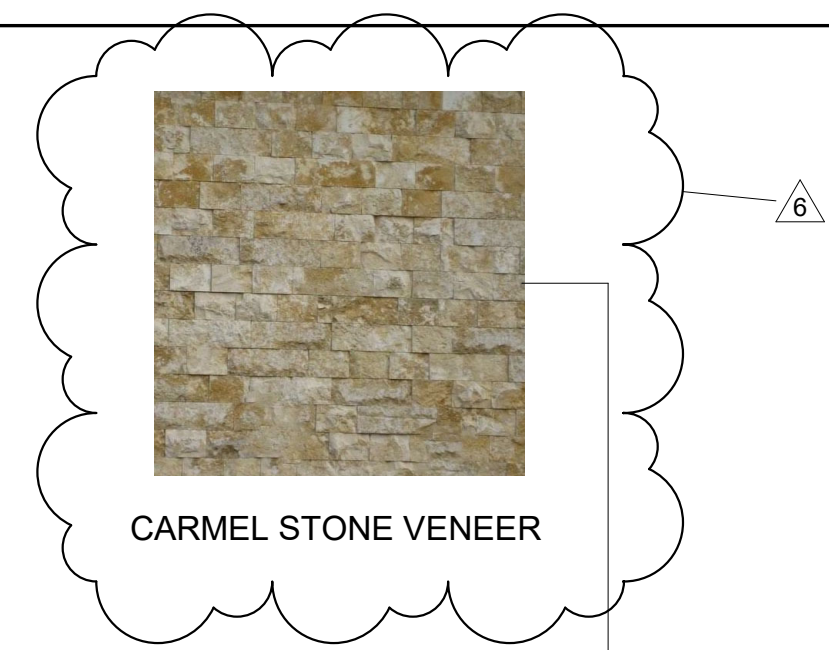


KEYNOTE LEGEND


8.12 CRC R408.2 - THE MINIMUM NET AREA OF VENTILATION OPENINGS SHALL BE NOT LESS THAN 1 SQUARE FOOT FOR EACH 150 SQUARE FEET OF UNDER-FLOOR AREA. ONE VENTILATION OPENING SHALL BE WITHIN 3 FEET OF EACH CORNER OF THE BUILDING. VENTILATION OPENINGS SHALL BE COVERED FOR THEIR HEIGHT AND WIDTH WITH ANY OF THE FOLLOWING MATERIALS PROVIDED THAT THE LEAST DIMENSION OF THE COVERING SHALL NOT EXCEED 1/4 INCH.

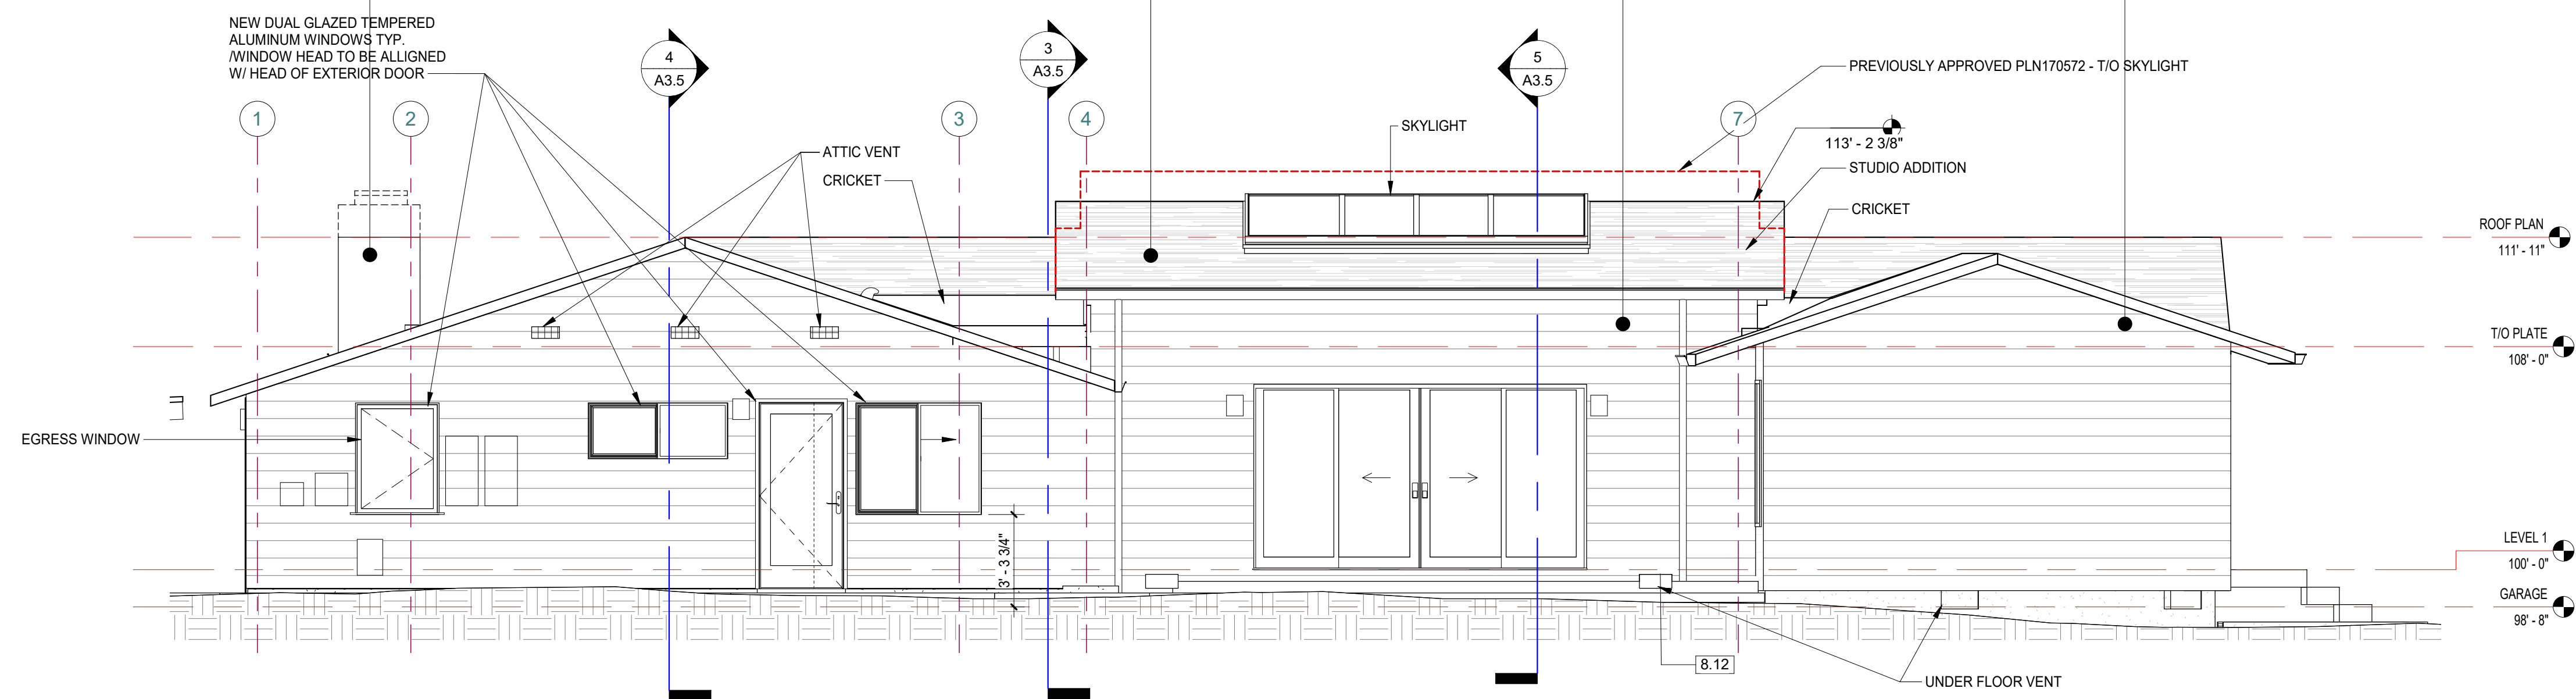

1 PHASE 2 - EAST ELEVATION
1/4" = 1'-0"

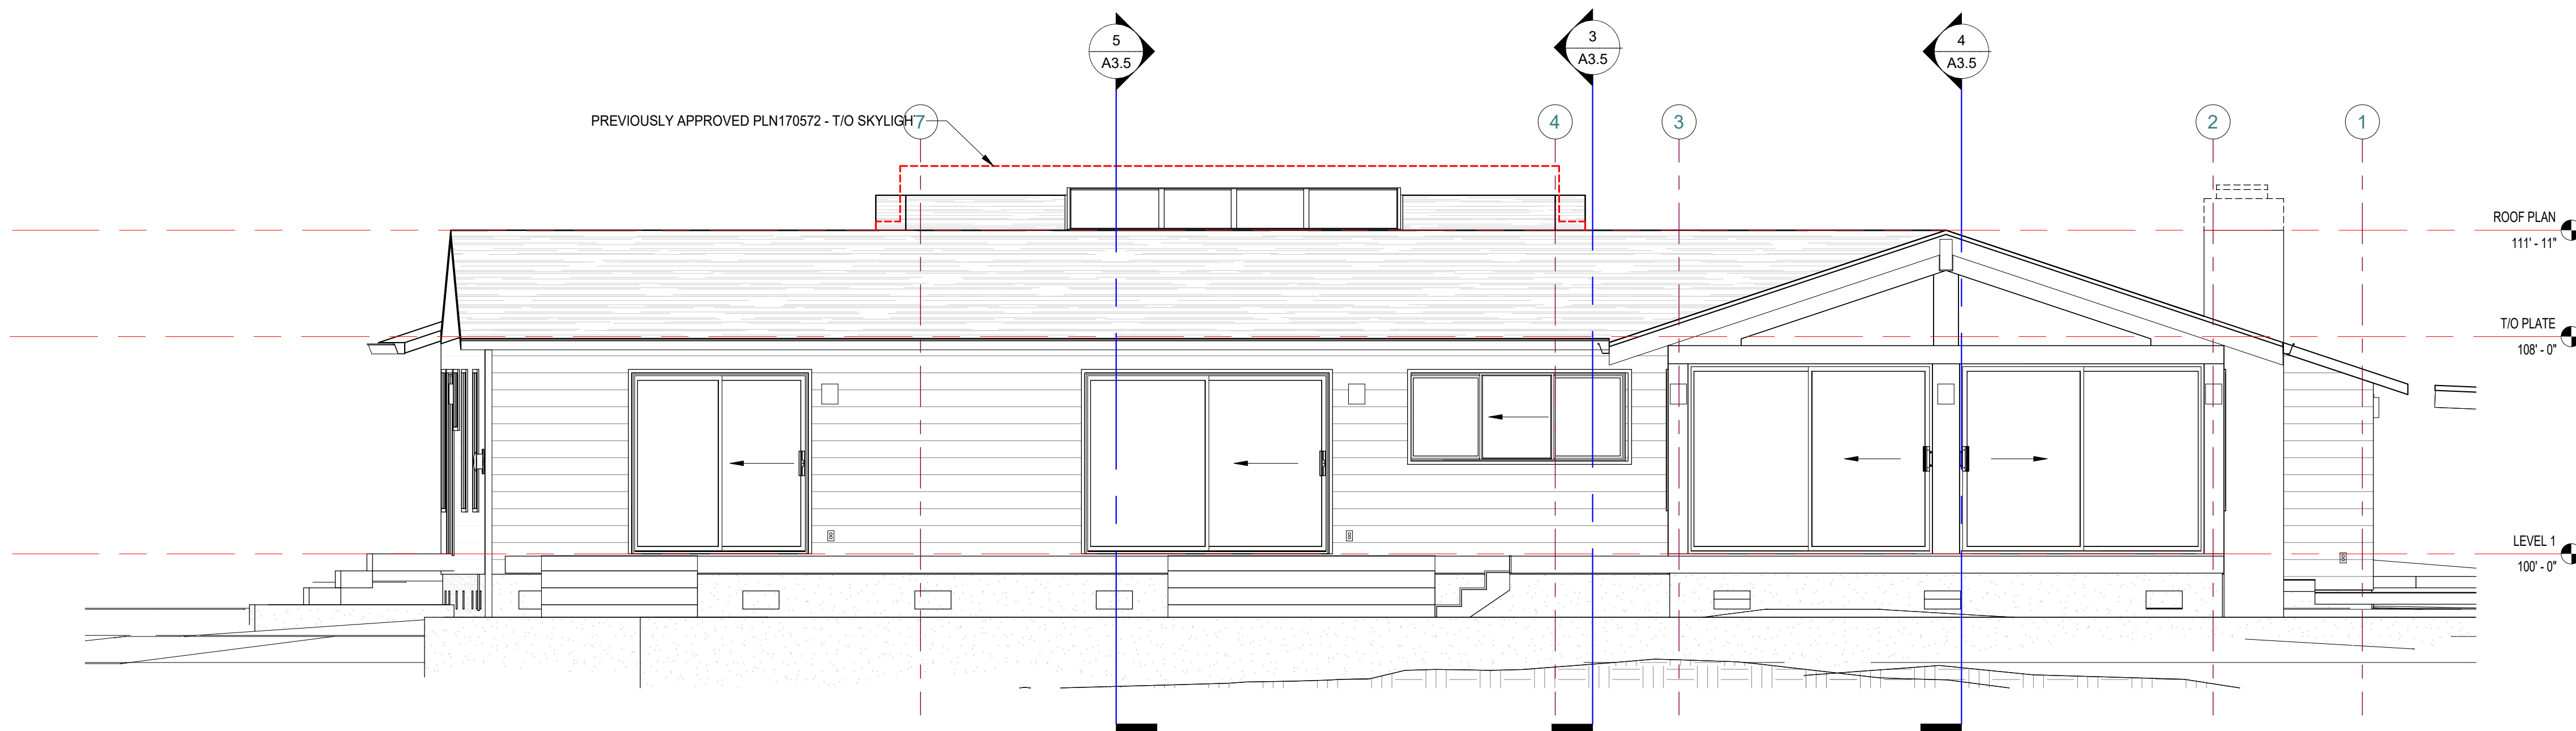


2 PHASE 2 - WEST ELEVATION
1/4" = 1'-0"

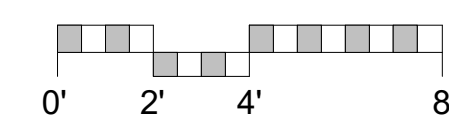

**SCHWARTZ
TRYON
REMODEL**


24980 OUTLOOK DR.,
CARMEL, CA 93923

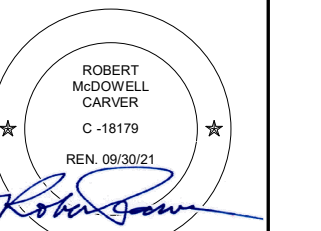

**PLANNING
DEPARTMENT
SUBMITTAL**

PO BOX 2884
CARMEL CA 93921 - USA
T:831.622.7837 F:831.624.0384
WWW.STUDIOCARVER.COM

STUDIO CARVER
ARCHITECTURE + PLANNING + INTERIOR DESIGN

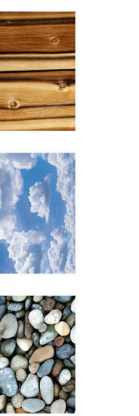




REVISION #	DATE	PLAN REVIEW COMMENTS
1	1/08/18	PLAN REVIEW COMMENTS
2	8/8/2020	PLN170572 REVISION
3	3/24/2021	Revision 3
6	5/3/2021	Planning

**ARCHITECTURAL
EXTERIOR
ELEVATIONS**

Scale: 1/4" = 1'-0"
@ 24x36
Drawn By: DP
Job: 1713

A3.3
5/4/2021


Use of these plans and specifications shall be restricted to the original site for which they were prepared and publication thereof is expressly limited to such use. Reproduction or publication by any method, in whole or in part, is prohibited. Title to the plans and specifications remains with the architect without prejudice. Visual contact with these plans and specifications shall constitute prima facie evidence of the acceptance of these restrictions.

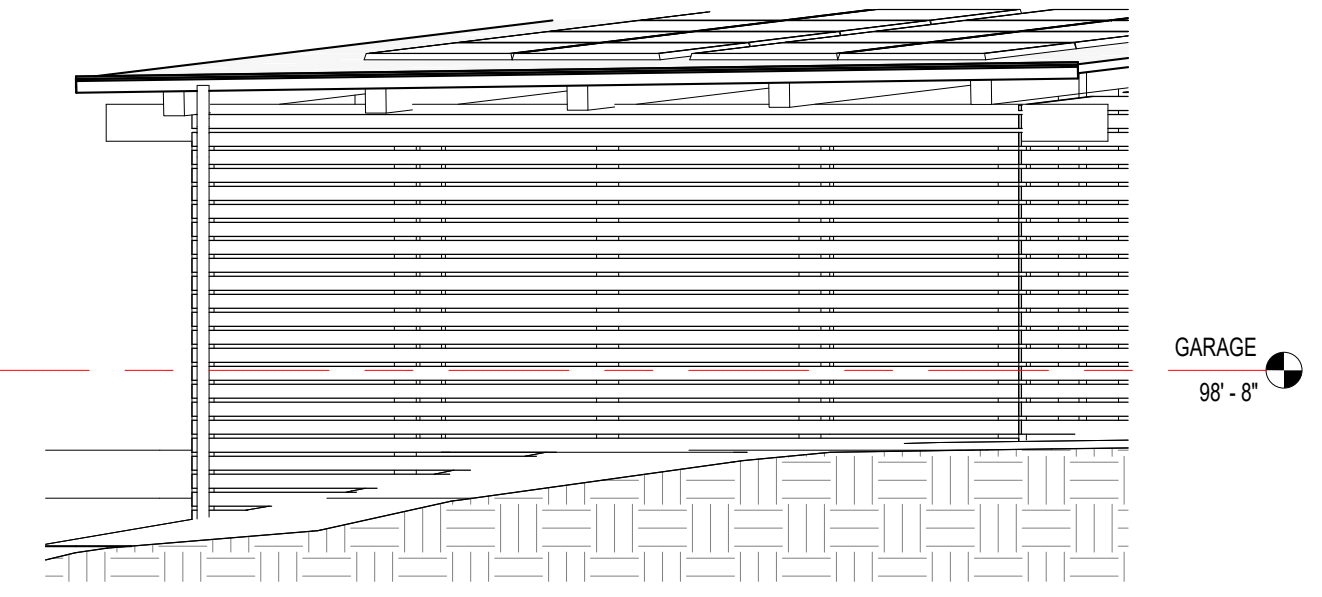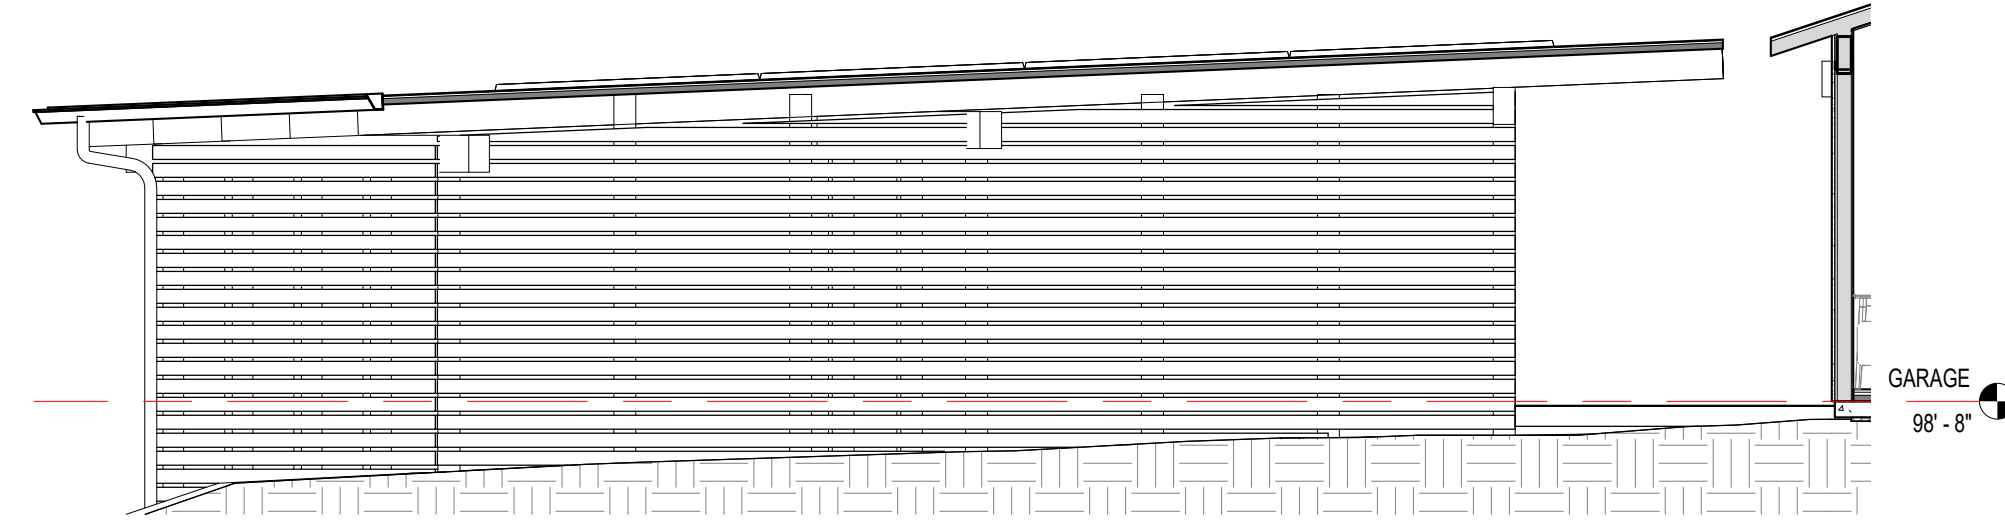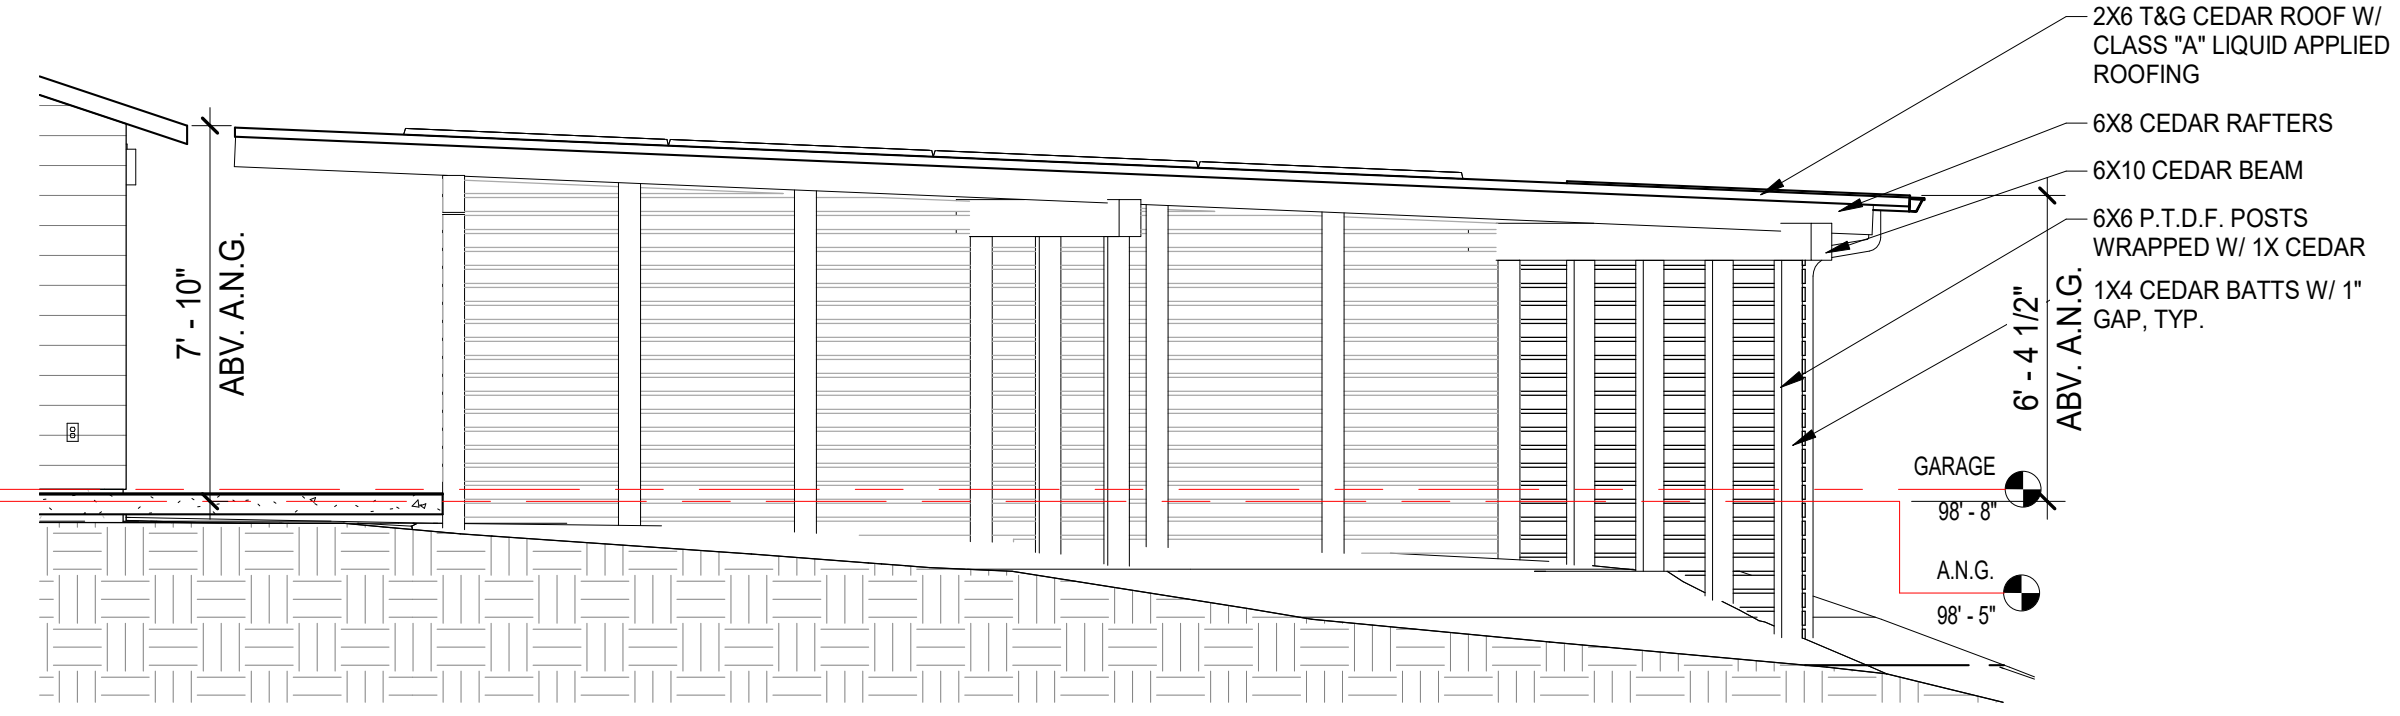


1 CARPORT - WEST
1/4" = 1'-0"

2 CARPORT - EAST
1/4" = 1'-0"


3 CARPORT - SOUTH
1/4" = 1'-0"

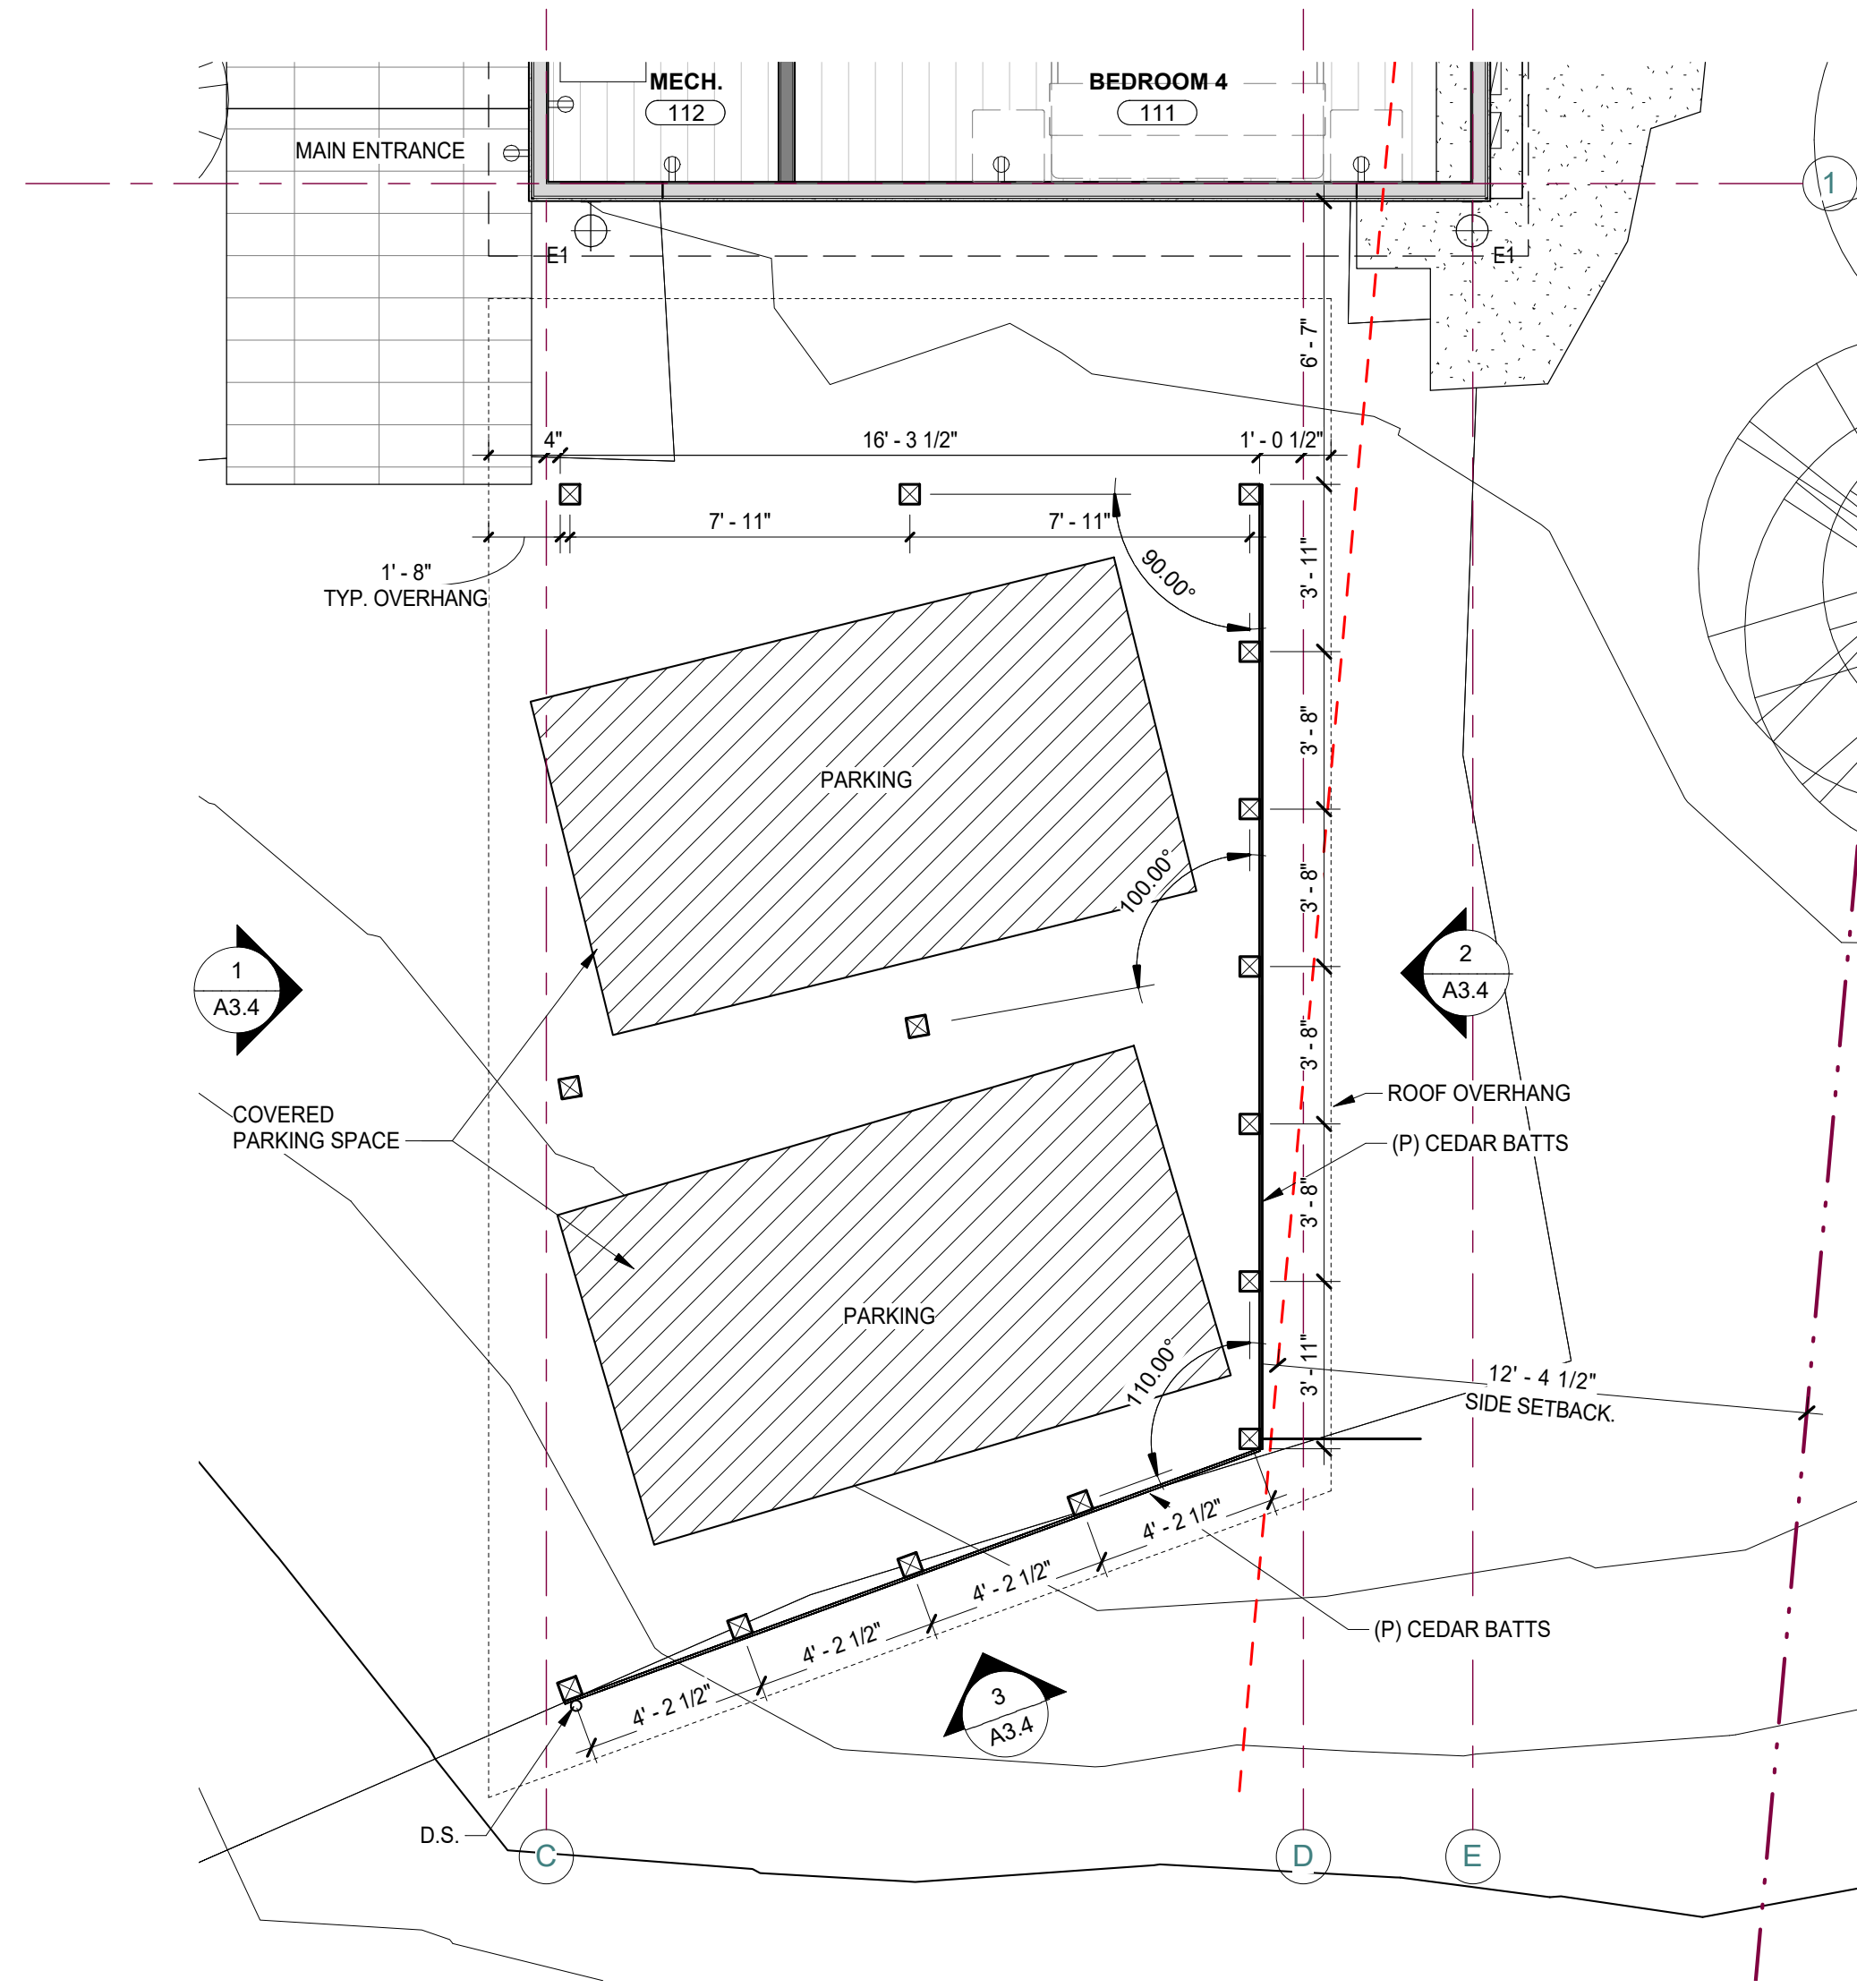

4 CARPORT FLOOR PLAN
1/4" = 1'-0"

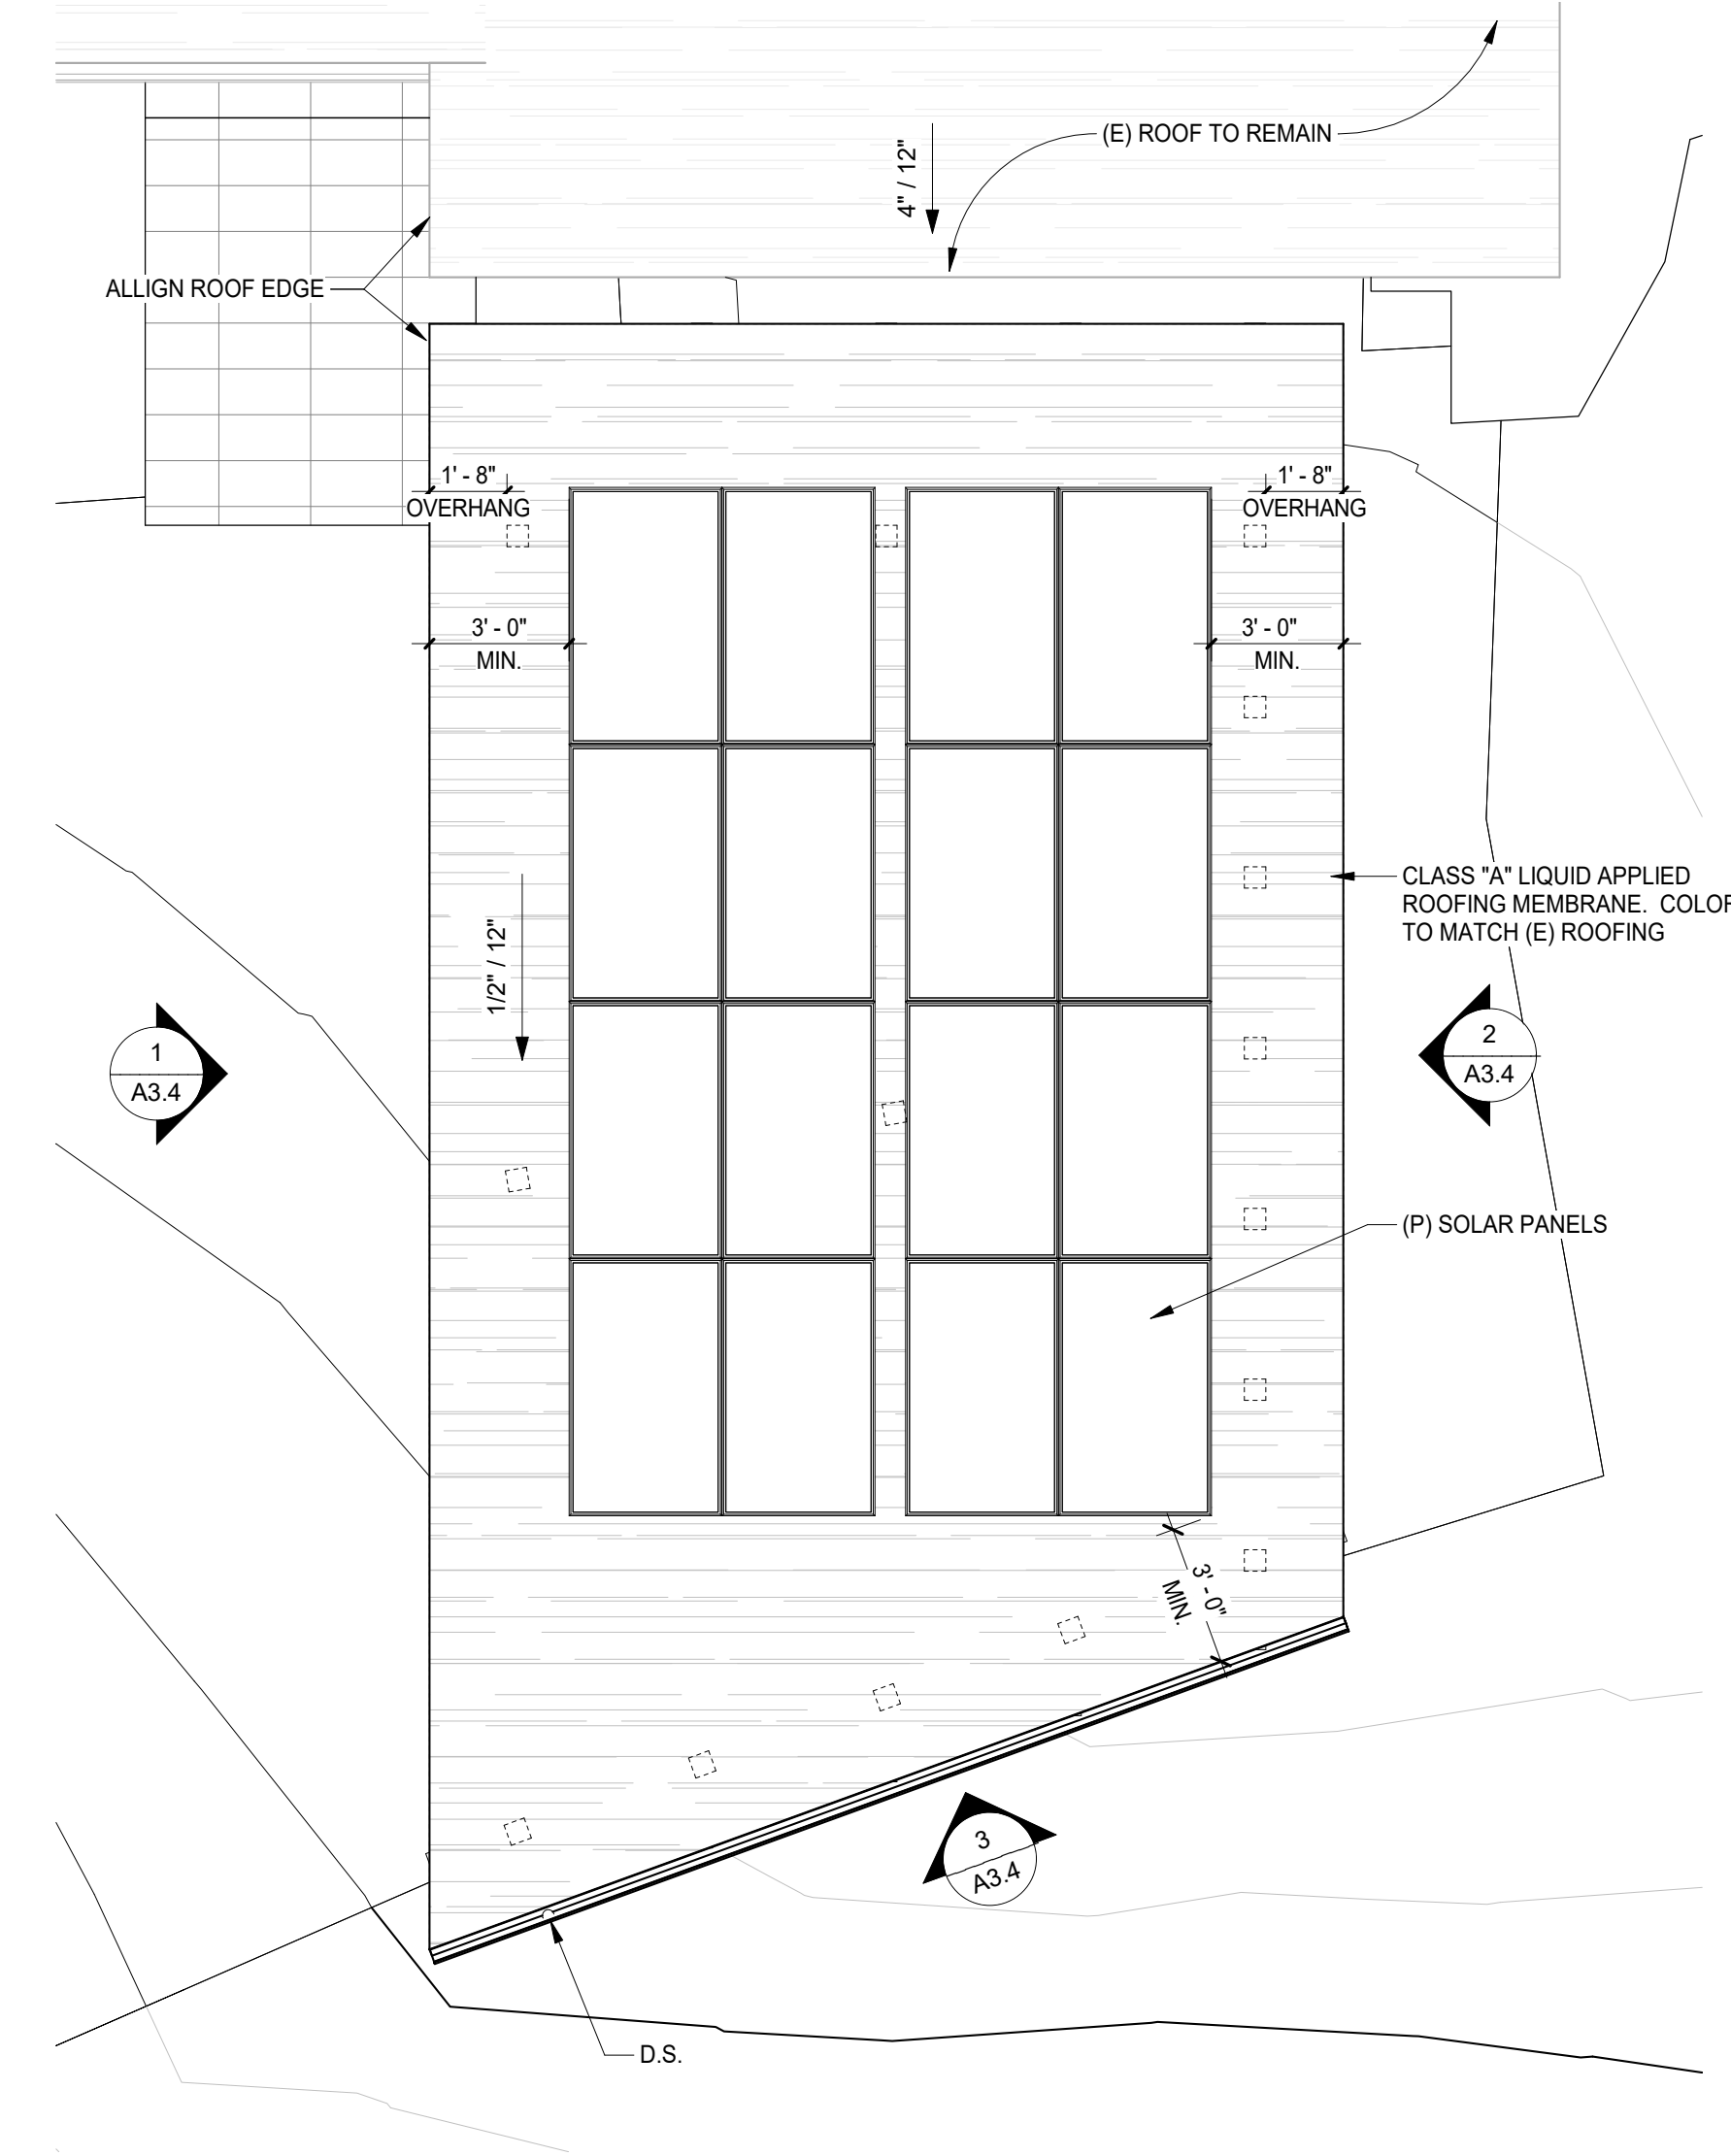


5 CARPORT ROOF
1/4" = 1'-0"

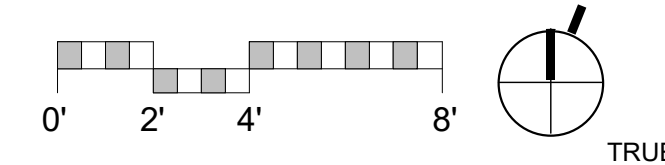

SCHWARTZ TRYON REMODEL


24980 OUTLOOK DR., CARMEL, CA 93923

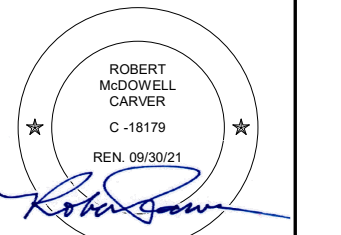

PLANNING DEPARTMENT SUBMITTAL

PO BOX 2884
CARMEL CA 93921 - USA
T:831.622.7837 - F:831.624.0364
WWW.STUDIOCARVER.COM

STUDIO CARVER
ARCHITECTURE + PLANNING + INTERIOR DESIGN

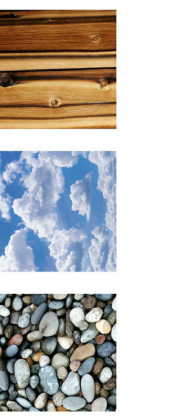



REVISION #	DATE	DESCRIPTION
2	8/5/2020	PLN170572 REVISION

ARCHITECTURAL CARPORT PLAN & ELEVATIONS





Scale: 1/4" = 1'-0"
@ 24x36
Drawn By: DP
Job: 1713

A3.4
5/4/2021 4:07:33 PM


Use of these plans and specifications shall be restricted to the original site for which they were prepared and publication thereof is expressly limited to such use. Reproduction or publication by any method, in whole or in part, is prohibited. Title to the plans and specifications remains with the architect without prejudice. Visual contact with these plans and specifications shall constitute prima facie evidence of the acceptance of these restrictions.

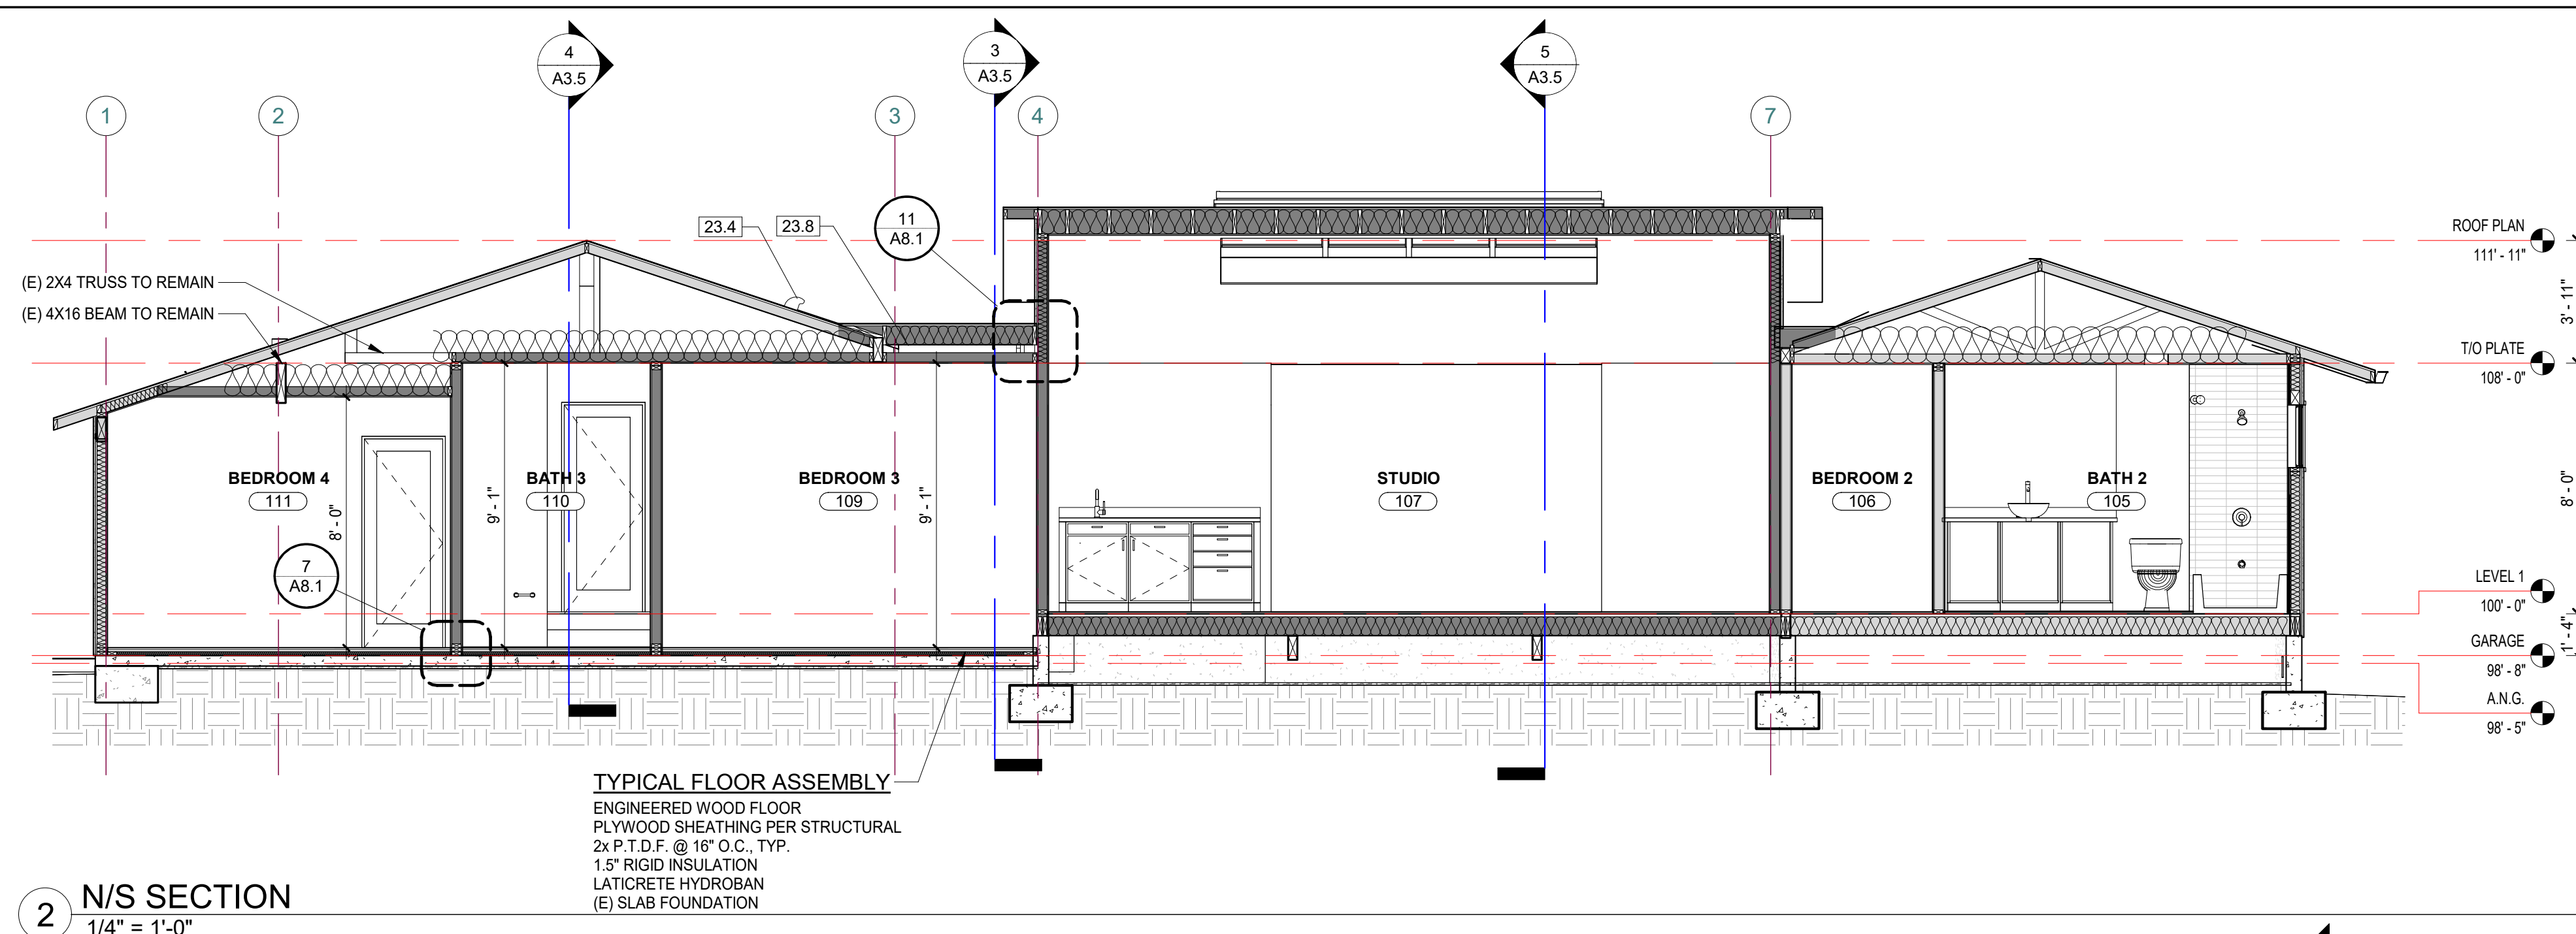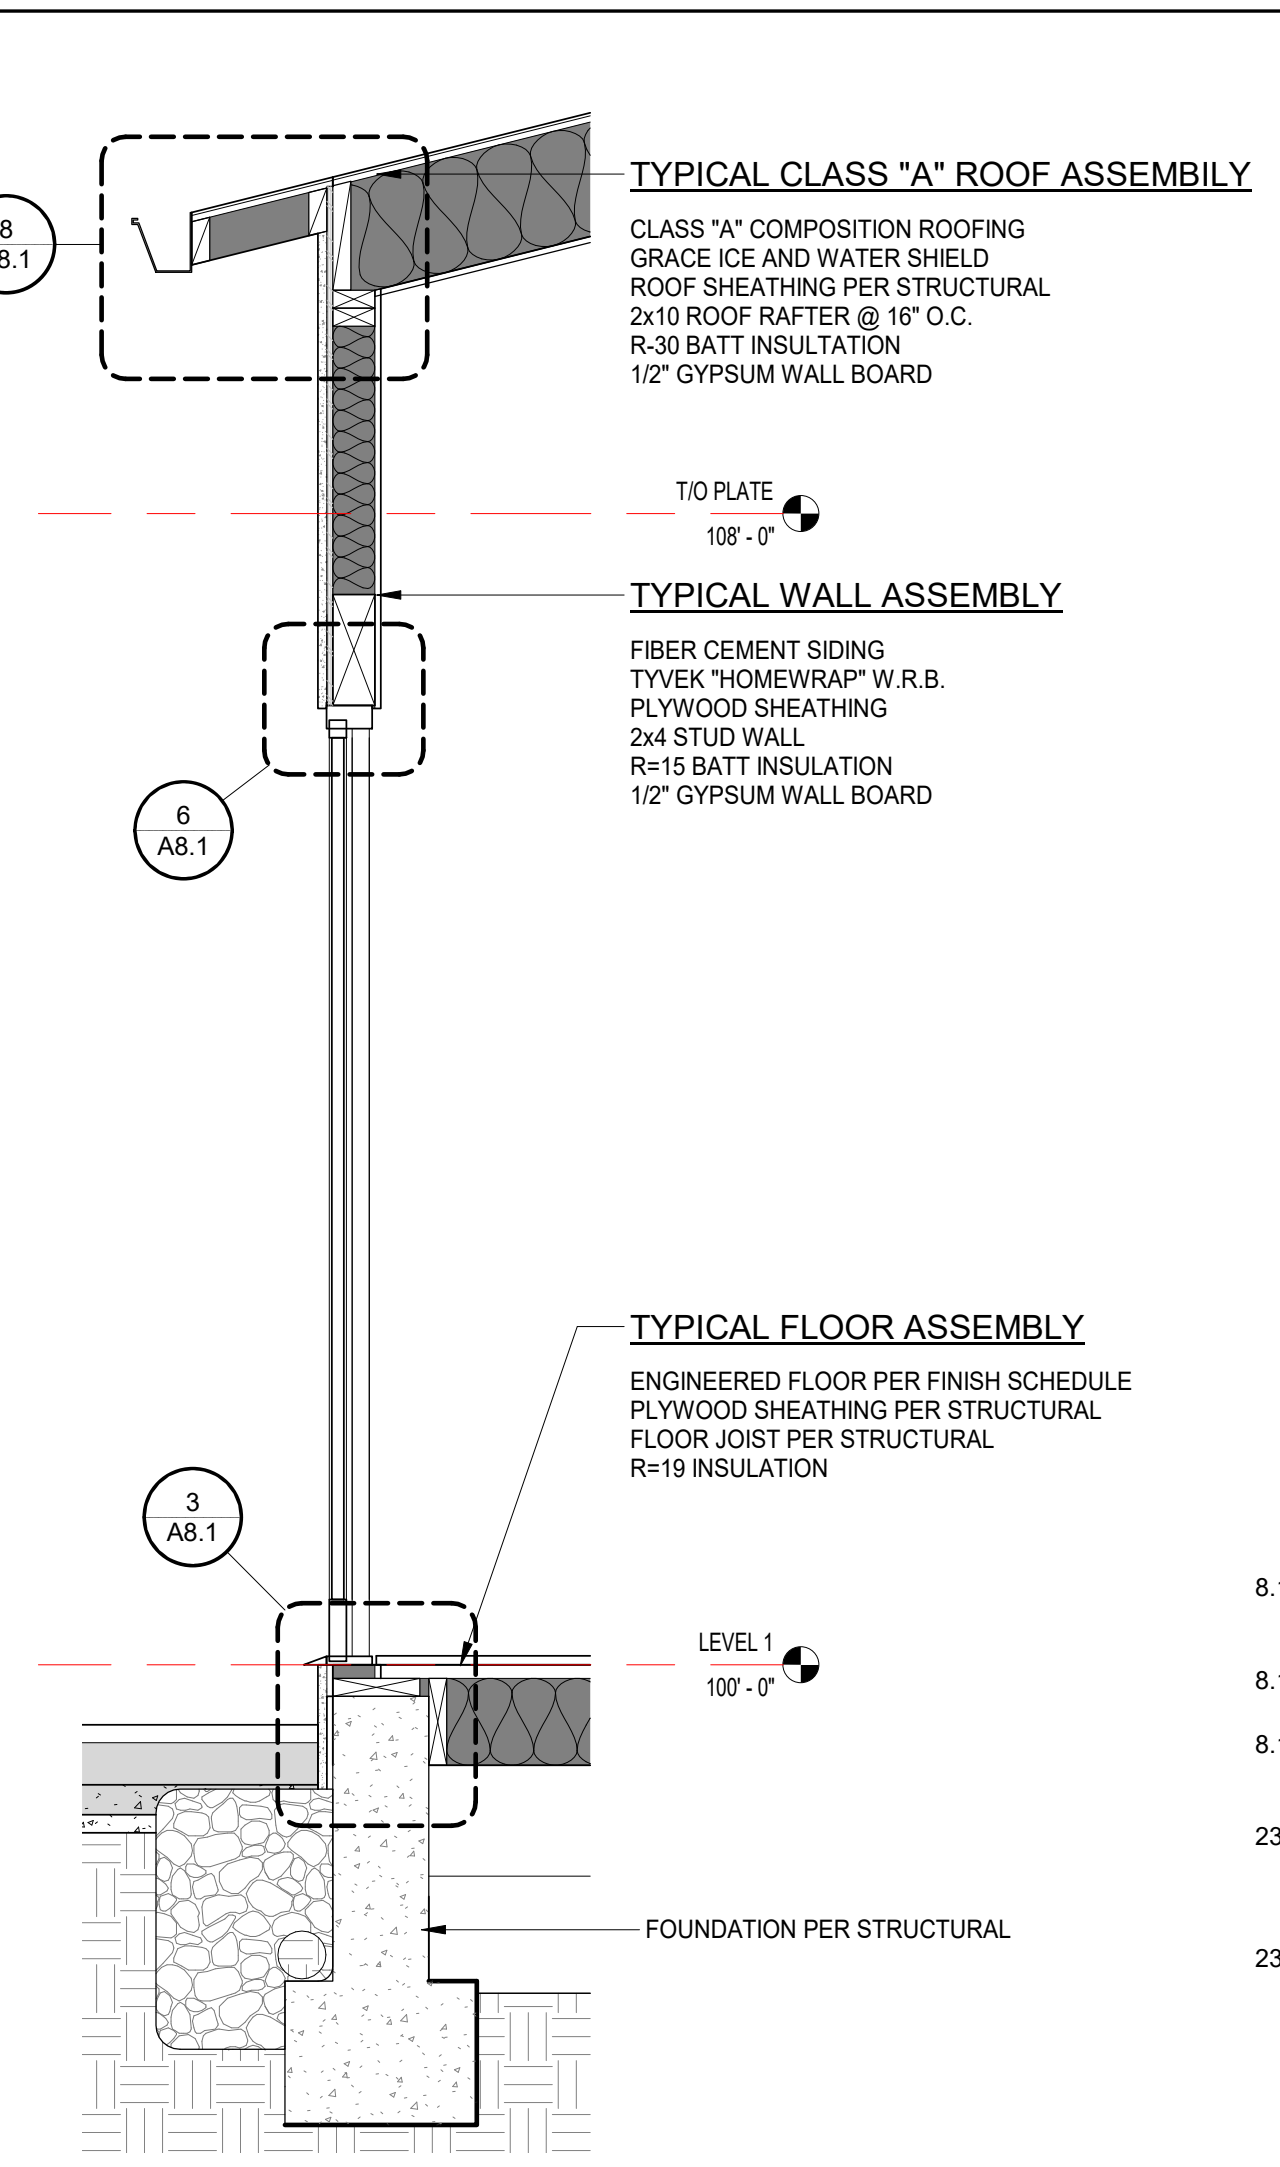

- KEYNOTE LEGEND**
- 8.11 CBC 2304.12.1.1 WOOD JOISTS OR WOOD STRUCTURAL FLOORS THAT ARE CLOSER THAN 18 INCHES OR WOOD GIRDERS THAT ARE CLOSER THAN 12 INCHES TO THE EXPOSED GROUND IN CRAWL SPACES OR UNEXCAVATED AREAS LOCATED WITHIN THE PERIMETER OF THE BUILDING FOUNDATION SHALL BE OF NATURALLY DURABLE OR PRESERVATIVE-TREATED WOOD.
 - 8.13 CRC R408.4 - ACCESS SHALL BE PROVIDED TO ALL UNDER-FLOOR SPACES. ACCESS OPENINGS THROUGH THE FLOOR SHALL BE A MINIMUM OF 18 INCHES BY 24 INCHES.
 - 8.14 CRC R408.3 - CONTINUOUSLY OPERATED MECHANICAL EXHAUST VENTILATION AT A RATE EQUAL TO 1 CUBIC FOOT PER MINUTE (0.47 L/S) FOR EACH 50 SQUARE FEET (4.7 M2) OF CRAWL SPACE FLOOR AREA, INCLUDING AN AIR PATHWAY TO THE COMMON AREA (SUCH AS A DUCT OR TRANSFER GRILLE).
 - 23.4 CMC 504.4 CLOTHES DRYERS. CLOTHES DRYER MOISTURE EXHAUST DUCTS SHALL TERMINATE OUTSIDE THE BUILDING AND HAVE A BACK-DRAFT DAMPER. EXHAUST DUCT IS LIMITED TO 14' WITH TWO ELBOWS, THIS SHALL BE REDUCED BY 2' FOR EVERY ELBOW MORE THAN TWO. DUCTS SHALL BE MINIMUM 4" DIAMETER, SMOOTH, AND METAL. CMC 504.4.1 - MAKEUP AIR SHALL BE PROVIDED FOR TYPE 1 CLOTHES DRYERS IN ACCORDANCE WITH THE MANUFACTURER'S INSTRUCTIONS.
 - 23.8 CRC R806.1 VENTILATION REQUIRED - ENCLOSED ATTICS AND ENCLOSED RAFTER SPACES FORMED WHERE CEILINGS ARE APPLIED DIRECTLY TO THE UNDERSIDE OF ROOF RAFTERS SHALL HAVE CROSS VENTILATION FOR EACH SEPARATE SPACE BY VENTILATING OPENINGS PROTECTED AGAINST THE ENTRANCE OF RAIN OR SNOW. VENTILATION OPENINGS SHALL HAVE A LEAST DIMENSION OF 1/16 INCH MINIMUM AND 1/4 INCH MAXIMUM. CRC R806.2 MINIMUM VENT AREA - THE MINIMUM NET FREE VENTILATING AREA SHALL BE 1/150 OF THE AREA OF THE VENTED SPACE.

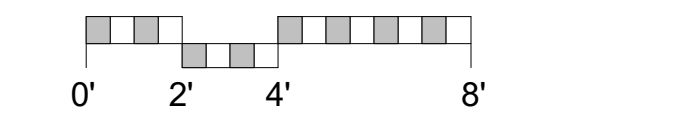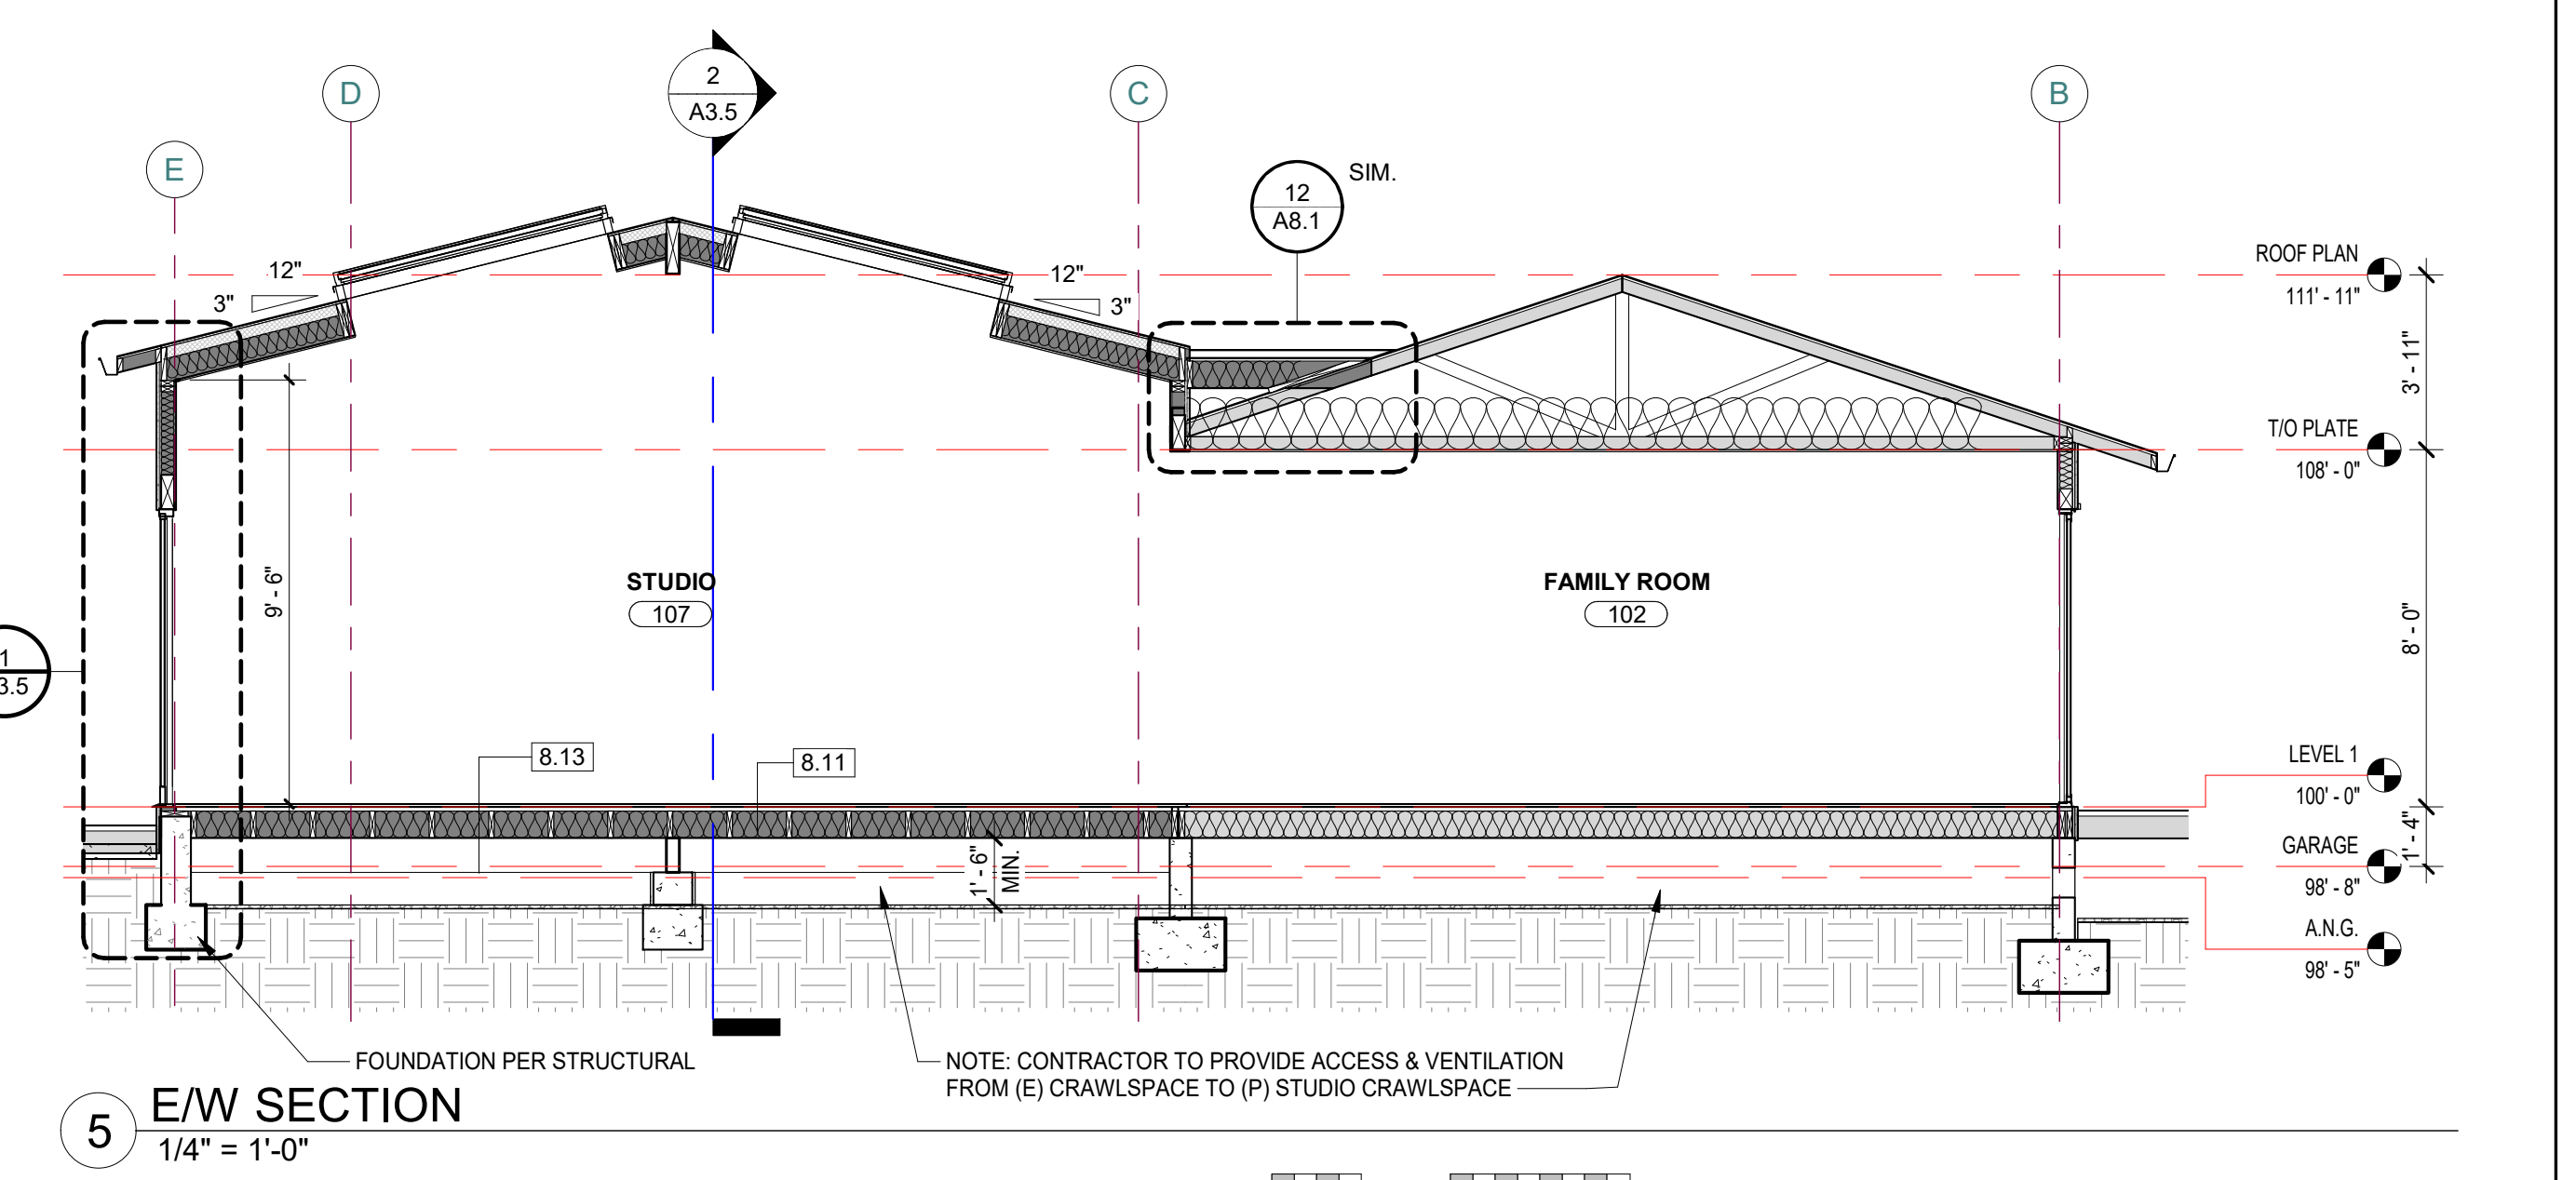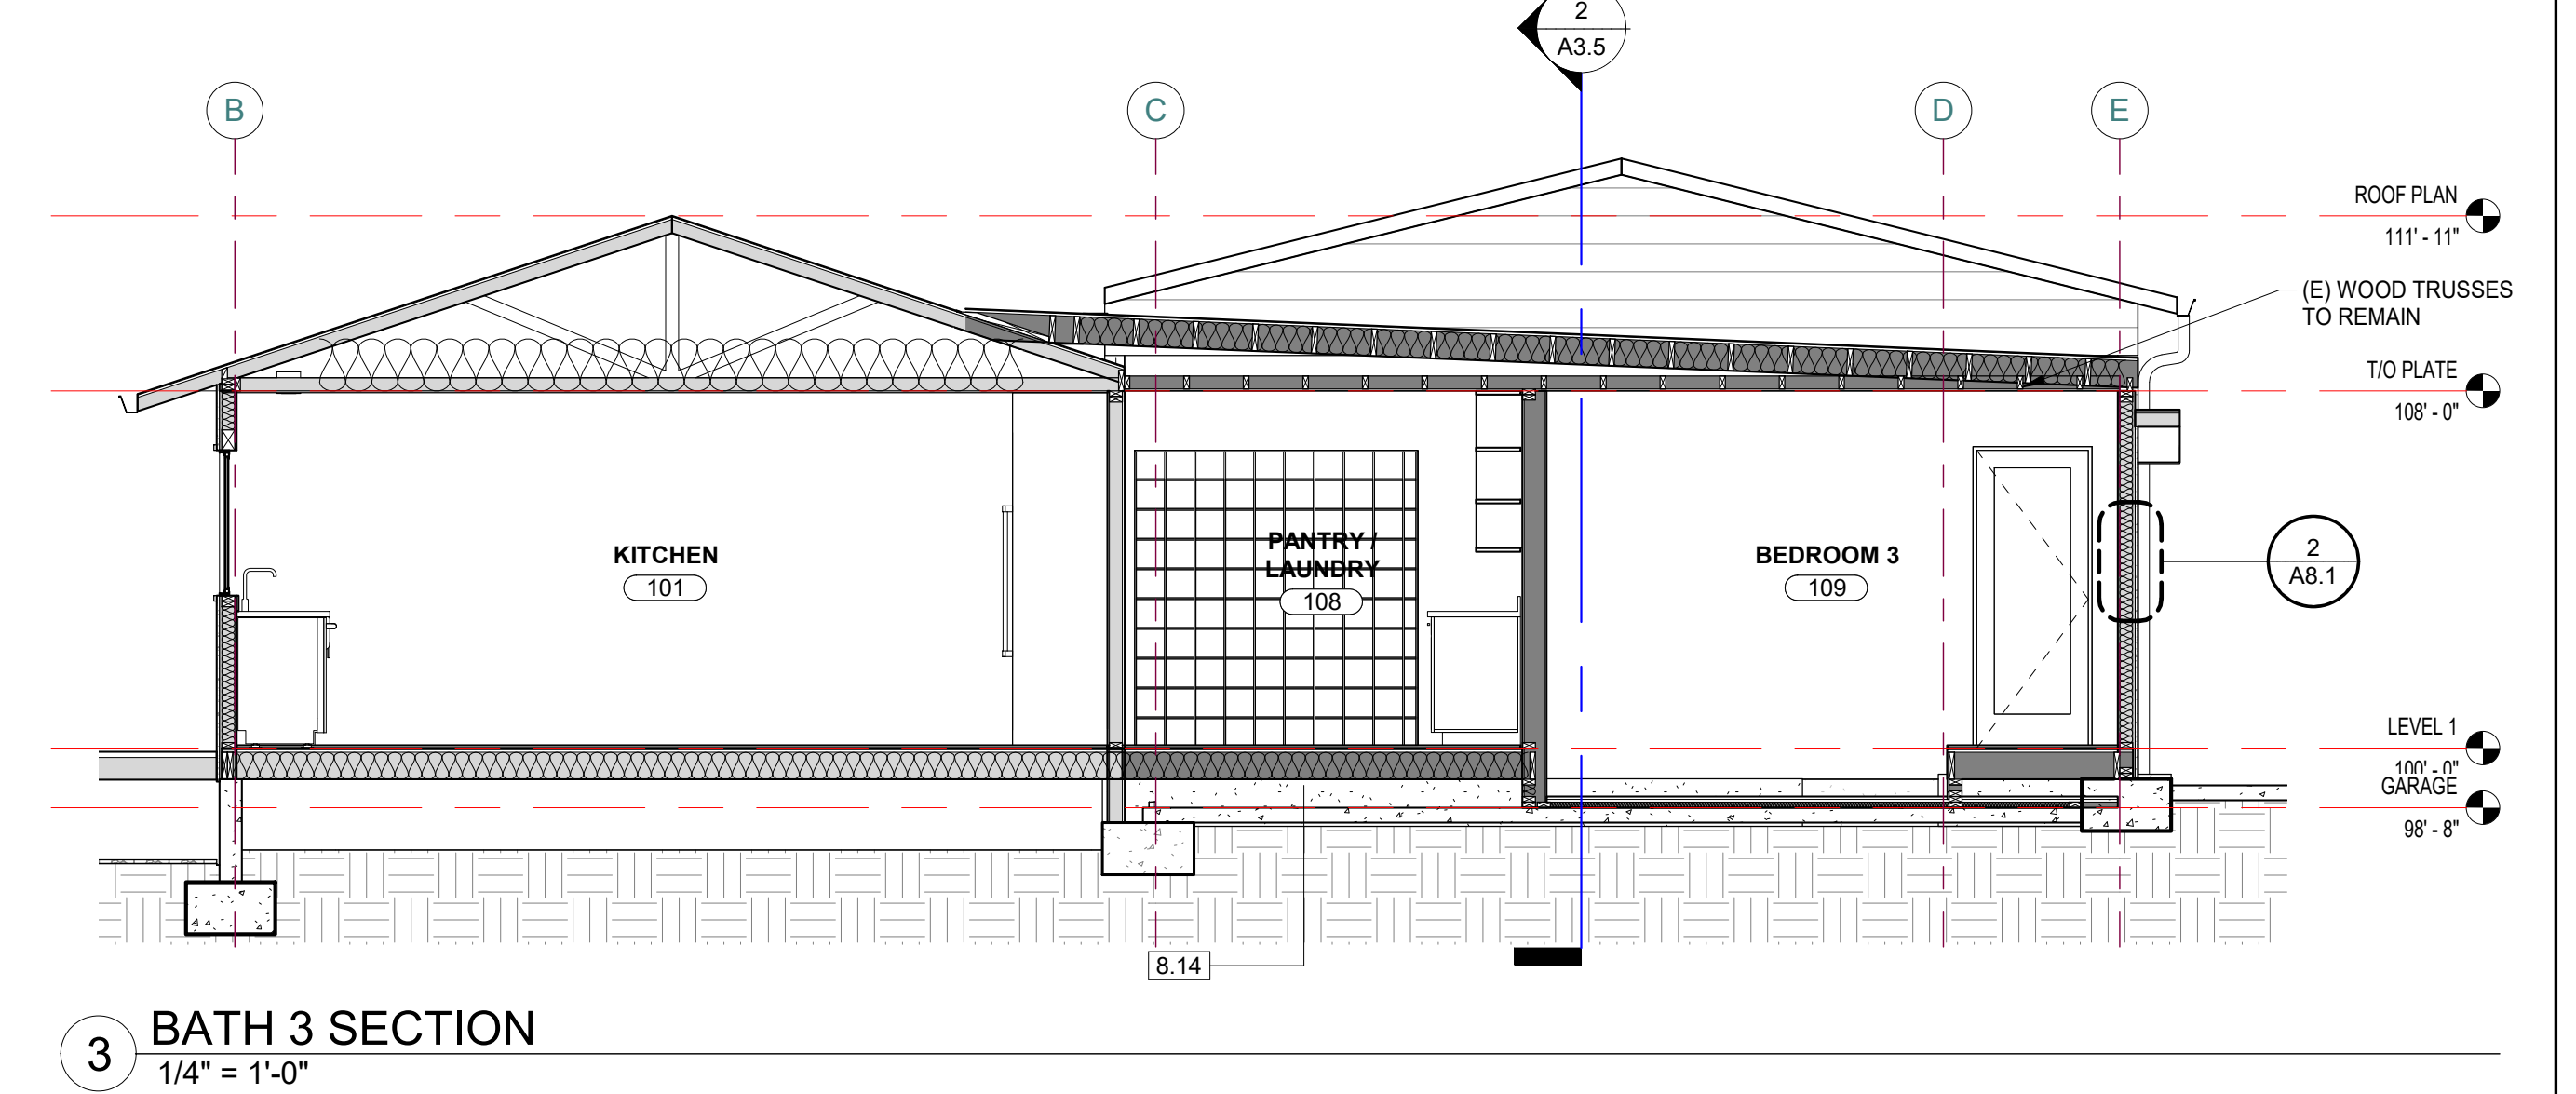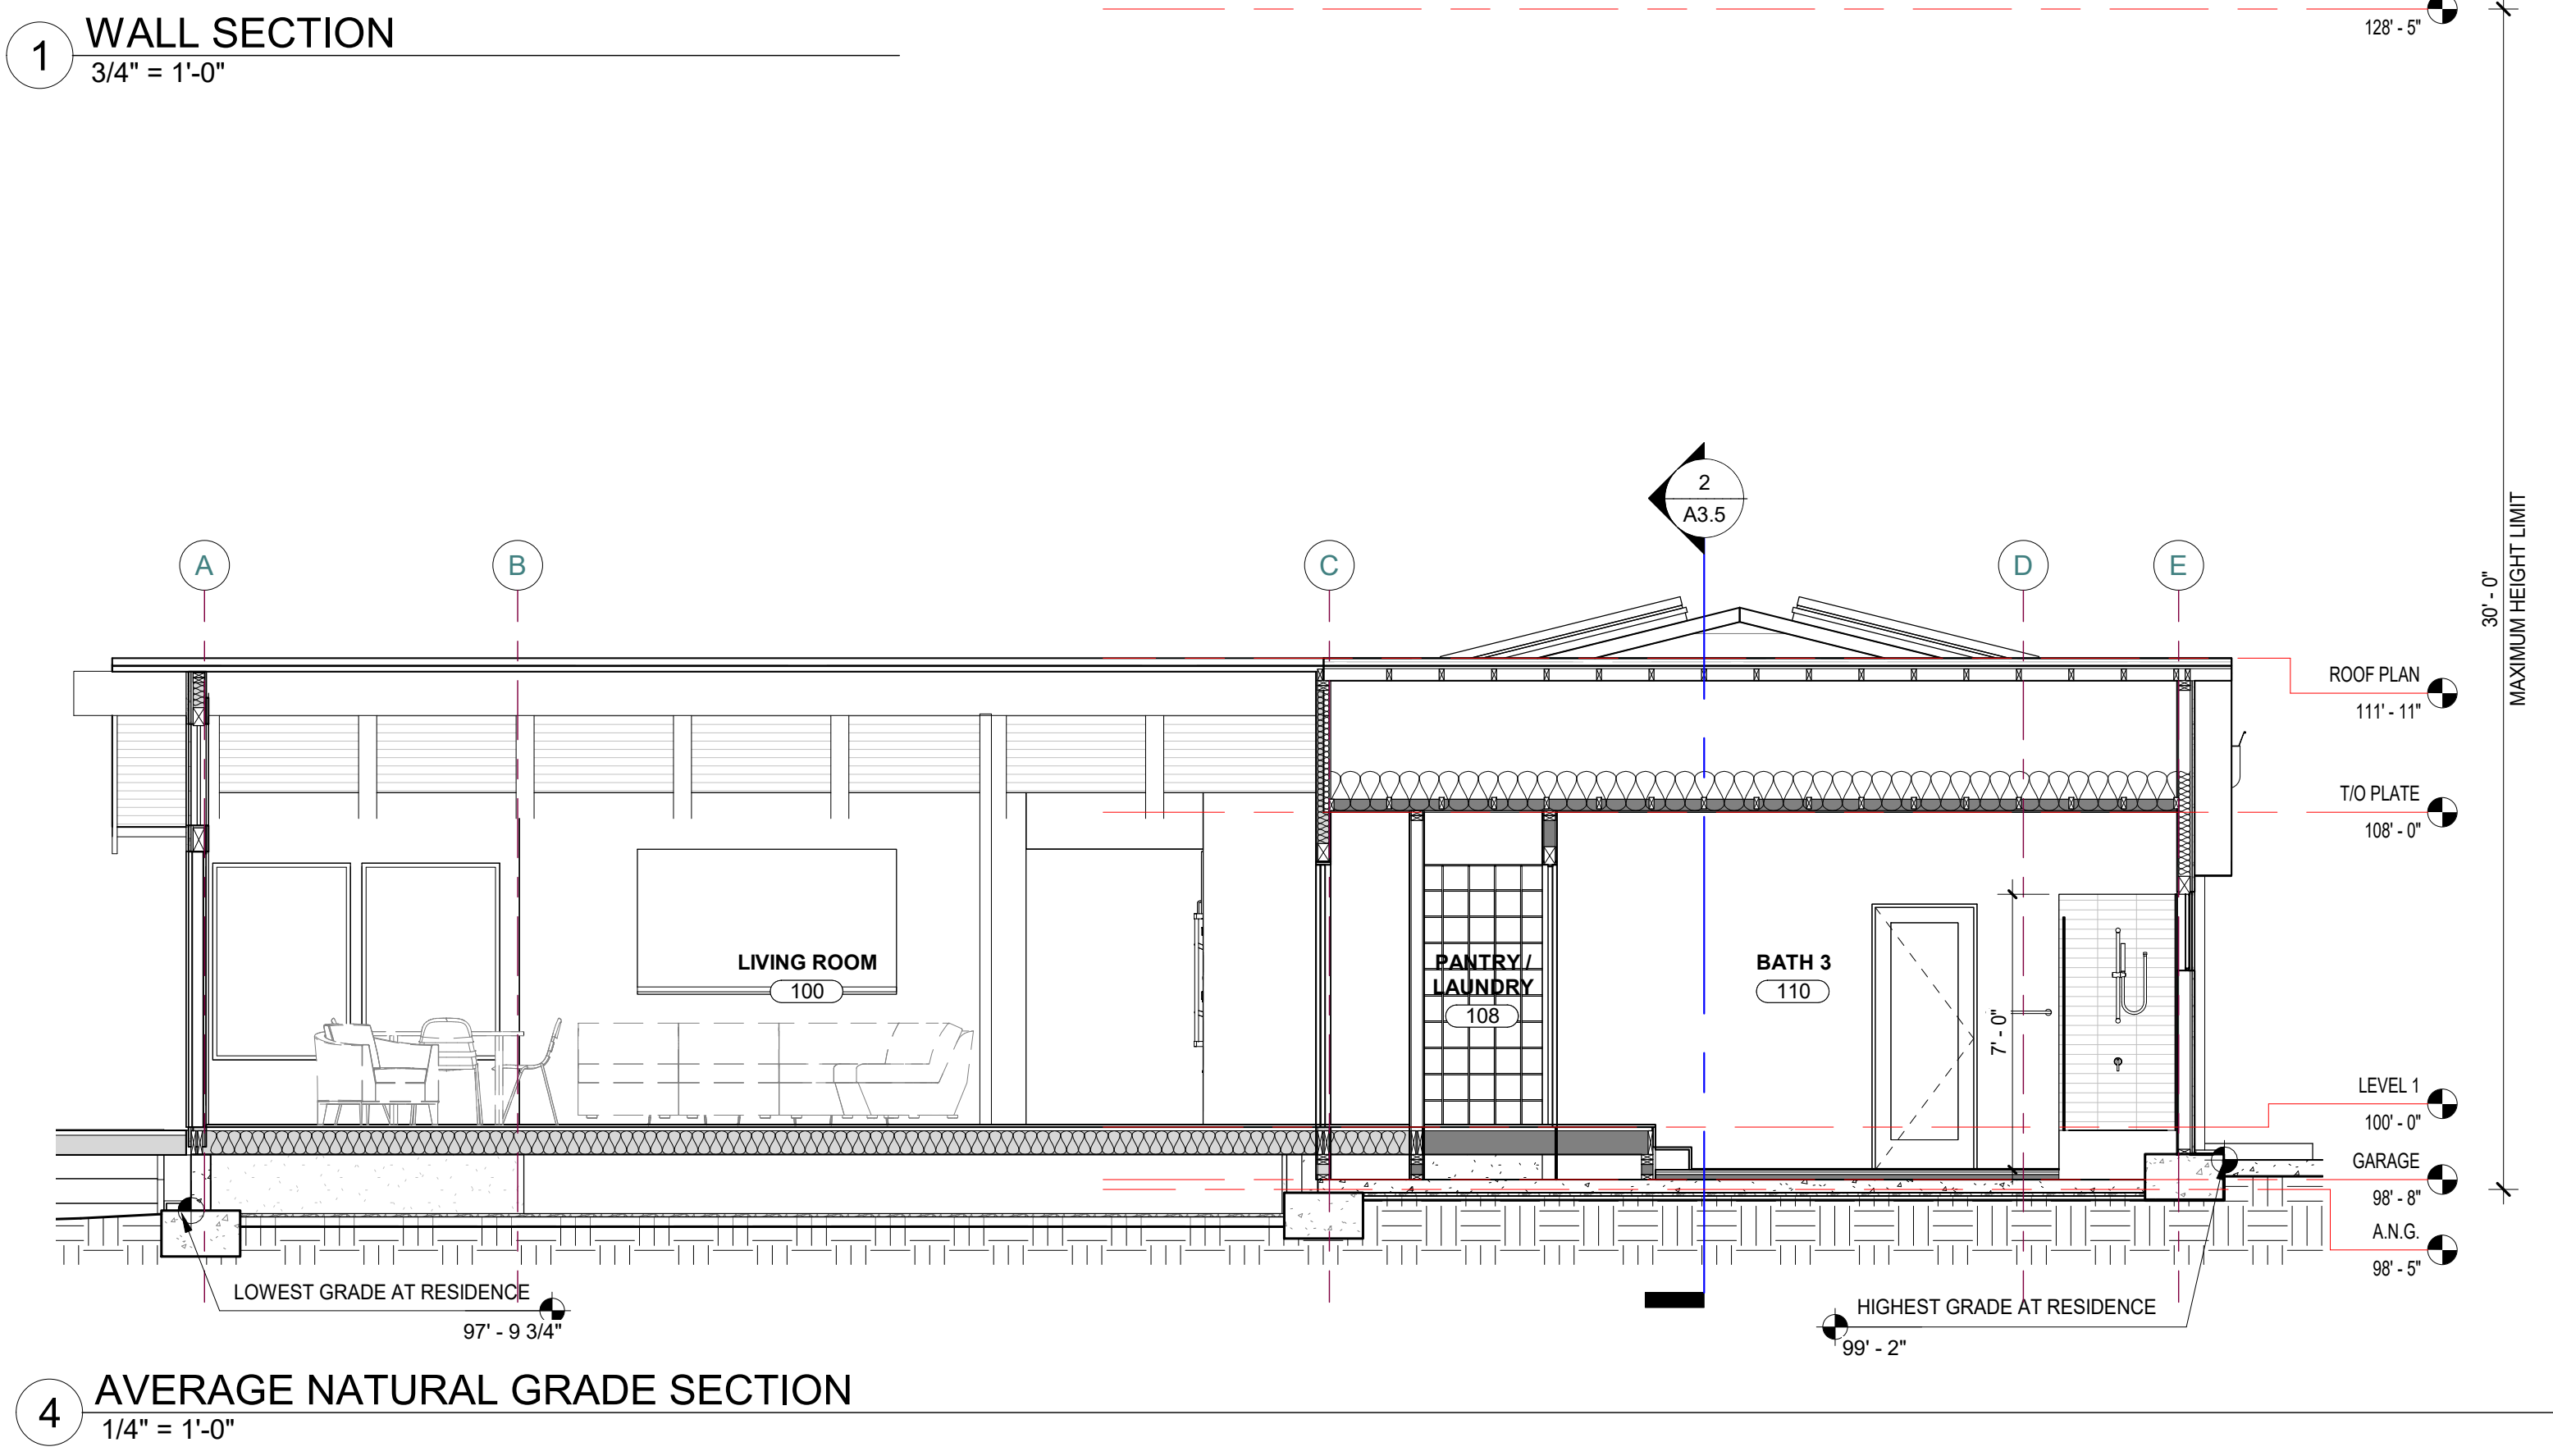

SCHWARTZ TRYON REMODEL
 24980 OUTLOOK DR., CARMEL, CA 93923

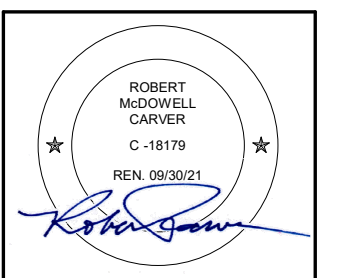

PLANNING DEPARTMENT SUBMITTAL

PO BOX 2884 - CARMEL CA 93921 - USA
 T:831.622.7837 - F:831.624.0364
 WWW.STUDIOCARVER.COM

STUDIO CARVER
 ARCHITECTURE + PLANNING + INTERIOR DESIGN



REVISION #

1	1/08/18	PLAN REVIEW COMMENTS
2	8/6/20	PLN170572 REVISION
5	4/23/2021	BUILDING CORRECTIO NS

ARCHITECTURAL BUILDING & WALL SECTIONS

Scale: As indicated @ 24x36
 Drawn By: DP
 Job: 1713

A3.5
 5/4/2021 4:07:36 PM

SCHWARTZ RESIDENCE - 7/17/2017

PLN200192



SCHWARTZ RESIDENCE - 3/15/2021

PLN200192



SCHWARTZ RESIDENCE - 7/17/2017

PLN200192



SCHWARTZ RESIDENCE - 3/15/2021

PLN200192



PROJECT FILE NO. PLN200192 PHOTOGRAPHS



Date: _____ Site Address: _____ Planner: _____

Description: _____

PROJECT FILE NO. _____ PHOTOGRAPHS

Date: _____ Site Address: _____ Planner: _____


Description: _____

COLOR SAMPLES FOR PROJECT FILE NO. PLN200192




Materials: _____ Colors: _____

Description: _____

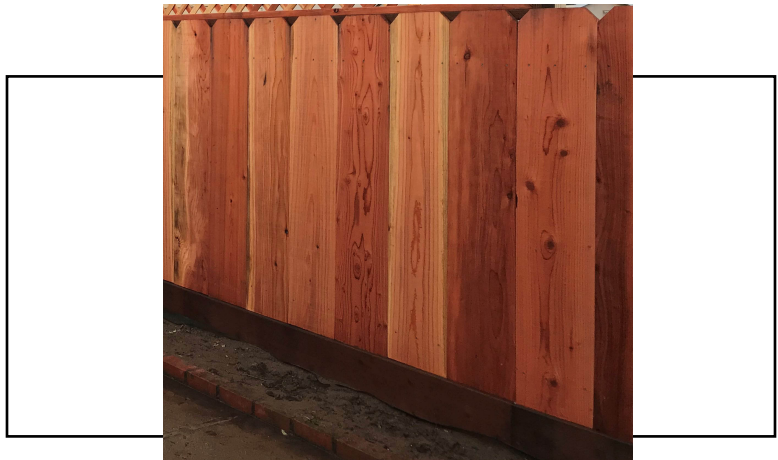

Materials: _____ Colors: _____

Description: _____

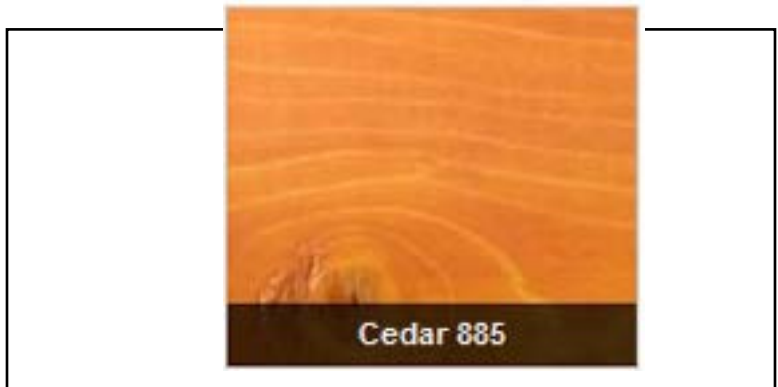

Materials: _____ Colors: _____

Description: _____

This page intentionally left blank.