
NATIVIDAD MEDICAL CENTER MOD. 5 TENANT IMPROVEMENTS

MODULAR 5, BUILDING 840 & BUILDING 870

1441 CONSTITUTION BLVD., SALINAS, CA 93906 THIS IS NOT AN OSHPD PROJECT

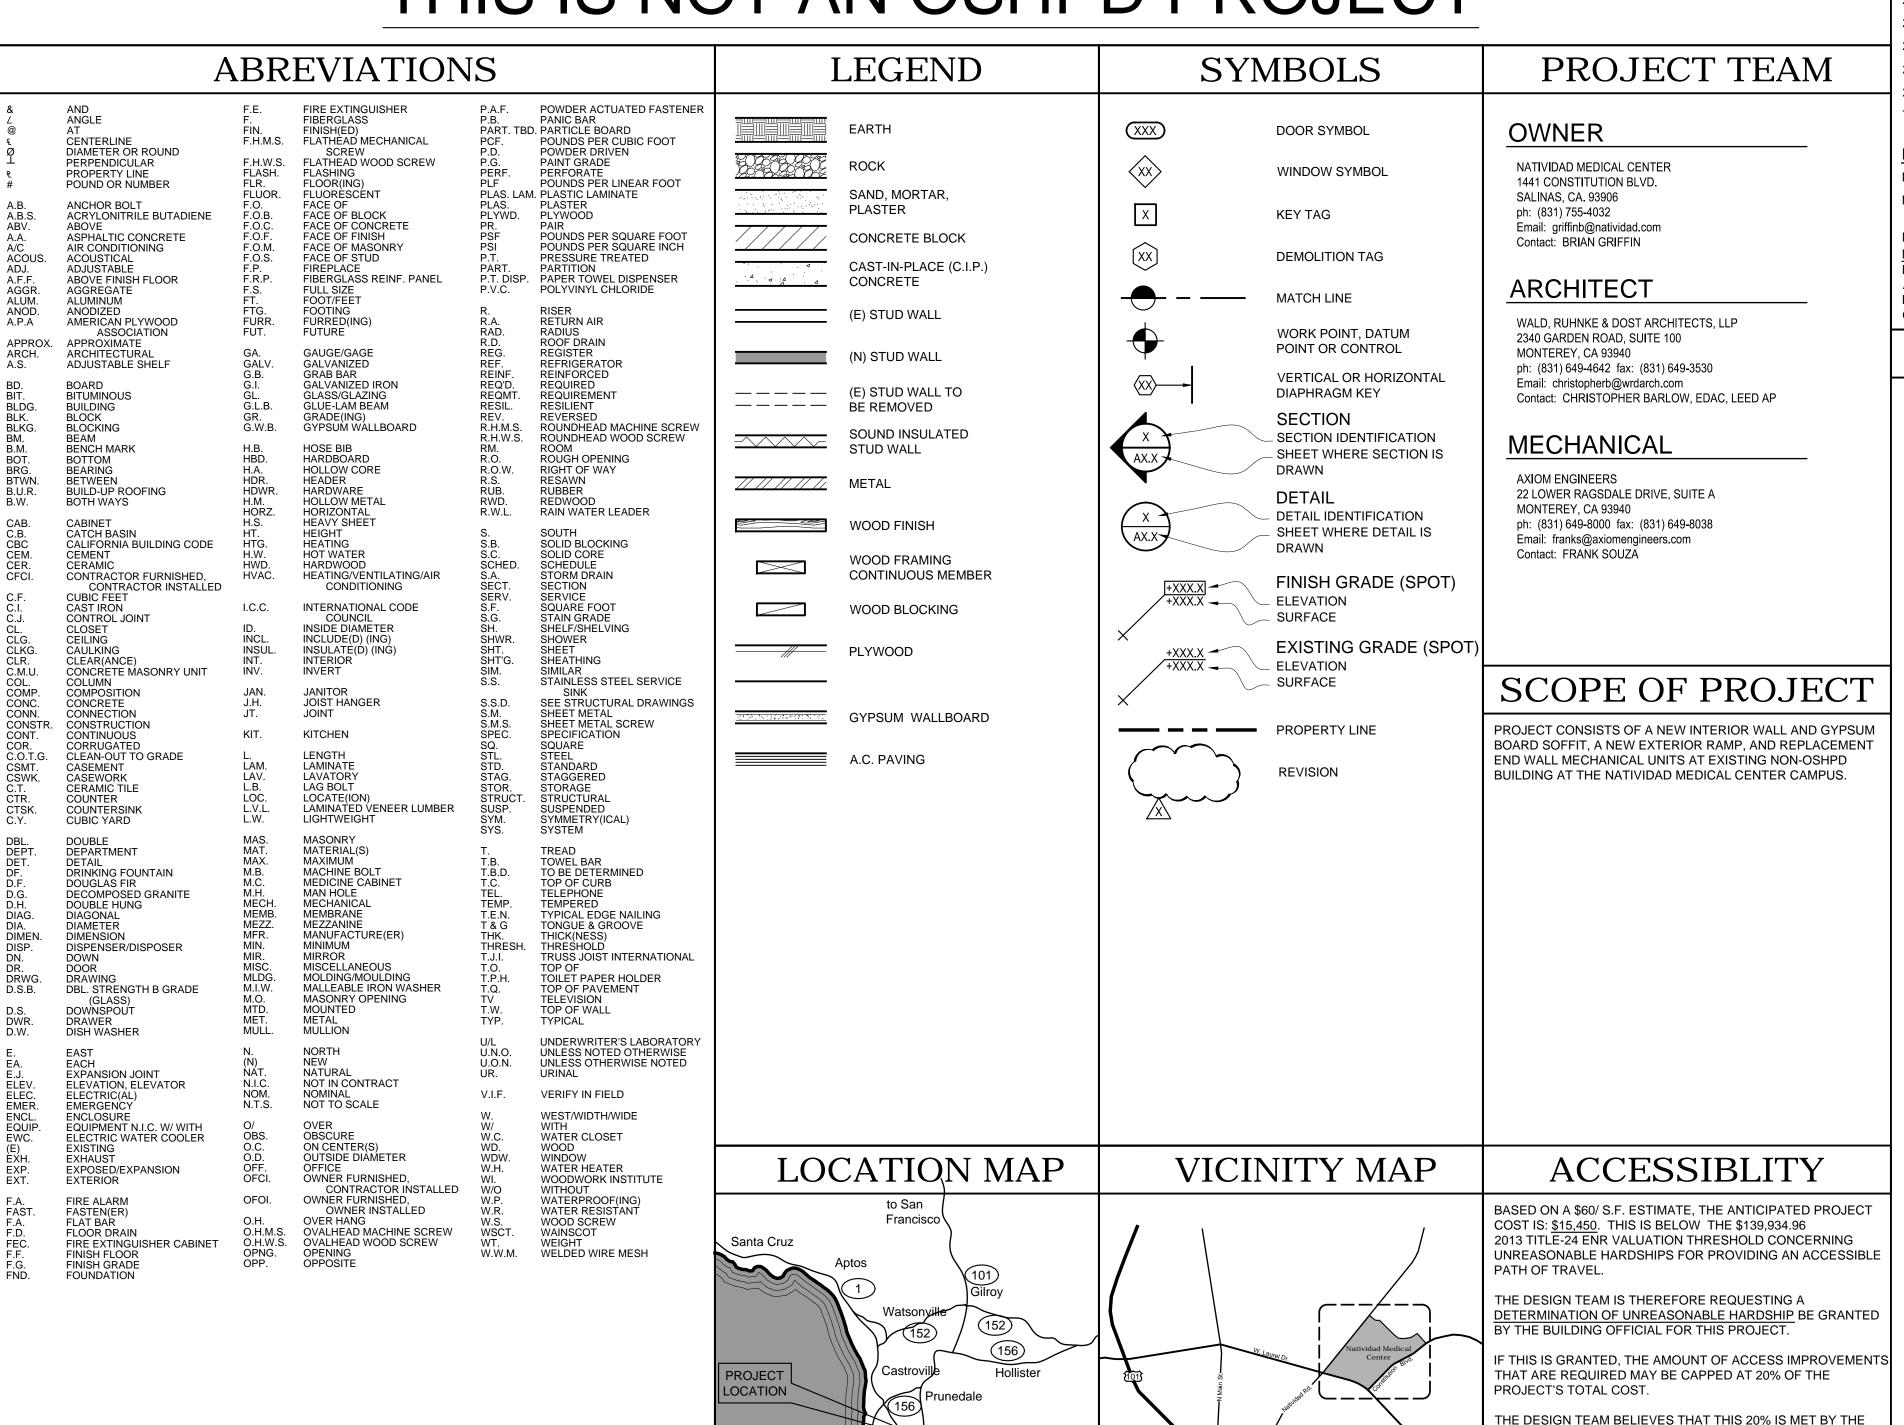

PROJECT INFORMATION

PROJECT: MANAGED CARE TENANT IMPROVEMENTS (BUILDING 870)

LOCATION 1441 CONSTITUTION BLVD. SALINAS, CA. 93906 003-851-018

ZONING: PQP (PUBLIC QUASI-PUBLIC) OCCUPANCY: GROUP 'B'

CONSTRUCTION: TYPE 'V'-B (NON-SPRINKLERED)

MPROVEMENT AREA: EXISTING BUILDING AREA:

APPLICABLE BUILDING CODES & STANDARDS

2010 CALIFORNIA BUILDING CODE (CBC), PART 2, TITLE 24 C.C.R. 2010 CALIFORNIA RESIDENTIAL CODE (CRC), PART 2.5, TITLE 24 C.C.R.

2010 CALIFORNIA ELECTRICAL CODE (CEC), PART 3, TITLE 24 C.C.R 2010 CALIFORNIA MECHANICAL CODE (CMC), PART 4, TITLE 24 C.C.R.

2010 CALIFORNIA PLUMBING CODE (CPC), PART 5, TITLE 24 C.C.R. 2008 CALIFORNIA ENERGY EFFICIENCY CODE (CEEC), PART 6, TITLE 24 C.C.R

2007 CALIFORNIA ELEVATOR CODE, PART 7, TITLE 24 C.C.R 2010 CALIFORNIA HISTORICAL BUILDING CODE (CHC), PART 8, TITLE 24 C.C.R. 2010 CALIFORNIA FIRE CODE (CFC), PART 9, TITLE 24 C.C.R

2010 CALIFORNIA EXISTING BUILDING CODE (CEBC), PART 10, TITLE 24 C.C.R

PARTIAL LIST OF APPLICABLE STATE STANDARDS

NFPA 13, AUTOMATIC SPRINKLER SYSTEMS, (CA AMENDED) 2010 EDITION NFPA 72, NATIONAL FIRE ALARM CODE, (CA AMENDED) 2010 EDITION

PROPOSED NEW ACCESSIBLE RAMP LEADING TO THE PROJECT

THE DESIGN TEAM IS NOT AWARE OF ANY PREVIOUS

ALTERATIONS TO THE PROJECT AREA (OR TO DIFFERENT AREAS ON THE SAME PATH OF TRAVEL) OVER THE PAST

EGRESS COMPLYING WITH CHAPTER 10 AND CHAPTER 11 (WHERE APPLICABLE FOR EXIT SYSTEM SHALL MAINTAIN A CONTINUOUS, UNOBSTRUCTED AND UNDIMINISHED PA

SHEET INDEX

SHEET TITLE

MANAGED CARE COVER SHEET

ARCHITECTURAI ENLARGED EXISTING SITE PLAN FLOOR PLAN & PARTIAL REF. CLG. PLAN

MECHANICAI

SCHEDULES, LEGENDS AND NOTES - MECHANICAL MANAGED CARE FLOOR PLAN - MECHANICAL

GENERAL NOTES


- DIMENSIONS, GRADES, AND OTHER CONDITIONS, AND SHALL CORRELATE AT THE JOB
- OR THE PROPER EXECUTION OF THE SAME WRITTEN DIMENSIONS SHALL HAVE PRECEDENCE OVER SCALED DIMENSIONS. ANY
- THESE DRAWINGS SHALL BE CONSIDERED SUBSTANTIALLY COMPLETE. IT IS THE

- SHALL BE DIRECTED TO THE ARCHITECT.).PROVIDE ALL REQUIRED FIRE BLOCKING IN ACCORDANCE WITH SECTION 708 OF TH

CURRENT ADOPTED EDITION OF C.B.C.

SITE PLAN (FOR REFERENCE ONLY)

NOTE: REFER TO ENLARGED SITE PLAN, SHEET A103 FOR DETAILED SITE AREA

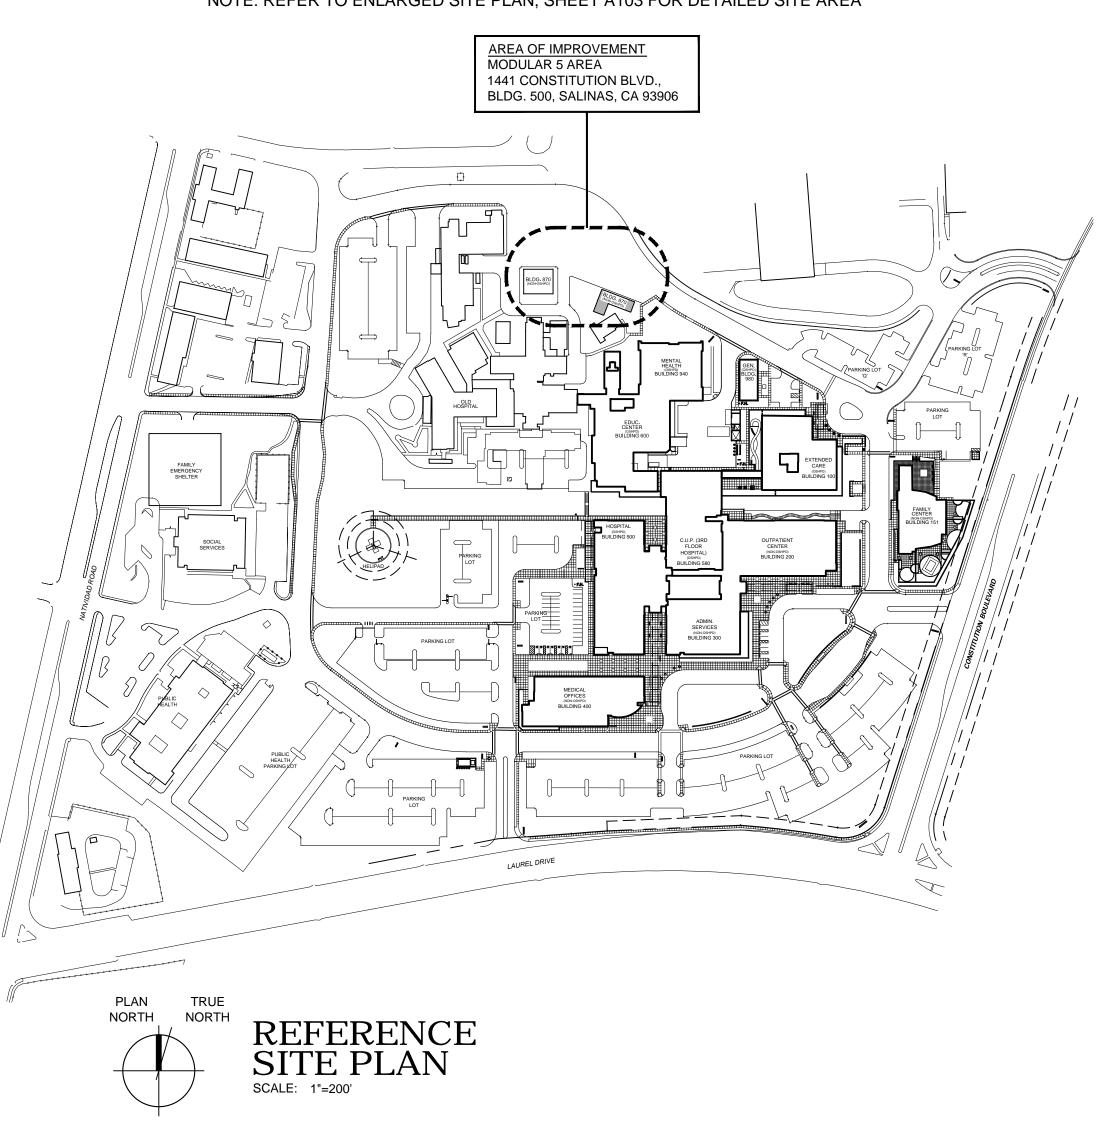



2340 GARDEN ROAD, SUITE 10 MONTEREY, CALIFORNIA 93940


FAX: 831.649.3530

WWW.WRDARCH.COM

PHONE: 831.649.4642

RESTRICTED TO THE ORIGINAL SITE FOR WHIC AND VISUAL CONTACT WITH THEM CONSTITUTES PRIMA FACIE EVIDENCE OF THE ACCEPTANCE OF THESE RESTRICTIONS

M Natividad MEDICAL CENTER

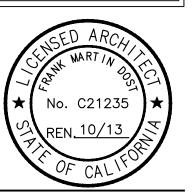

870)

UILDIN

MEDIC/ CARE T

CARE

ED

MANAG

JOB NO.:

PRINT DATE:

SET ISSUED:


PLOT DATE: 6.1.2013 DRAWN BY: CHECKED BY:


PERMIT SUBMITTAL 5.30.2013


SHEET NAME:


MANAGED **CARE COVER** SHEET


SHEET NO.:

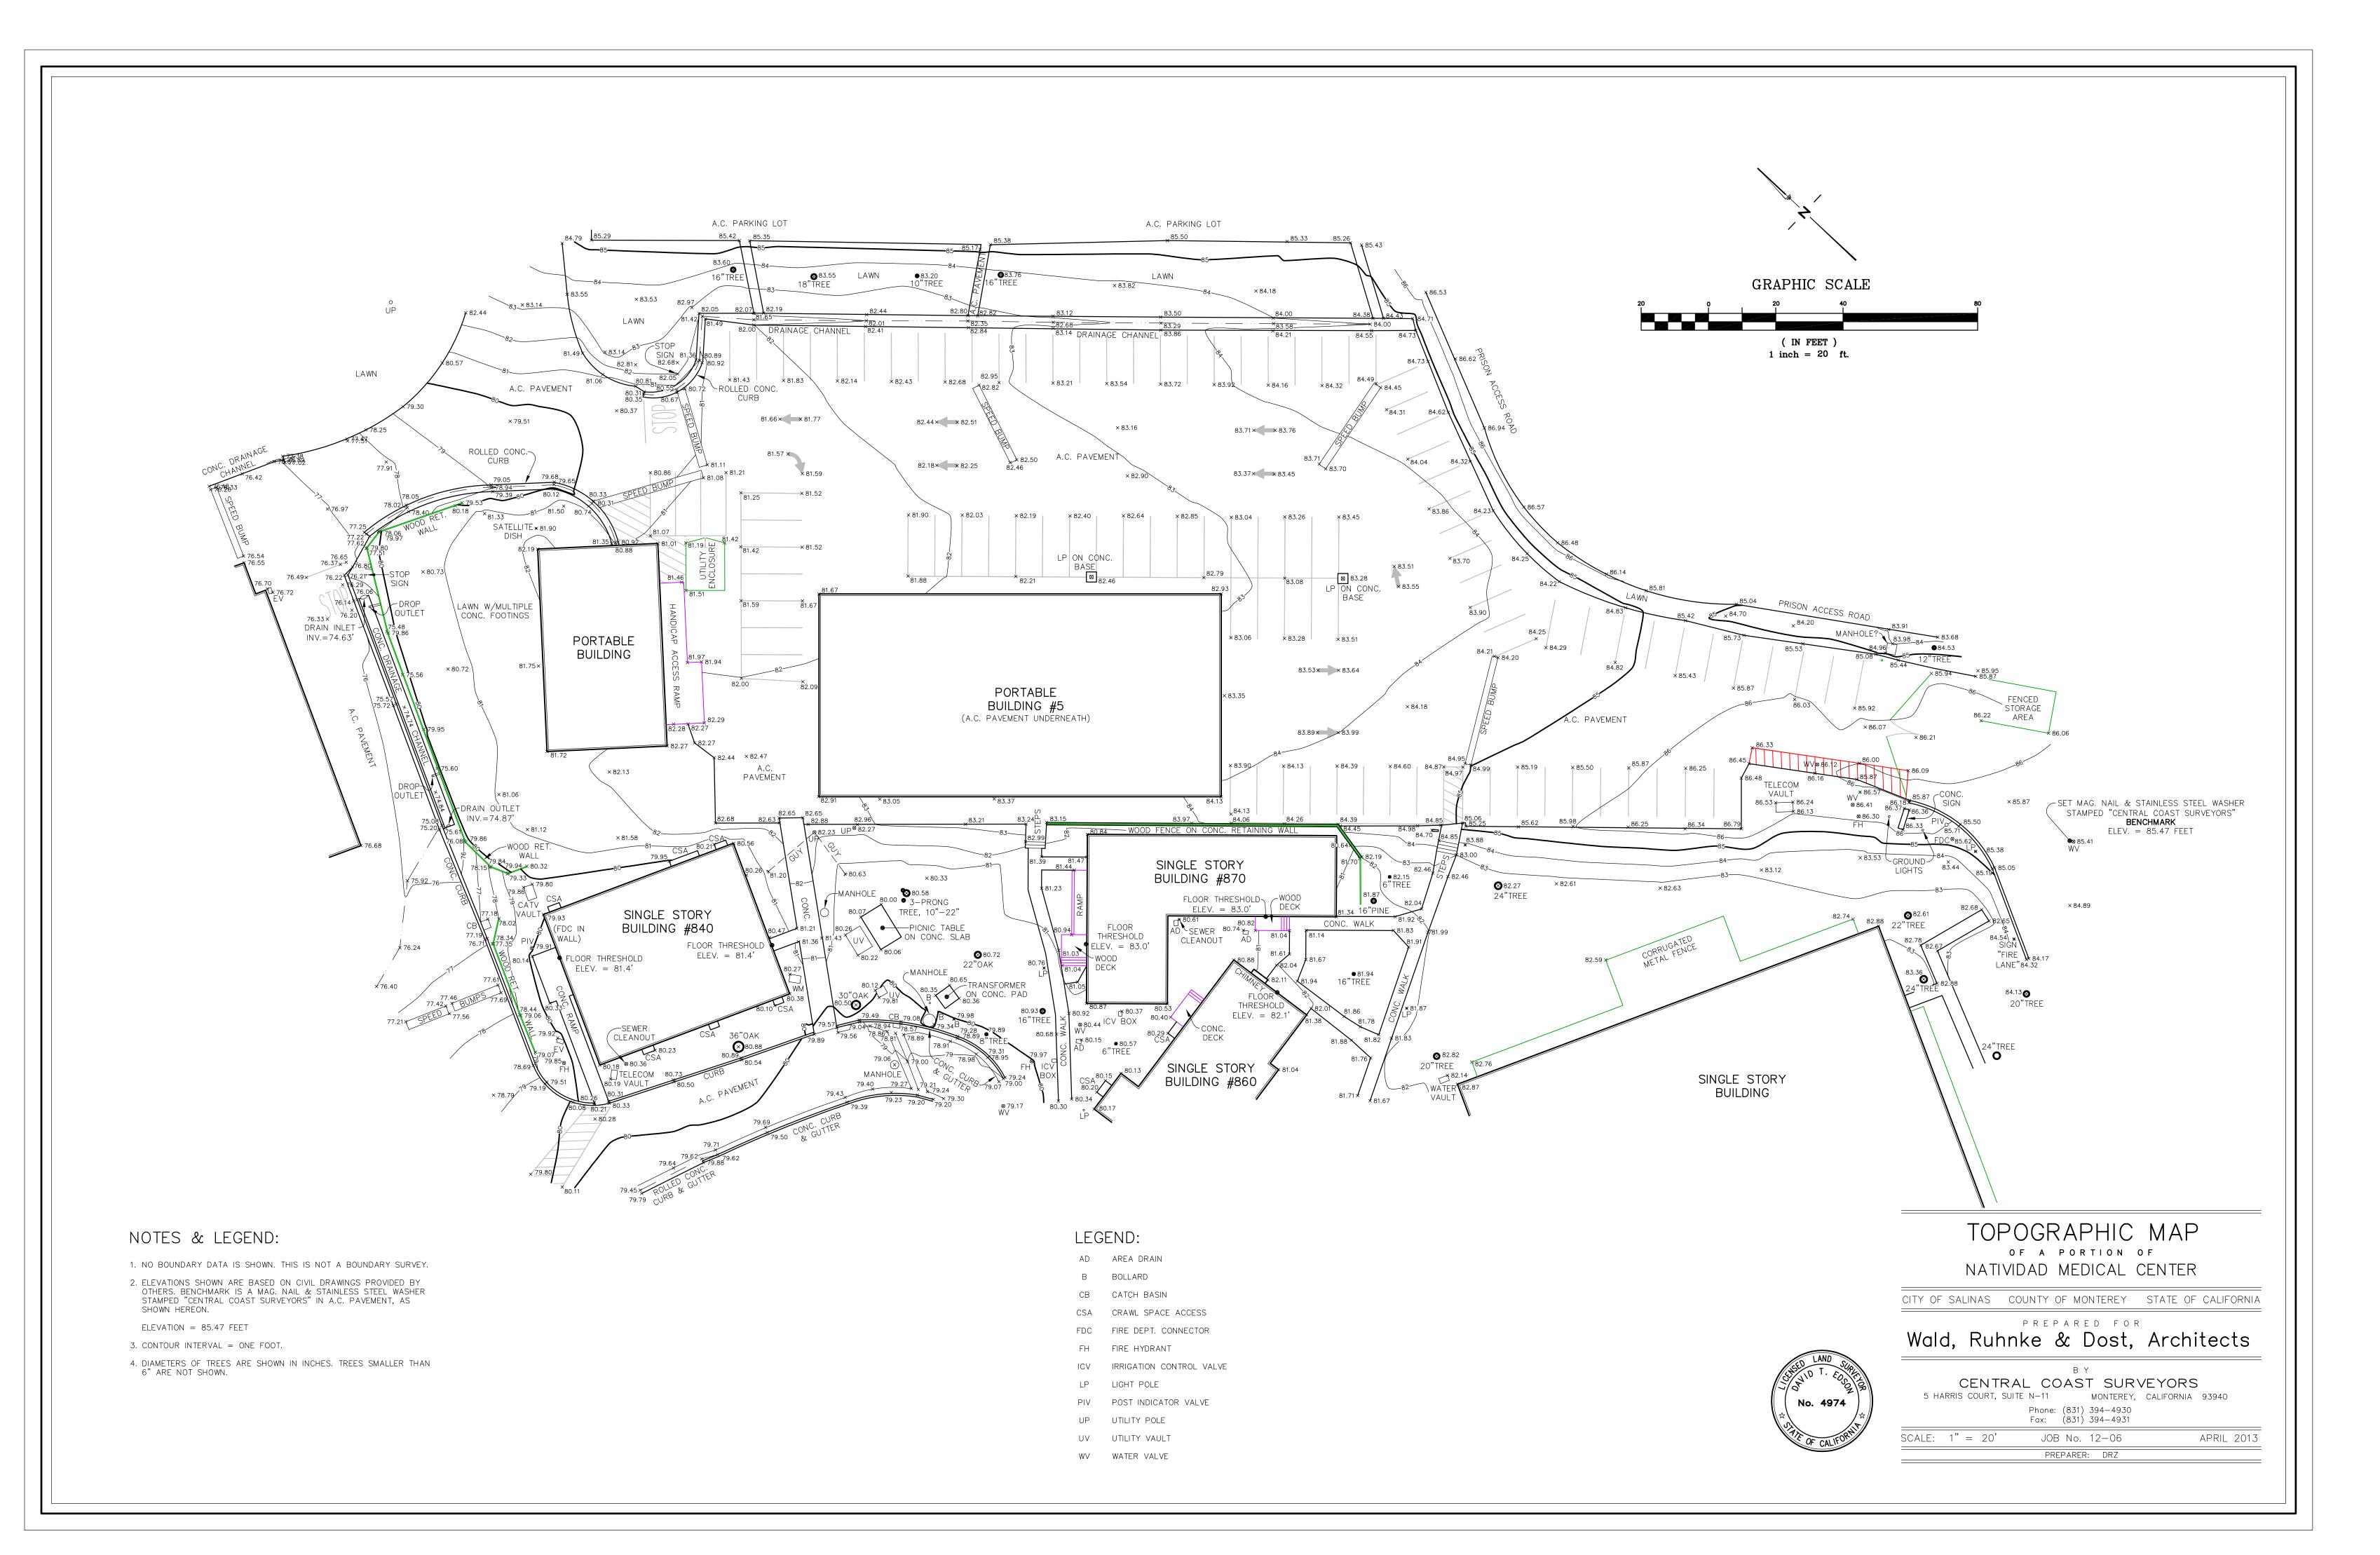

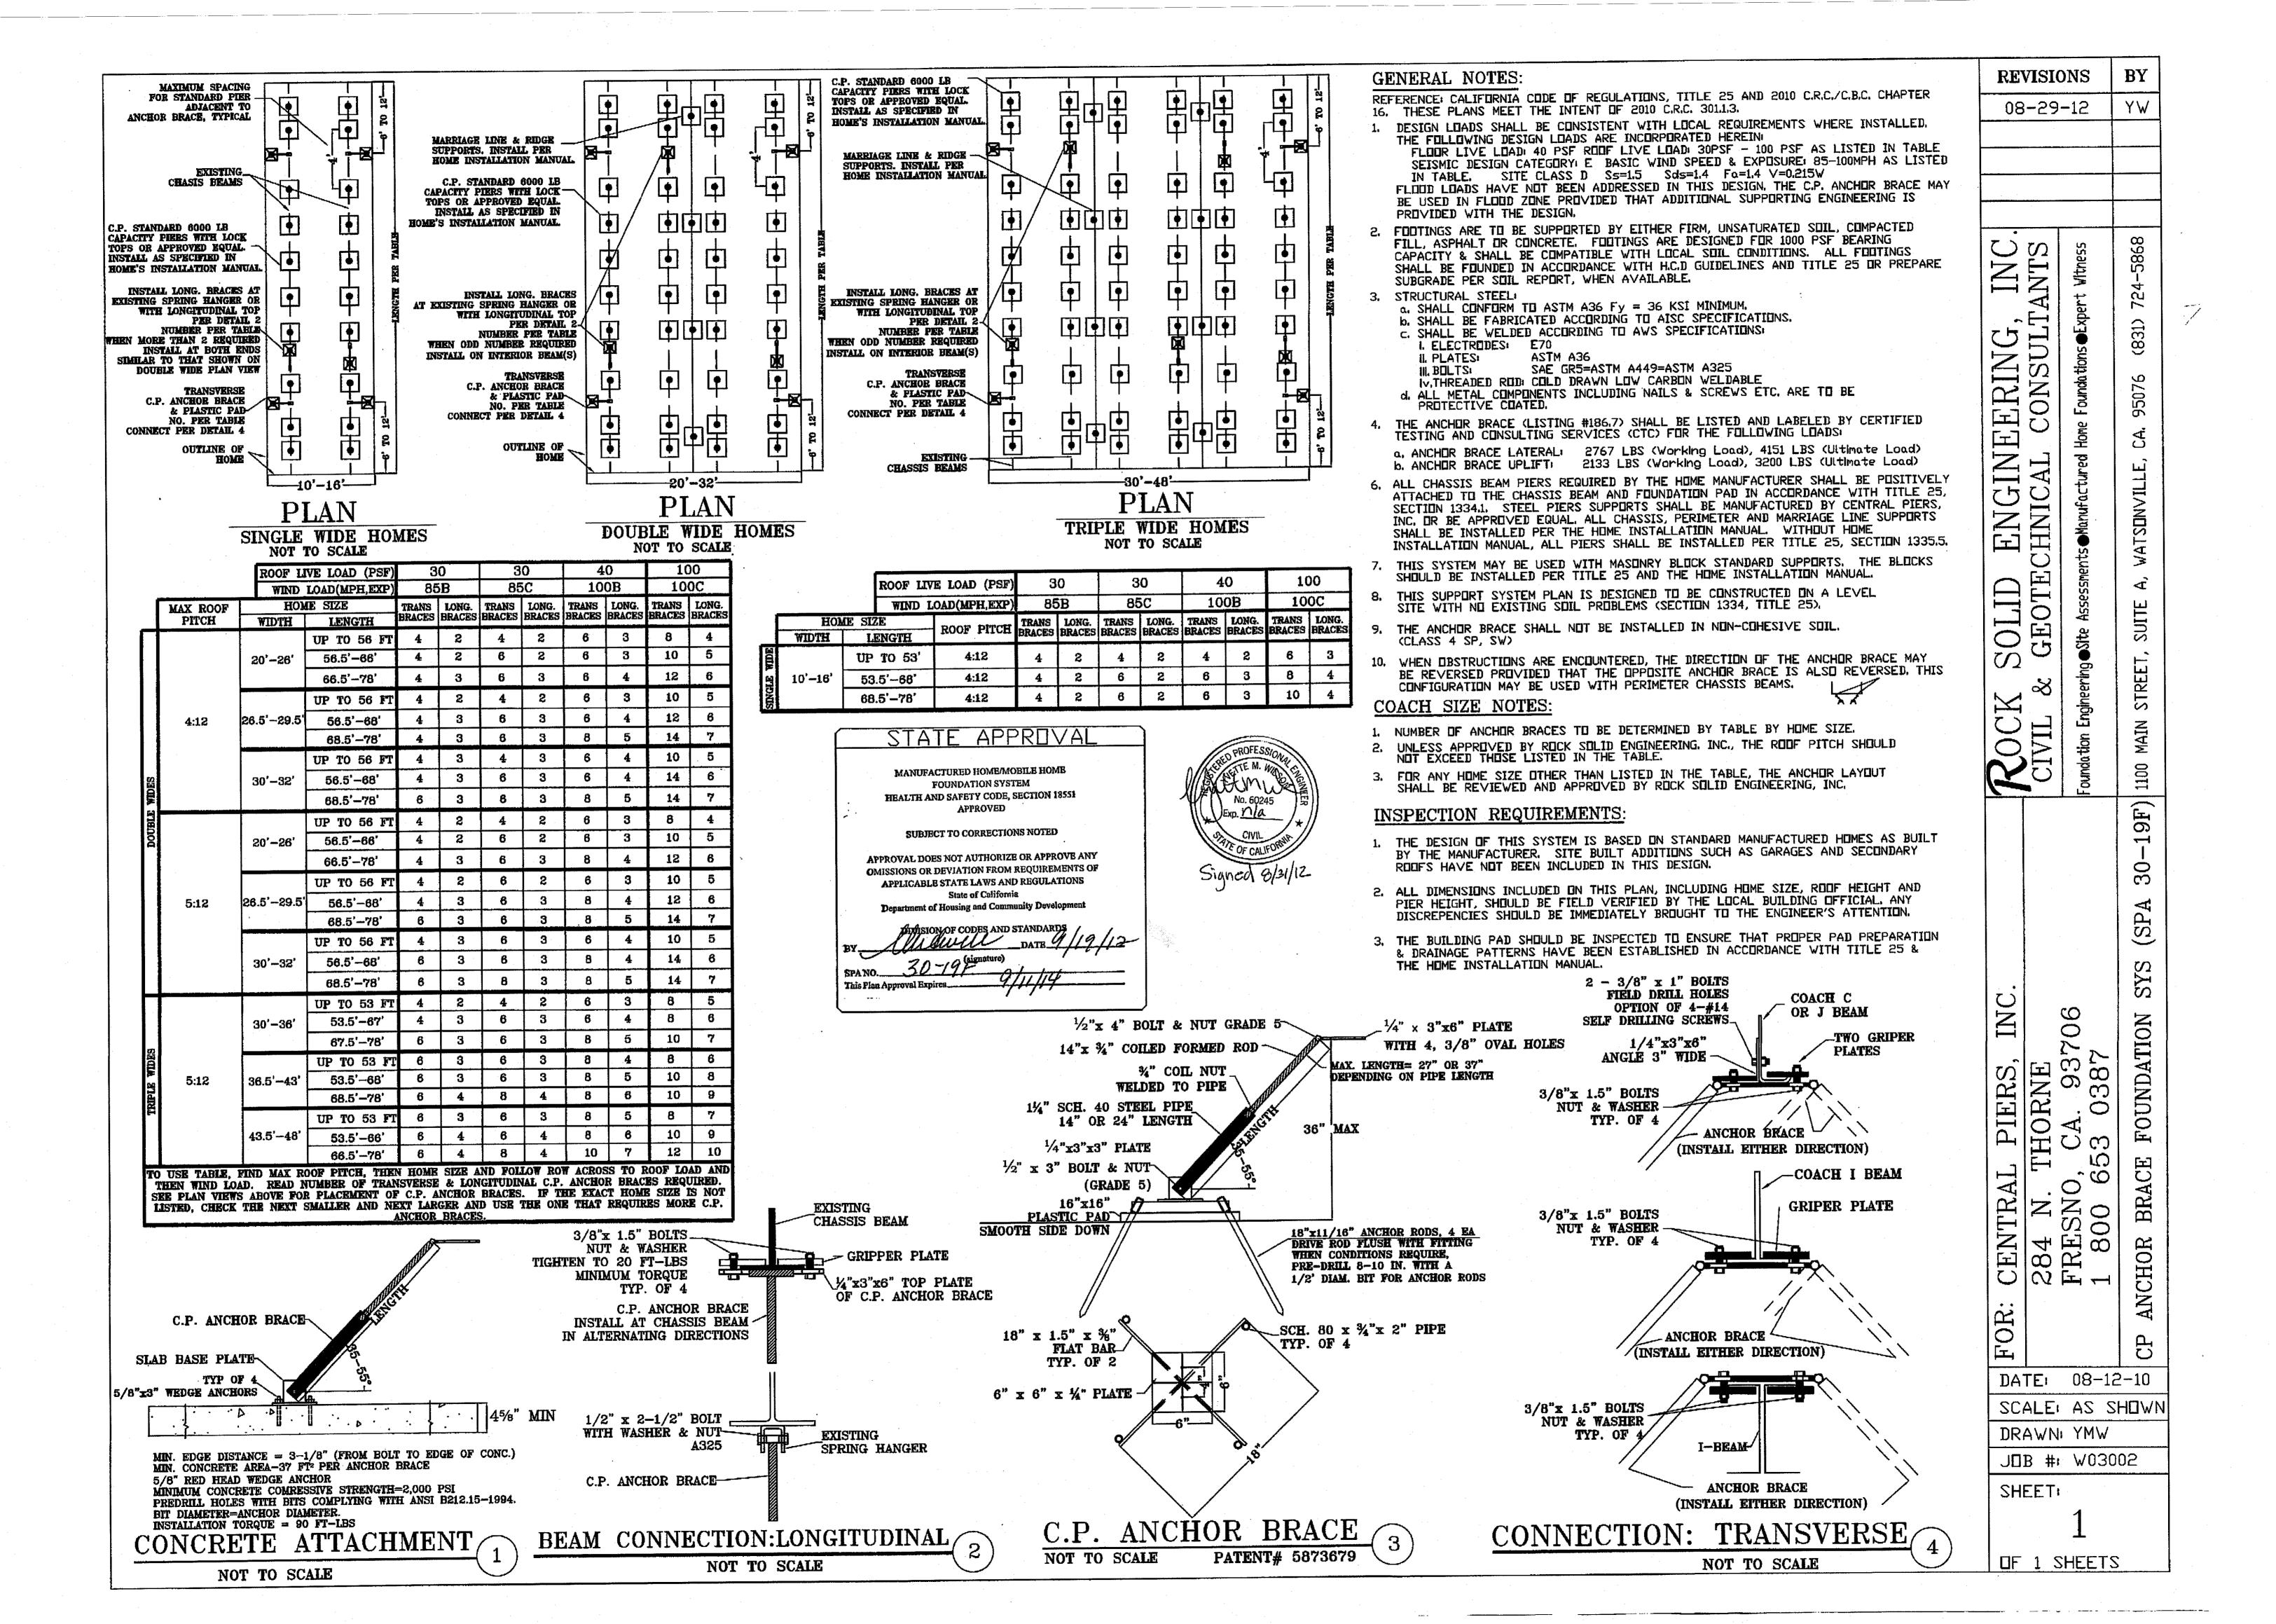

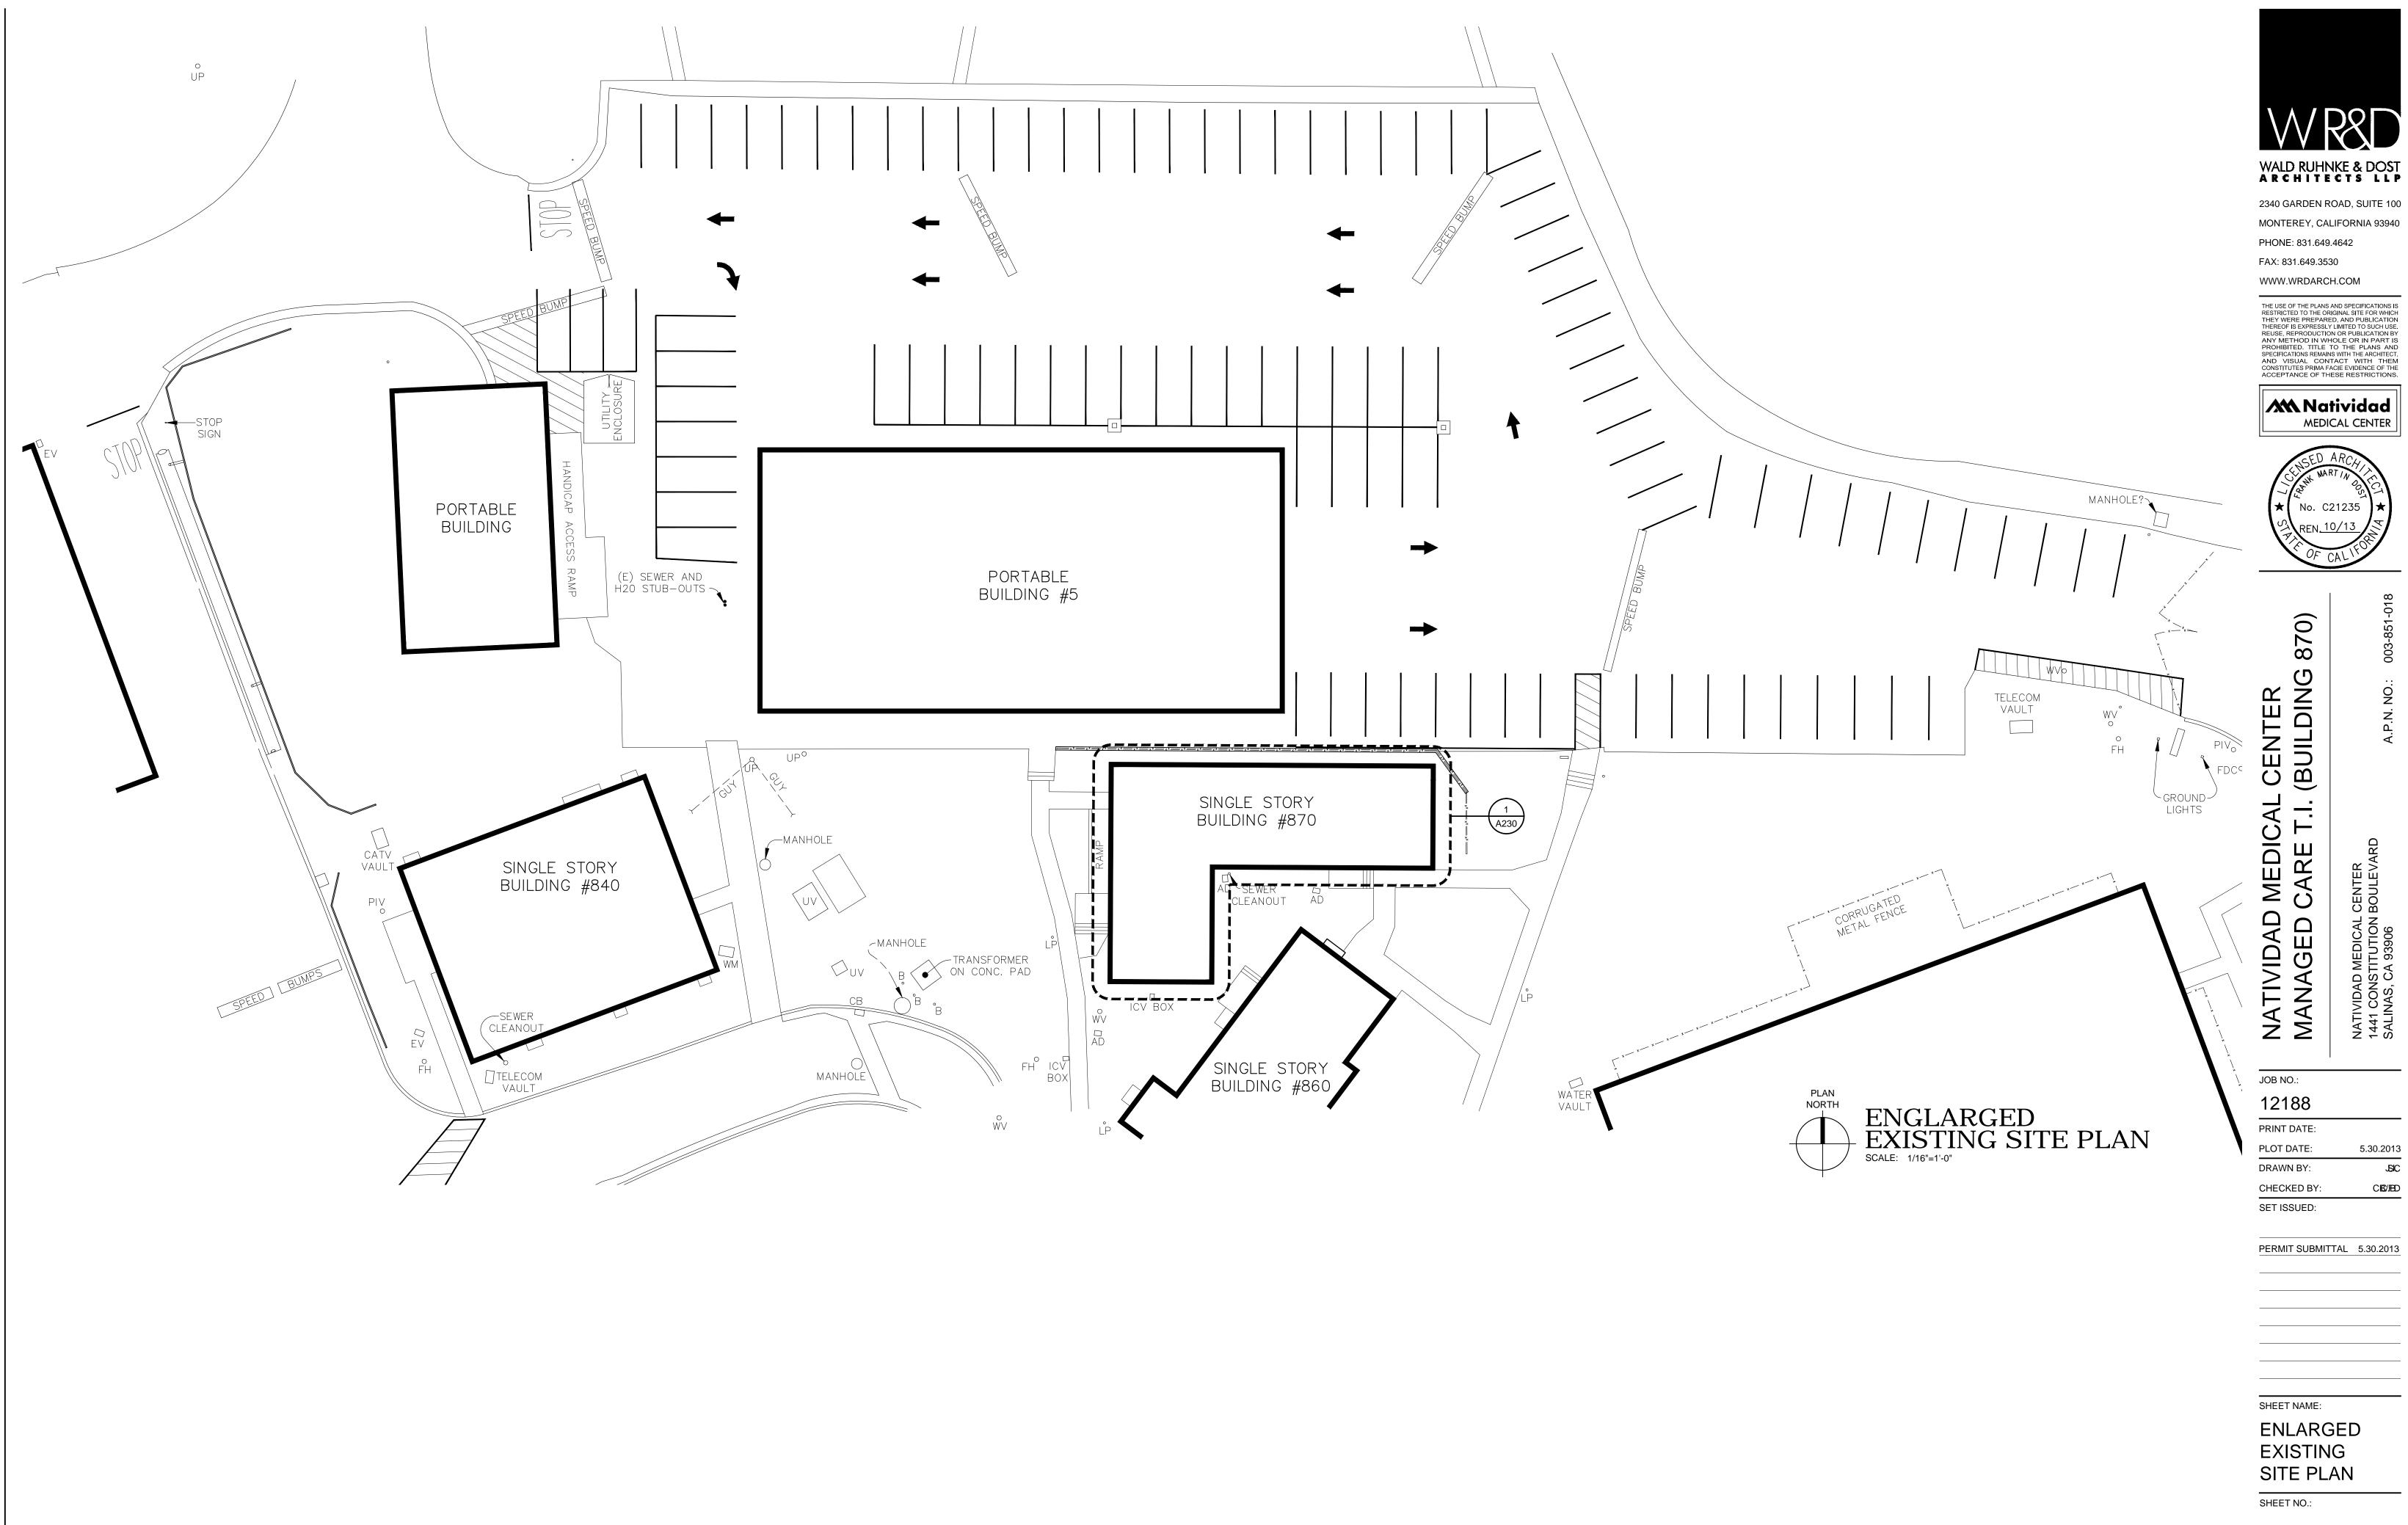

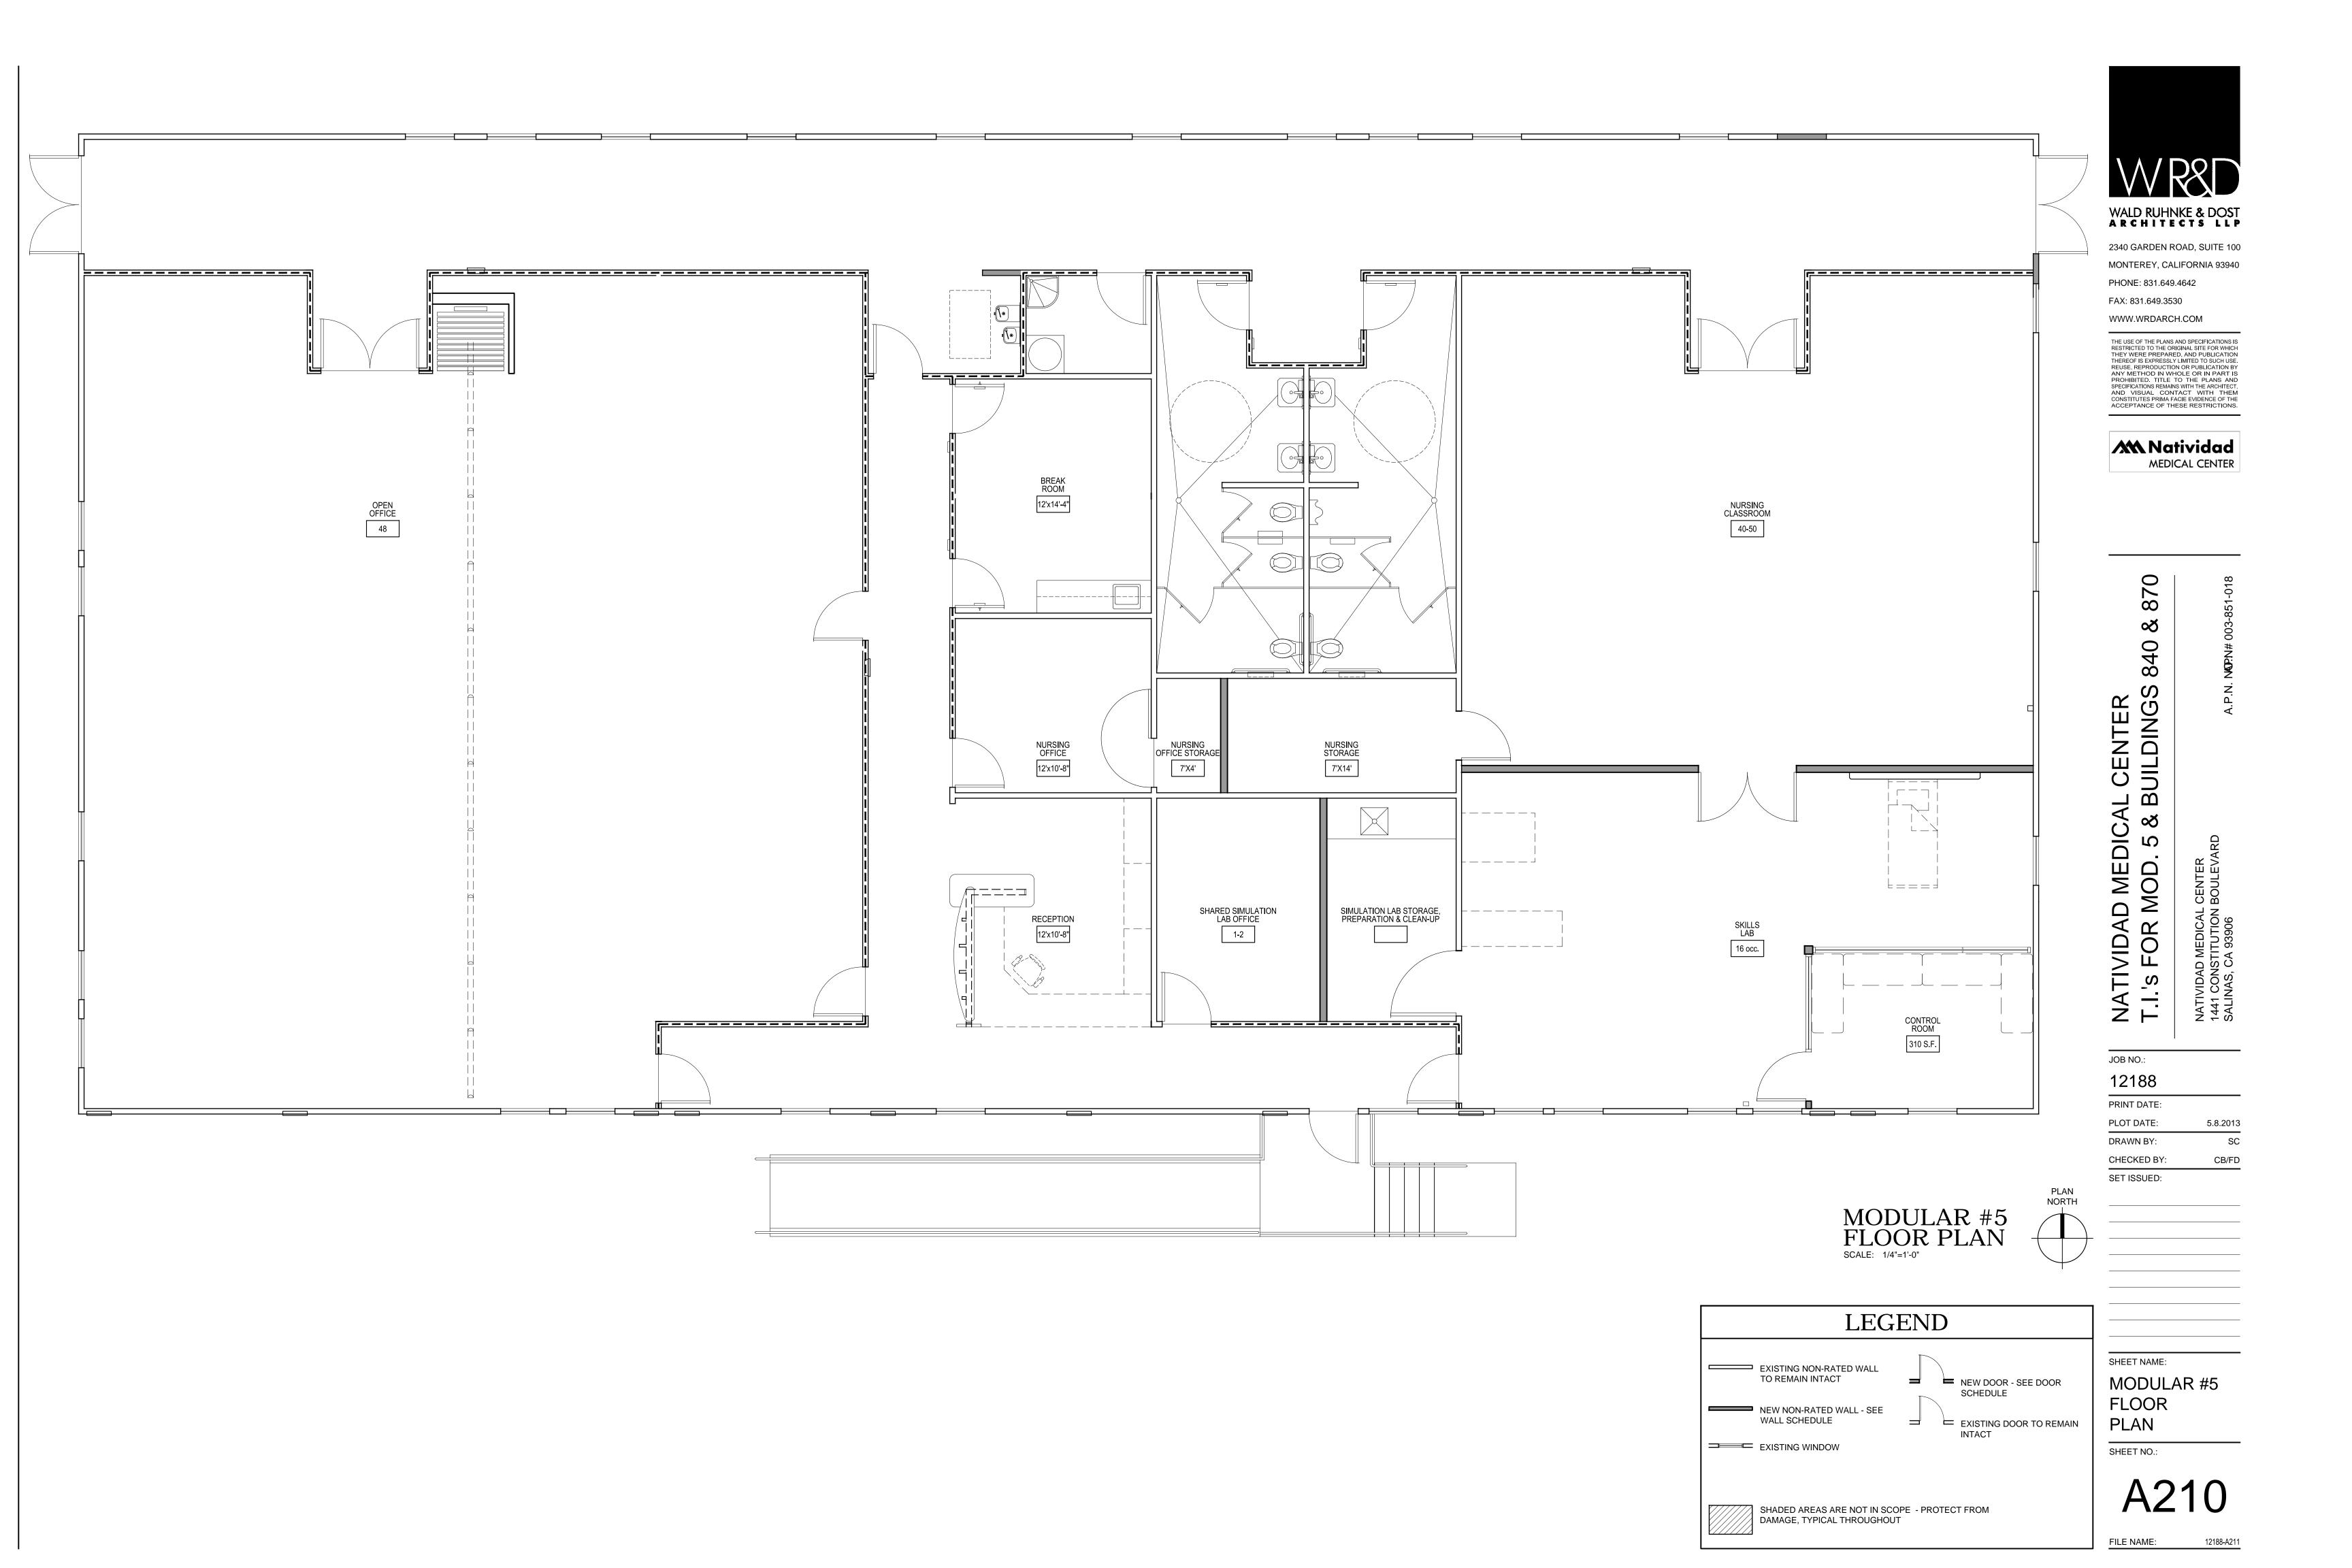

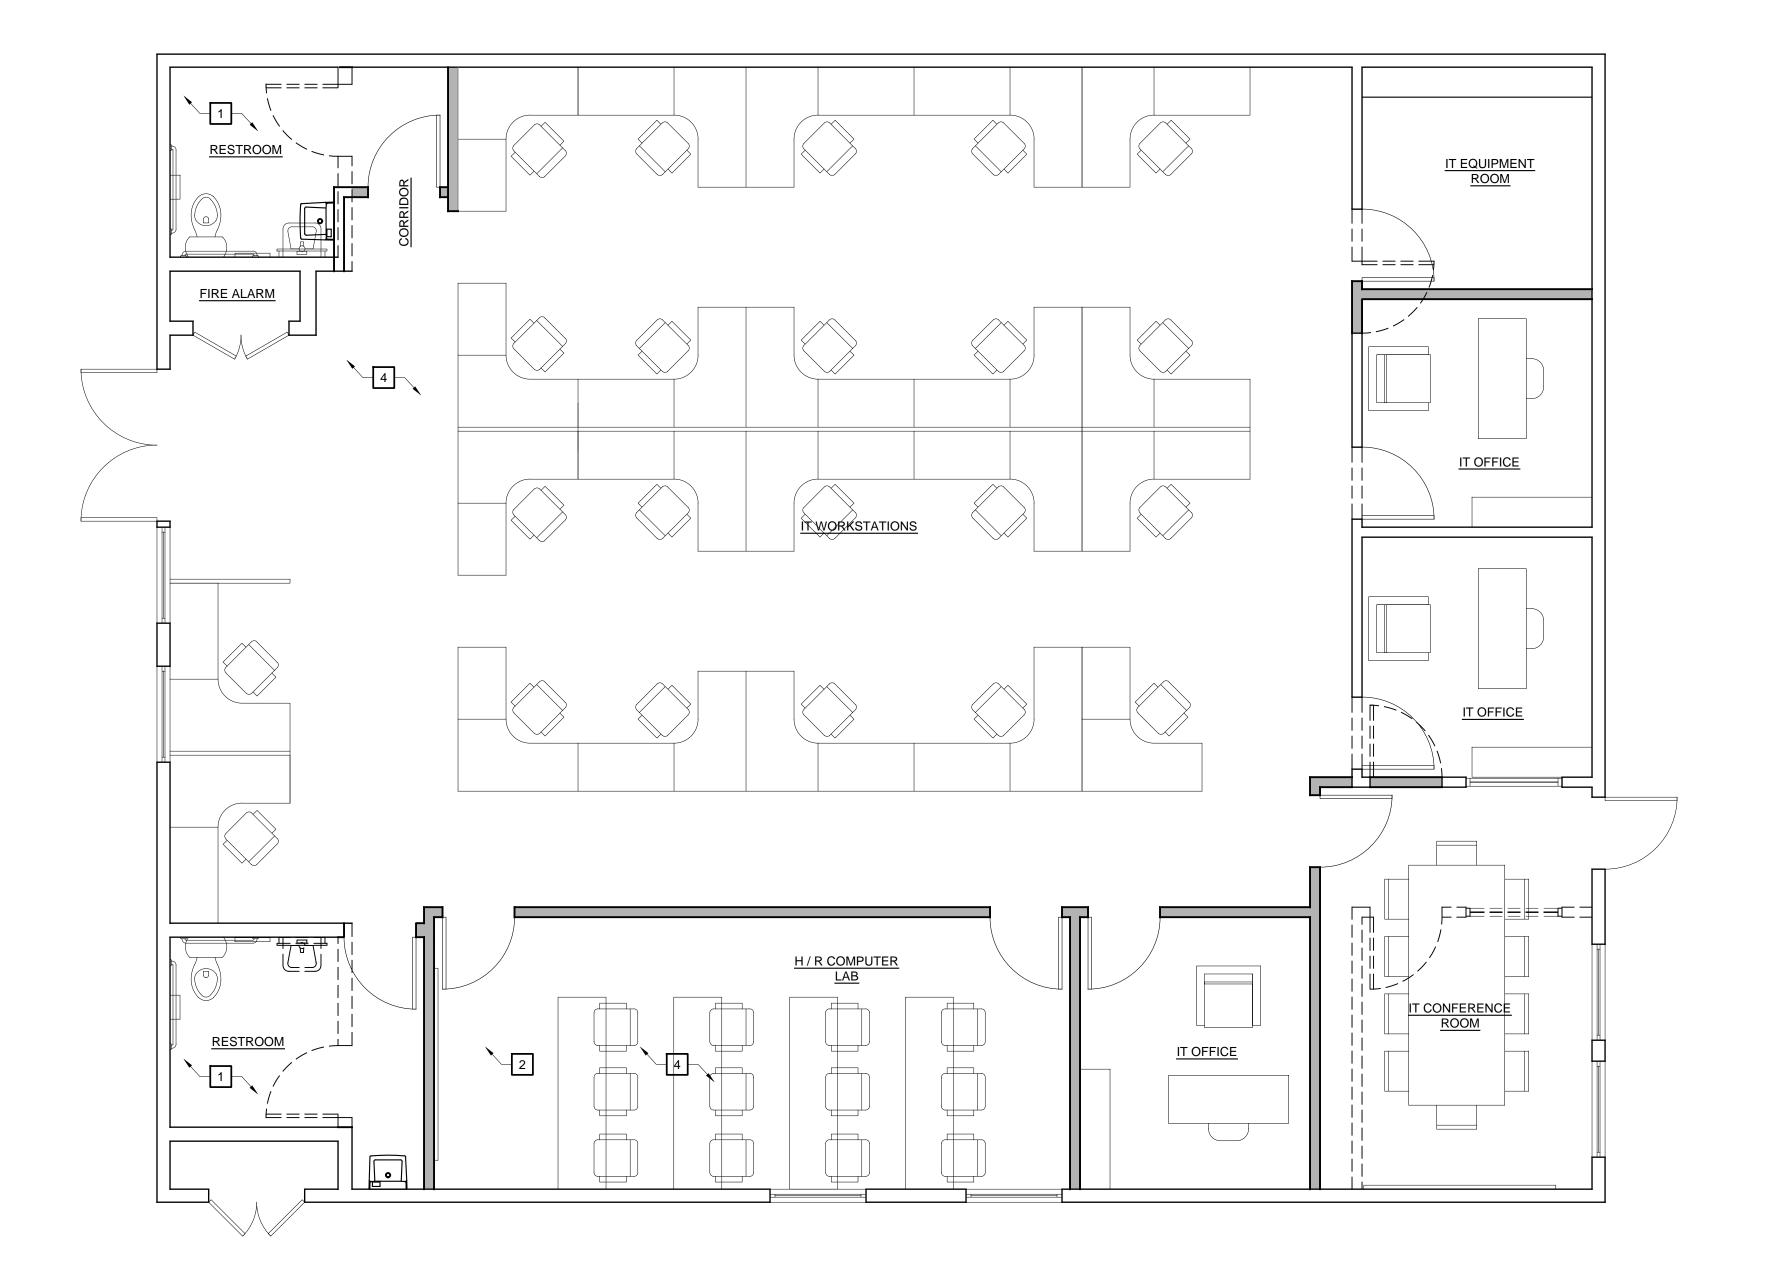

BUILDING 840 FLOOR PLAN SCALE: 1/4"=1'-0"

KEY NOTES

THE KEY NOTES THAT FOLLOW APPLY TO THE DRAWING(S) ON THIS SHEET ONLY. REFER TO FOLLOWING SHEETS FOR NOTES THAT ARE APPLICABLE TO THOSE DRAWINGS.

- EXISTING ACCESSIBLE RESTROOM WITH ALL FIXTURES AND ACCESSORIES TO REMAIN VERIFY ACCESSIBILITY AT ALL ITEMS PRIOR TO FURTHER DESIGN.
- WALL MOUNTED WHITEBOARD VERIFY EXACT A / V AND TELECONFERENCING REQUIREMENTS PRIOR TO SPECIFICATION.
- 3 WORK COUNTER FOR SEATED ACCESS, 30" A.F.F.
- FURNITURE SYSTEMS INCLUDING DESKS, TABLES, CHAIRS, SHELVING AND STORAGE UNITS. TYPICAL OF / CI.



2340 GARDEN ROAD, SUITE 100 MONTEREY, CALIFORNIA 93940 PHONE: 831.649.4642

FAX: 831.649.3530 WWW.WRDARCH.COM

THE USE OF THE PLANS AND SPECIFICATIONS IS RESTRICTED TO THE ORIGINAL SITE FOR WHICH
THEY WERE PREPARED, AND PUBLICATION
THEREOF IS EXPRESSLY LIMITED TO SUCH USE.
REUSE, REPRODUCTION OR PUBLICATION BY
ANY METHOD IN WHOLE OR IN PART IS PROHIBITED. TITLE TO THE PLANS AND SPECIFICATIONS REMAINS WITH THE ARCHITECT, AND VISUAL CONTACT WITH THEM CONSTITUTES PRIMA FACIE EVIDENCE OF THE ACCEPTANCE OF THESE RESTRICTIONS.

M Natividad MEDICAL CENTER

> 0 ∞ **∞** 840 ∞

GENERAL NOTES

- BUILDING EXTERIOR INCLUDING WALLS, ROOF, WINDOWS, EXTERIOR DOORS, ACCESS STAIRS AND RAMPS ARE SCHEDULED TO REMAIN AS IS. PATCH / REPAIR AS NEEDED. REPLACE IF UNABLE TO PATCH / REPAIR. AFTER OWNER APPROVAL OF REPLACEMENT SCOPE. ALL EXISTING EXTERIOR SYSTEMS ARE ANTICIPATED TO BE ACCESSIBLE COMPLIANT WITHOUT FURTHER ADJUSTMENT - VERIFY PRIOR TO ISSUANCE OF BID / PERMIT PACKAGE.
- 2. LAYOUT HAS BEEN DESIGNED TO KEEP AS MANY EXISTING INTERIOR WALLS AND SYSTEMS IN PLACE AS IS IN ORDER TO SAVE TIME AND COST.
- THIS LAYOUT HAS BEEN CREATED IN CONJUNCTION WITH THE DEPARTMENTS SCHEDULED TO BE LOCATED IN THIS SPACE. ITEMS SHOWN REFLECT ADJACENCY, QUANTITY, AND SPATIAL REQUIREMENTS NOTED IN THE PROGRAMMING AND SCHEMATIC DESIGN MEETINGS.
- FIELD VERIFY ALL EXISTING CONDITIONS PRIOR TO FURTHER DEVELOPMENT OF DRAWINGS, DETAILS, SPECIFICATIONS, SELECTION OF NEW PRODUCTS AND SYSTEMS.

NATIVIDAD MEDIC T.I.'s FOR MOD. 5 8

JOB NO.:

SET ISSUED:

12188

PRINT DATE: PLOT DATE:

DRAWN BY: CHECKED BY:

5.8.2013


LEGEND

EXISTING NON-RATED WALL TO REMAIN INTACT

NEW NON-RATED WALL - SEE WALL SCHEDULE

□ EXISTING WINDOW


□=== EXISTING NON-RATED WALL TO REMAIN REMOVED

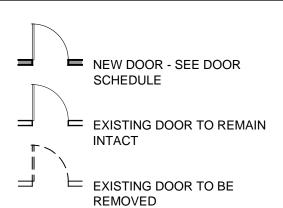


SHEET NAME:

SHEET NO.:


BUILDING 840 FLOOR PLAN

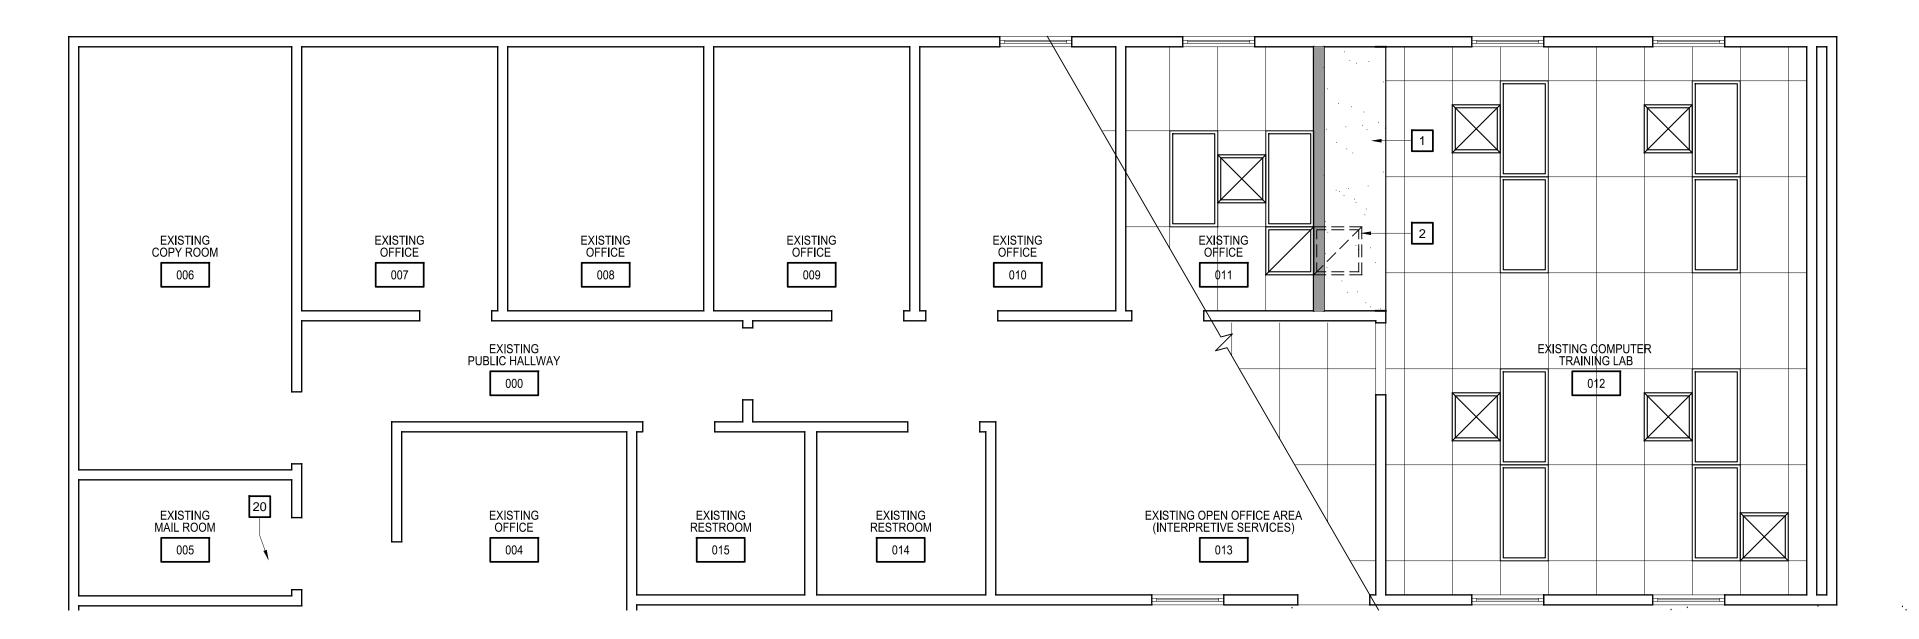




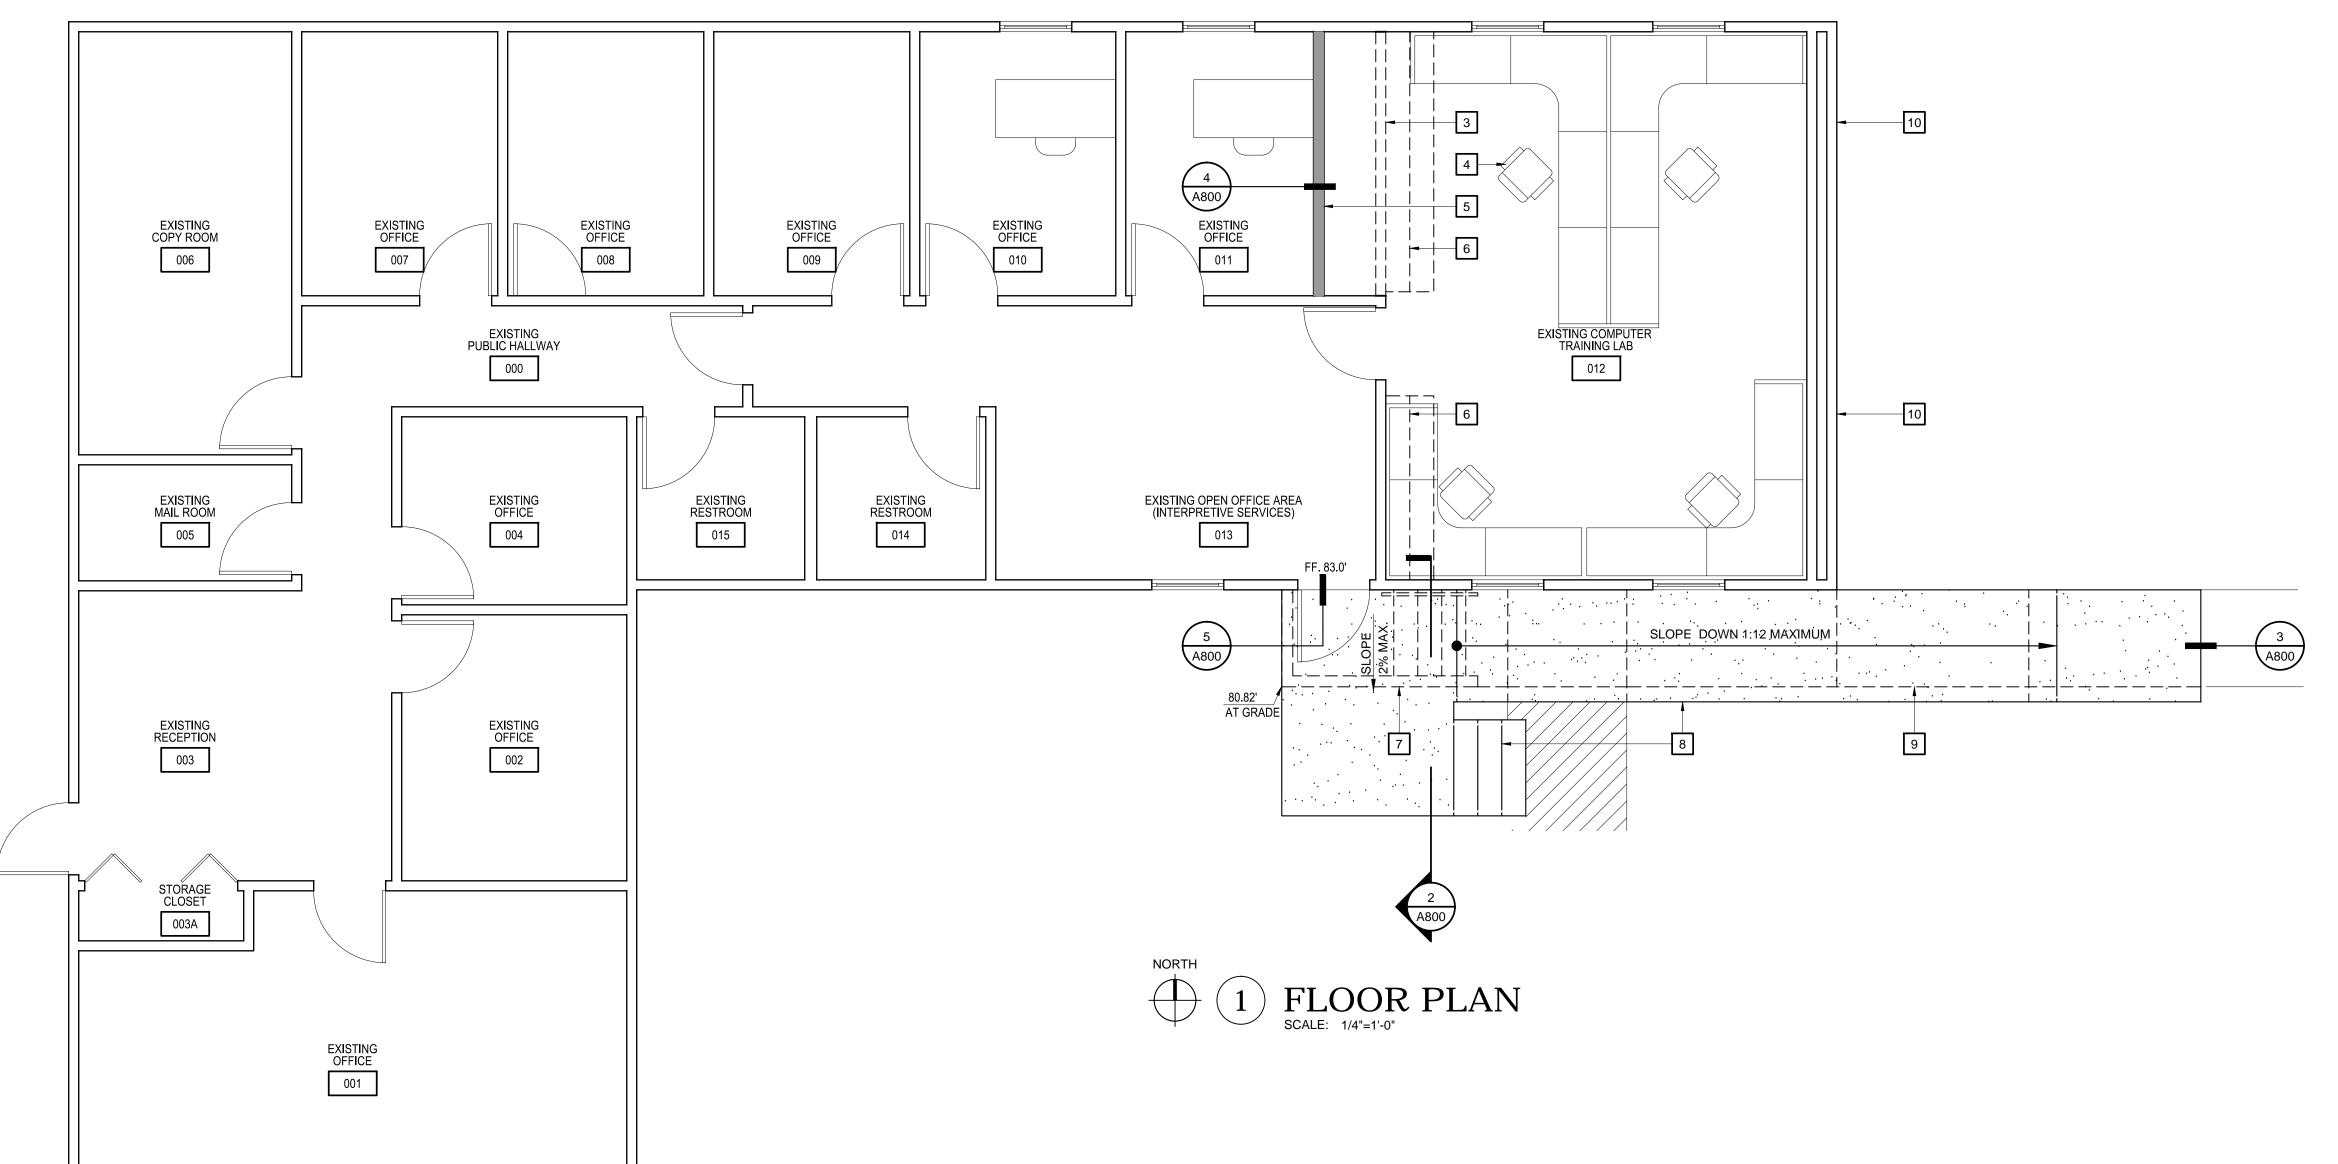


R.C.P. LEGEND

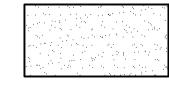

NEW GYPSUM BOARD SOFFIT / CEILING

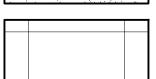

EXISTING SUSPENDED 24" x 48" T-BAR ACOUSTICAL CEILING TILE TO REMAIN, REPAIR GRID AND REPLACE AL TILES AFFECTED BY NEW CONSTRUCTION

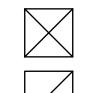

EXISTING SUPPLY DIFFUSER TO REMAIN - SHOWN FOR REFERENCE ONLY



EXISTING 24" x 48" FLORESCENT LIGHT FIXTURE TO REMAIN - SHOWN FOR REFERENCE ONLY.

R.C.P. GENERAL NOTES

- ELECTRICAL, MECHANICAL, AND PLUMBING ELEMENTS ARE SHOWN FOR REFERENCE ONLY.
- 2. ALL NEW INTERIOR WALLS TO RECEIVE SOUND BATT INSULATION ALONG FULL HEIGHT OF WALL, WITH NEW INSULATION ADDED ABOVE CEILING AT A MINIMUM OF 48" AT EACH SIDE OF EACH NEW WALL.
- CONTRACTOR SHALL PROVIDE BACKING / BLOCKING FOR ALL CEILING MOUNTED EQUIPMENT AS REQUIRED.
- 4. ALL PENETRATIONS AT WALLS THAT HAVE SOUND INSULATION SHALL BE SEALED WITH NON-HARDENING ACOUSTICAL SEALANT.

KEY NOTES

THE KEY NOTES THAT FOLLOW APPLY TO THE DRAWING(S) ON THIS SHEET ONLY. REFER TO FOLLOWING SHEETS FOR NOTES THAT ARE APPLICABLE TO THOSE DRAWINGS.

NEW GYPSUM BOARD SOFFIT, REFER TO DETAIL $\frac{4}{A800}$

2 RELOCATED HVAC RETURN, SEE MECHANICAL

MECHANICAL DRAWINGS

- EXISTING WALL TO BE REMOVED. PATCH AND REPAIR ALL ADJACENT SURFACES
- FURNITURE SHOWN FOR REFERENCE ONLY, NOT IN CONTRACT

OPTION TO RETAIN OWNERSHIP OF REMOVED CABINETRY.

- NEW METAL STUD WALL WITH GYP. BOARD, FINISHED AND PAINTED TO MATCH EXISTING ADJACENT SURFACES. SEE FLOOR PLAN LEGEND AND DETAIL

 REMOVE EXISTING UPPER AND LOWER CABINETS AND PATCH AND
- CONTRACTOR TO REMOVE AND LEGALLY DISPOSE OF EXISTING WOOD STAIR STRUCTURE IN ITS ENTIRETY (AS INDICATED BY DASHED LINES)

REPAIR EXISTING WALL(S) WHERE OCCUR. PROVIDE OWNER WITH

- STRUCTURE IN ITS ENTIRETY (AS INDICATED BY DASHED LINES)

 NEW STAIR AND RAMP, REFER TO DETAIL SHEET A800
- 9 REMOVE PORTIONS OF EXISTING CONCRETE WALKWAY AS REQUIRED TO ACCOMODATE NEW RAMP APPROXIMATE LOCATION OF REPLACEMENT END WALL HVAC UNITS, SEE

WALD RUHNKE & DOST

2340 GARDEN ROAD, SUITE 100 MONTEREY, CALIFORNIA 93940

FAX: 831.649.3530


PHONE: 831.649.4642

WWW.WRDARCH.COM

THE USE OF THE PLANS AND SPECIFICATIONS IS RESTRICTED TO THE ORIGINAL SITE FOR WHICH THEY WERE PREPARED, AND PUBLICATION THEREOF IS EXPRESSLY LIMITED TO SUCH USE. REUSE, REPRODUCTION OR PUBLICATION BY ANY METHOD IN WHOLE OR IN PART IS PROHIBITED. TITLE TO THE PLANS AND SPECIFICATIONS REMAINS WITH THE ARCHITECT, AND VISUAL CONTACT WITH THEM CONSTITUTES PRIMA FACIE EVIDENCE OF THE ACCEPTANCE OF THESE RESTRICTIONS.

Matividad

MEDICAL CENTER

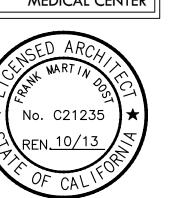

. 003-851-018

870)

A.P.N. NO.: 003-

DAD MEDICAL CENTER
ED CARE T.I. (BUILDINC

 \mathbf{Z}

JOB NO.: 12188

SET ISSUED:

PRINT DATE:

PLOT DATE: 5.30.2013

DRAWN BY: JOB

CHECKED BY: C.IED

PERMIT SUBMITTAL 5.30.2013

SHEET NAME:


FLOOR PLAN & PARTIAL REF.
CEILING PLAN

SHEET NO.:

A230

FILE NAME: 12


FLOOR PLAN LEGEND

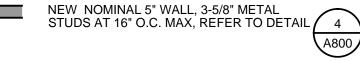


EXISTING WALL, 2X6 WOOD STUD FRAMING AT 16" O.C.

FLOOR PLAN GENERAL NOTES

- 1. ALL DIMENSIONS ARE TO FACE OF FINISH U.O.N.
- 2. CONTRACTOR SHALL PROVIDE BACKING / BLOCKING FOR ALL WALL MOUNTED ITEMS AS REQUIRED, INCLUDING FOR FULL HEIGHT ADJUSTABLE SHELVING .
- 3. ALL PENETRATIONS AT WALLS THAT HAVE SOUND INSULATION SHALL BE SEALED WITH NON-HARDENING ACOUSTICAL SEALANT.

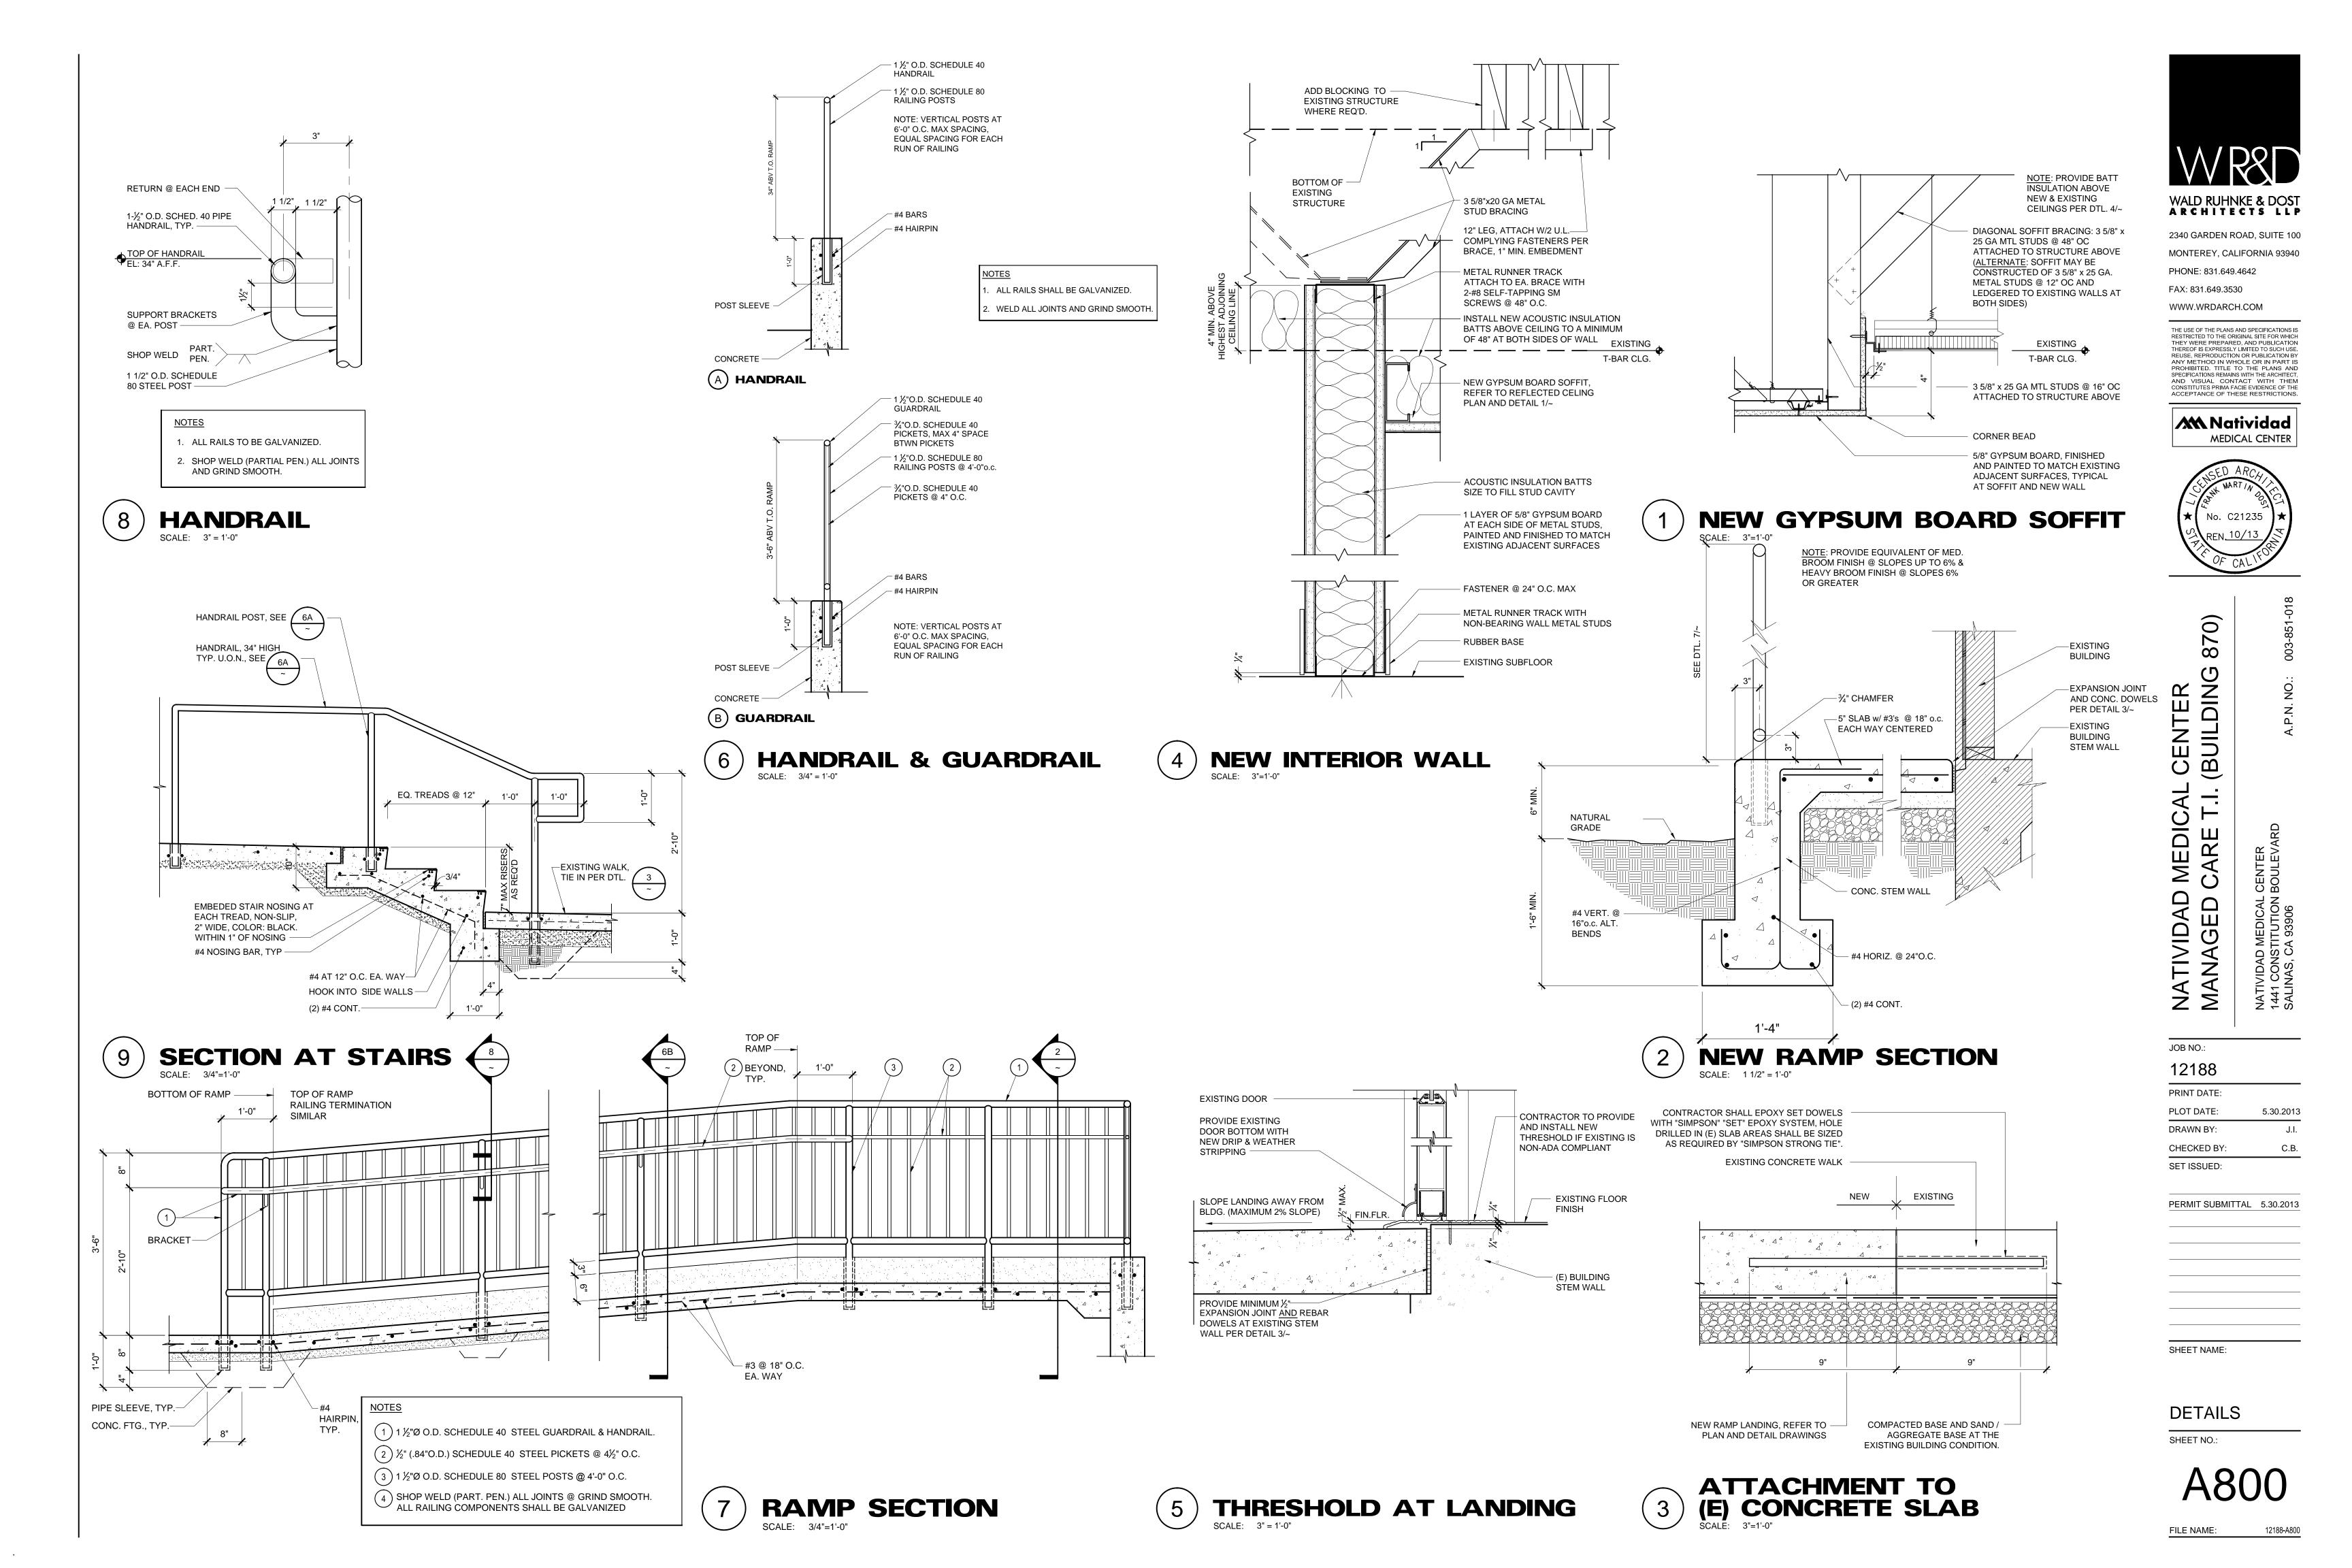

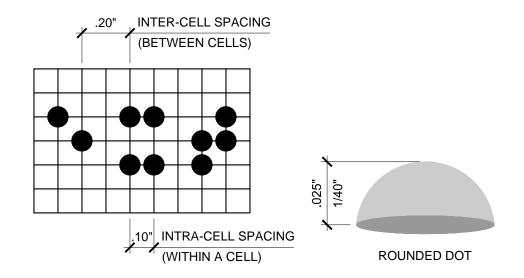


VERT. OR HORIZ.

- (A) BRAILLE CELL SPACING (B) BRAILLE DOT
 - PER 2010 CBC, BRAILLE SHALL CONFORM TO THE FOLLOWING:

1. BRAILLE CHARACTERS: CONTRACTED GRADE 2 BRAILLE.

- 2. CALIFORNIA SPACING: DOTS ARE 1/10" O.C. IN EA. CELL WITH 2/10" SPACE BETWEEN CELLS MEASURED FROM THE SECOND COLUMN OF DOTS IN THE FIRST CELL TO THE FIRST COLUMN OF DOTS IN THE SECOND CELL.
- 3. CHARACTER THICKNESS & SHAPE: DOTS SHALL BE RAISED 1/40" MIN. ABOVE BACKGROUND AND SHALL BE DOMED.
- (C) BRAILLE CHARACTER NOTES

CONTRACTED **GRADE 2 BRAILLE**

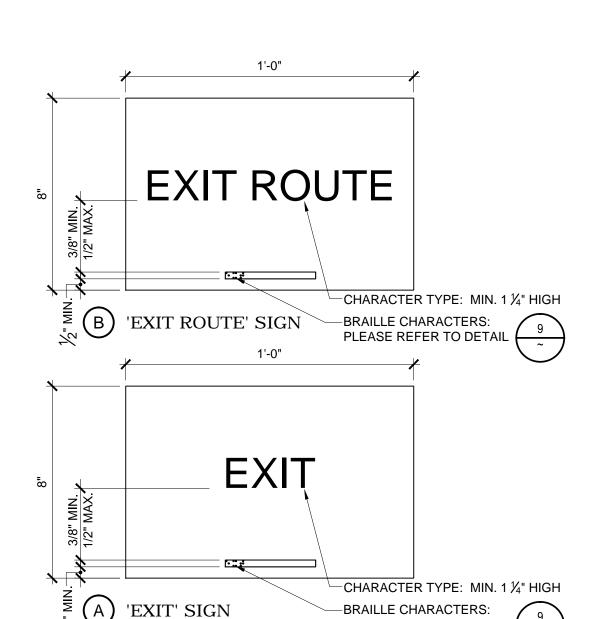

PLEASE REFER TO DETAIL (NOTE: PROVIDE SIGNS WHERE INDICATED ON PLANS; LOCATE CENTERLINE OF EA. SIGN 9" MAX. AWAY FROM DOOR STRIKE SIDE. TACTILE CHARACTERS ON SIGNS SHALL BE LOCATED 48 INCHES (1220 MM) MINIMUM ABOVE THE FINISH FLOOR OR GROUND SURFACE, MEASURED FROM THE BASELINE OF THE LOWEST TACTILE CHARACTER AND 60 INCHES (1525 MM) MAXIMUM ABOVE THE FINISH FLOOR OR GROUND SURFACE, MEASURED FROM THE BASELINE OF THE HIGHEST TACTILE CHARACTER.

EXIT SIGNAGE
SCALE: 3" = 1'-0"

FULL SIDE - - -

A) EXTERIOR DOOR

5'-0" MIN.


REQ'D CLR.

DOOR CLEARANCES

ISPACE ____

(B) INTERIOR DOOR

REQUIRED ACCESSIBLE MOUNTING HEIGHTS

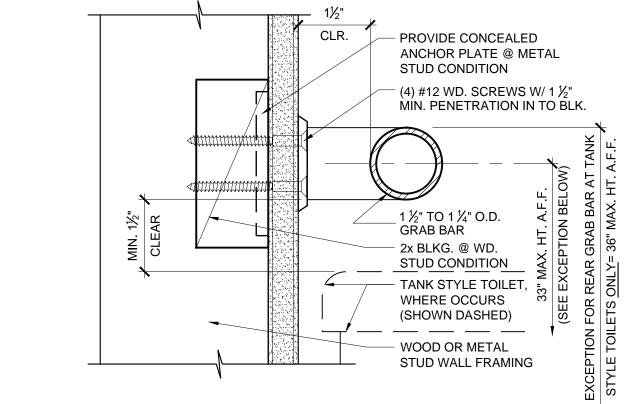

GRAB BAR

PROVIDE 42" BAF

(36" MIN. REQ'D)

2'-6½" 17½" (24" MIN. REQ'D)±½" MAX

5'-2" CLR. (60" MIN. REQ'D)

AT REAR WALL (NO SINKS)

ADDITIONAL

IS EQUIPPED

W/ BOTH A

LATCH AND A

CLOSER

SPACE IF DOOR

2% MAX. SLOPE IN

ANY DIRECTION, TYP.

BEHIND WC

ACCESSIBLE TOILET

54" MIN.

12" PROVIDE 48" GRAB BAR

(42" MIN. REQ'D)

2'-6"

(24" MIN. REQ'D)

4'-2" CLR.


(48" MIN. REQ'D)

GRAB BAR

SCALE: 6" = 1'-0"


WALL MOUNTED SIGNAGE TO BE LOCATED ALONGSIDE THE DOOR AT THE LATCH SIDE. WHERE THERE IS NO WALL SPACE AT THE LATCH SIDE OF A SINGLE DOOR, SIGN SHALL BE LOCATED ON THE NEAREST ADJACENT WALL. SIGNS CONTAINING TACTILE CHARACTERS SHALL BE LOCATED SO THAT A CLEAR FLOOR SPACE OF 18 INCHES MINIMUM BY 18 INCHES MINIMUM, CENTERED

ON THE TACTILE CHARACTERS, IS PROVIDED BEYOND THE ARC OF ANY DOOR SWING BEYOND THE CLOSED RAISED 1 / 32" POSITION AND 45° OPEN POSITION. **HEIGHT OF** LETTERING 5/8" MIN. TO 2" UPPERCASE CHARACTERS

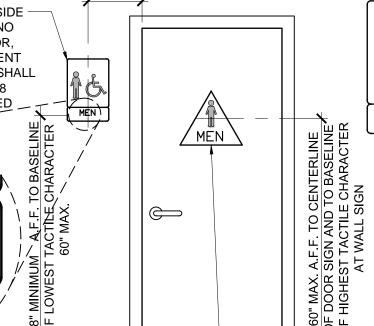


CONTRACTED GRADE 2

BRAILLE CENTERED ON

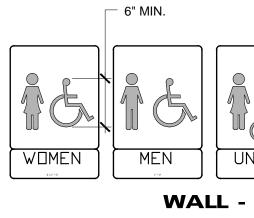






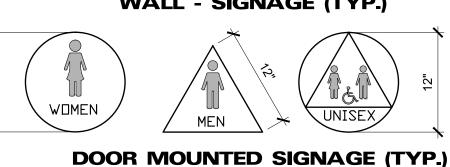



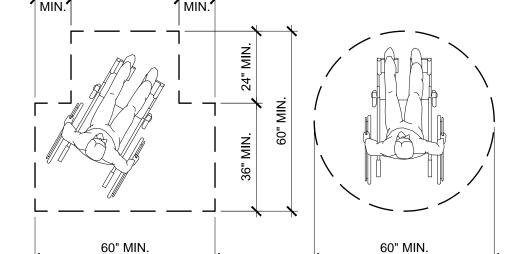

IDENTIFICATION SYMBOL AT SANITARY FACILITIES

SCALE: 3/8"=1'-0"

DOOR - MOUNTED

SIGNAGE



ACCESSIBLITY NOTES

A. GENERAL

I. All dimensions and clearances within restroom areas shown on details are to be measured from finished surfaces.

2. Doorways leading to men's sanitary facilities shall be identified by an equilateral triangle ¼" thick with edges 12" long and a vertex pointing upward. Women's sanitary facilities shall be identified by a circle $\frac{1}{2}$ " thick and $\frac{1}{2}$ " in diameter.

3. Unisex sanitary facilities shall be identified by a circle ¼" thick, 12" diameter, with a ¼" thick triangle superimposed within the circle. 4. Where a tactile sign is provided at a door, the sign shall be located alongside the door at the latch side. Where a tactile sign is provided at double doors with one active leaf, the sign shall be installed on the wall adjacent to the latch outside of the door. Where a tactile sign is provided at double doors with two active leafs, the sign shall be located to the right of the right hand door. Where there is no wall space at the latch side of a single door or at the right side of double doors, signs shall be located on the nearest adjacent wall. Signs containing tactile characters shall be located so that a clear floor space of 18" min. by 18" min., centered on the tactile characters, is provided beyond the arc of any door swing between the closed position and 45 degree open position. Tactile characters on signs shall be located 48" min. above the finish floor or ground surface, measured from the baseline of the lowest tactile

character and 60" max. above the finish floor or ground surface, measured from the baseline of the highest tactile character 5. There shall be sufficient space in the toilet room for a wheelchair measuring 30" wide by 48" long to enter the room and permit the door to close.

6. There shall be in the room a clear floor space of at least 60" in diameter, or a T-shaped space. No door shall encroach into this space for more than 12".

. The water closet shall be located in a space 60" min. clear in width. The side shall provide a minimum of 17" and a maximum of 18" from the center line of the water closet to the adjacent wall. A minimum 48"x60" clear floor space shall be provided in front of the water closet. Provide a minimum 60"x56" clear floor space around water closet. No fixture (including sinks) shall obstruct this clear floor space at the water closet.

8. In other than dwelling units, toilet rooms floors shall have a smooth, hard, non-absorbant surface such as portland cement, concrete ceramic tile or other approved material which extends upward onto the walls at least 5 inches. Walls within water closet compartments shall be similarly finished to a height of 48 inches.

B. SANITARY FACILITY FIXTURES & ACCESSORIES

1. A minimum of 30"x48" clear space is provided in front of lavatory allowing foward approach.

2. Lavatory faucets are lever type, push type or electronic control mechanisim valves that are operable with one hand and do not require tight grasping, pinching or twisting of the wrist. Self closing valves shall maintain a minimum of 10 second open flow of 5 lbs.

3. Lavatories adjacent to a wall shall be mounted with a minimum distance of 18" to the center line of the fixture.

4. All lavatories that are designed to be accessible shall be mounted with the rim or counter edge no higher than 34" above the finished floor and vertical clearance measured from the bottom of the apron or outside bottom edge of the lavatory of 29" reducing to 27" at a point located 8" back from edge. Toe clearance under lavatory is under 9" high, 30" wide and extends a minimum of 17" in

5. All piping under lavatories shall be configured, insulated or otherwise covered to prevent contact. There shall be no sharp or

6. Controls for water closet flush valves shall be mounted on the wide side of toilet areas and shall require 5 lbs. maximum pressure

7. Water closet and urinal flush valves controls and faucet and operating mechanism controls, shall be operable with one hand, shall not require tight grasping, pinching, or twisting of the wrist, and shall be mounted no more than 44" above the floor.

8. Mirrors shall be mounted with the bottom of the reflective surface no higher than 40" from the finished floor elevation. 9. Where towels, sanitary napkins, waste receptacles, and other similar dispensing and disposal fixtures are provided, at least one of each type shall be located with all operable parts, including coin slots, within 40" from the finished floor.

10. Toilet tissue dispensers that control delivery or that do not permit continuous paper flow shall not be used. Dispenser is to be located within 7"-9" of the front edge of the toilet seat to the centerline of the dispenser with 19" min. height from floor to center line of dispenser (below grab bar).

11. The top of the toilet seat 17" to 19" from floor surface measured to the top of a maximum 2" high toilet seat. C. GRAB BARS


I. Grab bars shall be located on each side, or on one side and the back of the accessible toilet stall or compartment.

2. Grab bars at the side shall be with the front end positioned 24" in front of the water closet stool and with the back end positioned no more than 12" from the rear wall.

3. Grab bars shall be securely attached 33" above and parallel to the floor, except that where a tank-type toilet is used which obstructs placement at 33", the grab bar may be as high as 36".

4. The diameter or width of the gripping surfaces of a grab bar shall be 1-1/4" to 1-1/2" or the shape shall provide an equivalent gripping surface. If grab bars are mounted adjacent to a wall, the clearance between the wall and the grab bars shall be 1-1/2".

5. No protruding objects shall be mounted 12" above the grab bar or 1-1/2" below the grab bar.

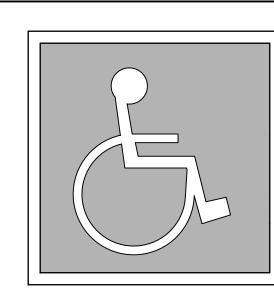


INTERNATIONAL SYMBOL OF ACCESSIBILITY

1. MINIMUM 5"x5" DECAL TO BE LOCATED AT EACH PRIMARY PUBLIC ENTRANCE AND AT EVERY MAJOR EXTERIOR JUNCTION ALONG OR LEADING TO AN ACCESSIBLE ROUTE OF TRAVEL.

2. MINIMUM 36"x36" PAINTED SYMBOL ON PAVEMENT SHALL BE LOCATED IN STALL SO THAT IT IS VISIBLE BY A TRAFFIC ENFORCEMENT OFFICER WHEN A VEHICLE IS PROPERLY PARKED IN THE SPACE. (CENTERED AT STALL ENTRANCE RECOMMENDED)

3. BACKGROUND TO BE BLUE, WHEELCHAIR SYMBOL TO BE WHITE (TYPICAL).



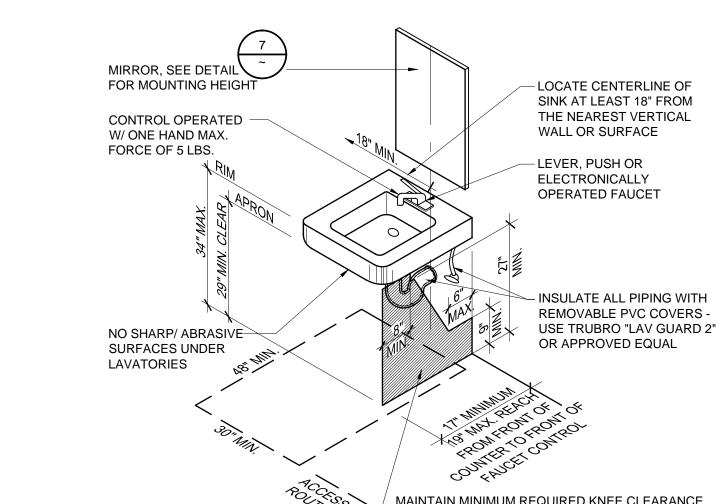

SINK CLEARANCES
SCALE: N.T.S.



2340 GARDEN ROAD, SUITE 100 MONTEREY, CALIFORNIA 93940

FAX: 831.649.3530 WWW.WRDARCH.COM

PHONE: 831.649.4642

RESTRICTED TO THE ORIGINAL SITE FOR WHICH THEY WERE PREPARED, AND PUBLICATION
THEREOF IS EXPRESSLY LIMITED TO SUCH USE REUSE, REPRODUCTION OR PUBLICATION B ANY METHOD IN WHOLE OR IN PART IS PROHIBITED. TITLE TO THE PLANS AND

SPECIFICATIONS REMAINS WITH THE ARCHITEC AND VISUAL CONTACT WITH THEM CONSTITUTES PRIMA FACIE EVIDENCE OF THE

ACCEPTANCE OF THESE RESTRICTIONS

0 ∞ ∞ 0

 ∞ AL CENTER BUILDING ∞

JOB NO.:

TIVIDAI 's FOR

12188 PRINT DATE: PLOT DATE: 6.1.2013 DRAWN BY: CHECKED BY: SET ISSUED:

SHEET NAME:

ACCESSIBILITY DETAILS

SHEET NO.:

NTERPRETATION OF REGULATIONS (IR 25-5) TITLE 21, TITLE 22 AND PARTS 2 OF TITLE 24, CCR)

IAXIMUM ALLOWABLE LOAD FOR 10 GAGE AND 12 GAGE WIRE

DESCRIPTION. "GALVANIZED SOFT ANNEALED MILD STEEL WIRE" AS USED IN SECTIONS 4701 (E), TITLE 24, CCR, WILL BE THE DESCRIPTION OF THIS WIRE.

BASIS OF DESIGN STRENGTH: BASED ON THE TESTS WHICH OSA/SSS HAS RECEIVED TO-DATE FOR THIS TYPE OF WIRE, AN ULTIMATE STRESS OF 60,000 PSI WILL BE USED FOR #10 GAGE AND #12 GAGE WIRE.

DESIGN VALUE. BASIS STRESS WILE BE THE ULTIMATE STRESS DIVIDED BY 2.5 OR 24,000 PSI. A 1/3 INCREASE FOR LATERAL FORCE WILL BE PERMITTED FOR A STRESS OF 32,000 PSI. USING THESE VALUES, NO TESTING OF WIRE IS NECESSARY.

DIAMETER OF WIRES. #10 WIRE IS 0.135" IN DIAMETER AND A #12 WIRE IS 0.1055" IN DIAMETER AS SHOWN BY THE U.S. STEEL WIRE GAGE.

ALLOWABLE LOAD. BASIC LOAD LATERAL LOAD (1/3 INCREASE)

#10 WIRE 343# #12 WIRE 209# 278#

FABRICATION. WHEN USING TWISTS ON WIRE TO DEVELOP THE MAXIMUM ALLOWABLE LOAD, USE MINIMUM OF 4 TWISTS WITHIN 1-1/2". THREE TWISTS MAY BE USED TO DEVELOP NOT MORE THAN ONE HALF THE ABOVE

THESE VALUES ARE FOR TENSION VALUES OF WIRE ONLY. TEARING OF THIN METAL BY WIRE MUST BE

IF THE SPECIFICATION REQUIRES A SPECIAL WIRE SUCH AS A WIRE MEETING FEDERAL SPECIFICATION FS-QQ-W261g, FINISH 5, CLASS 1, SOFT TEMPER WITH AN ULTIMATE STRESS OF 70,000 PSI FOR #10 WIRE & 75,000 PSI FOR #12 WIRE, A PROPORTIONATELY HIGHER ALLOWABLE MAY BE USED.

ETAL SUSPENSION SYSTEMS FOR LAY IN PANEL CEILINGS

REFERENCE: CALIFORNIA BUILDING CODE, SECTION 803.9 AND INTERPRETATION OF REGULATIONS (IR 25-5)

12 GA. (MIN.) HANGER WIRES SHALL BE USED FOR UP TO AND INCLUDING 4'-0"x4'-0" GRID SPACING AND SHALL BE ATTACHED TO MAIN RUNNERS.

PROVIDE #12 GA. HANGER WIRES AT THE ENDS OF ALL MAIN AND CROSS RUNNERS WITHIN 8" FROM THE SUPPORT OR WITHIN 1/4" OF THE LENGTH OF THE END TEE, WHICHEVER IS LEAST, FOR THE PERIMETER OF THE CEILING AREA. END CONNECTIONS FOR RUNNERS WHICH ARE DESIGNED AND DETAILED TO RESIST THE APPLIED VERTICAL AND HORIZONTAL FORCES MAY BE USED IN LIEU OF THE #12 GA. HANGER WIRES SUBJECT TO OSA/SSA REVIEW AND APPROVAL.

PROVIDE TRAPEZE OR OTHER SUPPLEMENTARY SUPPORT MEMBERS AT OBSTRUCTIONS TO MAINTAIN HANGER SPACING. PROVIDE ADDITIONAL HANGERS, STRUTS. HANGER WIRES THAT ARE MORE THAN 1 IN 6 OUT OF PLUMB ARE TO HAVE COUNTER-SLOPING WIRES.

CEILING GRID MEMBERS MAY BE ATTACHED TO NOT MORE THAN 2 ADJACENT WALLS. CEILING GRID MEMBERS SHOULD BE AT LEAST 3/4" FREE OF OTHER WALLS. IF WALLS RUN DIAGONALLY TO CEILING GRID SYSTEM RUNNERS, ONE END OF MAIN AND CROSS RUNNERS SHOULD BE FREE WITH A MINIMUM OF 3/4" CLEAR AT

AT THE PERIMETER OF THE CEILING AREA WHERE MAIN OR CROSS RUNNERS ARE NOT CONNECTED TO THE ADJACENT WALL, PROVIDE INTERCONNECTION BETWEEN THE RUNNERS AT THE FREE END TO PREVENT LATERAL SPREADING. A METAL STRUT OR A 16 GA. WIRE WITH A POSITIVE MECHANICAL CONNECTION TO THE RUNNER MAY BE USED. WHERE THE PERPENDICULAR DISTANCE FROM THE WALL TO THE FIRST PARALLEL RUNNER IS 12" OR LESS, THIS INTERLOCK IS NOT REQUIRED.

) PROVIDE LATERAL SUPPORT BRACING ASSEMBLIES CONSISTING OF COMPRESSION STRUCT AND FOUR (4) #12 GA. SPLAYED BRACING WIRES ORIENTED 90 DEGREES FROM EACH OTHER AT THE FOLLOWING SPACING

(A) PLACE BRACING ASSEMBLIES NOT MORE THAN 8' x 12' ON CENTER

(B) PROVIDE BRACING ASSEMBLIES AT LOCATIONS NOT MORE THAN ONE HALF (1/2) THE CALCULATED SPACINGS GIVEN ABOVE, FOR EACH PERIMETER WALL AND AT THE EDGE OF VERTICAL CEILING OFFSETS. THE SLOPE OF THESE WIRES SHOULD NOT EXCEED 45 DEGREES FROM A HORIZONTAL PLANE AND SHOULD BE TAUT. SPLICES IN BRACING WIRES ARE NOT TO BE PERMITTED.

(C) THE MAXIMUM SLENDERNESS RATIO (kL/R) OF THE COMPRESSION STRUCT IS 200 OR LESS.

FASTEN #12 HANGER WIRES WITH NOT LESS THAN 3 TIGHT TURNS. FASTEN #10 OR #12 BRACING WIRES WITH 4 TIGHT TURNS. MAKE ALL TIGHT TURNS WITHIN A DISTANCE OF 1 1/2". HANGER OR BRACING WIRE ANCHORS TO THE STRUCTURE SHOULD BE INSTALLED IN SUCH A MANNER THAT THE DIRECTION OF THE WIRE ALIGNS AS CLOSELY AS POSSIBLE WITH THE DIRECTION OF THE FORCES ACTION ON THE WIRE.

SEPARATE ALL CEILING HANGING AND BRACING WIRES AT LEAST SIX INCHES (6") FROM ALL UNBRACED DUCTS, PIPES, CONDUIT, ETC.

WHEN DRILLED IN CONCRETE ANCHORS OR SHOT IN ANCHORS ARE USED IN REINFORCED CONCRETE FOR HANGER WIRES , 1 OUT OF 10 MUST BE FIELD TESTED FOR 200 POUNDS OF TENSION. WHEN DRILLED IN CONCRETE ANCHORS ARE USED FOR BRACING WIRES , 1 OUT OF 2 MUST BE FIELD TESTED FOR 440 POUNDS IN TENSION. SHOT IN ANCHORS IN CONCRETE ARE NOT PERMITTED FOR BRACING WIRES. IF ANY SHOT IN OR DRILLED IN ANCHOR FAILS, ALL ADJACENT ANCHORS MUST BE TESTED.

NOTE: DRILLED IN OR SHOT IN ANCHORS REQUIRED SPECIAL STATE APPROVAL WHEN USED IN PRESTRESSED

) ATTACH ALL LIGHT FIXTURES TO THE CEILING GRID RUNNERS TO RESIST A HORIZONTAL FORCE EQUAL TO THE WEIGHT OF THE FIXTURES.

FLUSH OR RECESSED LIGHT FIXTURES AND MECHANICAL TERMINALS OR SERVICES WEIGHING LESS THAN 20 POUNDS MAY BE SUPPORTED DIRECTLY ON THE RUNNERS OF A HEAVY DUTY GRID SYSTEM BUT, IN ADDITION THEY MUST HAVE MINIMUM OF TWO 12 GA. SLACK SAFETY WIRES ATTACHED TO THE FIXTURE AT DIAGONAL CORNERS AND ANCHORED TO THE STRUCTURE ABOVE. ALL 4' x 4' LIGHT FIXTURES MUST HAVE SLACK SAFETY WIRES AT EACH CORNER.

ALL FLUSH OR RECESSED LIGHT FIXTURES WEIGHING 56 POUNDS AND MECHANICAL TERMINALS OR SERVICES WEIGHING 20 LBS. OR MORE MUST BE INDEPENDENTLY SUPPORTED BY NOT LESS THAN FOUR (4) TAUT #12 GA. WIRES EACH ATTACHED TO THE FIXTURES AND TO THE STRUCTURE ABOVE, REGARDLESS OF THE TYPE OF CEILING GRID SYSTEM USED. THE FOUR (4) TAUT 12 GA. WIRES INCLUDING THEIR ATTACHMENT TO THE STRUCTURE ABOVE MUST BE CAPABLE OF SUPPORTING 4 TIMES THE WEIGHT OF THE UNIT.

SUPPORT SURFACE MOUNTED LIGHT FIXTURES BY AT LEAST TWO POSITIVE DEVICES WHICH SURROUND THE CEILING RUNNER AND WHICH ARE EACH SUPPORTED FROM THE STRUCTURE ABOVE BY A #12 GA. WIRE. SPRING CLIPS OR CLAMPS THAT CONNECT ONLY TO THE RUNNER ARE NOT ACCEPTABLE. PROVIDE ADDITIONAL SUPPORTS WHEN LIGHT FIXTURES ARE 8 FT. OR LONGER.

) THE CEILING GRID SYSTEM MUST BE RATED AS 'HEAVY DUTY' AS DEFINED BY ASTM C635.


ESSENTIAL SERVICES BUILDINGS: IN EXITWAYS A MAIN OR CROSS RUNNER SHALL BE INSTALLED ON ALL SIDES OF EACH PIECE OF TILE, BOARD, OR PANEL AND EACH LIGHT FIXTURE OR GRILL. SPLICES OR INTERSECTIONS OF SUCH RUNNERS SHALL BE ATTACHED WITH THROUGH CONNECTORS SUCH AS POP RIVETS, SCREWS, PINS, PLATES WITH END TABS OR OTHER APPROVED CONNECTORS.

SUSPENDED ACOUSTICAL CEILING SYSTEMS WITH A CEILING AREA OF 144 SQUARE FEET OR LESS. SURROUNDED BY WALLS WHICH CONNECT DIRECTLY TO THE STRUCTURE ABOVE OR WALLS INDEPENDENTLY BRACED ABOVE CEILING TO STRUCTURE ABOVE DO NOT REQUIRE BRACING ASSEMBLIES WHEN ATTACHED TO TWO ADJACENT WALLS.


PARTITIONS. NON BEARINGS PARTITIONS THAT EXTEND TO AND TERMINATE AT A SUSPENDED CEILING, AND ARE SUPPORTED LATERALLY BY AN ADEQUATE BRACING SYSTEM OF SPLAYED WIRES SPACED NOT MORE THAN 8 FT. ON CENTER ALONG THE TOP EDGE OF THE PARTITION OR BY OTHER EQUIVALENT MEANS MAY BE CONSIDERED AS NOT ADDING TO THE LATERAL LOAD REQUIRED TO BE RESISTED BY THE CEILING SYSTEM.

B) ALL FIELD TESTS MUST BE PERFORMED IN THE PRESENCE OF THE PROJECT INSPECTOR OF RECORD.




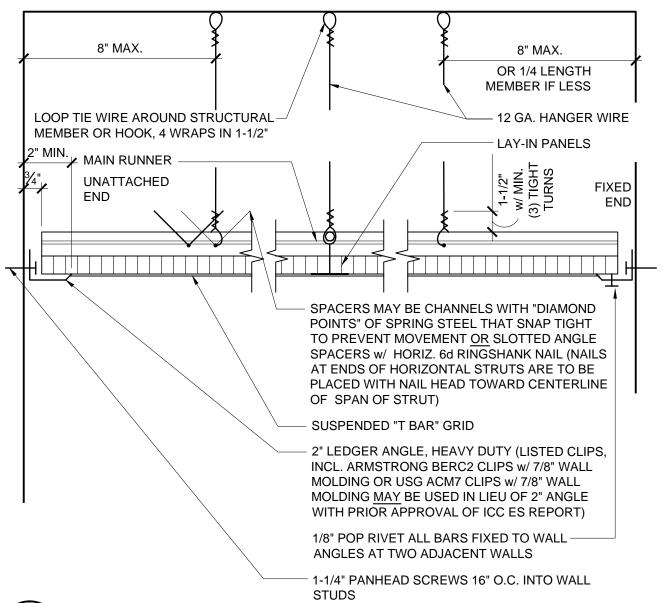


SUSPENDED CEILING

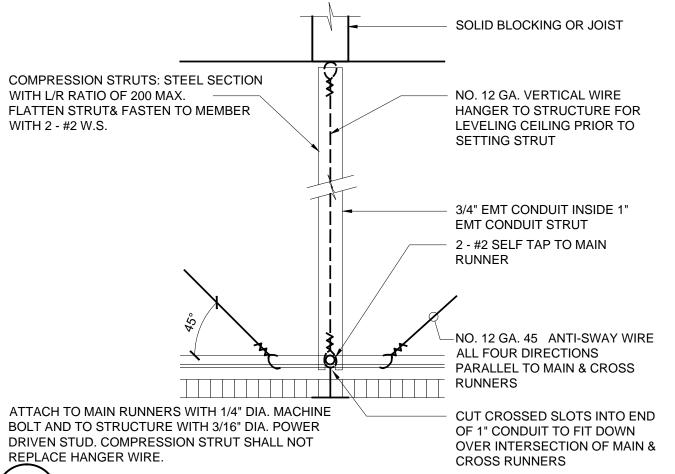

COMPRESSION STRUT

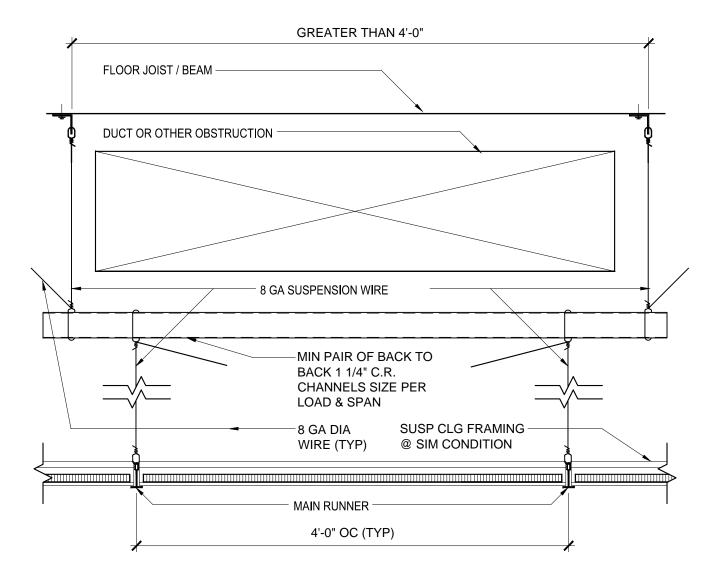



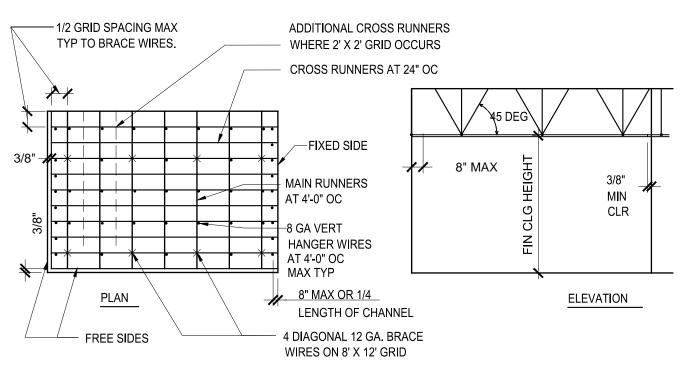

CBC SECTION 803.9.1.1, 1613.1 & ASCE 7-05 13.5.6.2.2:


1. VERTICAL STRUT: A STRUT FASTENDED TO THE MAIN RUNNER SHALL BE EXTENDED TO AND FASTENED TO THE STRUCTURAL MEMBERS SUPPORTING THE FLOOR ABOVE. THE STRUT SHALL BE ADEQUATE TO RESIST THE VERTICAL COMPONENT INDUCED BY THE BRACING BRACING WIRES. THE STRUT MAY BE STEEL STUD, BLACK IRON, EMT OR OTHER APPROVED EQUAL. (GOOD FOR UP TO 4'-0" HIGH). STRUTS AND ASSOCIATED LATERAL BRACING SHALL BE PLACED IN 12'-0" X 12'-0" GRID WITH THE FIRST POINT WITHIN 6'-0" FROM EA. WALL. 2. A HEAVY TYPE OF T-BAR CEILING SHALL BE USED.


3. THE WIDTH OF PERIMETER CLOSURE ANGLE SHALL BE 2" MINIMUM IN WIDTH. IN EACH ORTHOGONAL HORIZONTAL DIRECTION, ONE END OF CEILING GRID SHALL BE ATTACHED TO THE CLOSURE ANGLE. THE OTHER END IN EACH HORIZONTAL DIRECTION SHALL HAVE A MINIMUM 0.75" CLEARANCE FROM THE WALL AND SHALL REST UPON AND BE FREE TO SLIDE ON A CLOSURE ANGLE.

4. FOR CEILINGS WITHOUT RIGID BRACING, SPRINKLER HEAD PENETRATION SHALL HAVE A 2' OVERSIZE RING, SLEEVE OR ADAPTER THROUGH THE CEILING TILE TO ALLOW FREE MOMENT OF AT LEAST 1" IN ALL HORIZONTAL DIRECTIONS.

T-BAR SEISMIC GRID SUSPENSION DIAGRAM

HORIZONTAL RESTRAINTS SHALL BE EFFECTED BY FOUR NO. 12 GAUGE WIRES SECURED TO THE MAIN RUNNER WITHIN 2" OF THE CROSS RUNNER INTERSECTION AND SPLAYED 90° FROM EACH OTHER AT AN ANGLE NOT EXCEEDING 45° FROM THE PLANE OF THE CEILING. THE STRUT SHALL BE ADEQUATE TO RESIST THE VERTICAL COMPONENT INDUCED BY THE BRACING WIRES. THESE HORIZONTAL RESTRAINT POINTS SHALL BE PLACED 12' ON CENTER IN BOTH DIRECTIONS WITH THE FIRST POINT WITHIN 6' FROM EACH WALL. ATTACHMENT OF THE

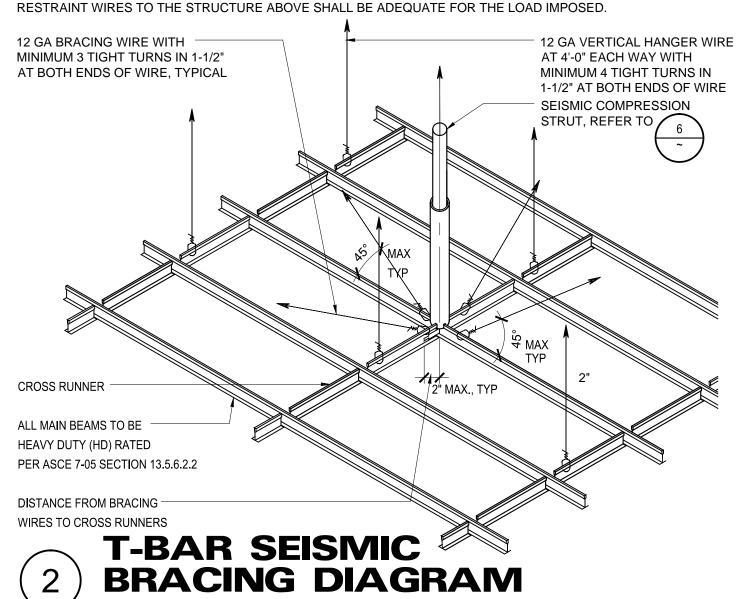

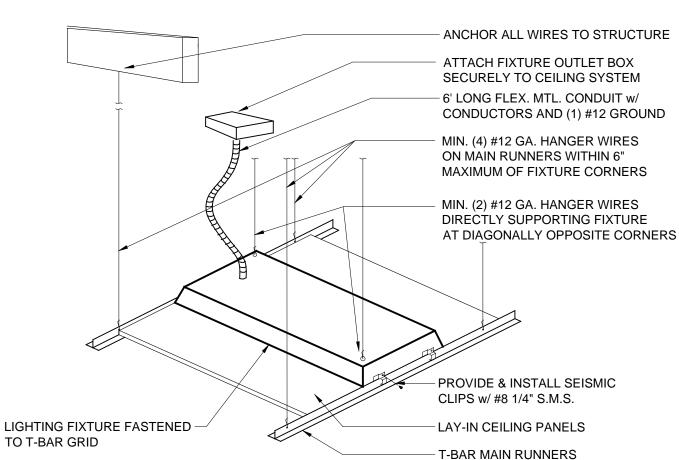

DETAIL '4' NOT USED

LIGHT FIXTURE SUPPORT



2340 GARDEN ROAD, SUITE 100 MONTEREY, CALIFORNIA 93940 PHONE: 831.649.4642

FAX: 831.649.3530 WWW.WRDARCH.COM

RESTRICTED TO THE ORIGINAL SITE FOR WHICH THEY WERE PREPARED, AND PUBLICATION
THEREOF IS EXPRESSLY LIMITED TO SUCH USE REUSE REPRODUCTION OR PUBLICATION B ANY METHOD IN WHOLE OR IN PART IS PROHIBITED. TITLE TO THE PLANS AND SPECIFICATIONS REMAINS WITH THE ARCHITEC AND VISUAL CONTACT WITH THEM CONSTITUTES PRIMA FACIE EVIDENCE OF THE ACCEPTANCE OF THESE RESTRICTIONS.

 ∞ **UILDING** $\mathbf{\Omega}$ DIC . 5 8 D ME MOD TIVIDAI 's FOR

0

∞

0

JOB NO.: 12188 PRINT DATE: PLOT DATE: 6.1.2013 CHECKED BY:

SET ISSUED:

CEILING **DETAILS**

SHEET NAME:

SHEET NO.:

	HEAT PUMPS																	
MARK	LOCATION	COOL TC	MBH SC	HEAT KW		TOTAL	CFM ESP	OA	FAN RPM	M HP	OTOR V/PH	MCA MOCP	WT LBS	EER SEER	СОР	MAKE	& MODEL	REMARKS
											,							·
																		1
																		•
																		•
WMHP-1	MANAGED CARE	34.6	26.1	3.1	28.5	800	.3"	X	1100	1/3	208/1	55 60	400	9.0	2.7		BARD, HA05VP4	2
WMHP-2	MANAGED CARE	16.4	12.9	1.6	13.8	780	.3"	Х	1100	1/6	208/1	37 40	360	9.5 -	2.5		BARD, HA04VP4	2
WMHP-3	MANAGED CARE	16.4	12.9	1.6	13.8	780	.3"	Х	1100	1/6	208/1	37 40	360	9.5 -	2.5		BARD, HAO4VPA	2

1) PACKAGED ROOFTOP MOUNTED HEAT PUMP

2 WALL MOUNTED PACKAGED HEAT PUMP

SYMBOL	ABBRV.	IDENTIFICATION	ABBRV.	IDENTIFICATION
		AIR DUCT	HP	HORSEPOWER
	BD	BALANCING DAMPER	LBS	POUNDS
		AIR FROM DEVICE	MAX	MAXIMUM
<u> </u>		AIR TO DEVICE	MBH	1000 BTU PER HOUR
		SECTION THROUGH SUPPLY	MECH	MECHANICAL
		SECTION THROUGH RETURN	MFR	MANUFACTURER
		SECTION THROUGH EXHAUST	MIN	MINIMUM
•		THERMOSTAT	(N)	NEW
√ F/D	F/D	VERTICAL FIRE DAMPER	OA	OUTSIDE AIR
BT		BYPASS TIMER	OBD	OPPOSED BLADE DAMPER
•	P.O.C.	POINT OF CONNECTION	ОС	ON CENTER
	°F	DEGREES FAHRENHEIT	OD	OUTSIDE DIAMETER
	AFUE	ANNUAL FUEL UTILIZATION EFFICIENCY	OV	OUTLET VELOCITY
	ARCH	ARCHITECT/ARCHITECTURAL	PC	PLUMBING CONTRACTOR
	BLDG	BUILDING	PD	PRESSURE DROP
	BTUH	BRITISH THERMAL UNITS PER HOUR	PH	PHASE
	CFM	CUBIC FEET PER MINUTE	RA	RETURN AIR
	CLG	CEILING	RM	ROOM
	CONN	CONNECTION	RPM	REVOLUTIONS PER MINUTE
	CONT	CONTINUED, CONTINUATION	SA	SUPPLY AIR
	COORD	COORDINATE	SC	SENSIBLE COOLING
	DN	DOWN	TV	TURNING VANES
	DWGS	DRAWINGS	TYP	TYPICAL
	(E)	EXISTING	V	VOLT
	EER	ENERGY EFFICIENCY RATIO	W/	WITH
	ESP	EXTERNAL STATIC PRESSURE	WT	WEIGHT
		CEILING DIFFUSER — ONE, TWO, THREE AND FOUR WAY THROW ——		REGISTER NECK SIZE AND MARK DESIGN CFM PANEL AT T-BAR CEILIN

AE Project #: 20130060

AXIOM ENGINEERS

LEE & ASSOCIATES
CONSULTING ENGINEERS

22 Lower Ragsdale Dr., Suite A Monterey, California 93940-5788

email: mail@axiomengineers.com

NATIVIDAD MEDICAL CENTER T.I. FOR BUILDING

WALD RUHNKE & DOST ARCHITECTS LLP

2340 GARDEN ROAD, SUITE 100 MONTEREY, CALIFORNIA 93940

THE USE OF THE PLANS AND SPECIFICATIONS IS RESTRICTED TO THE ORIGINAL SITE FOR WHICH THEY WERE PREPARED, AND PUBLICATION THEREOF IS EXPRESSLY LIMITED TO SUCH USE. REUSE, REPRODUCTION OR PUBLICATION BY ANY METHOD IN WHOLE OR IN PART IS PROHIBITED. TITLE TO THE PLANS AND SPECIFICATIONS REMAINS WITH THE ARCHITECT, AND VISUAL CONTACT WITH THEM CONSTITUTES PRIMA FACIE EVIDENCE OF THE ACCEPTANCE OF THESE RESTRICTIONS.

M Natividad

870

MEDICAL CENTER

PHONE: 831.649.4642

WWW.WRDARCH.COM

FAX: 831.649.3530

JOB NO.:


12188 PRINT DATE:

PLOT DATE: 05/31/2013 DRAWN BY: CADD CHECKED BY: WME

SET ISSUED:

SHEET NAME:
SCHEDULES, LEGENDS AND NOTES -MECHANICAL

SHEET NO.:

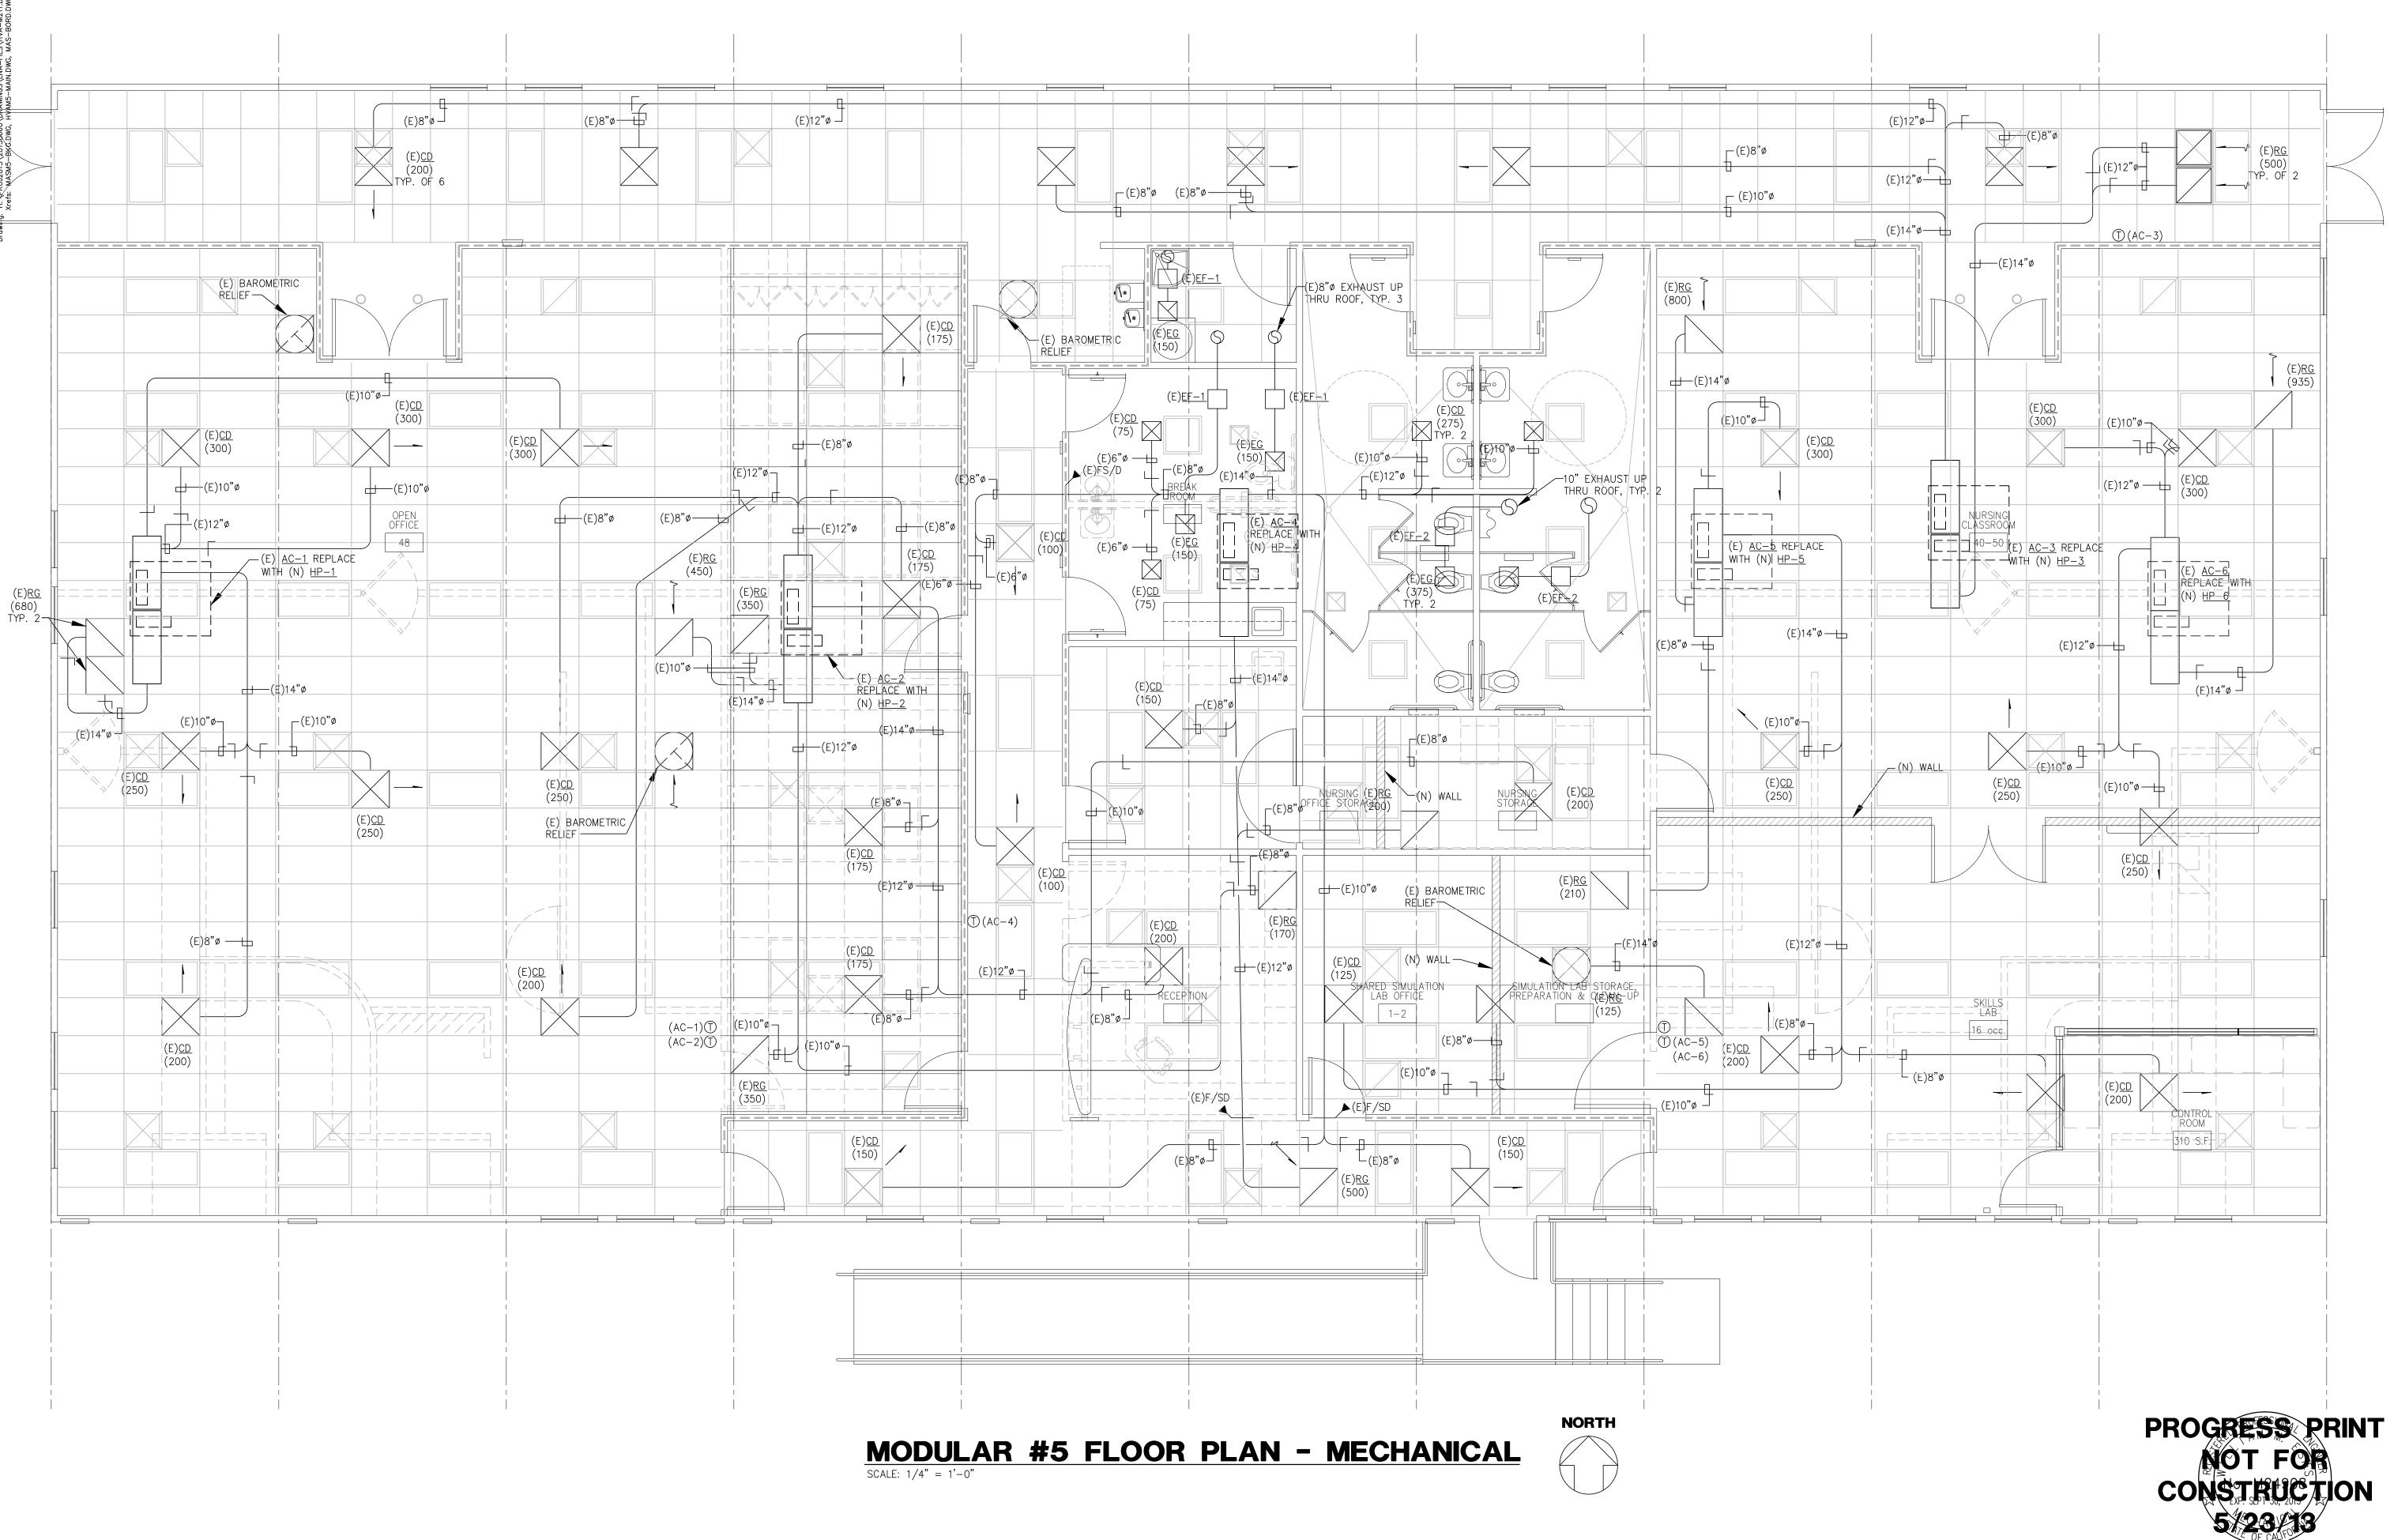

WALD RUHNKE & DOST

WALD RUHNKE & DOST ARCHITECTS LLP

2340 GARDEN ROAD, SUITE 100

MONTEREY, CALIFORNIA 93940

FAX: 831.649.3530 WWW.WRDARCH.COM

PHONE: 831.649.4642

THE USE OF THE PLANS AND SPECIFICATIONS IS RESTRICTED TO THE ORIGINAL SITE FOR WHICH THEY WERE PREPARED, AND PUBLICATION THEREOF IS EXPRESSLY LIMITED TO SUCH USE. REUSE, REPRODUCTION OR PUBLICATION BY ANY METHOD IN WHOLE OR IN PART IS PROHIBITED. TITLE TO THE PLANS AND SPECIFICATIONS REMAINS WITH THE ARCHITECT, AND VISUAL CONTACT WITH THEM CONSTITUTES PRIMA FACIE EVIDENCE OF THE ACCEPTANCE OF THESE RESTRICTIONS.

Natividad

MEDICAL CENTER

S 840 & 870

NATIVIDAD MEDICAL CENTER T.I.'s FOR MOD. 5 & BUILDINGS

JOB NO.:

PRINT DATE:

DRAWN BY: CADD

CHECKED BY: WME

SET ISSUED:

SHEET NAME:

MODULAR #5 FLOOR PLAN -MECHANICAL


SHEET NO.:

email: mail@axiomengineers.com


AXIOM ENGINEERS

LEE & ASSOCIATES
CONSULTING ENGINEERS

M211

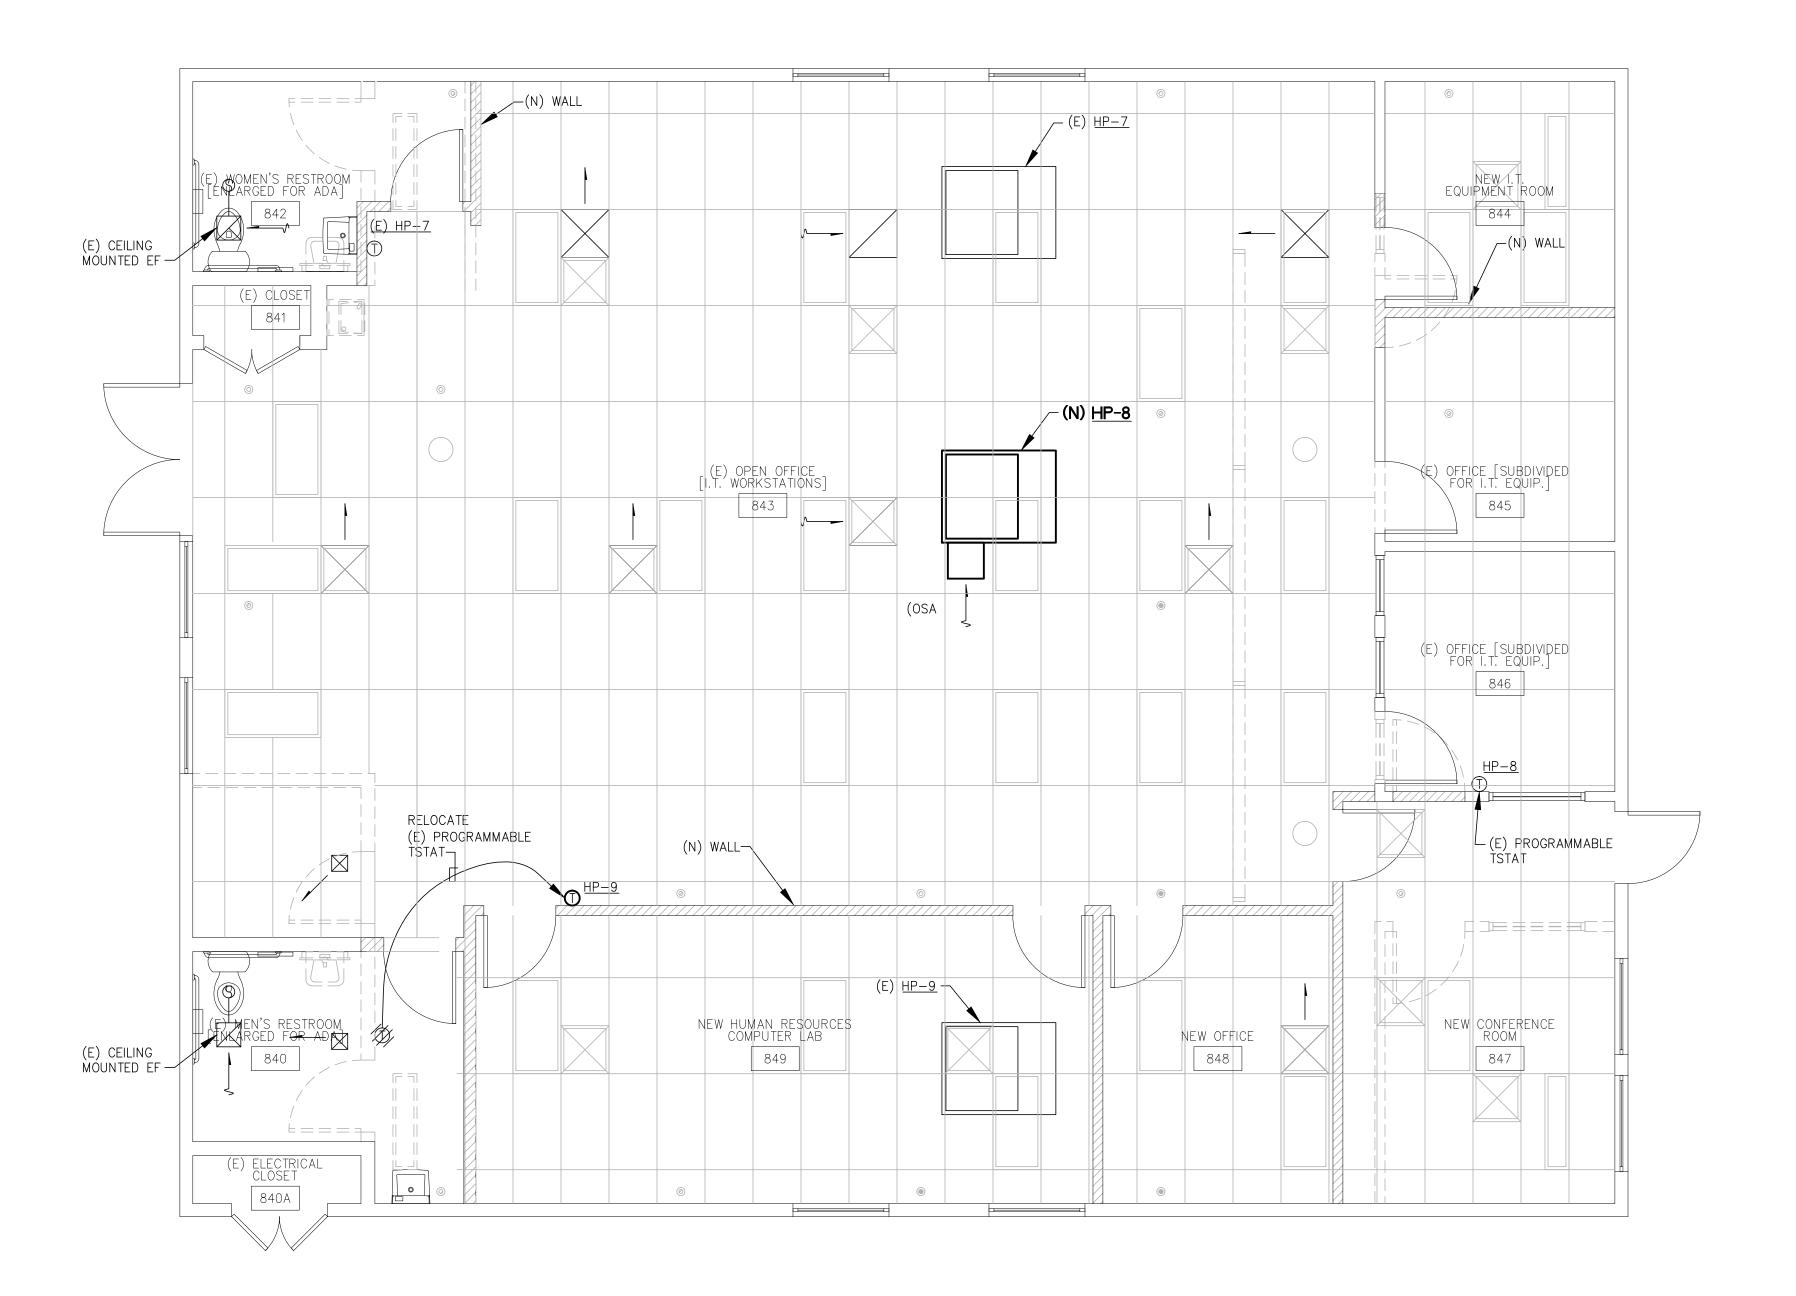

BUILDING 840 FLOOR PLAN - MECHANICAL SCALE: 1/4" = 1'-0"

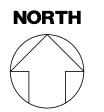



2340 GARDEN ROAD, SUITE 100 MONTEREY, CALIFORNIA 93940 PHONE: 831.649.4642 FAX: 831.649.3530

WWW.WRDARCH.COM

THE USE OF THE PLANS AND SPECIFICATIONS IS RESTRICTED TO THE ORIGINAL SITE FOR WHICH THEY WERE PREPARED, AND PUBLICATION THEREOF IS EXPRESSLY LIMITED TO SUCH USE. REUSE, REPRODUCTION OR PUBLICATION BY ANY METHOD IN WHOLE OR IN PART IS PROHIBITED. TITLE TO THE PLANS AND SPECIFICATIONS REMAINS WITH THE ARCHITECT, AND VISUAL CONTACT WITH THEM CONSTITUTES PRIMA FACIE EVIDENCE OF THE ACCEPTANCE OF THESE RESTRICTIONS.

M Natividad MEDICAL CENTER

870 NATIVIDAD MEDICAL CENTER T.I.'s FOR MOD. 5 & BUILDINGS 840

JOB NO.: 12188

PRINT DATE: PLOT DATE: DRAWN BY: CHECKED BY:

SET ISSUED:

SHEET NAME:

BUILDING 840


FLOOR PLAN -

MECHANICAL

PROGRESS PRINT NOT FOR CONSTRUCTION



SHEET NO.:

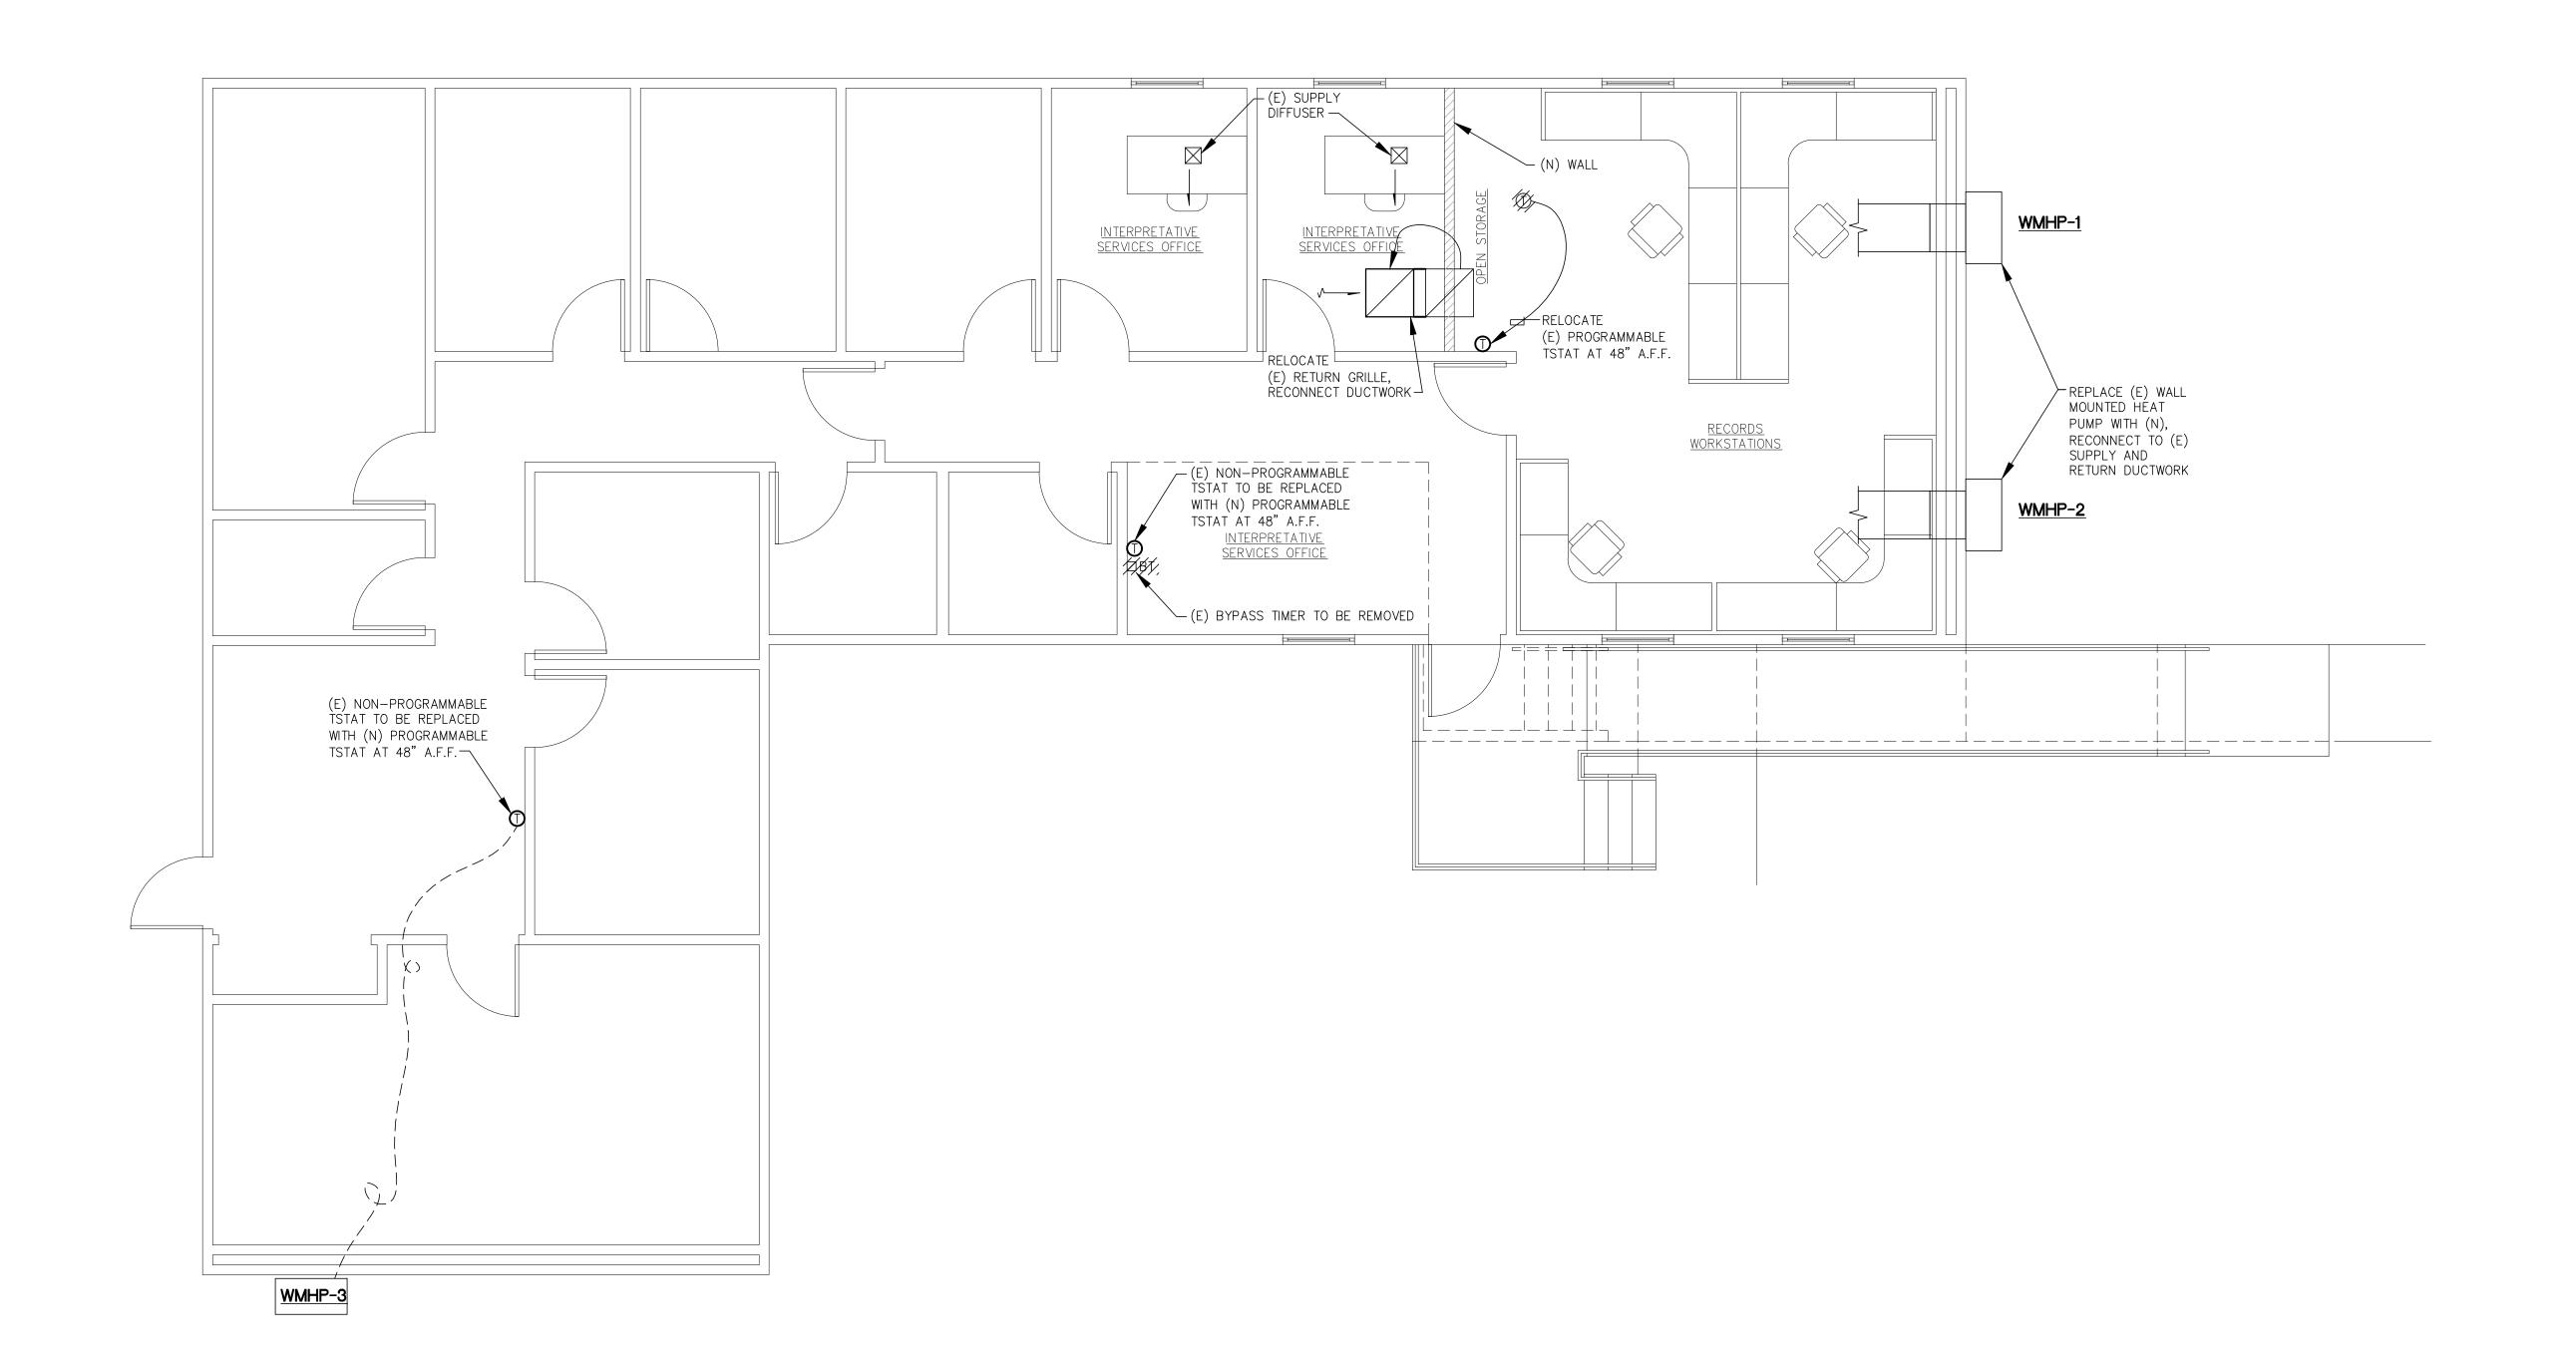

MANAGED CARE FLOOR PLAN - MECHANICAL SCALE: 1/4" = 1'-0"





vc. (831) 649-8000 email: mail@axiomengineers.com



22 Lower Ragsdale Dr., Suite A

WALD RUHNKE & DOST AR CHITECTS LLP

2340 GARDEN ROAD, SUITE 100

MONTEREY, CALIFORNIA 93940
PHONE: 831.649.4642

FAX: 831.649.3530 WWW.WRDARCH.COM

THE USE OF THE PLANS AND SPECIFICATIONS IS RESTRICTED TO THE ORIGINAL SITE FOR WHICH THEY WERE PREPARED, AND PUBLICATION THEREOF IS EXPRESSLY LIMITED TO SUCH USE. REUSE, REPRODUCTION OR PUBLICATION BY ANY METHOD IN WHOLE OR IN PART IS PROHIBITED. TITLE TO THE PLANS AND SPECIFICATIONS REMAINS WITH THE ARCHITECT, AND VISUAL CONTACT WITH THEM CONSTITUTES PRIMA FACIE EVIDENCE OF THE ACCEPTANCE OF THESE RESTRICTIONS.

Matividad

MEDICAL CENTER

870

ω,

AL CENTER

I. FOR

NAT T.T.

JOB NO.: 12188

PRINT DATE:

PLOT DATE: 05/31/2

DRAWN BY: C/


SET ISSUED:

SHEET NAME:

MANAGED CARE FLOOR PLAN -MECHANICAL

SHEET NO.:

M230

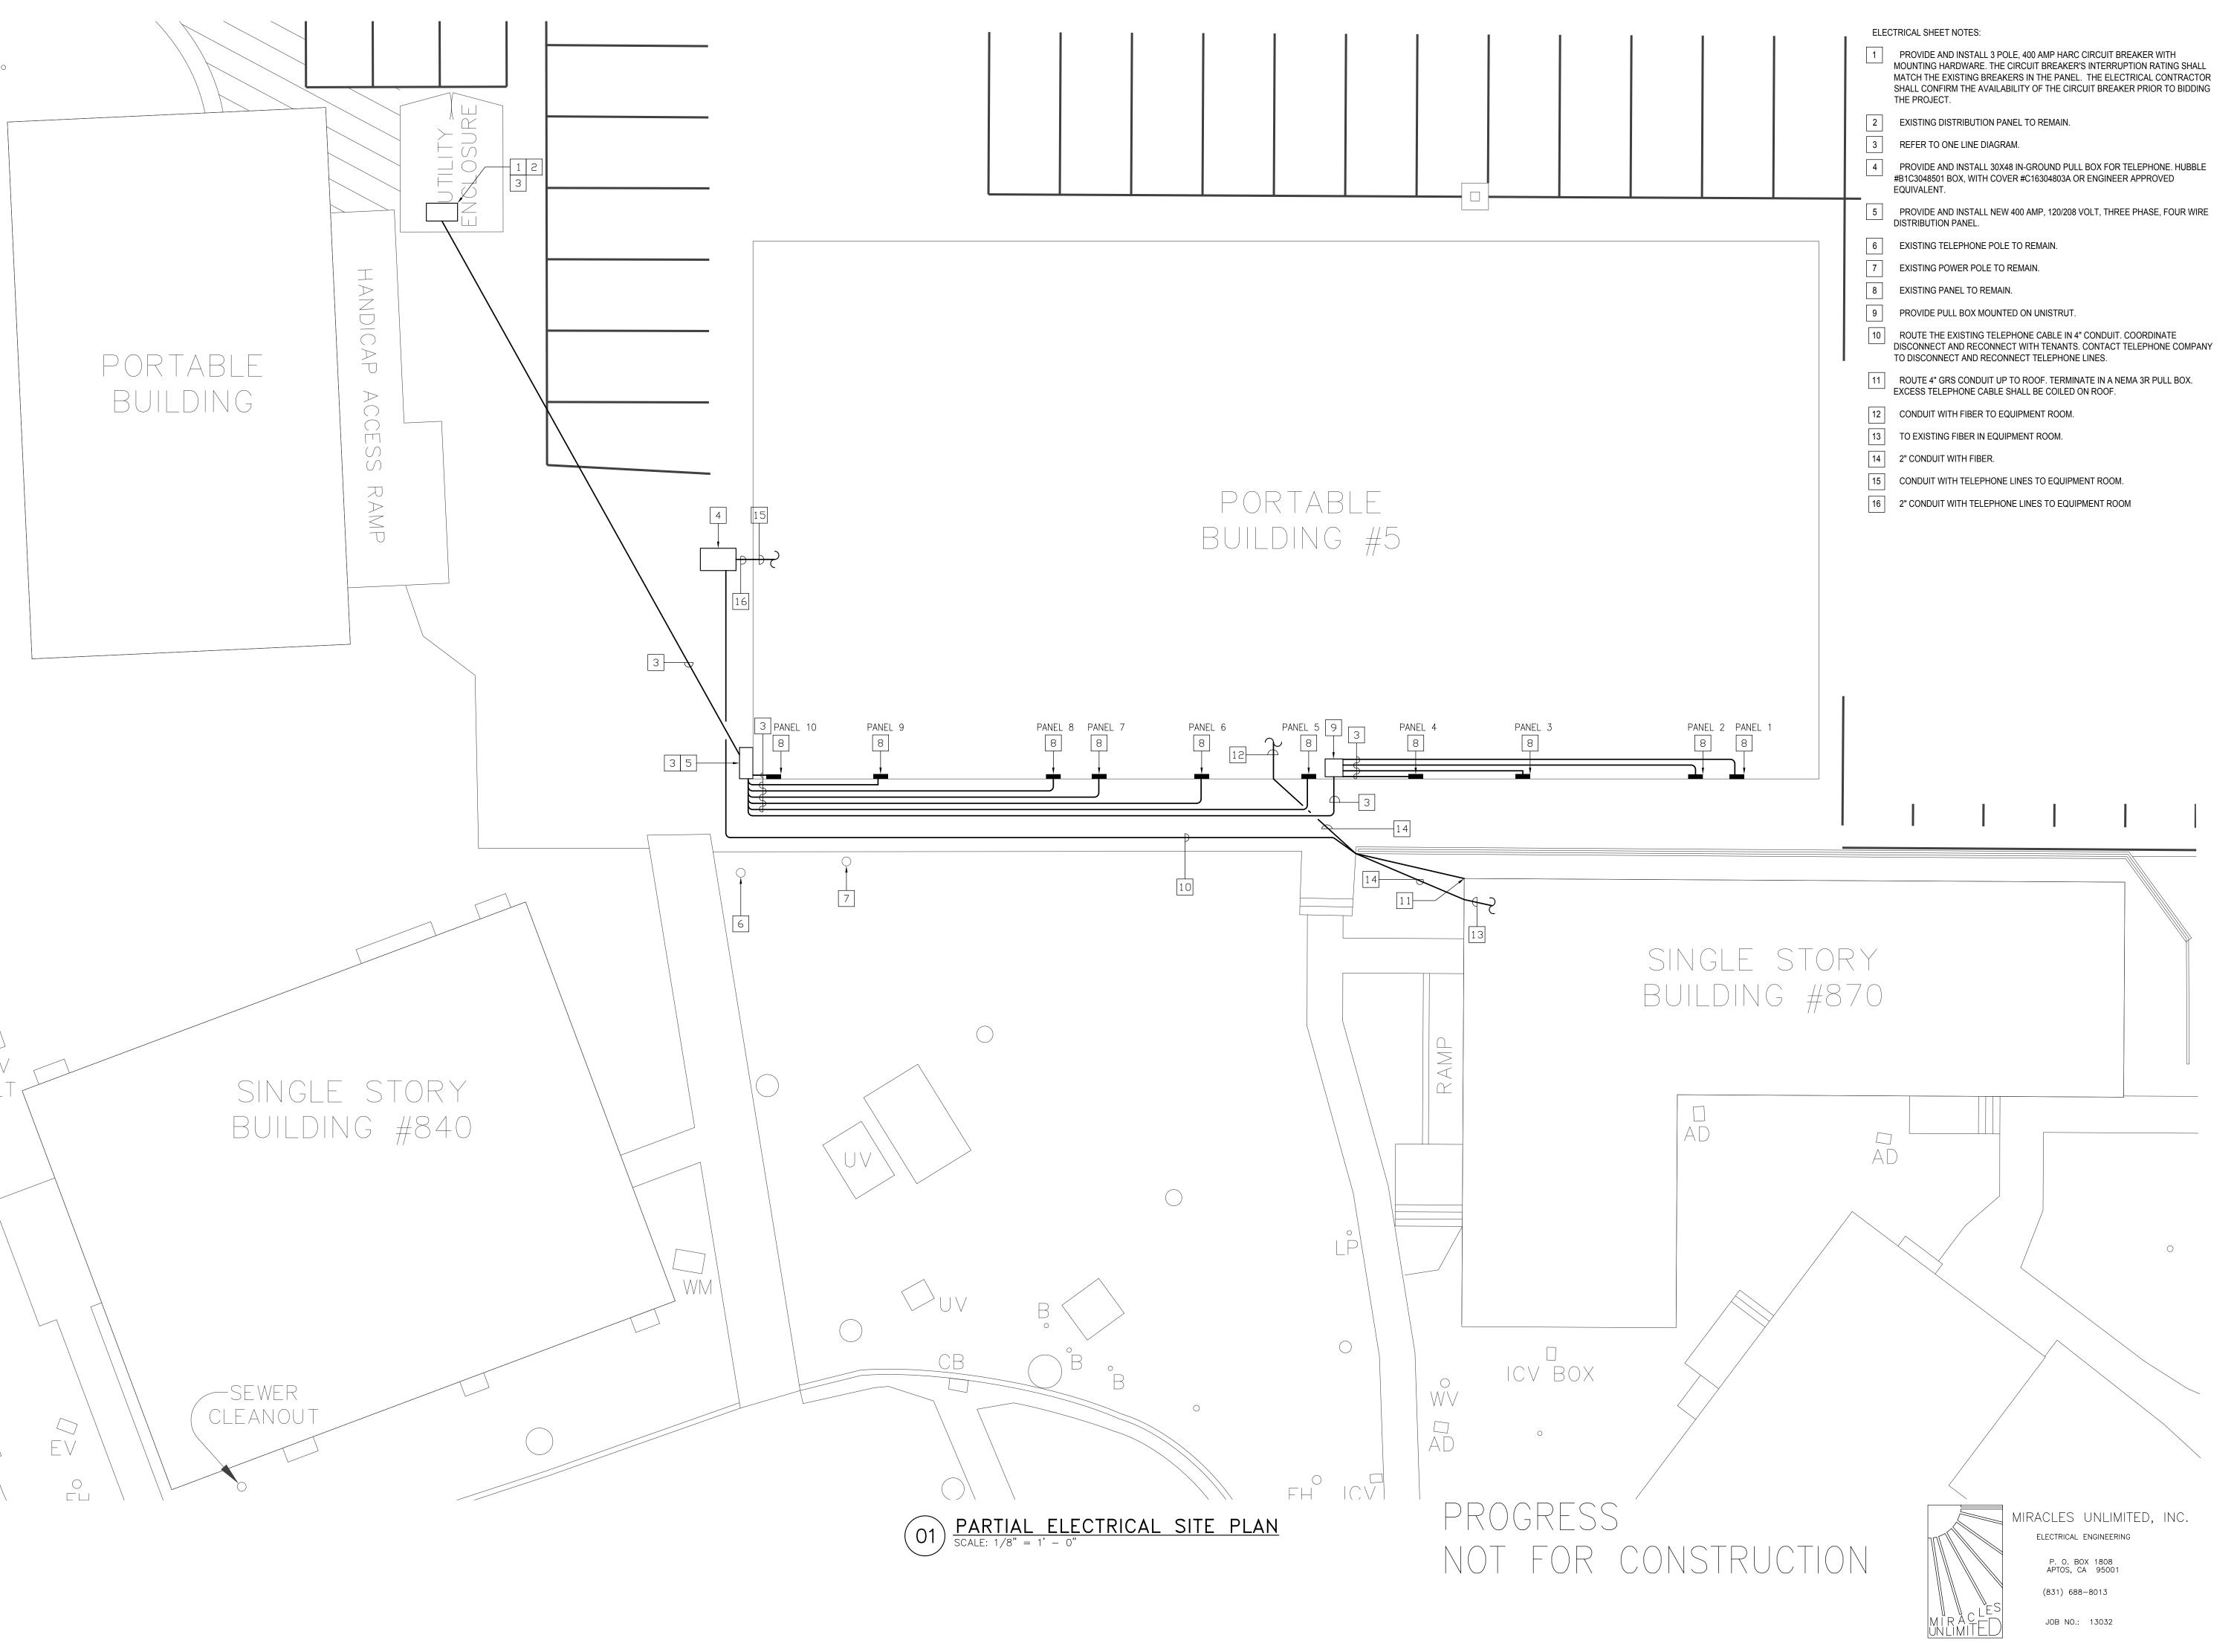



2340 GARDEN ROAD, SUITE 100

PHONE: 831.649.4642 FAX: 831.649.3530

MONTEREY, CALIFORNIA 93940

WWW.WRDARCH.COM

THE USE OF THE PLANS AND SPECIFICATIONS IS RESTRICTED TO THE ORIGINAL SITE FOR WHICH THEY WERE PREPARED, AND PUBLICATION THEREOF IS EXPRESSLY LIMITED TO SUCH USE. REUSE, REPRODUCTION OR PUBLICATION BY ANY METHOD IN WHOLE OR IN PART IS PROHIBITED. TITLE TO THE PLANS AND SPECIFICATIONS REMAINS WITH THE ARCHITECT, AND VISUAL CONTACT WITH THEM CONSTITUTES PRIMA FACIE EVIDENCE OF THE ACCEPTANCE OF THESE RESTRICTIONS.

NATIVIDAD MEDICAL CENTER T.I.'s FOR MOD. 5 & BUILDINGS 840 & 870

JOB NO.:
12188
PRINT DATE:

PLOT DATE:

DRAWN BY:

CHECKED BY:


SET ISSUED:

SHEET NAME:
PARTIAL
ELECTRICAL

SITE PLAN

SHEET NO.:


E1.1

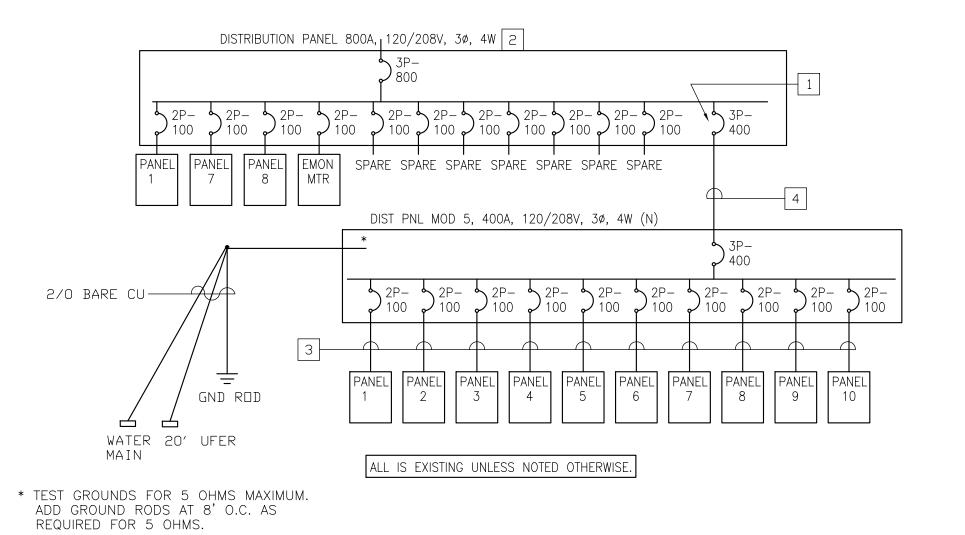

PARTIAL ONE LINE DIAGRAM
SCALE: NOT TO SCALE

PROGRESS NOT FOR CONSTRUCTION ELECTRICAL SHEET NOTES:

- PROVIDE AND INSTALL 3 POLE, 400 AMP HARC CIRCUIT BREAKER WITH MOUNTING HARDWARE. THE CIRCUIT BREAKER'S INTERRUPTION RATING SHALL MATCH THE EXISTING BREAKERS IN THE PANEL. THE ELECTRICAL CONTRACTOR SHALL CONFIRM THE AVAILABILITY OF THE CIRCUIT BREAKER PRIOR TO BIDDING THE PROJECT.
- 2 EXISTING DISTRIBUTION PANEL TO REMAIN.
- 3#3 PLUS 1#8 GROUND WIRE IN 1.25" CONDUIT. PROVIDE CONNECTION TO EXISTING PANEL.
- 4#600 KCMIL PLUS 1#3 GROUND WIRE IN 4" CONDUIT.

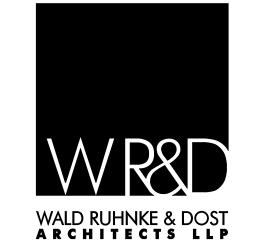

2340 GARDEN ROAD, SUITE 100 MONTEREY, CALIFORNIA 93940

PHONE: 831.649.4642 FAX: 831.649.3530

WWW.WRDARCH.COM

THE USE OF THE PLANS AND SPECIFICATIONS IS RESTRICTED TO THE ORIGINAL SITE FOR WHICH THEY WERE PREPARED, AND PUBLICATION THEREOF IS EXPRESSLY LIMITED TO SUCH USE. REUSE, REPRODUCTION OR PUBLICATION BY ANY METHOD IN WHOLE OR IN PART IS PROHIBITED. TITLE TO THE PLANS AND SPECIFICATIONS REMAINS WITH THE ARCHITECT, AND VISUAL CONTACT WITH THEM CONSTITUTES PRIMA FACIE EVIDENCE OF THE ACCEPTANCE OF THESE RESTRICTIONS.

870 **∞**ŏ 840 ICAL CENTER 5 & BUILDINGS 8 NATIVIDAD MEDIC T.I.'s FOR MOD. 5


JOB NO.: 12188 PRINT DATE:

PLOT DATE: DRAWN BY: CHECKED BY:

SET ISSUED:

SHEET NAME: ELECTRICAL ONE LINE, PNL SCHED

SHEET NO.:

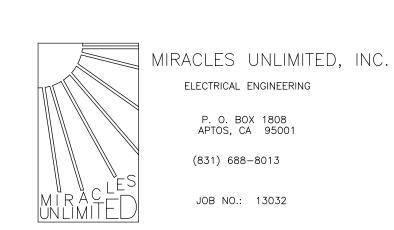

WATER HEATERS												
MARK	LOCATION	GAL CAP	MBH IN	KW ELE	CT V/PH	RECOVERY	FULL WT	MAKE & MODEL	REMARKS			
(E) <u>EWH-1</u>	MODULAR 5M, SEE P211	30	ı	45	208/1	30.7 GPH	330	RHEEM 82V30-2	1 2			
(N) <u>EWH-2</u>	LAV <u>L-1</u> AT BLDG 840, SEE P220	-	-	3	208/1	X GPH	7	CHRONOMITE LABS, S-30L	2			
(N) E <u>WH-3</u>	LAV <u>L-1</u> AT BLDG 840, SEE P220	_	ı	3	208/1	X GPH	7	CHRONOMITE LABS, S-30L	2			

1) EXISTING WH MANUFACTURED IN 2006, TO BE REINSTALLED 3 X

SYMBOL	ABBRV.	IDENTIFICATION	ABBRV.	IDENTIFICATION
	- CW	COLD WATER (DOMESTIC)	COORD	COORDINATE
	- HW	HOT WATER	DN	DOWN
	- HWR	HOT WATER RETURN	DWGS	DRAWINGS
	- V	VENT	(E)	EXISTING
— G —	– G	GAS (7"WC)	MIN	MINIMUM
— W —	S OR W	SOIL OR WASTE ABOVE GRADE	(N)	NEW
—w— —	S OR W	SOIL OR WASTE BELOW GRADE	VTR	VENT THROUGH ROOF
0	-	RISE UP	W/	WITH
G	- ELL	ELBOW DOWN		
0	- TEE	TEE DOWN		
E	-	CAP		
\	- CONT	CONTINUATION		
	-	BALL VALVE		
	-	UNION		
101	- WHA	WATER HAMMER ARRESTOR		
	НВ	HOSE BIBB		
Φ	- GCO/FCO	GRADE CLEAN-OUT/FLOOR CLEAN-OUT		
e	WCO	WALL CLEAN-OUT		
軍		THERMOMETER		
•	P.O.C.	POINT OF CONNECTION		



ARCHITECTS LLP

MONTEREY, CALIFORNIA 93940 PHONE: 831.649.4642

2340 GARDEN ROAD, SUITE 100

FAX: 831.649.3530 WWW.WRDARCH.COM

THE USE OF THE PLANS AND SPECIFICATIONS IS RESTRICTED TO THE ORIGINAL SITE FOR WHICH THEY WERE PREPARED, AND PUBLICATION THEREOF IS EXPRESSLY LIMITED TO SUCH USE. REUSE, REPRODUCTION OR PUBLICATION BY ANY METHOD IN WHOLE OR IN PART IS PROHIBITED. TITLE TO THE PLANS AND SPECIFICATIONS REMAINS WITH THE ARCHITECT, AND VISUAL CONTACT WITH THEM CONSTITUTES PRIMA FACIE EVIDENCE OF THE ACCEPTANCE OF THESE RESTRICTIONS.

M Natividad MEDICAL CENTER

870 NATIVIDAD MEDICAL CENTER T.I.'s FOR MOD. 5 & BUILDINGS 840

JOB NO.:

12188 PRINT DATE: PLOT DATE: DRAWN BY:

LEGENDS AND


NOTES PLUMBING
SHEET NO.:

CADD

CHECKED BY: SET ISSUED:

PROGRESS PRINT
NOT FOR
CONSTRUCTION SHEET NAME: SCHEDULES,



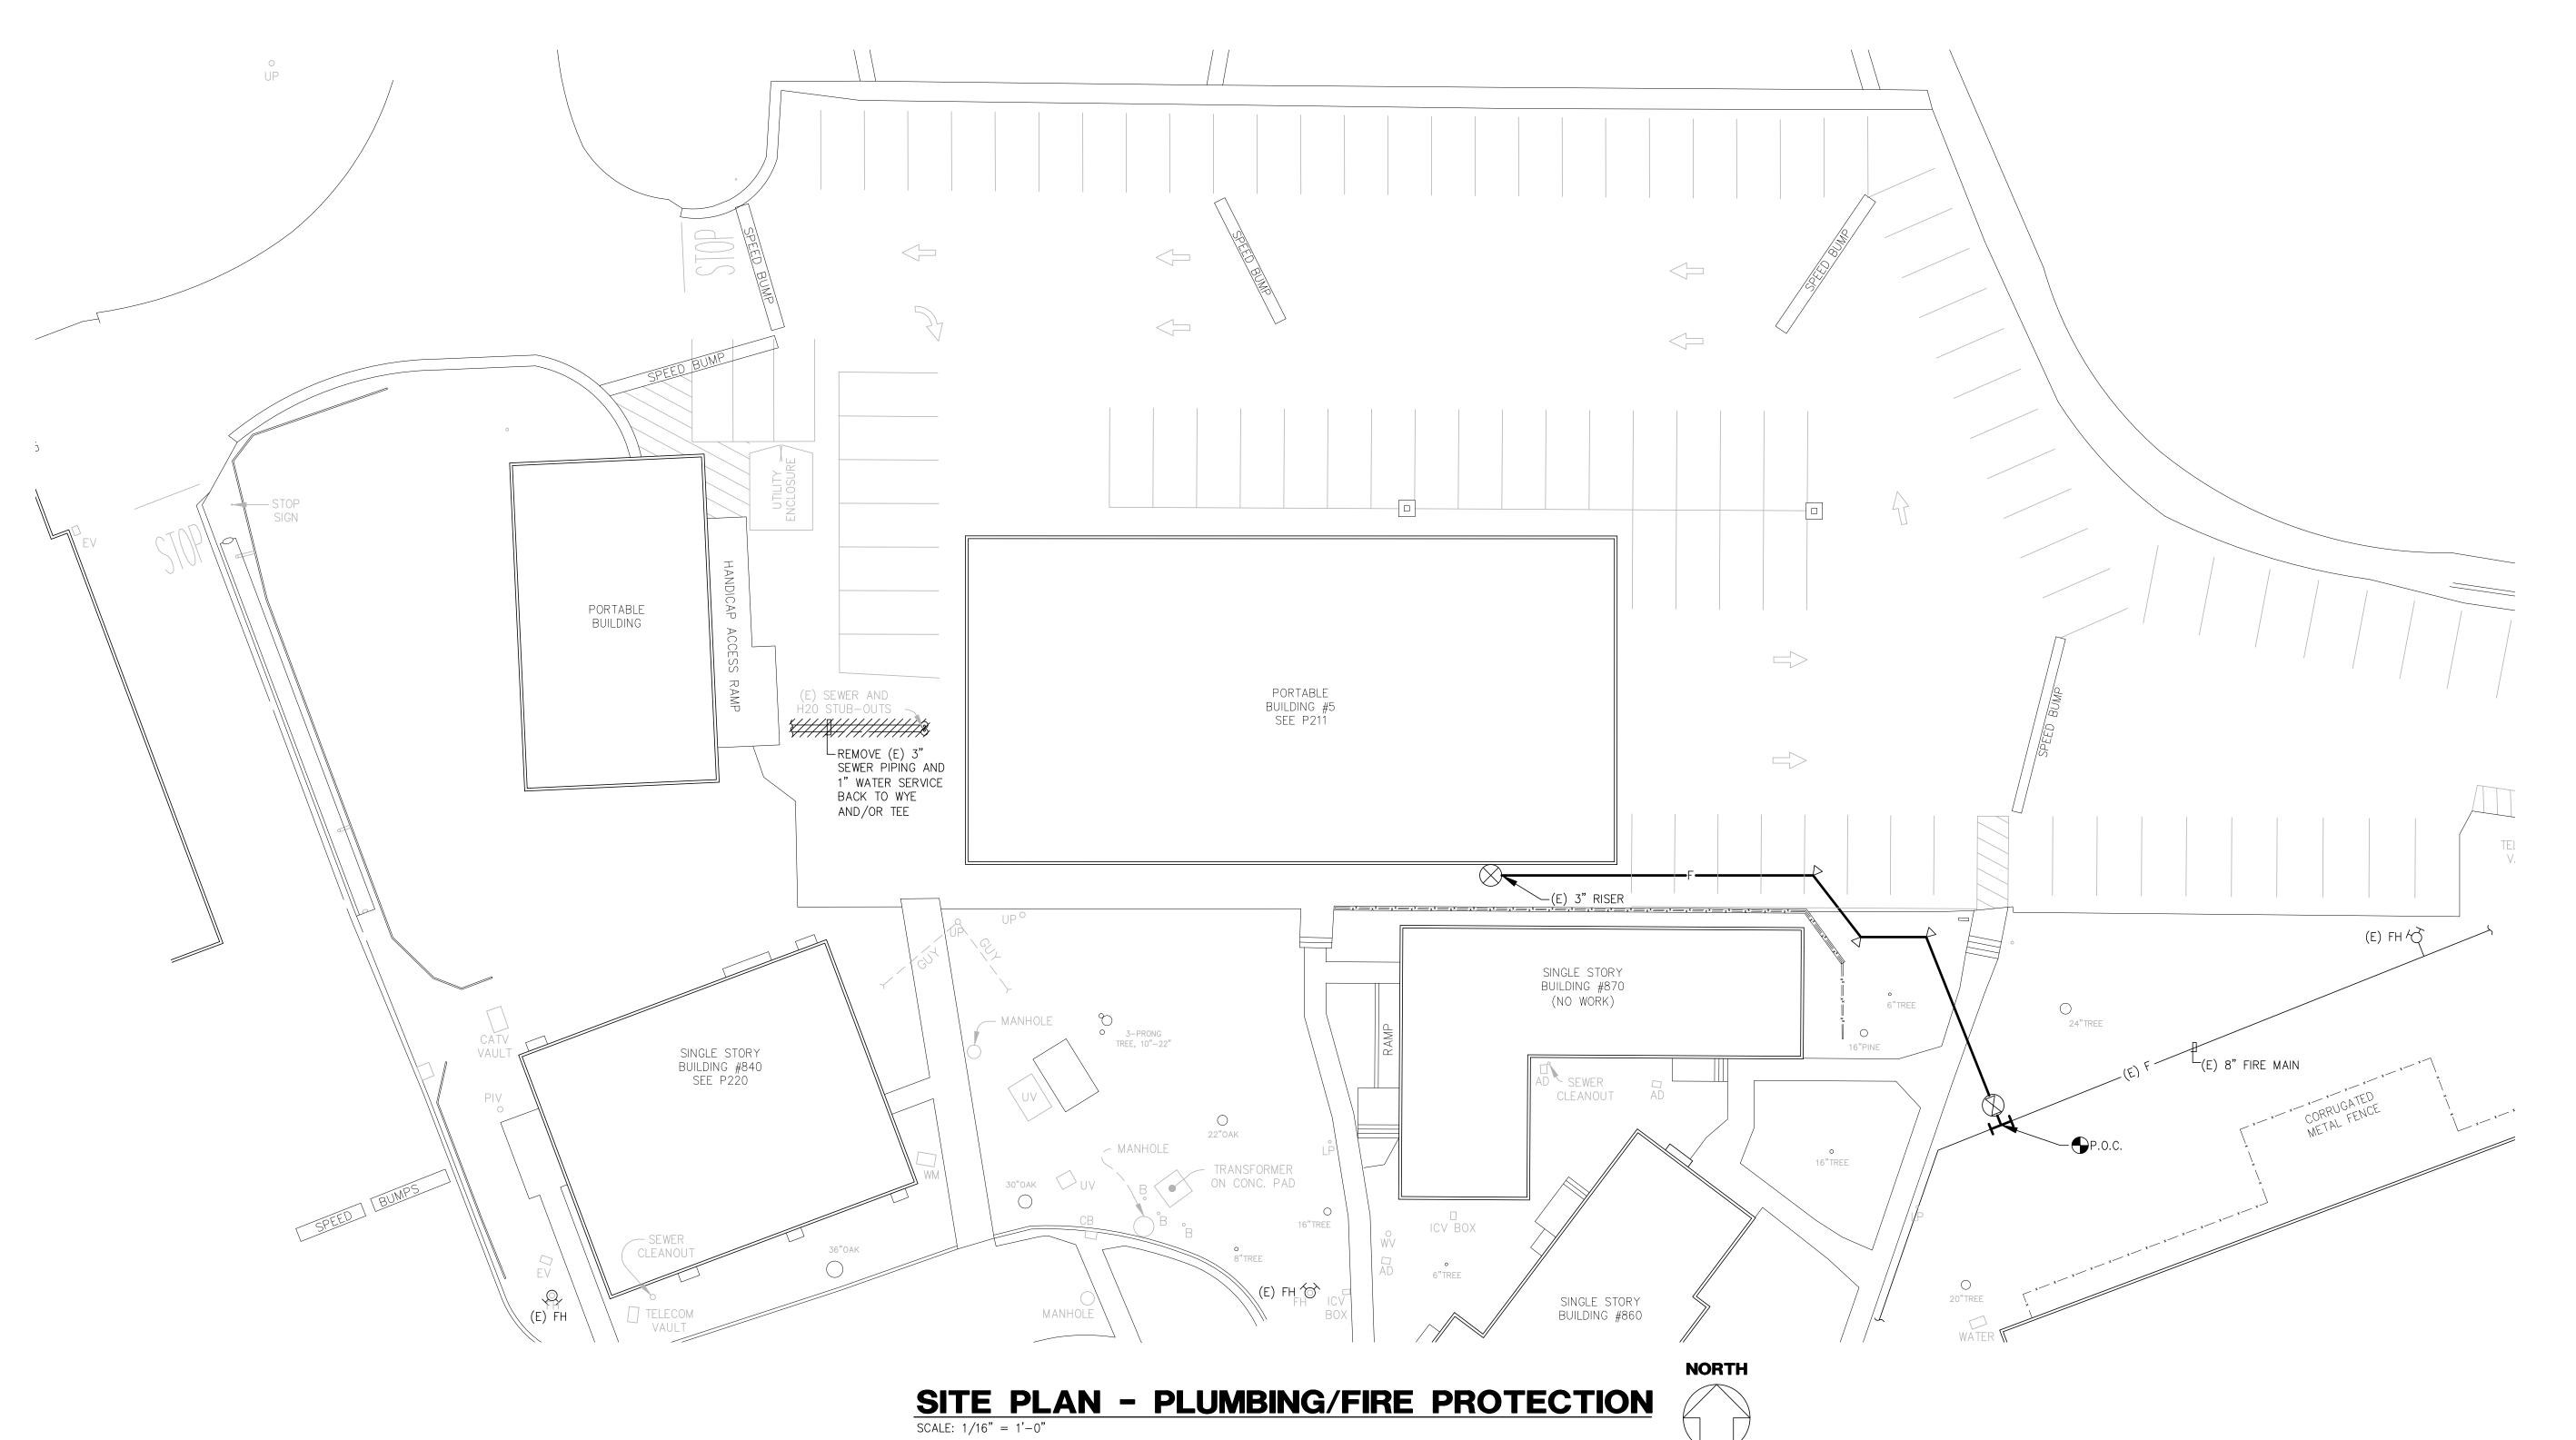



PHONE: 831.649.4642

FAX: 831.649.3530 WWW.WRDARCH.COM

THE USE OF THE PLANS AND SPECIFICATIONS IS RESTRICTED TO THE ORIGINAL SITE FOR WHICH THEY WERE PREPARED, AND PUBLICATION THEREOF IS EXPRESSLY LIMITED TO SUCH USE. REUSE, REPRODUCTION OR PUBLICATION BY ANY METHOD IN WHOLE OR IN PART IS PROHIBITED. TITLE TO THE PLANS AND SPECIFICATIONS REMAINS WITH THE ARCHITECT, AND VISUAL CONTACT WITH THEM CONSTITUTES PRIMA FACIE EVIDENCE OF THE ACCEPTANCE OF THESE RESTRICTIONS.

Natividad

MEDICAL CENTER

870 NATIVIDAD MEDICAL CENTER T.I.'s FOR MOD. 5 & BUILDINGS

JOB NO.: 12188


PRINT DATE: PLOT DATE: 05/23/2013 DRAWN BY: CHECKED BY: SET ISSUED:

SHEET NAME: SITE PLAN -PLUMBING/FIRE PROTECTION

SHEET NO.:

PROGRESS PRINT NOT FOR CONSTRUCTION



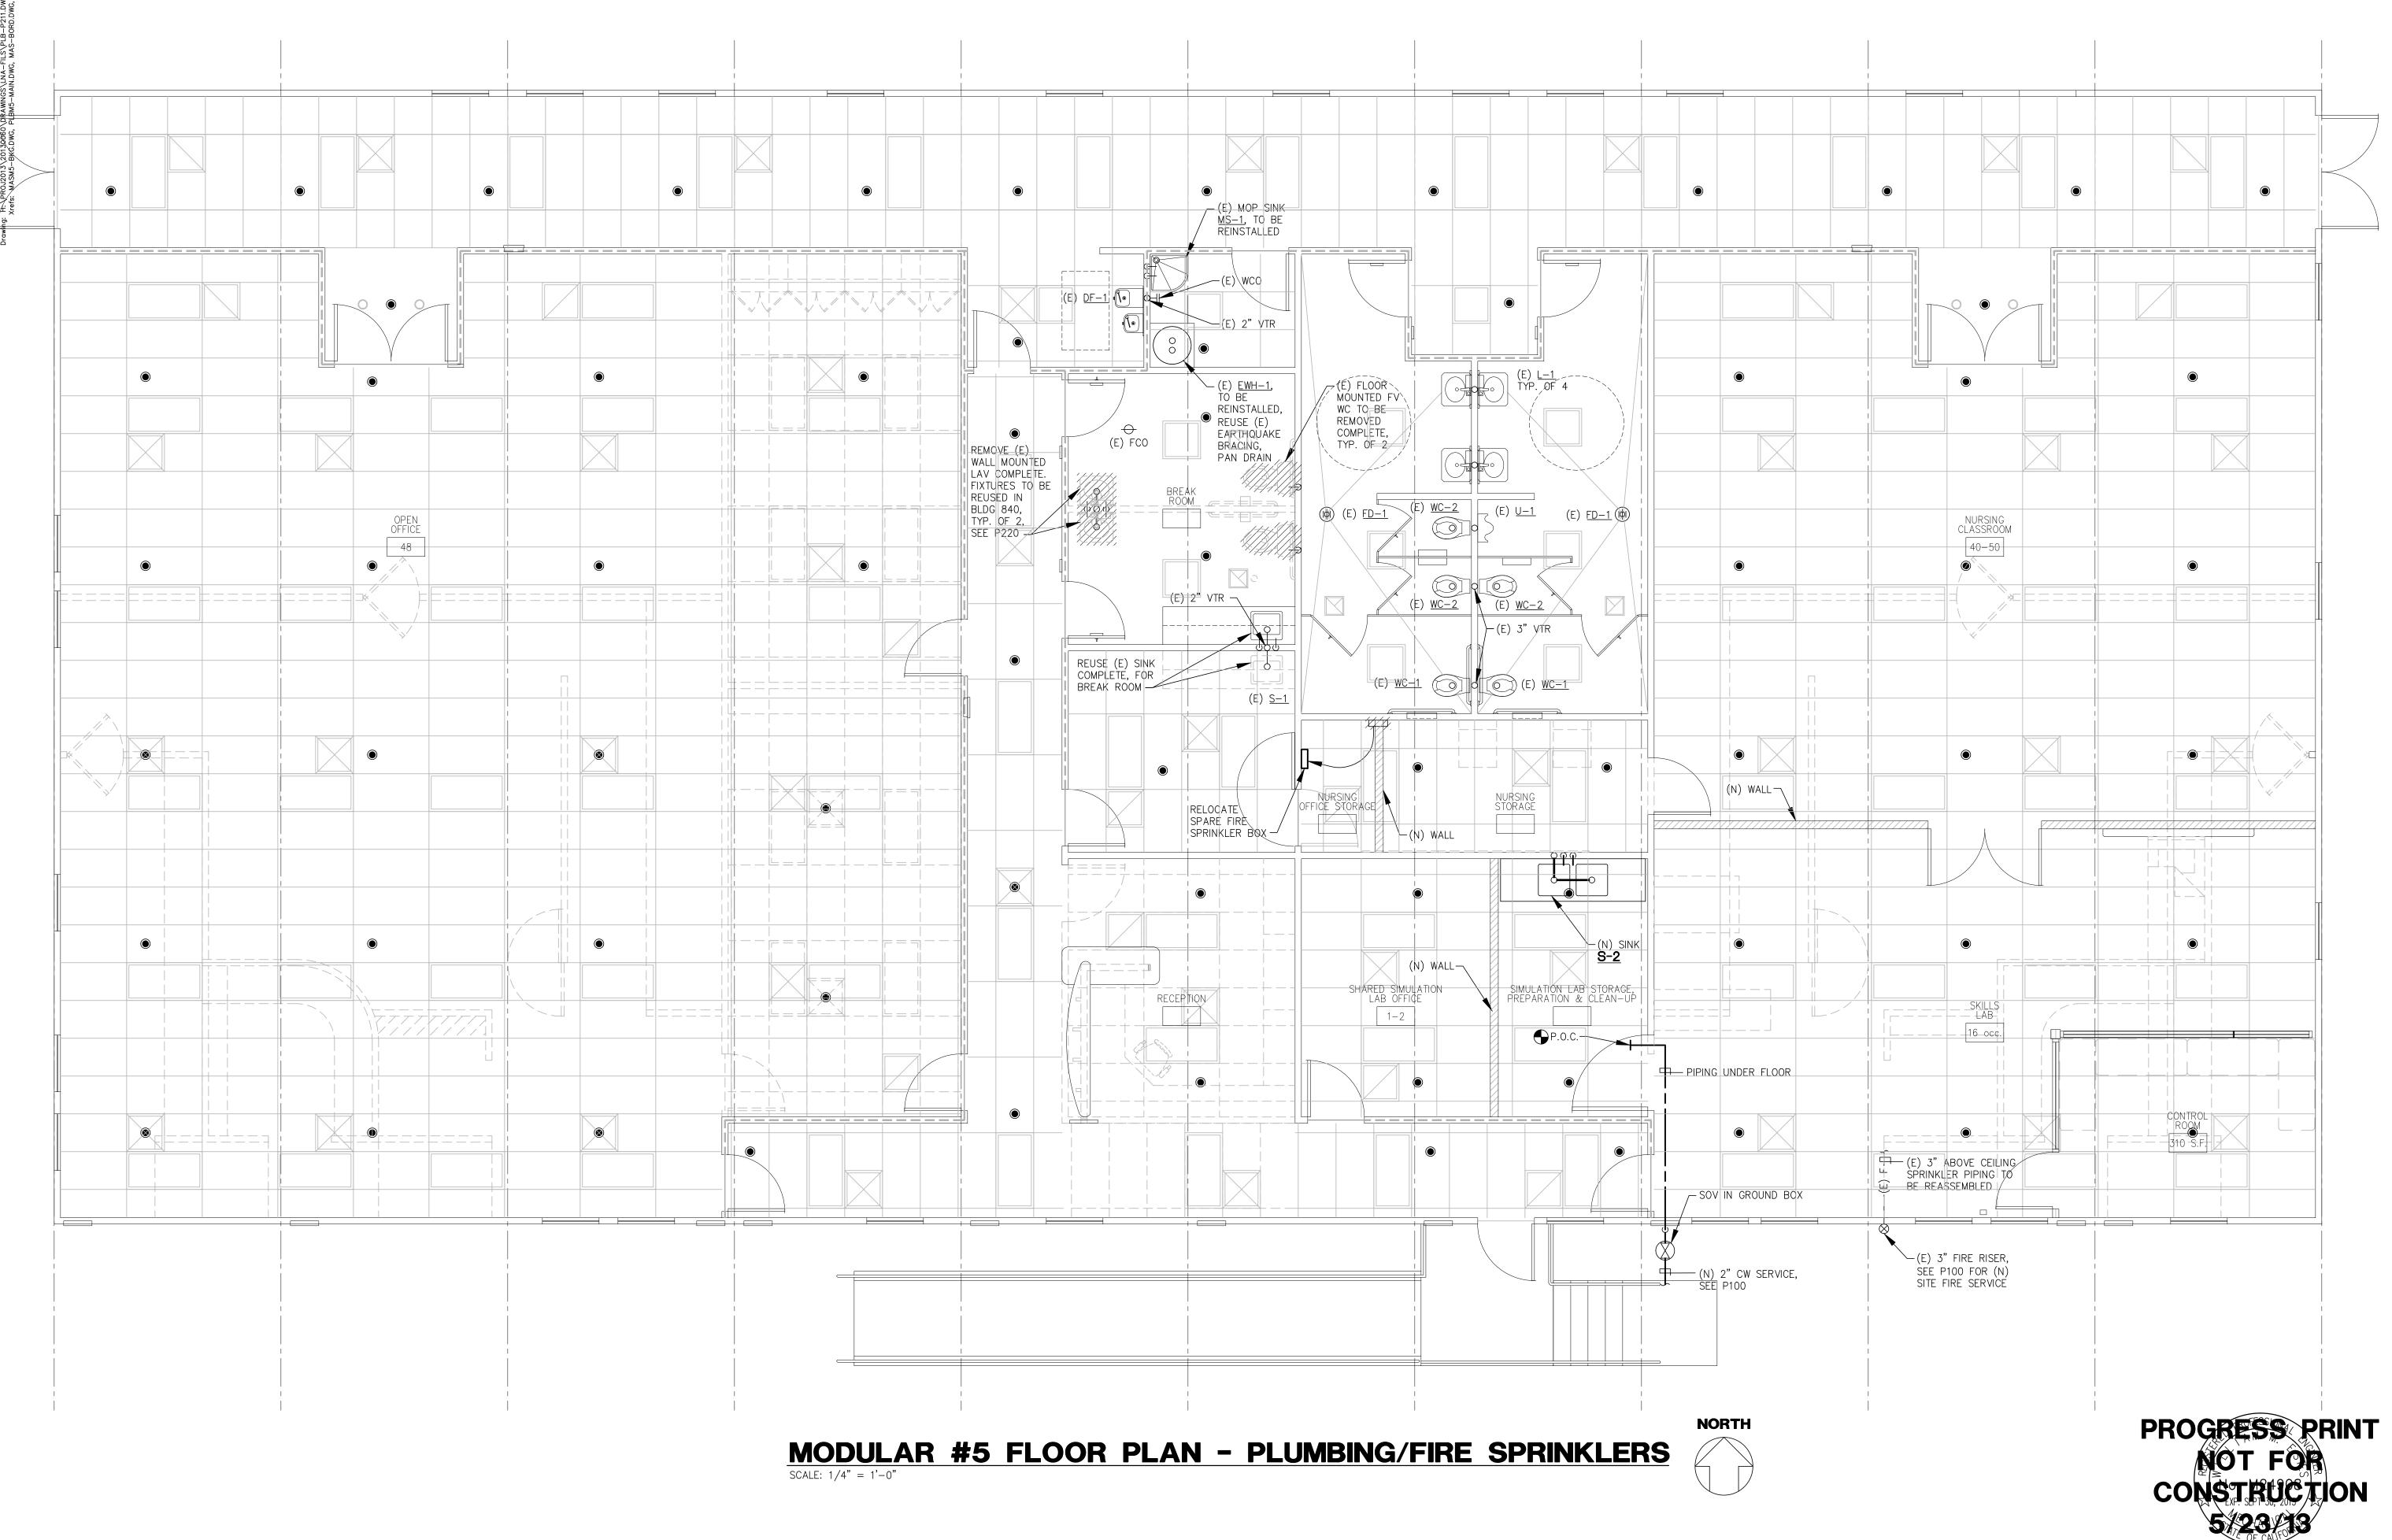

WALD RUHNKE & DOST

WALD RUHNKE & DOST ARCHITECTS LLP

2340 GARDEN ROAD, SUITE 100

MONTEREY, CALIFORNIA 93940
PHONE: 831.649.4642
FAX: 831.649.3530

WWW.WRDARCH.COM

THE USE OF THE PLANS AND SPECIFICATIONS IS RESTRICTED TO THE ORIGINAL SITE FOR WHICH THEY WERE PREPARED, AND PUBLICATION THEREOF IS EXPRESSLY LIMITED TO SUCH USE. REUSE, REPRODUCTION OR PUBLICATION BY ANY METHOD IN WHOLE OR IN PART IS PROHIBITED. TITLE TO THE PLANS AND SPECIFICATIONS REMAINS WITH THE ARCHITECT, AND VISUAL CONTACT WITH THEM CONSTITUTES PRIMA FACIE EVIDENCE OF THE ACCEPTANCE OF THESE RESTRICTIONS.

Matividad

MEDICAL CENTER

3S 840 & 870

NATIVIDAD MEDICAL CENTER
T.I.'s FOR MOD. 5 & BUILDINGS
NATIVIDAD MEDICAL CENTER

JOB NO.:
12188

PRINT DATE:
PLOT DATE: 0:

CHECKED BY:
SET ISSUED:


SHEET NAME:
MODULAR #5
FLOOR PLAN PLUMBING/FIRE
SPRINKLERS

P211

SHEET NO.:

22 Lower Ragsdale Dr., S
Project #: 20130060 Monterey, California 9394

AXIOM ENGINEERS
LEE & ASSOCIATES
CONSULTING ENGINEERS

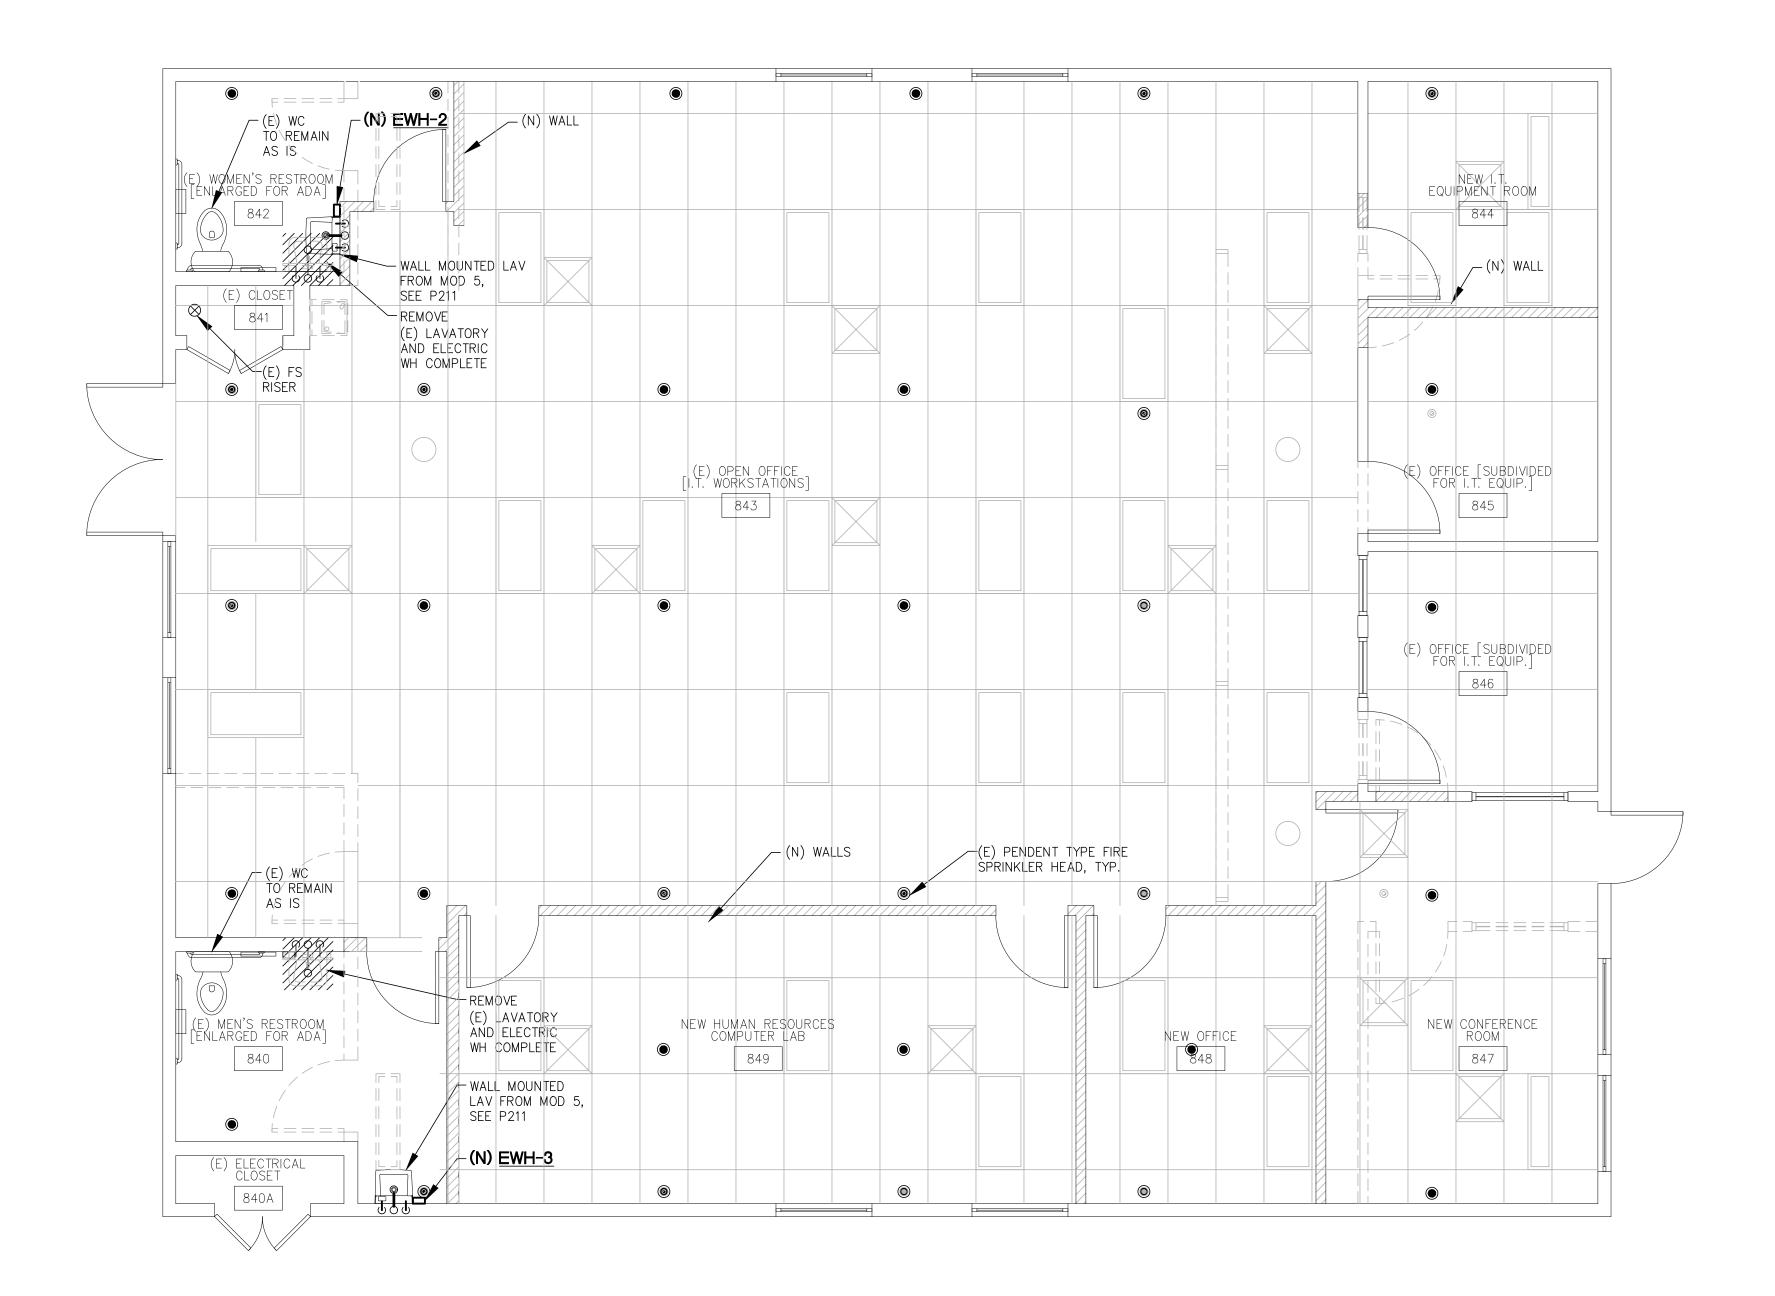

BUILDING 840 FLOOR PLAN - PLUMBING/FIRE SPRINKLERS SCALE: 1/4" = 1'-0"





2340 GARDEN ROAD, SUITE 100 MONTEREY, CALIFORNIA 93940 PHONE: 831.649.4642

FAX: 831.649.3530 WWW.WRDARCH.COM

THE USE OF THE PLANS AND SPECIFICATIONS IS RESTRICTED TO THE ORIGINAL SITE FOR WHICH THEY WERE PREPARED, AND PUBLICATION THEREOF IS EXPRESSLY LIMITED TO SUCH USE. REUSE, REPRODUCTION OR PUBLICATION BY ANY METHOD IN WHOLE OR IN PART IS PROHIBITED. TITLE TO THE PLANS AND SPECIFICATIONS REMAINS WITH THE ARCHITECT, AND VISUAL CONTACT WITH THEM CONSTITUTES PRIMA FACIE EVIDENCE OF THE ACCEPTANCE OF THESE RESTRICTIONS.

M Natividad MEDICAL CENTER

870 840 NATIVIDAD MEDICAL CENTER T.I.'s FOR MOD. 5 & BUILDINGS

JOB NO.: 12188

PRINT DATE: PLOT DATE: 05/23/2013 DRAWN BY:

CADD

WME

CHECKED BY: SET ISSUED:

SHEET NAME:

SHEET NO.:

BUILDING 840

FLOOR PLAN -

SPRINKLERS

PLUMBING/FIRE

PROGRESS PRINT NOT FOR CONSTRUCTION 5/28/13



GENERAL NOTES

A. REFER TO ARCHITECTURAL SPECIFICATIONS FOR ALL SUBMITTAL AND/OR MOCKUP GUIDELINES AND REQUIREMENTS.

- B. CONTACT GALLUN SNOW FOR CLARIFICATION IN THE EVENT OF CONTRADICTORY INFORMATION BETWEEN DRAWINGS, LEGEND, AND/OR SPECIFICATIONS.
- C. REFER TO FINISH PLAN FOR GENERAL FINISHES. REFER TO ALL SPECIFICATIONS AND INTERIOR DRAWINGS (INCLUDING PLANS, ELEVATIONS, AND DETAILS) FOR COMPLETE INTERIORS INFORMATION.
- D. ALL SURFACES REQUIRE NEW FINISHES UNO. IF COLOR OR FINISH IS NOT SPECIFIED, CONTACT GALLUN SNOW FOR CLARIFICATION.
- E. REMOVE EXISTING ARTWORK, SIGNAGE, AND WALL MOUNTED ACCESSORIES WITHIN THE PROJECT SCOPE AND RETURN TO OWNER FOR STORAGE PRIOR TO DEMOLITION.

- REMOVE COMPLETELY FROM THE JOB SITE ALL MATERIALS SPECIFIED FOR DEMOLITION AND NOT NOTED TO BE RETURNED TO OWNER.
- B. REPLACE ANY ITEM DEMOLISHED OR DAMAGED BY DEMOLITION AND NOT SPECIFIED FOR DEMOLITION WITH A LIKE ITEM AS APPROVED BY OWNER AT NO ADDITIONAL COST.
- C. PROTECT ALL EXISTING FLOOR, WALL, DOOR, AND CEILING FINISHES TO REMAIN. REPAIR ANY DAMAGE AS A RESULT OF DEMOLITION OR CONSTRUCTION.
- REMOVE EXISTING FLOORING, ADHESIVE, AND MASTIC AT ALL EXISTING FLOOR SCHEDULED FOR DEMOLITION. PATCH AND PREP SUBFLOOR TO MEET MANUFACTURER'S REQUIREMENTS FOR NEW FLOORING MATERIALS. FLOAT SUBFLOOR AS NECESSARY TO
- E. DEMOLISH AND STORE ALL EXISTING CORNER GUARDS AND WALL MOUNTED EQUIPMENT PRIOR TO CONSTRUCTION UNO.

ALIGN FINISHED SURFACE BETWEEN NEW FLOORING AND EXISTING TO REMAIN.

- F. PATCH AND PREP ALL EXISTING WALLS TO REMAIN FOLLOWING DEMOLITION. CONFIRM EQUIPMENT MOUNTING HEIGHTS WITH DESIGNER/OWNER PRIOR TO RE-INSTALL.
- G. WHERE FINISHES ARE CALLED OUT TO MATCH EXISTING, CONTRACTOR TO VERIFY PRODUCT MATCH PRIOR TO ORDERING.

- A. ALIGN TRANSITION OF FLOOR MATERIAL WITH CENTER OF HINGE IN DOORWAY. IN A WRAPPED OPENING WITHOUT HINGES RE: FINISH PLANS FOR TRANSITION LOCATION.
- B. HEAT WELD ALL RESILIENT SHEET FLOORING SEAMS AND SEAL.
- C. PROVIDE COLOR MATCH HEAT WELD RODS FOR EACH SHEET RESILIENT FLOOR AS SPECIFIED IN FINISH LEGEND.
- D. INSTALL DIRECTIONAL FLOORING ORIENTED AS SPECIFIED IN THE FINISH PLAN.

A. PROVIDE 6" HIGH RUBBER COVE BASE UNO.

- B. PROVIDE 6" HIGH INTEGRAL COVE BASE TO MATCH ADJACENT SHEET FLOORING WITH STAINLESS STEEL TOP CAP AND MECHANICALLY FASTENED CORNERS, BNT METALS #6450-IC (INSIDE CORNER) AND #6450-OC (OUTSIDE CORNER).
- C. PROVIDE CONTINUOUS LENGTH OF RUBBER BASE WITH FIELD FORMED OUTSIDE CORNERS.
- D. PROVIDE ALL AVAILABLE CERAMIC TILE TRIM PIECES COVE, BULLNOSE, INSIDE/OUTSIDE CORNERS, ETC.

- A. PROVIDE WALL FINISHES FROM LOWER TO HIGHER IN THE ORDER LISTED.
- B. PROVIDE ALL AVAILABLE CERAMIC TILE TRIM PIECES BULLNOSE, OUTSIDE CORNERS, ETC.
- C. REFER TO INTERIOR ELEVATIONS FOR ADDITIONAL WALL FINISH INFORMATION D. PAINT ALL METAL DOORS, VISION PANEL, SIDELIGHT, AND WINDOW FRAMES P1 UNO.
- E. REFER TO ARCHITECTURAL SPECIFICATION FOR DEFINITION OF GLOSS RANGE ON THE
- FOLLOWING PAINT SHEENS: PROVIDE LOW LUSTER FINISH UNO. PROVIDE SEMI GLOSS FINISH IN TOILET ROOMS AND SKILLS LAB

- CEILINGS

 A. PAINT SOFFITS P1 UNO. PAINT UNDERSIDE AND FACE OF SOFFIT AS SCHEDULED.
- B. REFER TO REFLECTED CEILING PLANS FOR ADDITIONAL SOFFIT AND CEILING FINISH
- C. PAINT ALL GYP. CEILINGS P1 UNO
- D. PROVIDE NON-PERFORATED VINYL FACED CEILING TILE [SAT#] WITH HOLD DOWN CLIPS AND GASKETS IN ALL ISOLATION/PRESSURIZED AREAS.
- E. CENTER CEILING GRID AND TILE LAYOUT IN EACH ROOM. DO NOT INSTALL LESS THAN A 1/2 CEILING TILE.
- F. PATCH AND MATCH EXISTING WHERE NEEDED WITH SAT5

- A. CAULK COUNTERS WHERE THEY ABUT WALLS WITH CLEAR CAULK.
- B. PROVIDE LAMINATE PL1 AT VERTICAL BASE, EXPOSED SHELVES, AND WALL
- C. PROVIDE 3MM PVC EDGE BANDING ON ALL DOOR AND DRAWER FRONT EDGES IN THE COLORS SPECIFIED UNO.
- D. PROVIDE 3MM PVC EDGE BANDING ON ALL COUNTERTOP EDGES IN THE COLORS
- E. PROVIDE BEIGE MELAMINE AT SEMI-EXPOSED CASEWORK INTERIORS, AS DEFINED BY AWI STANDARDS, UNO.
- F. PROVIDE LAMINATE PL1 AT ALL EXPOSED CASEWORK INTERIORS UNO.

- WINDOW TREATMENTS

 A. REFER TO FINISH PLAN FOR EXTENT OF WINDOW TREATMENTS.
- B. PROVIDE WINDOW SHADES AT ALL EXTERIOR WINDOWS WITHIN SCOPE OF WORK
- C. INSTALL ALL EXTERIOR WINDOW COVERINGS [INSIDE MOUNT CONCEALED BEHIND FACTORY FINISHED FASCIA.

A. ALL FURNITURE (EQUIPMENT) IS OFOI UNO.

ABBREVIATIONS

```
ACOUSTICAL CEILING TILE
         AMERICANS WITH DISABILITIES ACT
         ABOVE FINISHED FLOOR
AFF
ALT
         ALTERNATE
CG
        CORNER GUARD
         CENTER LINE
CLG
         CEILING
CPT
         CARPET
        CERAMIC TILE
CTB
         CERAMIC TILE BASE
         CERAMIC TILE (FLOOR)
CTW
        CERAMIC TILE (WALL)
DEMO
        DEMOLITION
EP
         EPOXY PAINT
         EXISTING
         GRAB BAR
         GROUT
         HOLLOW METAL
         INTERIOR DESIGN
        LINER BAR
         LINOLEUM
```

NTS NOT TO SCALE PLASTIC LAMINATE RUBBER BASE/RESILIENT BASE REFERENCE **RESILIENT FLOORING** SUSPENDED ACOUSTICAL TILE SDT

WALL PROTECTION

WINDOW TREATMENT

STATIC DISSIPATIVE TILE SIM STAINLESS STEEL SHEET VINYL TYPICAL **UNLESS NOTED OTHERWISE** VINYL COMPOSITION TILE VOC VOLATILE ORGANIC COMPOUND

WT

FINISH LEGEND

FLOORING AND WALL BASE

LEES, PATTERN: GROUND STRATA DK963, COLOR: PEAR CACTUS; INSTALLATION: VERTICAL ASHLAR, CONTACT SHANNON WHITE (720) 217-8056 FOR NATIVIDAD LEES, PATTERN: REALIZATION, COLOR: WOODLAND #224; INSTALLATION: MONOLITHIC, CONTACT SHANNON WHITE (720) 217-8056 FOR NATIVIDAD MEDICAL

SHAW, PATTERN: PORTLAND TILE, COLOR: CHESTNUT #49700; INSTALLATION: BRICK ASHLAR

CERAMIC TILE BASE CTB2 AMERICAN OLEAN, SERIES: COLOR BY NUMBERS, COVED BASE COLOR: THREE HOUR TOUR WT03, SIZE: 4" x 8", GROUT: GR1

AMERICAN OLEAN, SERIES: AVENUE ONE, COLOR: PLAYGROUND SAND AU03, SIZE: 12" x 24"; GROUT: GR2

FORBO, MARMOLEUM REAL, COLOR: 3075 SHELL, WELDING ROD COLOR: R3075 MC

BURKE, 6" HIGH COVED BASE, COLOR: 508 TWEED

SHAW HARD SURFACE, NATURELIFE, STYLE: 00002V, COLOR: 05304 LIGHT MAPLE, ROLL SIZE: 72"W x 25'. THICKNESS: .86", WELD ROLD COLOR: WEL5304 SHAW HARD SURFACE, NATURELIFE, STYLE: 00002V, COLOR: 05306 BRAZILIAN CHERRY, ROLL SIZE: 72"W x 25'. THICKNESS: .86", WELD ROLD COLOR: WEL9446

ARMSTRONG, 51950 MARBLE BEIGE, THICKNESS: 1/8"

ARMSTRONG, CONNECTION CORLON, SANDSTONE 88713, SHEET SIZE: 82.5' x 6FT. THICKNESS: 2.0MM. WELD ROD COLOR: SANDLOT W0662

WALLS

CROSSVILLE, SERIES: COLOR BY NUMBERS, COLOR: THREE HOUR TOUR WT03, SIZE: 4" x 8"; GROUT: GR1

```
AMERICAN OLEAN, SERIES: LINEA, DECORATIVE LINER, COLOR: ARTICHOKE 0063, SIZE: .5" x 6", GROUT: GR1
LB3
          AMERICAN OLEAN, SERIES: LINEA, DECORATIVE LINER, COLOR: SUMMER RAIN 0081, SIZE: .5" x 6", GROUT: GR1
LB4
          AMERICAN OLEAN, SERIES: LINEA, DECORATIVE LINER, COLOR: NUTMEG 0037, SIZE: .5" x 6", GROUT: GR1
LB5
          AMERICAN OLEAN, SERIES: LINEA, DECORATIVE LINER, COLOR: AUTUMN LEAVES 0027, SIZE: .5" x 6", GROUT: GR1
```

```
SHERWIN WILLIAMS, COLOR: SW6126 NAVAJO WHITE
SHERWIN WILLIAMS, COLOR: SW6141 SOFTER TAN
SHERWIN WILLIAMS COLOR: SW6142, MACADAMIA
NOT USED
```

NOT USED

SHERWIN WILLIAMS, SW6366 AMBITIOUS AMBER NOT USED P12 SHERWIN WILLIAMS, COLOR: SW7616 BREEZY P13 NOT USED

SHERWIN WILLIAMS, COLOR: SW6529 SCANDA P15 NOT USED SHERWIN WILLIAMS, COLOR: SW6414 RICE PADDY P16 P17 P18 SHERWIN WILLIAMS, COLOR: SW6430 GREAT GREEN

SHERWIN WILLIAMS, COLOR: SW6431 LEAPFROG

CEILINGS

P19

ARMSTRONG, OPTIMA OPEN PLAN, 3250, TEGULAR FINE TEXTURE, 2'-0" x 2'-0" x 1" THICK; 15/16" SQUARE TEGULAR, WHITE ARMSTONG, FINE FISSURED, SECOND LOOK 1761, ANGELED TEGULAR

CASEWORK

WILSONART, COLOR: 10776-60 KENSINGTON MAPLE - VERTICAL: EDGE BANDING COLOR: EDGE BANDING COLOR: DOELLKEN, 4469 NEVAMAR, COLOR: SOVEREIGN CHERRY, #W8325T - VERTICAL; EDGE BANDING COLOR: DOELLKEN, 3994 WILSONART, COLOR: MORRO ZEPHYR #4846-60 - HORIZONTIAL: EDGE BANDING COLOR: DOELLKEN, 6396

MISCELLANEOUS

MAPEI, KERAPOXY, PREMIUM EPOXY MORTAR AND GROUT, 100% SOLIDS HIGH-STRENGTH EPOXY MORTAR AND CHEMICAL RESISTANT NON-SAGGING GROUT SYSTEM, RECOMMENDED GROUT JOINT 1/8" U.N.O.

KERAPOXY COLOR: #14 BISCUIT GR2 KERAPOXY COLOR: #06 HARVEST

MECHOSHADE, MECHO/5 STANDARD BRACKET, W/O FASCIA, THERMO VEIL, SINGLE, DENSE VERTICAL WEAVE, SHADECLOTH 1000 SERIES, COLOR #1002 BEIGE; APPROVED EQUALS: LUTRON OR DRAPER XD

MECHOSHADE, DOUBLESHADE BRACKETS- #15, W/O FASCIA, DUAL, EQUINOX BLACKOUT SHADECLOTH 0100 SERIES, COLOR: #0104 SANDSTONE; APPROVED EQUALS: LUTRON OR DRAPER XD

WALD RUHNKE & DOST ARCHITECTS LLP

2340 GARDEN ROAD, SUITE 100 MONTEREY, CALIFORNIA 93940

PHONE: 831.649.4642

FAX: 831.649.3530 WWW.WRDARCH.COM

THE USE OF THE PLANS AND SPECIFICATIONS IS RESTRICTED TO THE ORIGINAL SITE FOR WHICH THEY WERE PREPARED, AND PUBLICATION THEREOF IS EXPRESSLY LIMITED TO SUCH US REUSE, REPRODUCTION OR PUBLICATION I ANY METHOD IN WHOLE OR IN PART IS AND VISUAL CONTACT WITH THEM ACCEPTANCE OF THESE RESTRICTIONS.





0

∞ 0

PLOT DATE: 05/22/13 DRAWN BY: CHECKED BY: SET ISSUED: 75% CONSTRUCTION DOCS


JOB NO.:

PRINT

SHEET NAME:

GENERAL NOTES AND INTERIOR FINISH LEGEND


SHEET NO.:

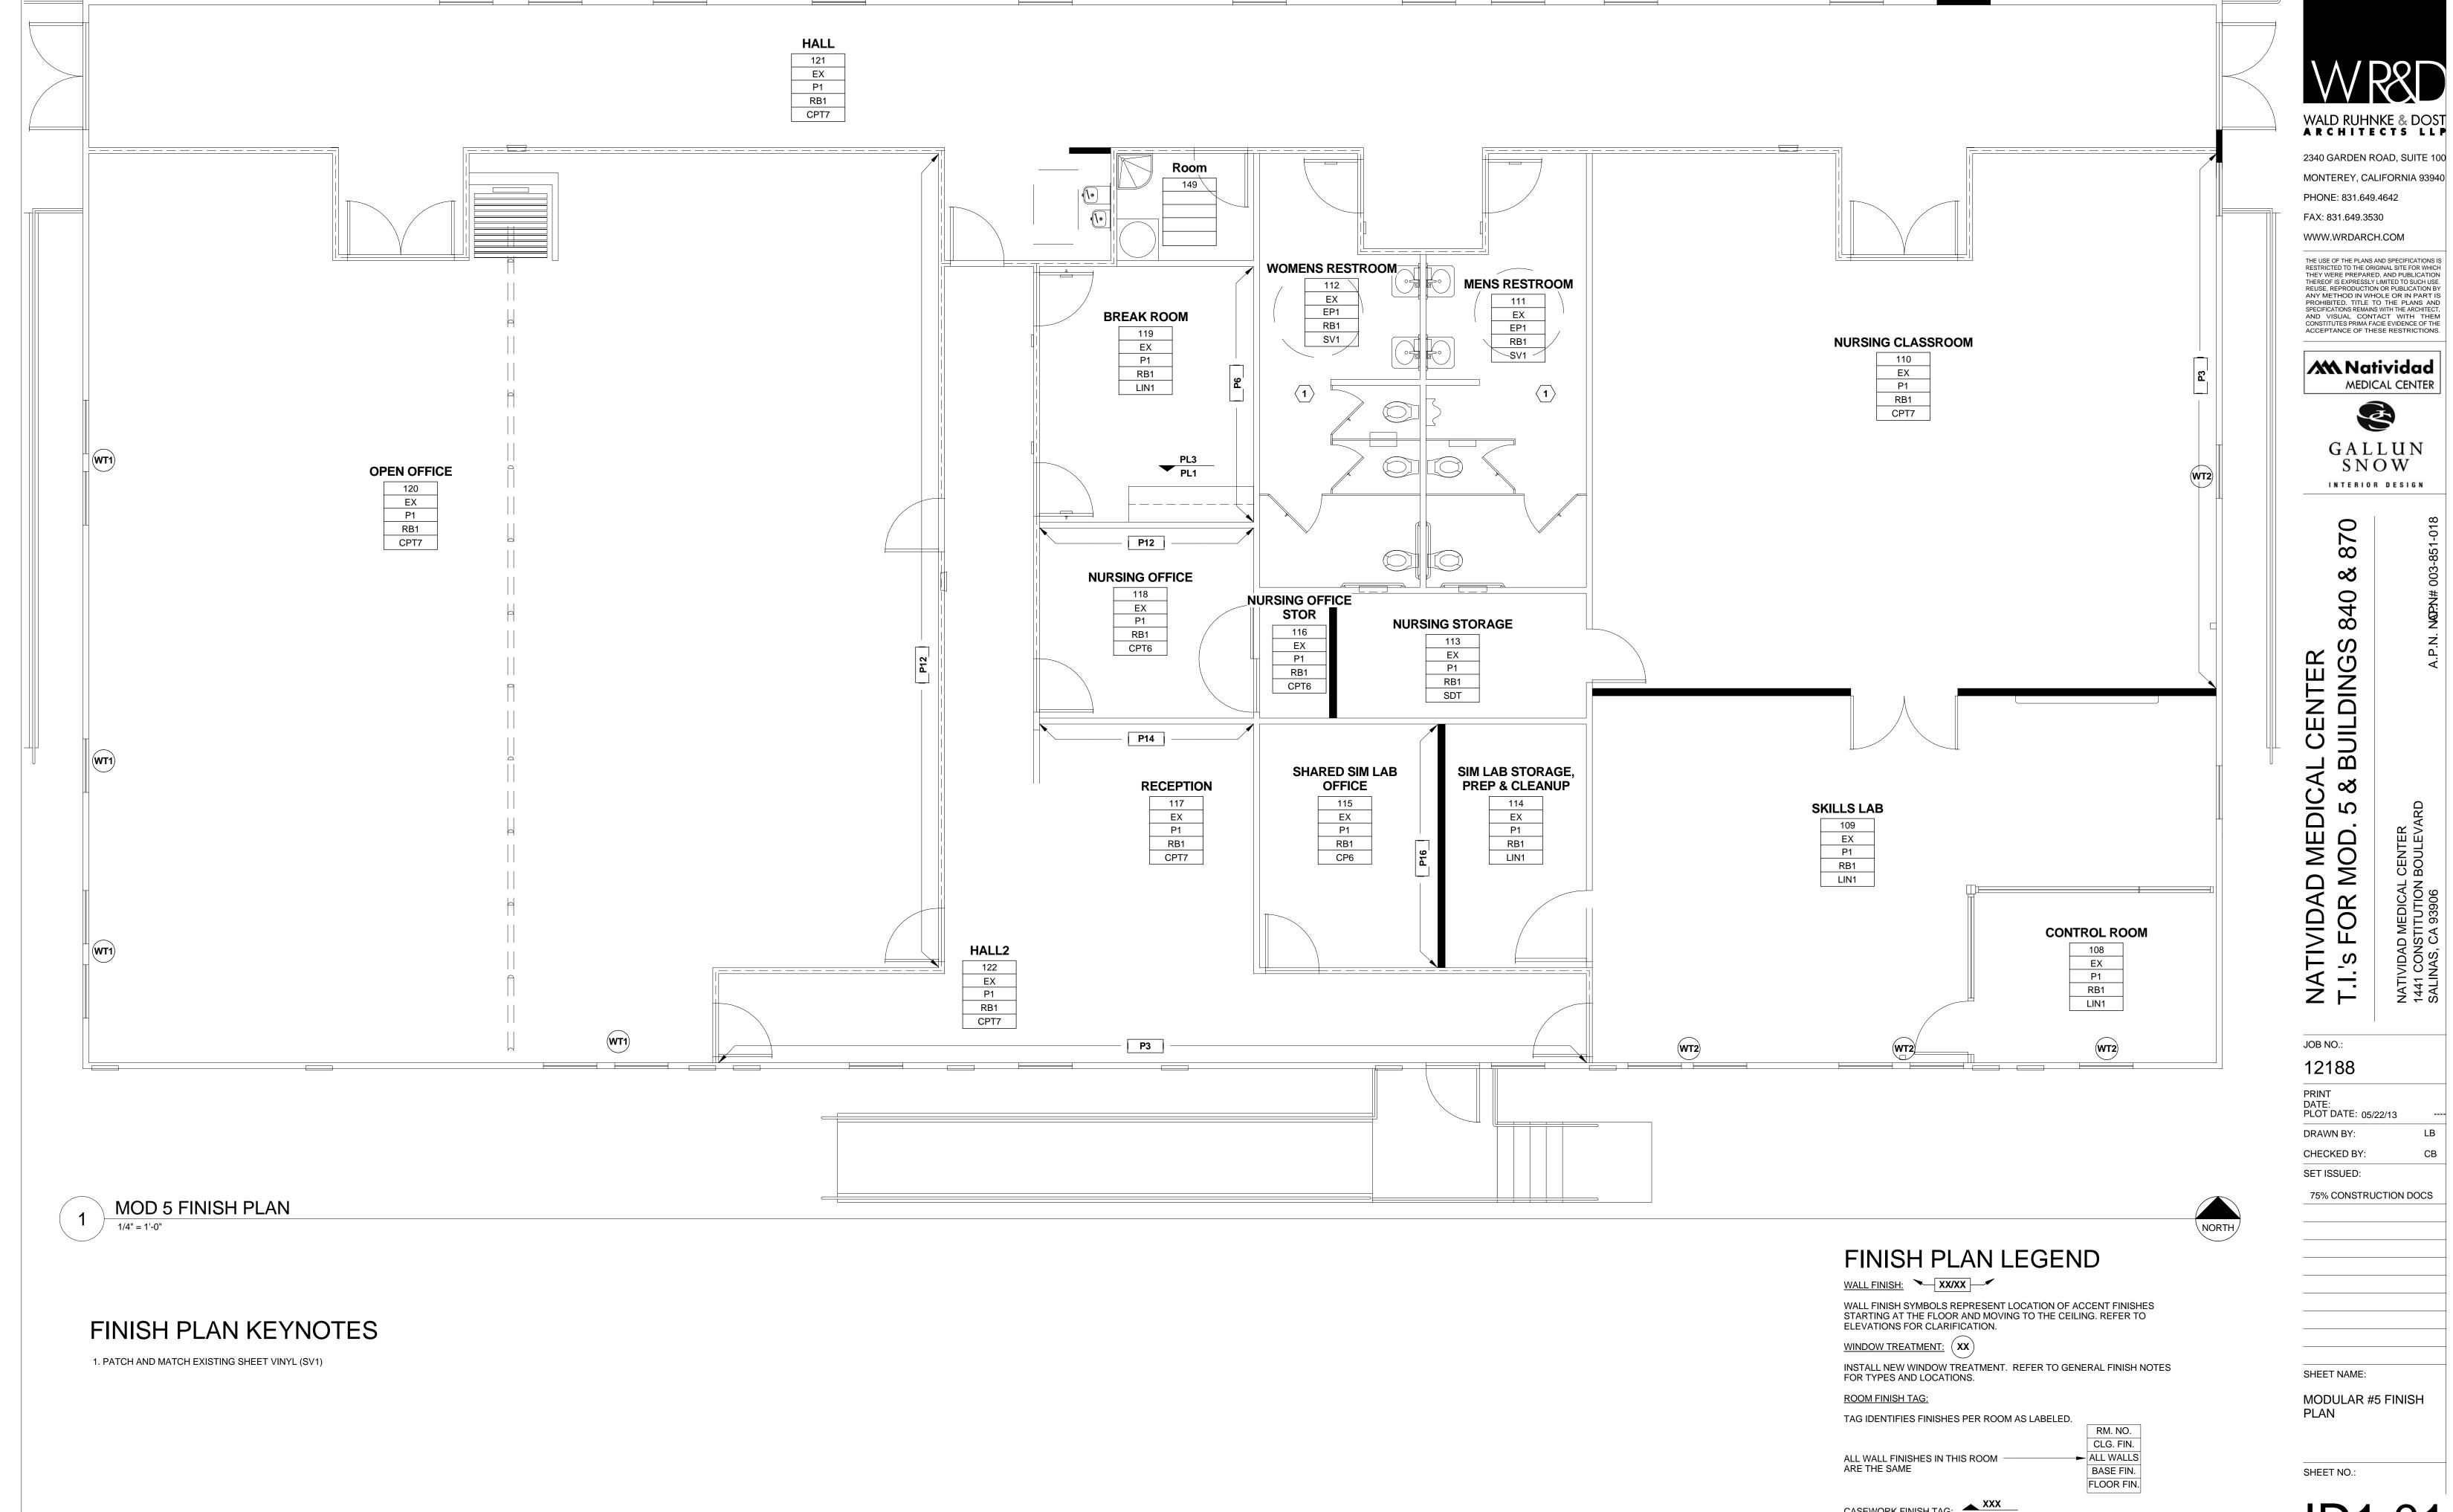

FILE NAME:

INDICATES CASEWORK FINISHES. ARROW POINTS TOWARD CASEWORK INDICATED. TOP LINE IS ALWAYS COUNTERTOP SURFACE. BOTTOM LINE

IS ALWAYS CABINET BODY AND DOOR FINISH.

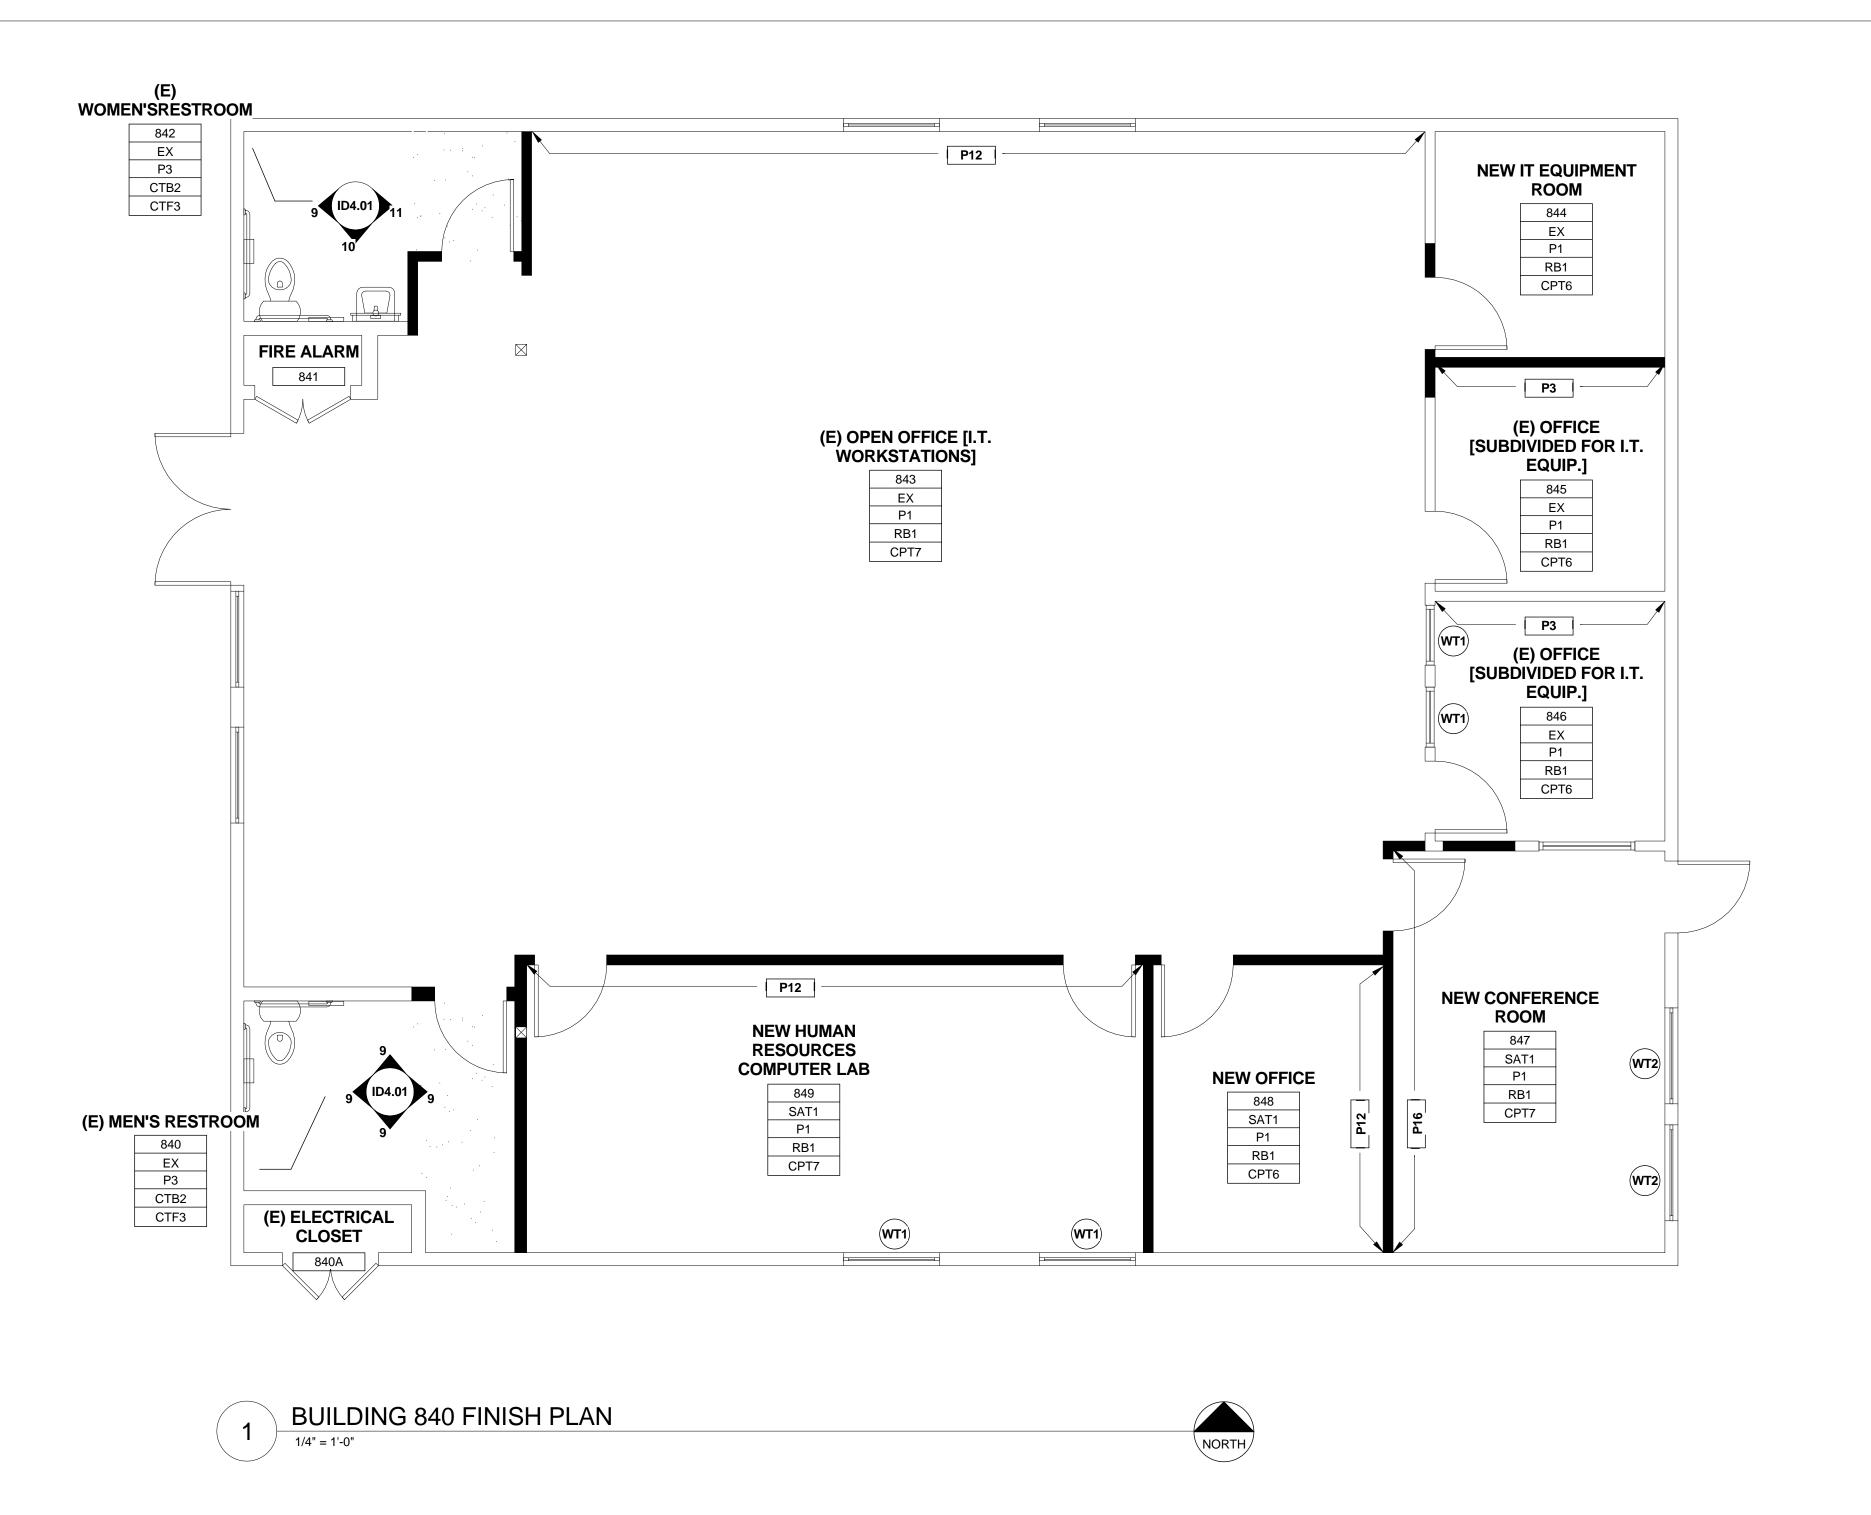

FINISH PLAN LEGEND

WALL FINISH: XX/XX

WALL FINISH SYMBOLS REPRESENT LOCATION OF ACCENT FINISHES STARTING AT THE FLOOR AND MOVING TO THE CEILING. REFER TO ELEVATIONS FOR CLARIFICATION.

WINDOW TREATMENT: (XX)

INSTALL NEW WINDOW TREATMENT. REFER TO GENERAL FINISH NOTES FOR TYPES AND LOCATIONS.

ROOM FINISH TAG:

TAG IDENTIFIES FINISHES PER ROOM AS LABELED.

		RM. NO.
		CLG. FIN.
ALL WALL FINISHES IN THIS ROOM	-	ALL WALLS
ARE THE SAME		BASE FIN.
		FLOOR FIN

INDICATES CASEWORK FINISHES. ARROW POINTS TOWARD CASEWORK INDICATED. TOP LINE IS ALWAYS COUNTERTOP SURFACE. BOTTOM LINE IS ALWAYS CABINET BODY AND DOOR FINISH.

CASEWORK FINISH TAG: XXX



WALD RUHNKE & DOST ARCHITECTS LLP

2340 GARDEN ROAD, SUITE 100 MONTEREY, CALIFORNIA 93940

FAX: 831.649.3530 WWW.WRDARCH.COM

PHONE: 831.649.4642

THE USE OF THE PLANS AND SPECIFICATIONS IS RESTRICTED TO THE ORIGINAL SITE FOR WHICH THEY WERE PREPARED, AND PUBLICATION THEREOF IS EXPRESSLY LIMITED TO SUCH USE. REUSE, REPRODUCTION OR PUBLICATION BY ANY METHOD IN WHOLE OR IN PART IS PROHIBITED. TITLE TO THE PLANS AND SPECIFICATIONS REMAINS WITH THE ARCHITECT, AND VISUAL CONTACT WITH THEM CONSTITUTES PRIMA FACIE EVIDENCE OF THE ACCEPTANCE OF THESE RESTRICTIONS.

M Natividad MEDICAL CENTER



0 87 840

JOB NO.: 12188

PRINT DATE: PLOT DATE: 05/22/13 DRAWN BY:


CHECKED BY: SET ISSUED:

75% CONSTRUCTION DOCS

SHEET NAME:

BUILDING 840 FINISH PLAN

SHEET NO.:

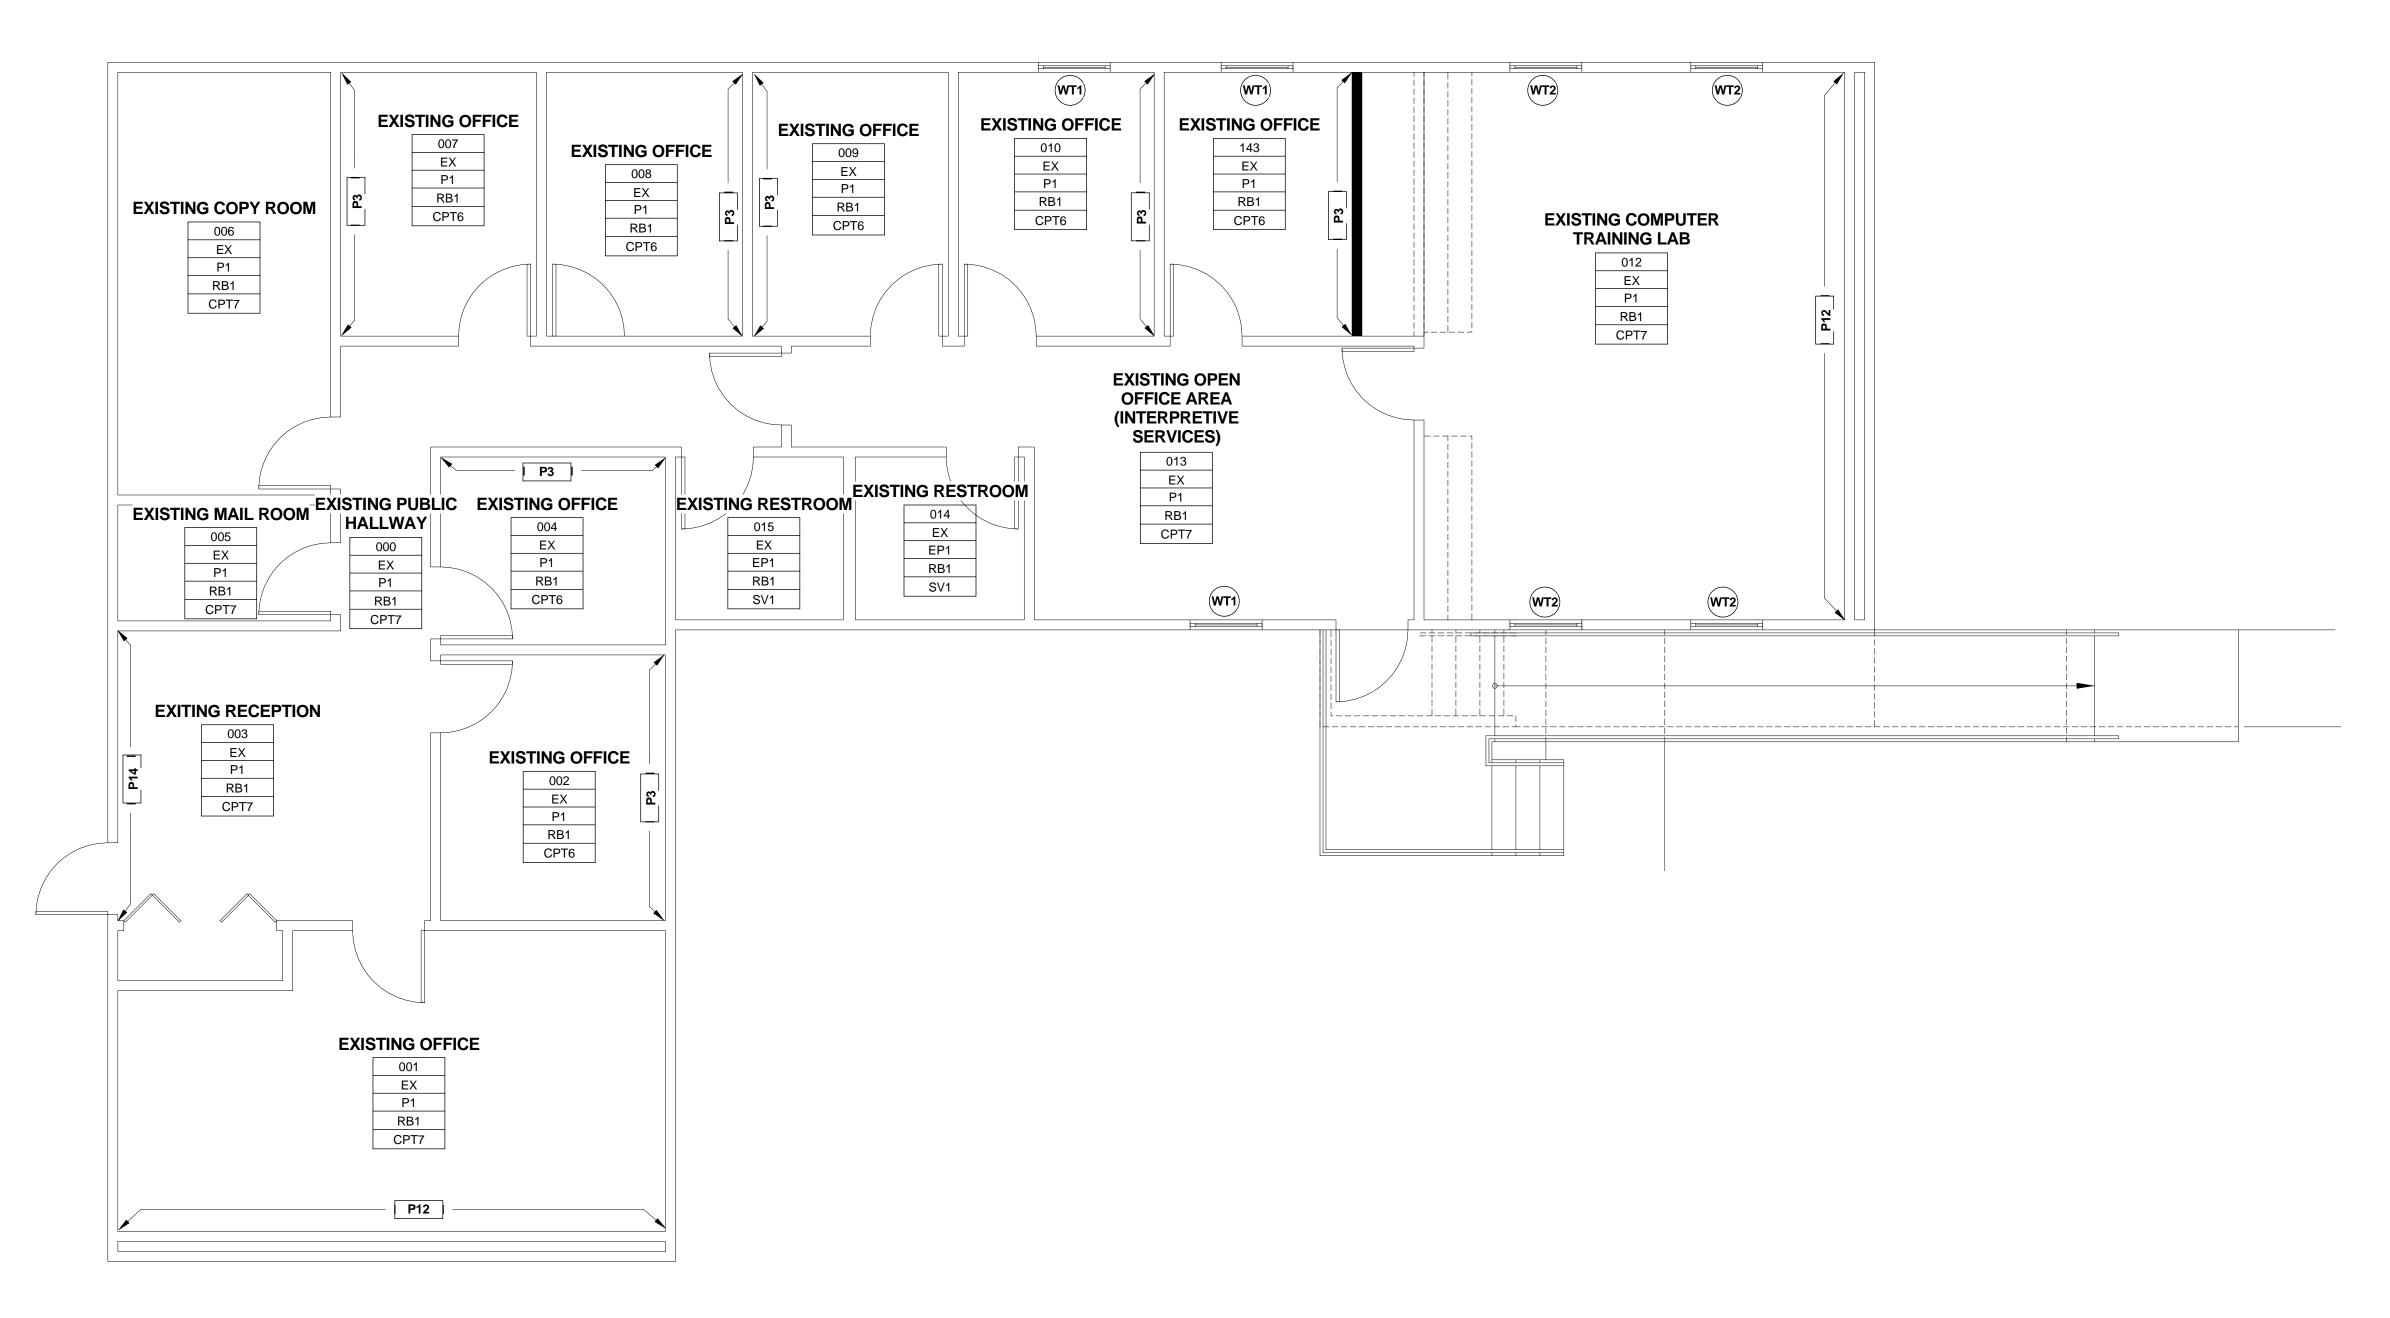

MANAGED CARE FINISH PLAN

FINISH PLAN LEGEND

WALL FINISH: XX/XX

WALL FINISH SYMBOLS REPRESENT LOCATION OF ACCENT FINISHES STARTING AT THE FLOOR AND MOVING TO THE CEILING. REFER TO ELEVATIONS FOR CLARIFICATION.

WINDOW TREATMENT: (XX)

INSTALL NEW WINDOW TREATMENT. REFER TO GENERAL FINISH NOTES FOR TYPES AND LOCATIONS.

ROOM FINISH TAG:

TAG IDENTIFIES FINISHES PER ROOM AS LABELED.

ALL WALL FINISHES IN THIS ROOM ARE THE SAME FLOOR FIN.

INDICATES CASEWORK FINISHES. ARROW POINTS TOWARD CASEWORK INDICATED. TOP LINE IS ALWAYS COUNTERTOP SURFACE. BOTTOM LINE IS ALWAYS CABINET BODY AND DOOR FINISH.

RM. NO. CLG. FIN. ALL WALLS BASE FIN.

CASEWORK FINISH TAG: XXX

WALD RUHNKE & DOST ARCHITECTS LLP

2340 GARDEN ROAD, SUITE 100 MONTEREY, CALIFORNIA 93940

FAX: 831.649.3530 WWW.WRDARCH.COM

PHONE: 831.649.4642

THE USE OF THE PLANS AND SPECIFICATIONS IS RESTRICTED TO THE ORIGINAL SITE FOR WHICH THEY WERE PREPARED, AND PUBLICATION THEREOF IS EXPRESSLY LIMITED TO SUCH USE. REUSE, REPRODUCTION OR PUBLICATION BY ANY METHOD IN WHOLE OR IN PART IS PROHIBITED. TITLE TO THE PLANS AND SPECIFICATIONS REMAINS WITH THE ARCHITECT, AND VISUAL CONTACT WITH THEM CONSTITUTES PRIMA FACIE EVIDENCE OF THE ACCEPTANCE OF THESE RESTRICTIONS.

M Natividad MEDICAL CENTER



0 ∞ 840


JOB NO.: 12188 PRINT DATE: PLOT DATE: 05/22/13 DRAWN BY:

CHECKED BY: SET ISSUED: 75% CONSTRUCTION DOCS

SHEET NAME:

MANAGED CARE FINISH PLAN

SHEET NO.:

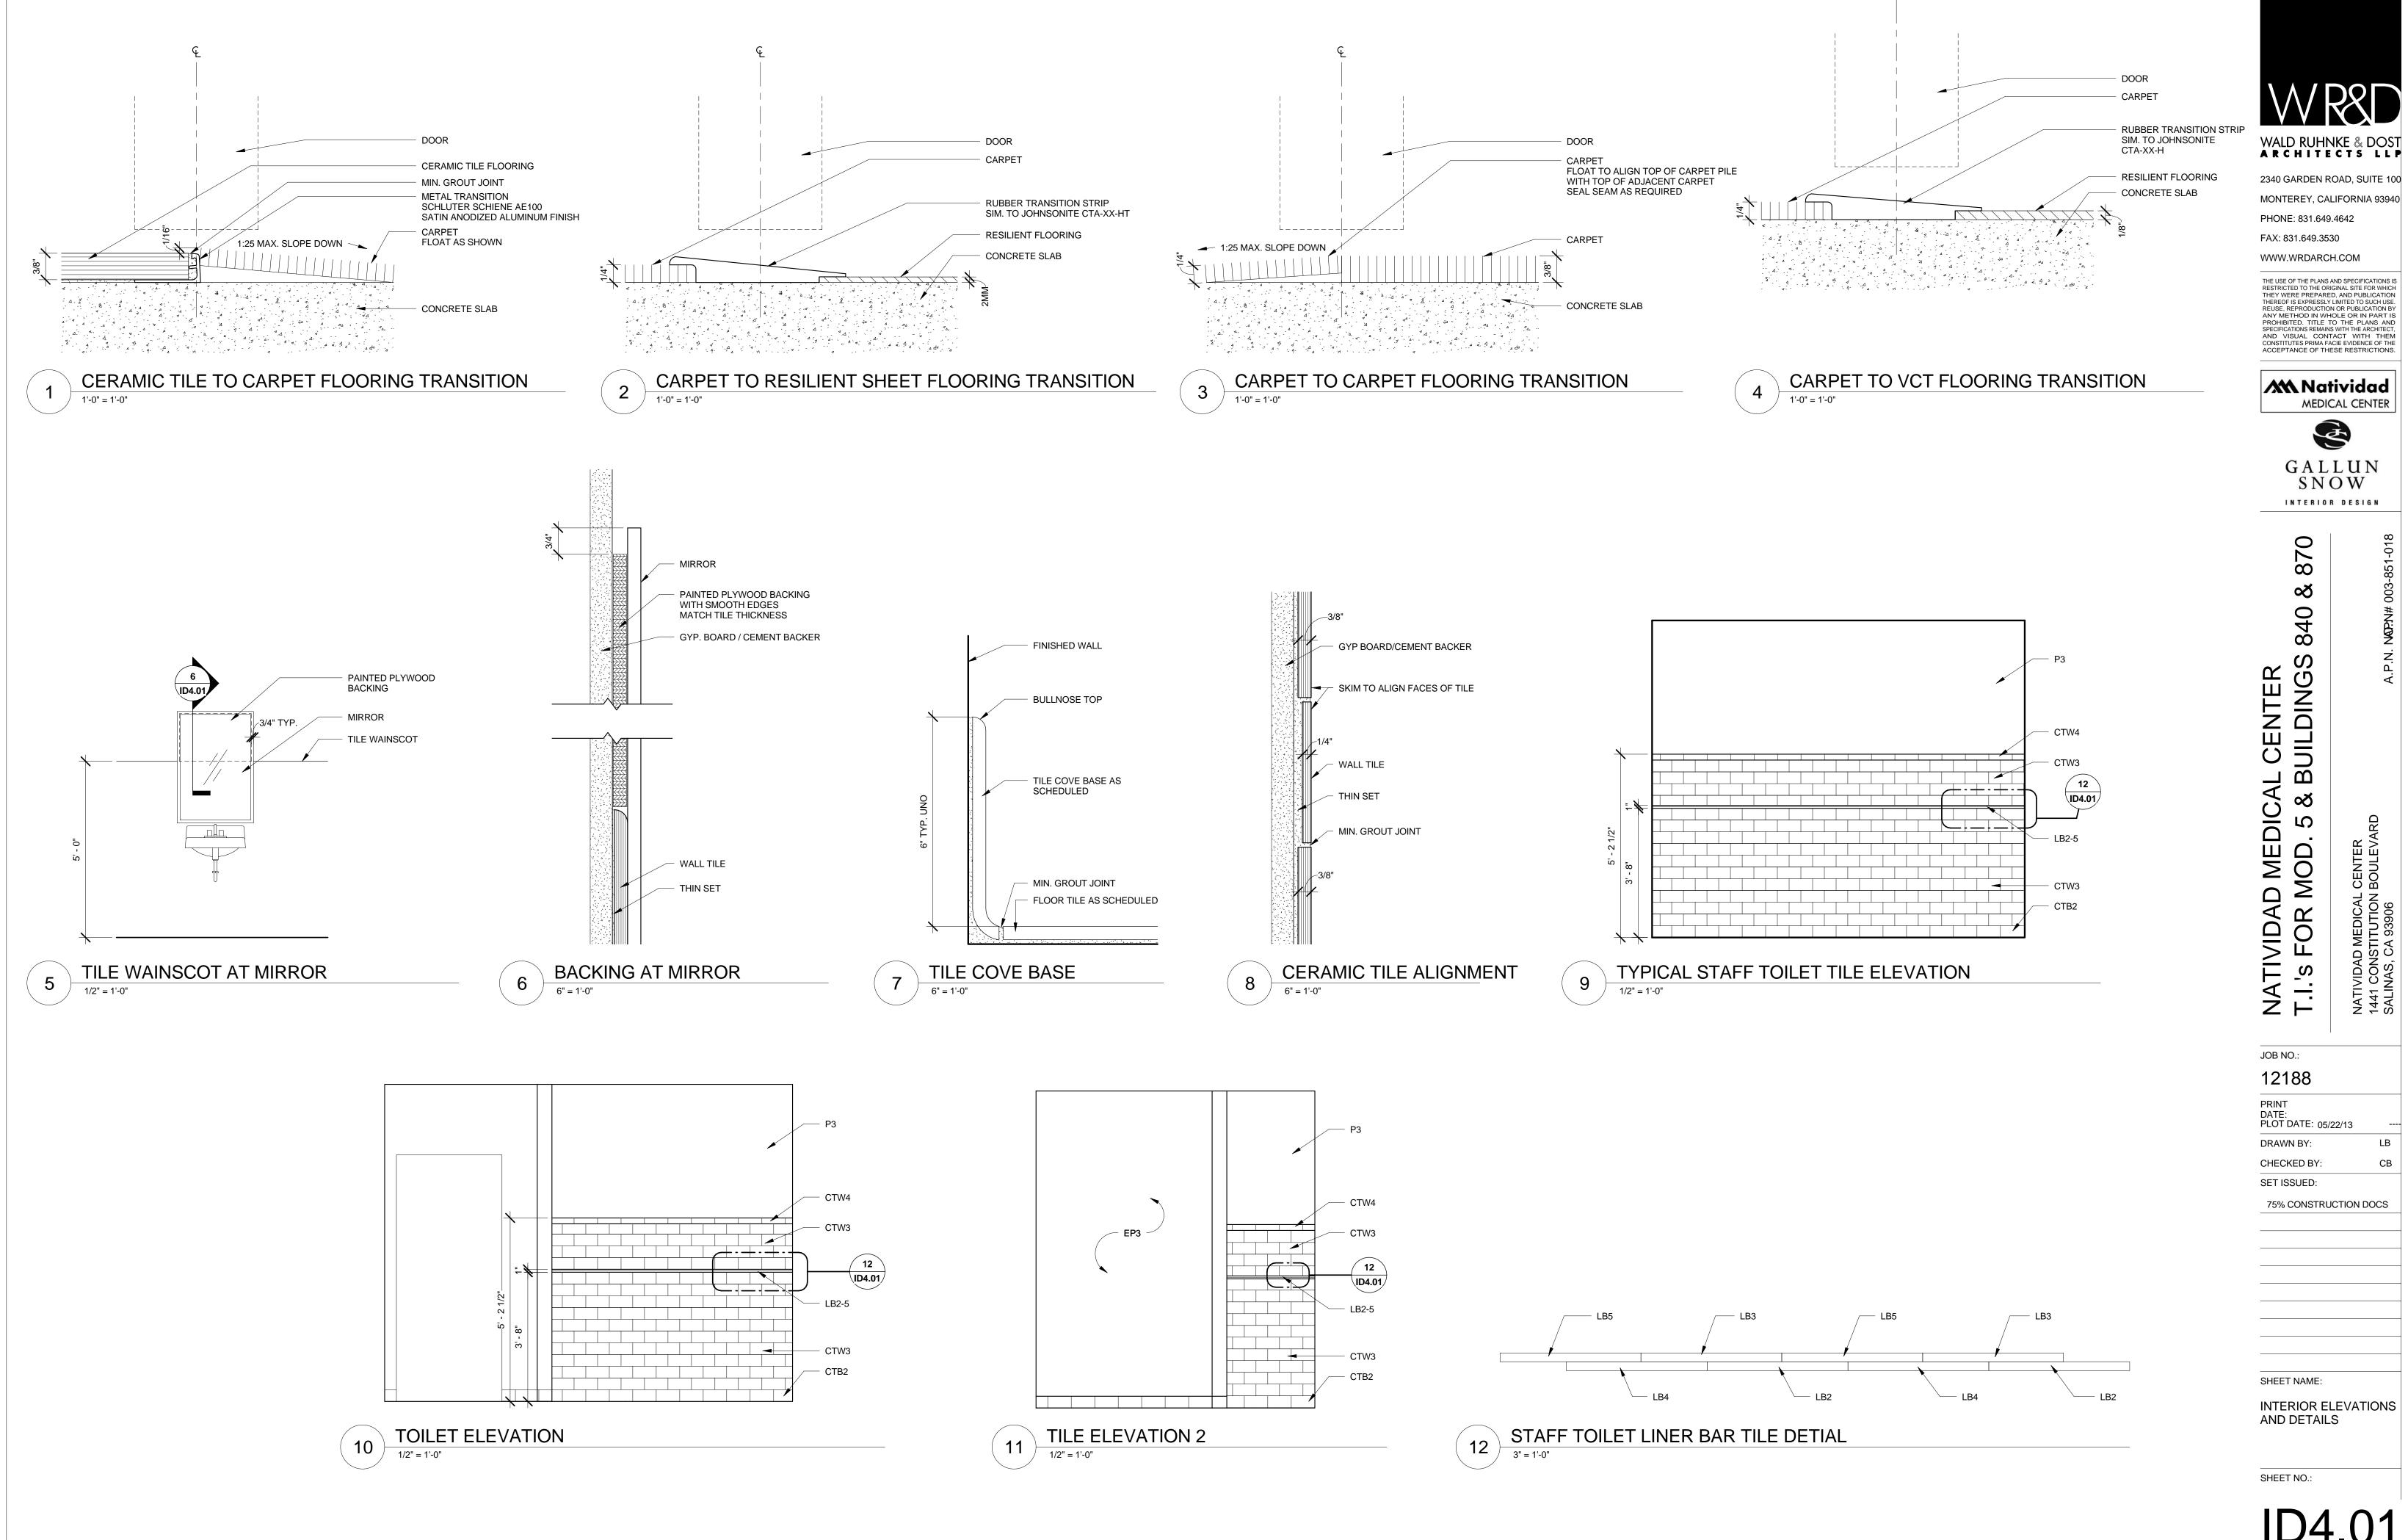

NATIVIDAD MEDICAL CENTER 1441 CONSTITUTION BOULEVA SALINAS, CA 93906