## Exhibit C



#### DRAFT RESOLUTION

# Before the Zoning Administrator in and for the County of Monterey, State of California

In the matter of the application of:

SAMIR MESSIAH (PLN170513)

#### **RESOLUTION NO. ----**

Resolution by the Monterey County Zoning Administrator:

- 1) Finding the project Categorically Exempt from per to section 15301(a)
- 2) Approving a Design Approval to allow a change in paint color from a previously approved off-white to a beige color;

[PLN170513, Samir Messiah, 26425 Via Petra, Carmel, Carmel Valley Master Plan (APN:015-271-016-000)]

The Messiah application (PLN170513) came on for public hearing before the Monterey County Zoning Administrator on August 31, 2017. Having considered all the written and documentary evidence, the administrative record, the staff report, oral testimony, and other evidence presented, the Zoning Administrator finds and decides as follows:

#### FINDINGS AND EVIDENCE

1. **FINDING: PROJECT DESCRIPTION** – The proposed project is a Design

Approval to allow the change of exterior body color from off-white/grey to a beige color (Behr paint color "Carving Party" M220-3); trim to

remain white.

**EVIDENCE:** The application, project plans, and related support materials submitted

by the project applicant to Monterey County RMA-Planning for the

proposed development found in Project File PLN170513.

2. **FINDING: CONSISTENCY** – The Project, as conditioned, is consistent with the

applicable plans and policies which designate this area as appropriate

for development.

**EVIDENCE:** a) During the course of review of this application, the project has been

reviewed for consistency with the text, policies, and regulations in:

- The 2010 Monterey County General Plan;
- Carmel Valley Master Plan
- Monterey County Zoning Ordinance (Title 21);

No conflicts were found to exist. No communications were received during the course of review of the project indicating any inconsistencies with the text, policies, and regulations in these documents.

b) The property is located at 26425 Via Petra (Assessor's Parcel Number 015-271-016), Carmel Valley Master Plan. The parcel is zoned LDR/2.5-D-S, which allows minor modifications to existing structures

- with the issuance of a Design Approval. Therefore, the project is an allowed land use for this site.
- c) The subject site is in a Design Control "D" zoning district, which provides regulation of the location, size, configuration, materials, and colors of structures and fences, except agricultural fences, in those areas of the County of Monterey where the design review of structures is appropriate to assure protection of the public viewshed, neighborhood character, and to assure the visual integrity of certain developments without imposing undue restrictions on private property. Projects in "D" districts require a Design Approval application. In January 2017, an addition and remodel for the Messiah residence was approved via a public hearing Design Approval. That resolution (Resolution No. 17-001) approved the addition and remodel with off-white/grey colors to match the existing paint colors. Changing the already approved paint color requires a new Design Approval, therefore the project is consistent with this requirement.
- d) The project is consistent with the intent and purpose of the "D" (Design Control) district. Homes in the neighborhood are a mix of pastel and earth tone hues. The proposed light orange coral is similar to other yellow and beige homes seen on Via Petra; therefore the project is consistent with the neighborhood character of the surrounding area.
- e) The subject property includes an "S" (Site Plan Review) overlay, which requires an Administrative Permit for construction. This project does not involve any construction only the change in color for an existing structure, so this requirement does not apply.
- f) The project is consistent with the intent and purpose of Carmel Valley Master Plan Policy CV-1.20, which requires development to be visually compatible with the surrounding areas or enhance the quality of areas that have been degraded by existing development. The proposed color is consistent with the colors of other homes in the neighborhood.
- g) The project planner conducted a site inspection on May 26, 2017 to verify that the project on the subject parcel conforms to the plans listed above.
- h) The project was referred to the Carmel Valley Land Use Advisory Committee (LUAC) for review. Based on the LUAC Procedure guidelines adopted by the Monterey County Board of Supervisors, this application did warrant referral to the LUAC because it is a Design Approval subject to review by the Zoning Administrator. The LUAC did not recommend approval of the proposed color change and expressed concerns that the color was too intense to fit with the neighborhood character. Staff considered the concerns expressed by the LUAC, and examined the color of homes in the neighborhood. Homes in Via Petra represent a wide range of pastel and colors, so staff determined that the proposed color is consistent with the neighborhood character.
- i) The application, project plans, and related support materials submitted by the project applicant to Monterey County RMA-Planning for the proposed development found in Project File PLN170513.

3. **FINDING: SITE SUITABILITY** – The site is physically suitable for the use proposed.

**EVIDENCE:** a) The project has been reviewed for site suitability by RMA-Planning. It did not warrant review by other departments or agencies because it is strictly a change in color.

- b) No potential impacts were identified. The project does not have the potential to impact the environment.
- c) Staff conducted a site inspection on May 26, 2017 to verify that the site is suitable for this use.
- d) The application, project plans, and related support materials submitted by the project applicant to the Monterey County RMA Planning for the proposed development found in Project File PLN170513.

#### 4. **FINDING:**

**HEALTH AND SAFETY -** The establishment, maintenance, or operation of the use or structure applied for, will not, under the circumstances of the particular case, be detrimental to the health, safety, peace, morals, comfort, and general welfare of persons residing or working in the neighborhood of such proposed use; or be detrimental or injurious to property and improvements in the neighborhood; or to the general welfare of the County.

**EVIDENCE:** 

- a) The project was reviewed by RMA Planning. No potential for adverse effects on health, safety, or welfare were identified and there are no proposed conditions.
- b) Necessary public facilities are available. The project is a change in color to an already existing and approved single family dwelling and no additional public facilities are necessary as a result of this change in color.
- c) Staff conducted a site inspection on May 26, 2017 to verify that the site is suitable for this use.
- d) The application, project plans, and related support materials submitted by the project applicant to the Monterey County RMA Planning for the proposed development found in Project File PLN170531.

#### 5. **FINDING:**

**NO VIOLATIONS** - The subject property is in compliance with all rules and regulations pertaining to zoning uses, subdivision, and any other applicable provisions of the County's zoning ordinance. No violations exist on the property.

**EVIDENCE:** 

- a) Staff reviewed Monterey County RMA Planning and Building Services Department records and is not aware of any violations existing on subject property.
- b) Staff conducted a site inspection on May 26, 2017 and researched County records to assess if any violation exists on the subject property.
- c) The application, plans and supporting materials submitted by the project applicant to Monterey County RMA-Planning for the proposed development are found in Project File PLN170531.

#### 6. **FINDING:**

**CEQA (Exempt): -** The project is categorically exempt from environmental review and no unusual circumstances were identified to exist for the proposed project.

**EVIDENCE:** 

- a) California Environmental Quality Act (CEQA) Guidelines Section 15301(a) categorically exempts interior or exterior alterations involving such things as interior partitions, plumbing, and electrical conveyances.
- b) The project is a change from a previously approved paint color in a residential neighborhood and has no potential to negatively affect the environment.
- c) No adverse environmental effects were identified during staff review of the development application during a site visit on May 26, 2017.
- d) None of the exceptions under CEQA Guidelines Section 15300.2 apply to this project.
- e) The application, project plans, and related support materials submitted by the project applicant to Monterey County RMA-Planning for the proposed development found in Project File PLN170531.
- 7. **FINDING: APPEALABILITY -** The decision on this project may be appealed to the Planning Commission.
  - **EVIDENCE:** a) Section 21.80.040(B) of the Monterey County Zoning Ordinance states that the proposed project is appealable to the Planning Commission.

#### **DECISION**

**NOW, THEREFORE**, based on the above findings and evidence, the Zoning Administrator does hereby:

- 1. Find the project exempt per section 15301(a) of the California Environmental Quality Act
- 2. Approve the Design Approval in general conformance with the attached color sample

**PASSED AND ADOPTED** this 31st day of August, 2017:

	Mike Novo, Zoning Administrator
COPY OF THIS DECISION MAILED TO APPLICANT	Γ ON
THIS APPLICATION IS APPEALABLE TO THE PLA	NNING COMMISSION.
IF ANYONE WISHES TO APPEAL THIS DECISION, AND SUBMITTED TO THE SECRETARY OF THE PI APPROPRIATE FILING FEE ON OR BEFORE	LANNING COMMISSION ALONG WITH THE

This decision, if this is the final administrative decision, is subject to judicial review pursuant to California Code of Civil Procedure Sections 1094.5 and 1094.6. Any Petition for Writ of Mandate must be filed with the Court no later than the 90th day following the date on which this decision becomes final.

#### **NOTES**

1. You will need a building permit and must comply with the Monterey County Building Ordinance in every respect.

Additionally, the Zoning Ordinance provides that no building permit shall be issued, nor any use conducted, otherwise than in accordance with the conditions and terms of the permit granted or until ten days after the mailing of notice of the granting of the permit by the appropriate authority, or after granting of the permit by the Board of Supervisors in the event of appeal.

Do not start any construction or occupy any building until you have obtained the necessary permits and use clearances from Monterey County RMA-Planning and RMA-Building Services Department office in Salinas.

2. This permit expires 3 years after the above date of granting thereof unless construction or use is started within this period.

Form Rev. 5-14-2014

# REMODEL & ADDITION

# SAMIR MESSIAH 26425 VIA PETRA, CARMEL, CA. 93923

APN 015-271-016-000

SIAH

RES SA DRAWN: MTC CHECKED: RBC

4/30/16 DATE:

SHE OVER

15-386

**REVISIONS:** ISSUED FOR BLDG PERMIT 4/30/

SHEET NO:

**GENERAL NOTES AREA MAP** 



26425 VIA PETRA CARMEL, CA

PROJECT DATA

SAMIR MESSIAH

THESE NOTES ARE ARRANGED ACCORDING TO THE FOLLOWING DIVISIONS AS A CONVENIENCE TO THE CONTRACTOR. GENERAL NOTES ARE NOT LIMITED BY THEIR DIVISION HEADING AND APPLY AS NECESSARY THROUGHOUT THE ENTIRE PROJECT.

- A) ALL CONTRACTORS WORK SHALL CONFORM TO THE 2013 CALIFORNIA BUILDING, MECHANICAL, ELECTRICAL PLUMBING, AND FIRE CODES, AMERICANS WITH DISABILITIES ACT. AND ALL OTHER APPLICABLE CODES, OR THOSE ADOPTED BY COUNTY OF MONTEREY, CALIFORNIA. GOVERNING AUTHORITIES AND CODES TAKE
- READING THE PLANS
- A) DIMENSIONS SHALL GOVERN ON WORKING DRAWINGS. DO NOT SCALE DRAWINGS. B) IN THE EVENT CERTAIN FEATURES OF THE CONSTRUCTION ARE NOT FULLY SHOWN ON THE DRAWINGS OR CALLED FOR IN THE NOTES OR SPECIFICATIONS, THEN THEIR CONSTRUCTION SHALL BE OF THE SAME CHARACTER AS FOR SIMILAR CONDITIONS THAT ARE SHOWN OR CALLED FOR
- C) SHOULD CONFLICTS OCCUR BETWEEN THE DRAWINGS AND SPECIFICATIONS. DRAWINGS SHALL GOVERN IN
- THE SPECIFICATIONS, OR BETWEEN THE DRAWINGS AND THE SPECIFICATIONS, THE MOST EXPENSIVE REQUIREMENT SHOWN OR SPECIFIED SHALL BE THE BASIS OF THE CONTRACT.

PRIOR TO CONSTRUCTION AND GRADING, VERIFY ALL EXISTING CONDITIONS AND CONTACT UTILITY COMPANIES AND AFFECTED CITY AGENCIES. CONTACT "UNDERGROUND SERVICE ALERT" PHONE: (800) 642-2444. THE CONTRACTOR SHALL THOROUGHLY REVIEW PLANS AND EXISTING SITE CONDITIONS AND NOTIFY ENGINEER OF ANY DISCREPANCIES, ERRORS OR OMISSIONS PRIOR TO CONSTRUCTION. ALWAYS CALL 811 AT LEAST 2 WORKING DAYS BEFORE STARTING THE PROJECT THAT INVOLVES DIGGING TO

SITE WORK

A) THE CIVIL ENGINEER IS RESPONSIBLE FOR PROVIDING THE FOLLOWING INFORMATION:

HAVE GAS PIPELINES AND OTHER UNDERGROUND UTILITY LINES LOCATED AND MARKED.

- 1) FINISHED AND EXISTING GRADES
- 2) ALL SITE DRAINAGE
- 3) SIZES AND TYPE OF CURB AND GUTTERS 4) SITE DIMENSION AND SETBACKS
- ) VERIFY DIMENSIONS, GRADES, ELEVATIONS AND CRITICAL LOCATIONS, SUCH AS STRUCTURAL SUPPORTS, BEFORE COMMENCING WORK AFFECTED BY THEM. THE CONTRACTOR SHALL REPORT ANY DISCREPANCIES TO THE ENGINEER IMMEDIATELY.

- 5. <u>JOB SITE</u>
- A) IT SHALL BE THE RESPONSIBILITY OF THE CONTRACTOR TO LOCATE ALL EXISTING UTILITIES, WHETHER SHOWN HEREIN OR NOT, AND TO PROTECT THEM FROM DAMAGE. THE CONTRACTOR SHALL BEAR ALL THE EXPENSE FOR REPAIR OR REPLACEMENT OF UTILITIES AND/OR OTHER PROPERTY DAMAGED BY OPERATIONS IN CONJUNCTIONS WITH THE EXECUTION OF WORK.
- B) CONTRACTOR SHALL PROVIDE TEMPORARY PROJECT OFFICE, TELEPHONE, FAX MACHINE, SECURITY FENCE, WATER, POWER, AND TOILET FACILITIES. COORDINATE LOCATIONS WITH ALL APPROPRIATE AGENCIES.
- IN GOOD CONDITION, ONE COMPLETE SET OF PLANS AND SPECIFICATIONS WITH ALL REVISIONS, ADDENDA, AND CHANGE ORDERS ON THE PREMISES AT ALL TIMES. THESE ARE TO BE UNDER THE CARE OF THE JOB
- D) CONTRACTOR SHALL BE RESPONSIBLE FOR THE COMPLETE SECURITY OF THE SITE WHILE THE JOB IS IN PROGRESS AND UNTIL THE JOB IS COMPLETE
- E) CONTRACTOR SHALL MAINTAIN THE SITE IN A CLEAN AND ORDERLY MANNER. NO RADIOS, ALCOHOL, OR CONTROLLED SUBSTANCES ARE ALLOWED ON THE JOB SITE. ALL DEBRIS SHALL BE REMOVED FROM PREMISES, AND ALL AREAS SHALL BE LEFT IN A BROOM-CLEAN CONDITION ON A DAILY BASIS.

- A) FIELD CONFIRMATION OF DISCREPANCIES SHALL BE RECORDED ON A REPRODUCIBLE DOCUMENT AND IMMEDIATELY TRANSMITTED TO ENGINEER FOR PROJECT RECORD, COORDINATION, AND NECESSARY RESOLUTION
- B) THE GENERAL CONTRACTOR SHALL PROVIDE OR MAKE AVAILABLE A COMPLETE SET OF CONSTRUCTION PARTICULAR TRADE. FURTHERMORE, THE GENERAL CONTRACTOR SHALL INSURE THAT EACH SUBCONTRACTOR WORKING ON THE PROJECT MAINTAINS A FULL SET OF CONSTRUCTION DOCUMENTS THROUGHOUT THE CONSTRUCTION OF THE PROJECT.

DRAWING SHEET

#### 8. COMPLETION

A) ONE SET OF EQUIPMENT OPERATING AND MAINTENANCE MANUALS PER UNIT SHALL BE SUBMITTED TO OWNER UPON COMPLETION OF PROJECT, PRIOR TO REQUEST FOR FINAL PAYMENT.

**ARCHITECTURAL** 

A0 COVER SHEET

A0.1 EXISTING SITE PHOTOS

A1.1 EXISTING / DEMO

A1.2 EXISTING / DEMO

A1.3 EXISTING ROOF PLAN

A1.4 EXISTING ELEVATIONS

A2.0 NEW MAIN FLOOR PLAN

A4.0 NEW ROOF PLAN

**ELEVATIONS** 

S1.0 STRUCTURAL NOTES

S1.3 TYP. WOOD DETAILS

S2.1 FOUNDATION PLAN &

S2.3 ROOF FRAMING PLAN

S3.1 FOUNDATION DETAILS

S3.2 FOUNDATION DETAILS

C2 GRADING AND DRAINAGE

S1.4 TYP. FRAMING DETAILS

S2.2 2ND FLOOR FRAMING PLAN

1ST FLOOR FRAMING PLAN

S1.2 TYP. CONCRETE DETAILS

A8.0 DETAILS

A9.0 DETAILS

STRUCTURAL

A3.1 GENERAL NOTES & LEGENDS/

A5.0 FRONT & REAR ELEVATIONS

A6.0 RIGHT SIDE / LEFT SIDE

KEY FLOOR PLAN NOTES

A7.0 SECTIONS (LONG. & TRANSVERSE)


A1.0 AREA CALCULATION/ EXTERIOR

ATTIC / LOFT FLOOR PLAN

WALL CALCULATIONS

MAIN FLOOR PLAN

B) CONTRACTOR SHALL ASSIST OWNER IN OBTAINING "CERTIFICATE OF OCCUPANCY" OR "OCCUPANCY PERMIT"

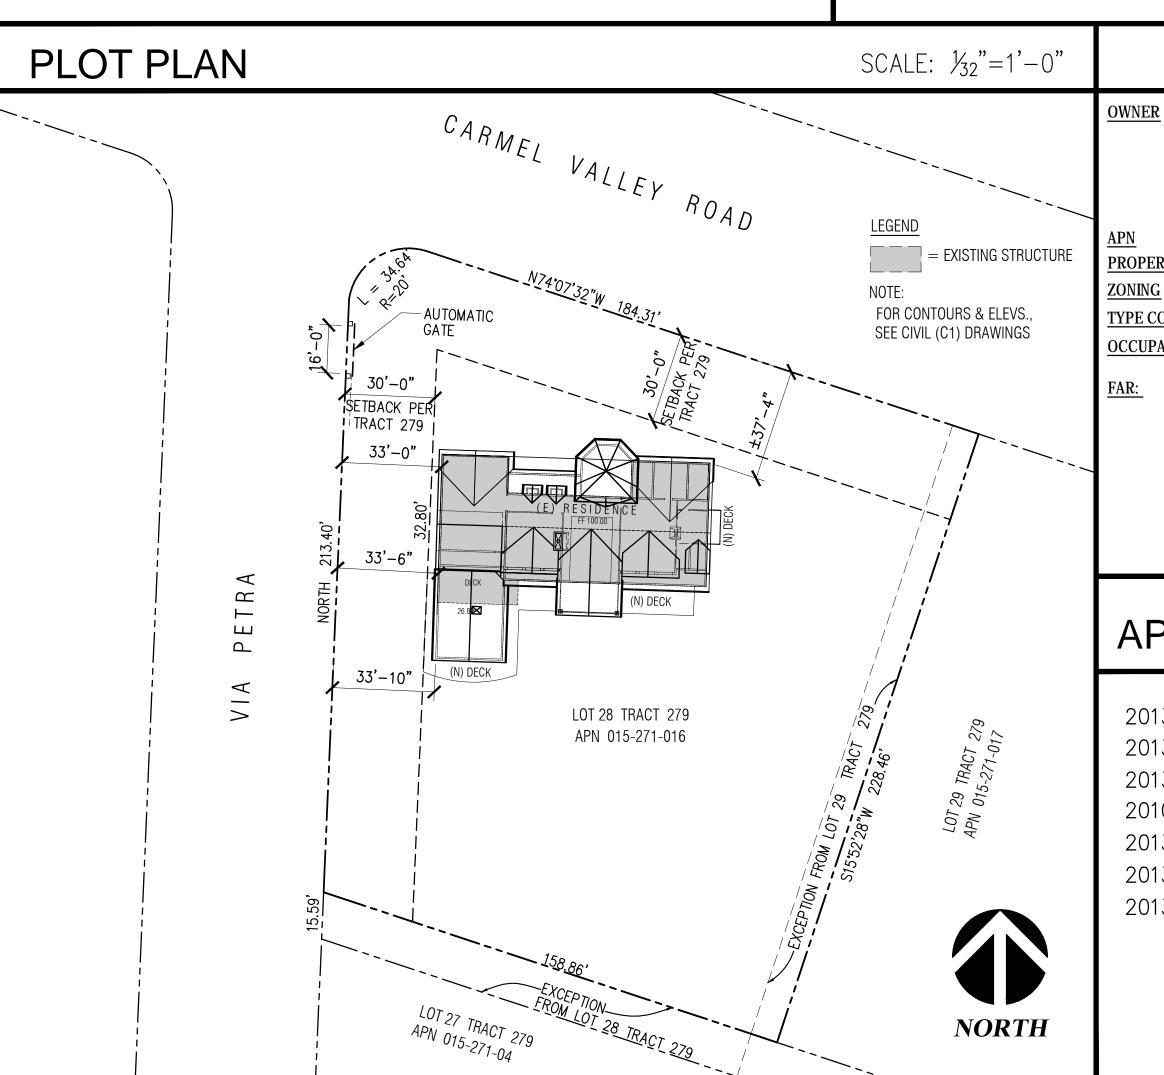

26425 VIA PETRA

CARMEL, CA

**VICINITY MAP** 


26245 VIA PETRA EXISTING FIRST FLOOR AREA 2,213 SF CARMEL, CA EXISTING ATTIC AREA (LIVABLE) 415-4370701 TOTAL EXISTING AREA APN 015-271-016 PROPOSED 1ST REMODEL (216 + 78) PROPOSED 1ST FLOOR ADDITION (270+830) 40276 SF (.925 AC) PROPERTY AREA PROPOSED 2ND FLOOR REMODEL (244+540+146+60) LDR/2.5-D-S-RAZ TOTAL NEW FLOOR AREA (LESS GARAGE) TYPE CONSTRUCTION V - NOCCUPANCY GROUPS R-1, U-1 TOTAL NEW FLOOR AREA (INCL GARAGE) 6506/40276 = .16NON-LIVABLE AREA EXISTING GARAGE AREA EXISTING STORAGE AREA ABV GARAGE (NO WORK) NEW FLOOR STORAGE AREA ABOVE (NON-LIVABLE) PROPOSED MAIN FLOOR DECK

LIVABLE AREA

- 1,197 SF 3410 SF 294 5 1,100 SF 990 SF 5,794 SF 6.506 S 712 SF 712 SF 216 SF 1033 S 248 SI PROPOSED 2ND FLOOR DECK 1,281 SF TOTAL DECK AREA (1ST & 2ND)
  - ▶ RELOCATE (E) ATTIC STAIRS INTO (N) HALLWAY (BY GUEST STE) • REMODEL ATTIC AREA & CONVERT TO MASTER SUITE, (N) FAMILY ROOM & STORAGE (TOTAL AREA = 990 SF) PARTIAL ROOF REMODEL TO CONFORM WITH THE 2ND FLOOR (7'-6" MIN TO 8'-0") CLG HT REAR DECK ADDITION AT MAIN FLOOR (1,033 SF) & 2ND FLOOR (248 SF) INSTALL AUTOMATIC ENTRY (BY OTHERS)
- **LEGEND** APPLICABLE CODES
- 2013 CALIFORNIA BUILDING CODE 2013 CALIFORNIA RESIDENTIAL CODE 2013 CALIFORNIA ELECTRIC CODE 2010 CALIFORNIA ENERGY CODE 2013 CALIFORNIA MECHANICAL CODE 2013 CALIFORNIA PLUMBING CODE 2013 CALIFORNIA FIRE CODE
- Sheet where found Sheet where found <u>TAIL NUMBER</u> Sheet where found See sheet notes on A3.1

DOOR NUMBER

See Door Schedule

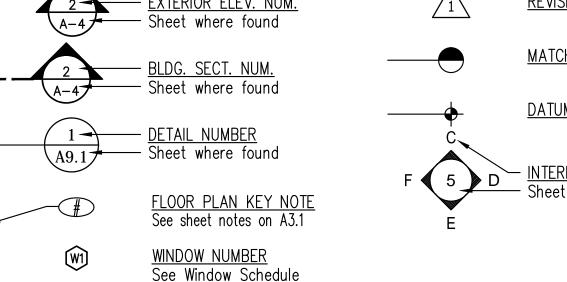

- **REVISION NUMBER** EXTERIOR ELEV. NUM.
  - <u>MATCHLINE</u> DATUM OR WORK POINT - <u>INTERIOR ELEV. NUM.</u> - Sheet where found

DESCRIPTION OF WORK

• ADDITION OF 830 SF GUEST SUITE (INCLUDES (N) STAIRWELL)

● REMODEL 294 SF (LAUNDRY & KITCHEN) ON 1ST FLR

ADDITION OF 270 SF GRAND ENTRY

E2 SECOND FLOOR PLAN- ELECT LAYOUT

FIRE PROTECTION FP1 FIRE PROTECTION NOTES

T24.1 TITLE 24 ENERGY COMPLIANCE T24.2 TITLE 24 ENERGY COMPLIANCE

APN 015-271-04 The information, plans, designs, notes & arrangements shown on this drawing are confidential and may not be reproduced in whole or in part without the written permission of KLC Consulting Engineers, Inc. Drawings noted as Preliminary, Schematic and / or Concept contain information that is conceptual and subject to verification and / or change. The Engineer makes no claim for accuracy of conceptual information or information supplied by others.

**NORTH** 

SCALE:

Ö

PROJ. NO.


S5.1 FRAMING DETAILS S5.2 FRAMING DETAILS S5.3 ROOF FRAMING DETAILS C1 TOPOGRAPHIC PLAN

E1 FIRST FLOOR PLAN- ELECT. LAYOUT






AERIAL PHOTO FRONT VIEW

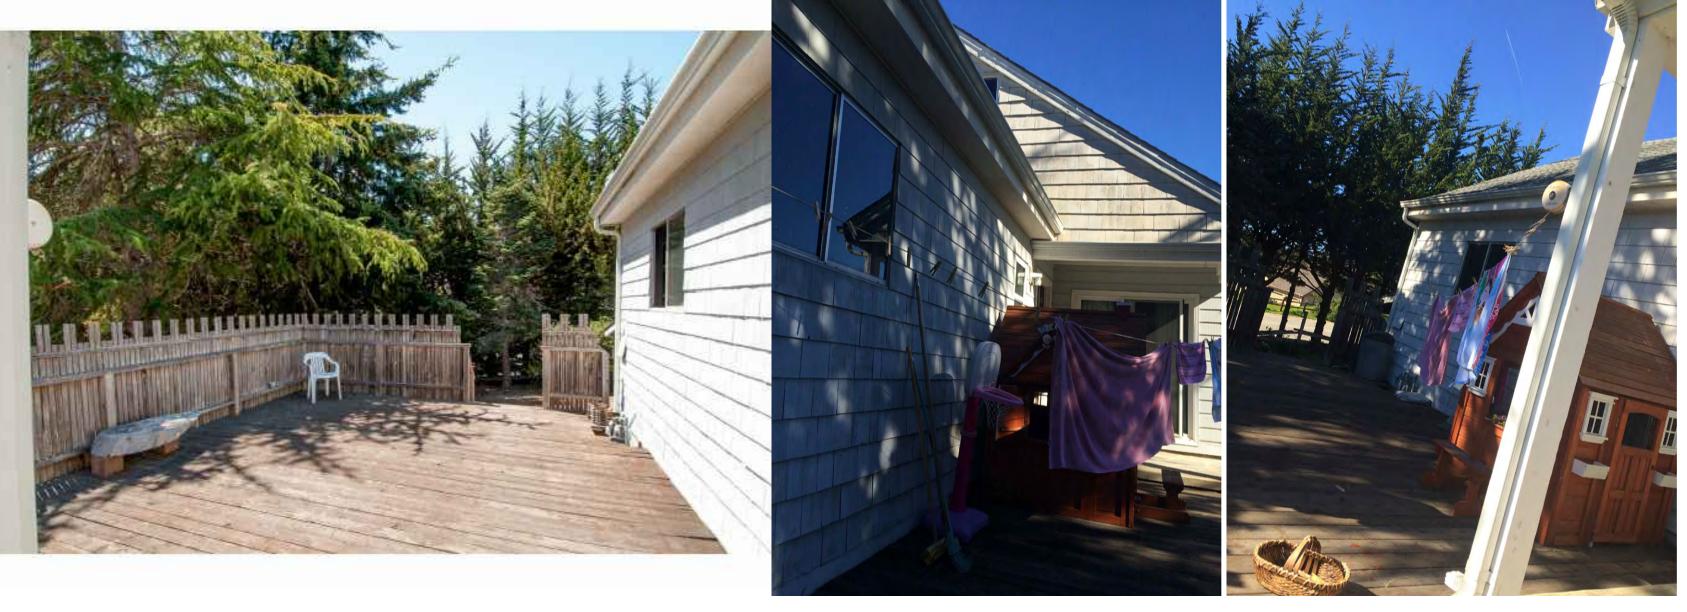

REAR DECK VIEW

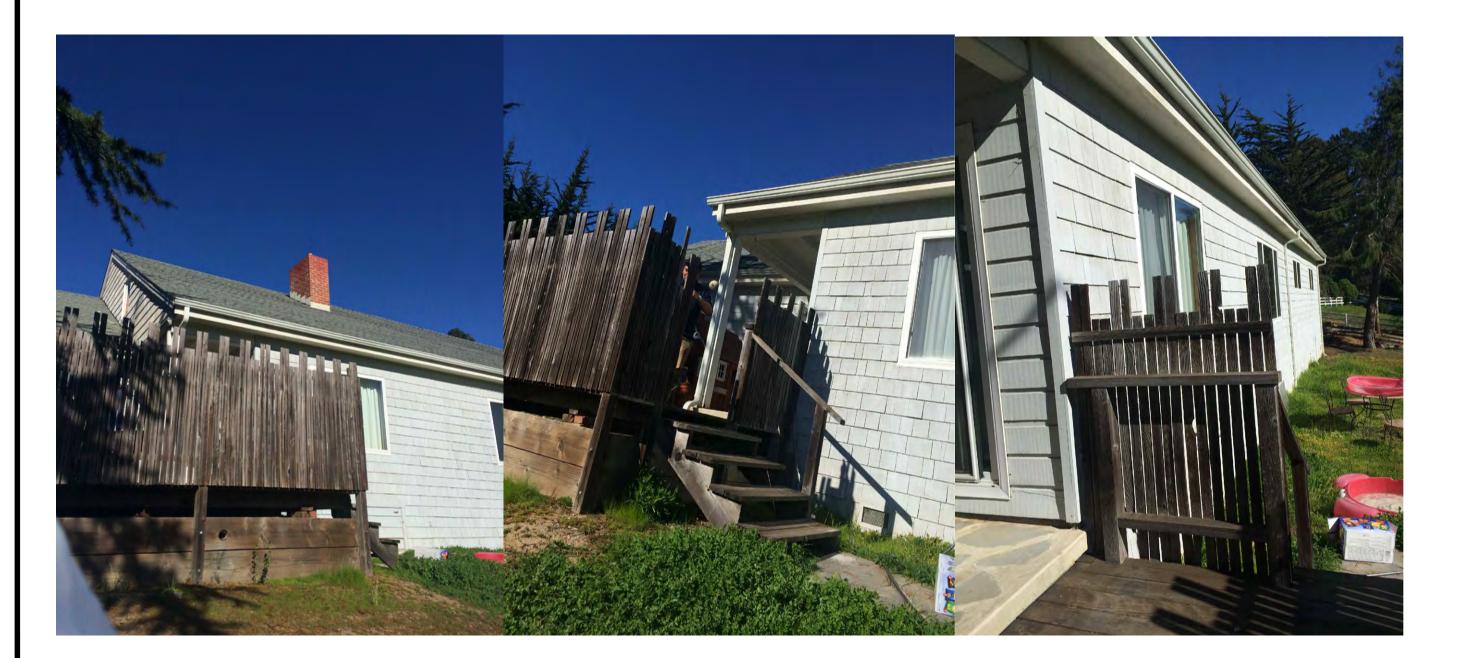

PARTIAL REAR VIEW





PARTIAL RIGHT SIDE VIEW




PARTIAL LEFT SIDE VIEW

	OF	FSSIO	
STAMP	STATE OF STATE OF	B. CALLEOR	C NE
CONSULTANT		CONSULTING ENGINEERS, INC 11100 SAN PABLO AVE, SUITE 207, EL CERRITO, CA 94530 FAX: 510-232-0303	http/www//klccea.com
			33923
	ON & REMODEL		CARMEL, CA 93923
PROJECT & OWNER (S):	RESIDENTIAL ADDITION & REMODEL	SAMIR MESSIAH	26425 VIA PETRA
	AWN:	MTC	7
CHE	CKED:	RBC	
SC	ALE:		
DA	TE:	4/30	0/16
SHEET TITLE	EXISTING SITE PHOTOS		
	. NO.	15-38	36
	ISIONS: FOR BLDG PEI	RMIT 4	4/30/16
SHE	ET NO:		


A.01

The information, plans, designs, notes & arrangements shown on this drawing are confidential and may not be reproduced in whole or in part without the written permission of **KLC Consulting Engineers**, **Inc.** Drawings noted as Preliminary, Schematic and / or Concept contain information that is conceptual and subject to verification and / or change. The Engineer makes no claim for accuracy of conceptual information or information supplied by others.

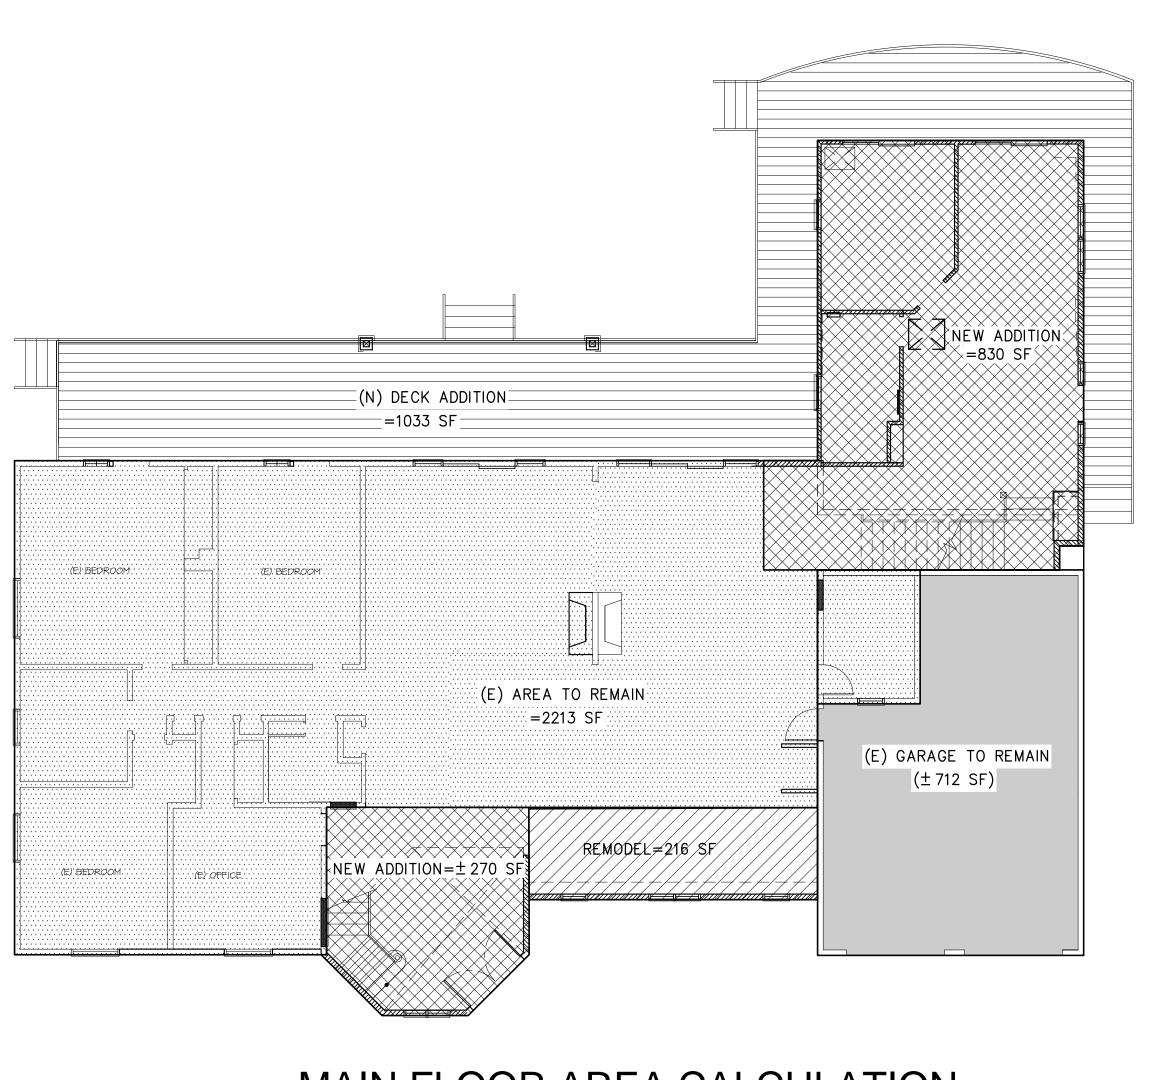

# ROOF REMODEL = 54D SF REMODEL = 54D SF REMAIN = 1197 SF ROOF REMAIN = 1197 SF ROOF ROOF ROOF ROOF ROOF ROOF ROOF REMAIN (NO WORK) ROOF ATTIC STORAGE TO REMAIN (NO WORK)


# LEGEND:

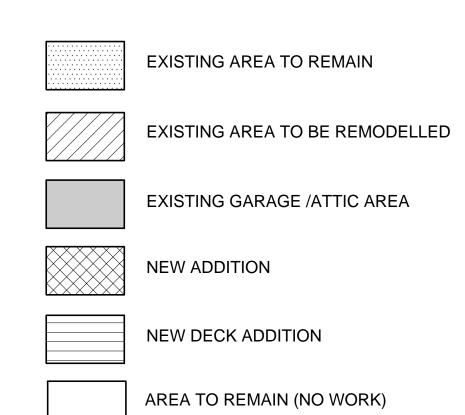

# MAIN FLOOR AREA CALCULATION

# ATTIC / LOFT AREA CALCULATION

# 

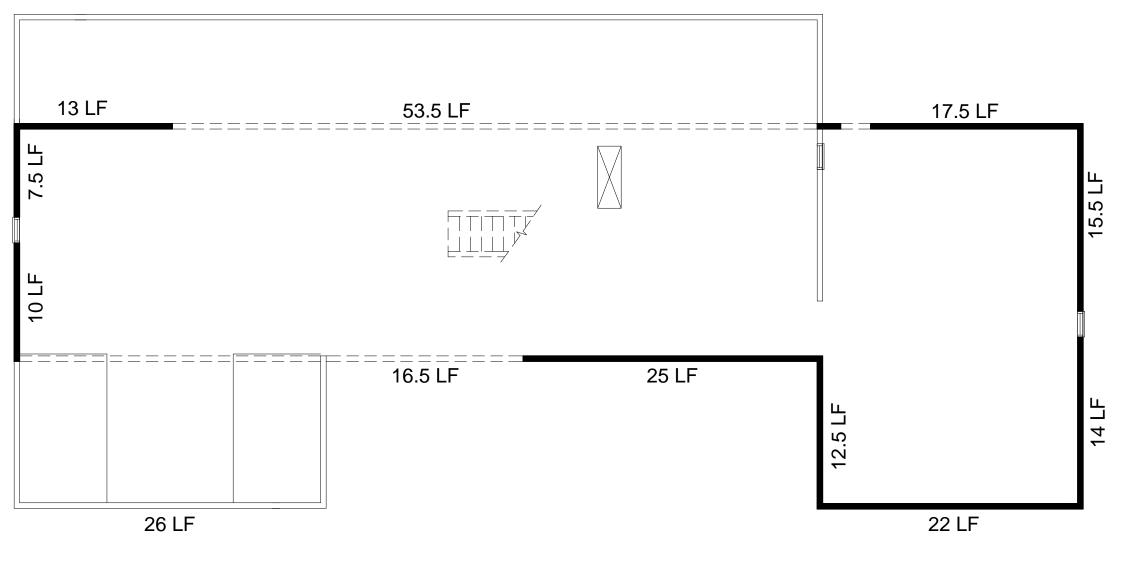

187.5 LF- EXTERIOR WALL LENGTH TO REMAIN
70 LF- EXTERIOR WALL LENGTH TO BE REMOVED

# SUMMARY OF AREA CALCULATIONS

	FIRST FLOOR	SQ. FT
	EXISTING GARAGE TO REMAIN ——————	712 SF
	EXISTING AREA TO REMAIN ————————————————————————————————————	2,213 S F
	EXISTING TO BE REMODELLED —————————————————————————————————	1,014 SF
	NEW ADDITION ————————————————————————————————————	830 SF
	NEW DECK ADDITION ————————————————————————————————————	1,033 SF
	LOFT / ATTIC STORAGE AREA	SQ. FT
ī	EXISTING ATTIC —	1,197 SF
) 5	EXISTING STORAGE TO REMAIN	712 SF
_	EXISTING TO BE REMODELLED —————————————————————————————————	930 SF 248 SF

SUMMARY OF EXTERIOR WALLS:

TOTAL LENGTH OF WALLS = 377.5 LF

TOTAL WALLS TO BE REMOVED (1ST + 2ND) = 94.5 LF

TOTAL WALLS TO REMAIN (1ST + 2ND) = 283.5LF

% WALLS TO BE REMOVED (1ST + 2ND) = 25%

% WALLS TO REMAIN (1ST + 2ND) = 75 %


& REMODEL ADDITION O RESIDENTIAL SAMIR 26425 VIA MTC DRAWN: CHECKED: SCALE: DATE: 4/30/16 SHEET TITLE

AREA CALCULATION/

EXT WALL LENGTH CALCS PROJ. NO. 15-386 **REVISIONS:** ISSUED FOR BLDG PERMIT

SHEET NO:

A1.0

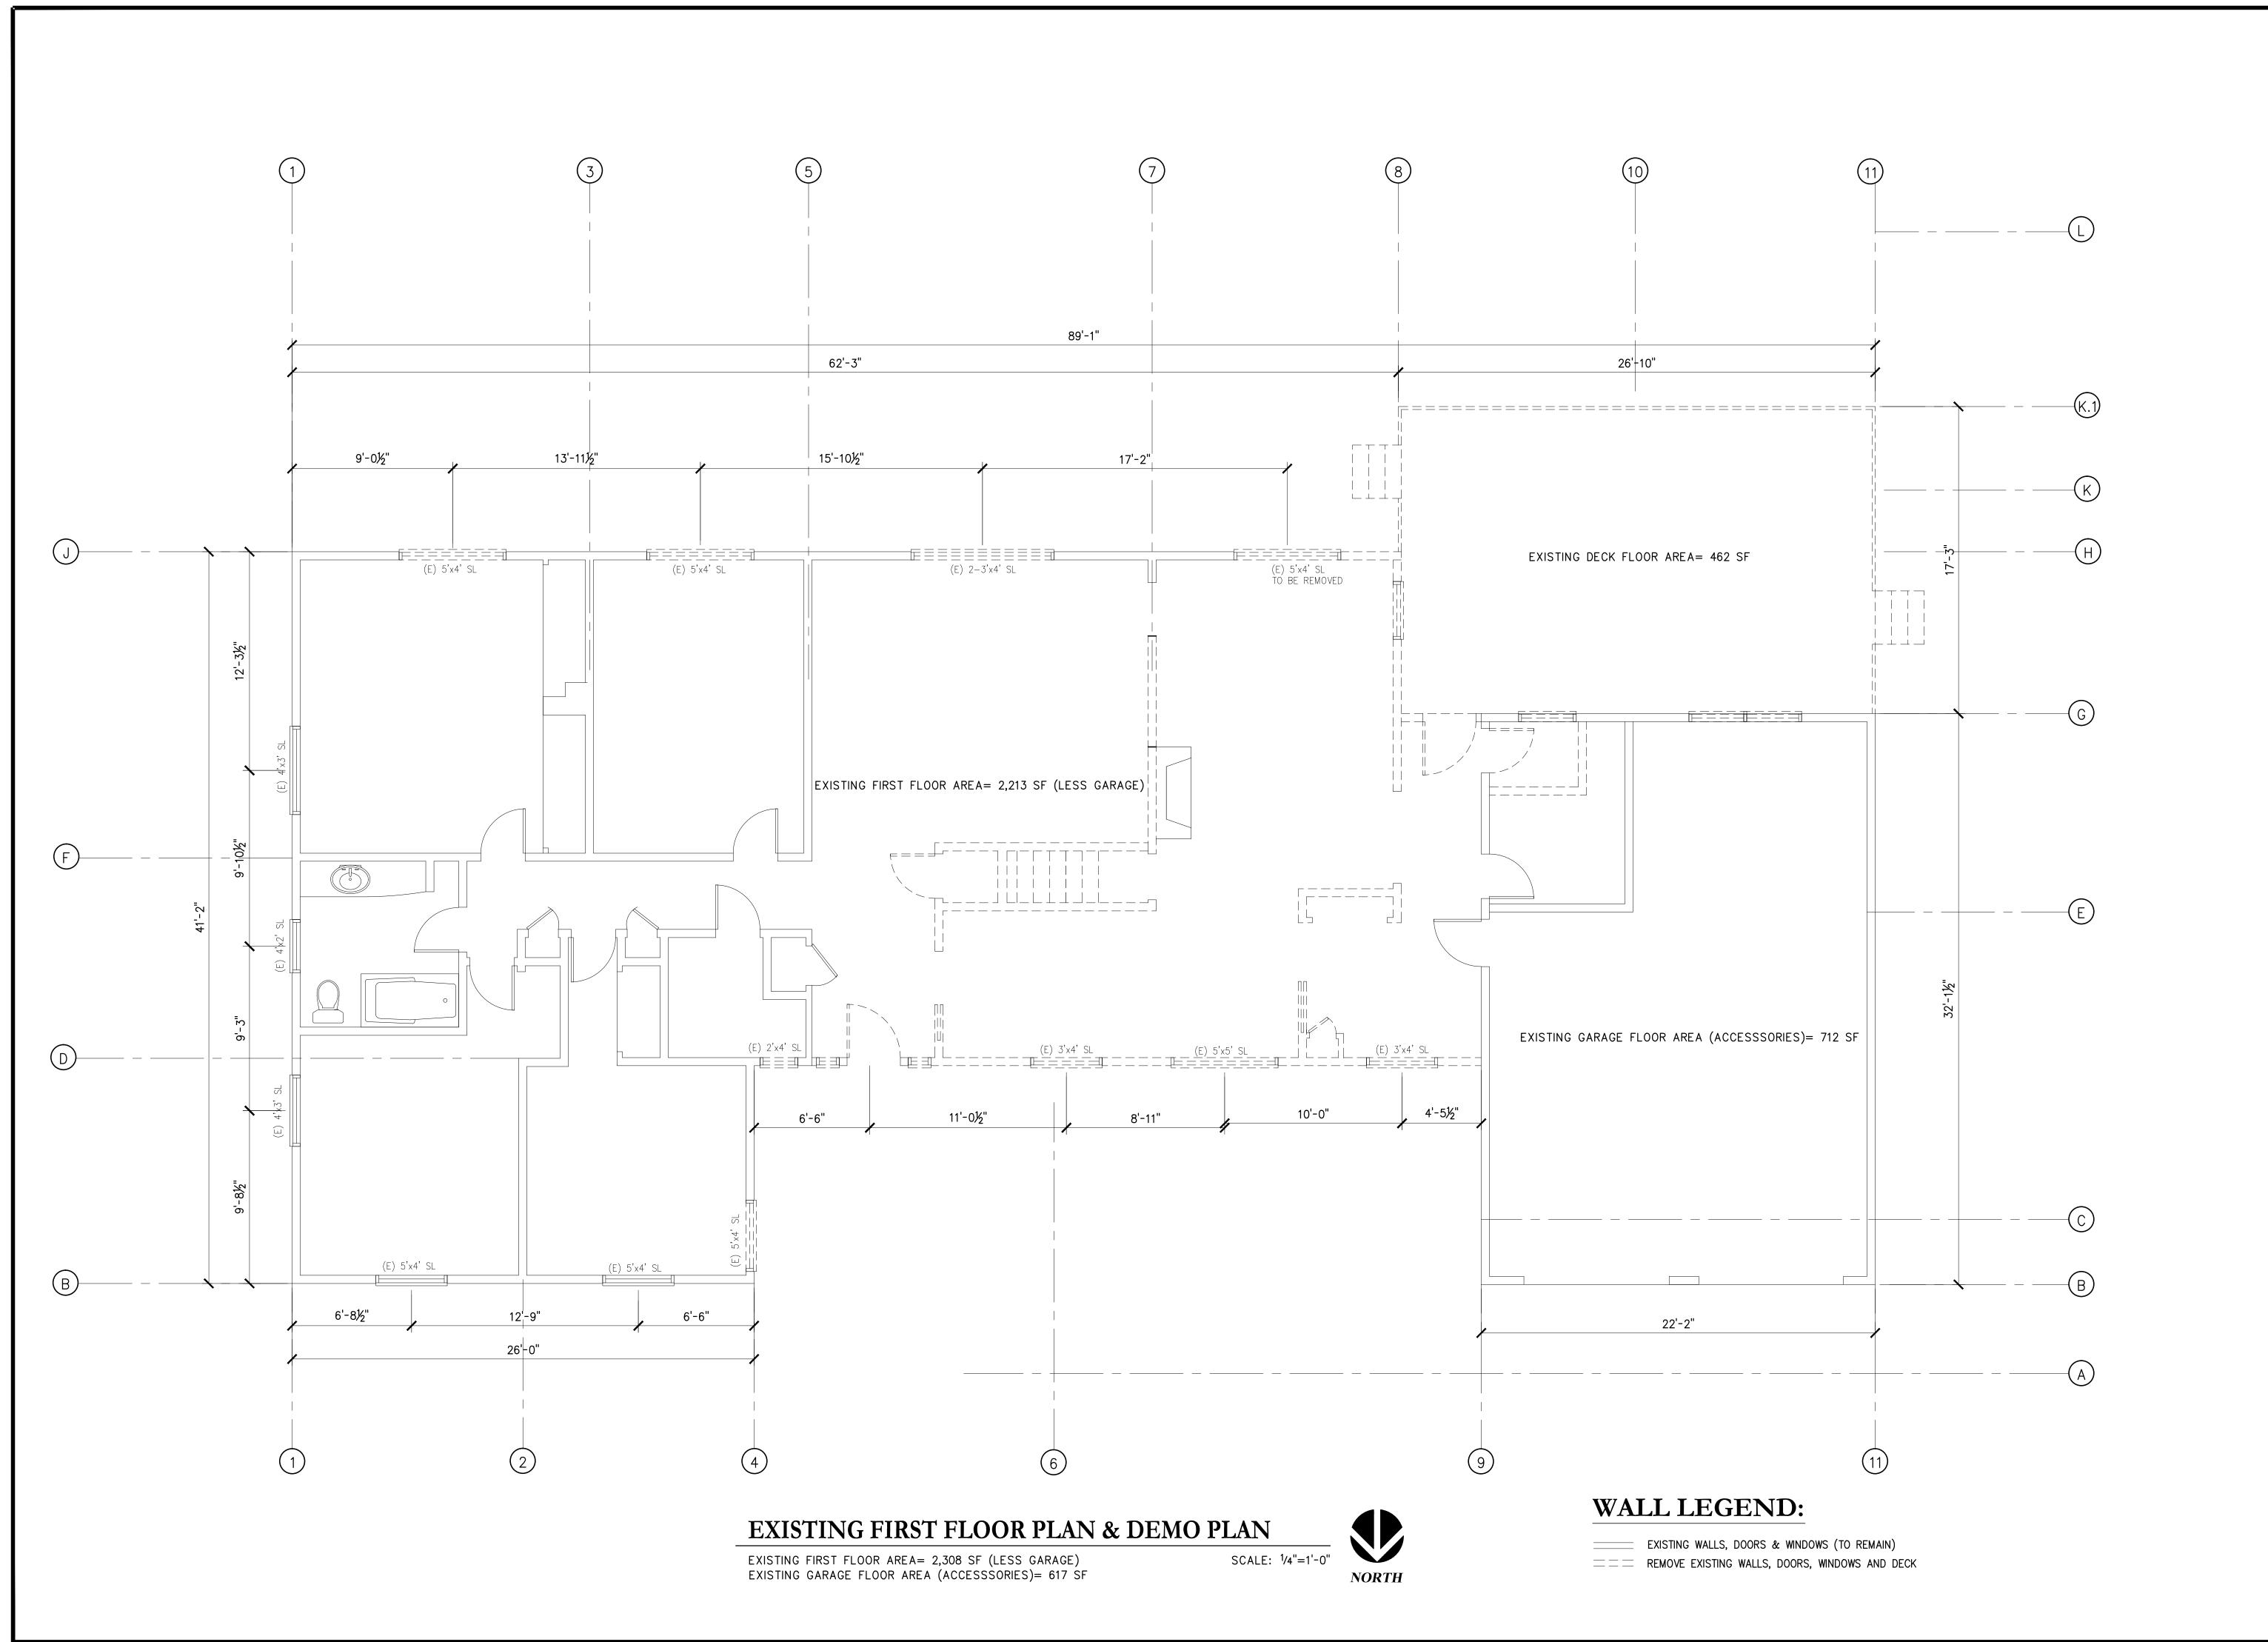

8 RESIDENTIAL ADDITION MESSIAH

SA DRAWN: RBC CHECKED:

SCALE: DATE: 4/30/16


PROJ. NO. 15-386


REVISIONS:

ISSUED FOR BLDG PERMIT 4/30/16

SHEET NO:


A1.1

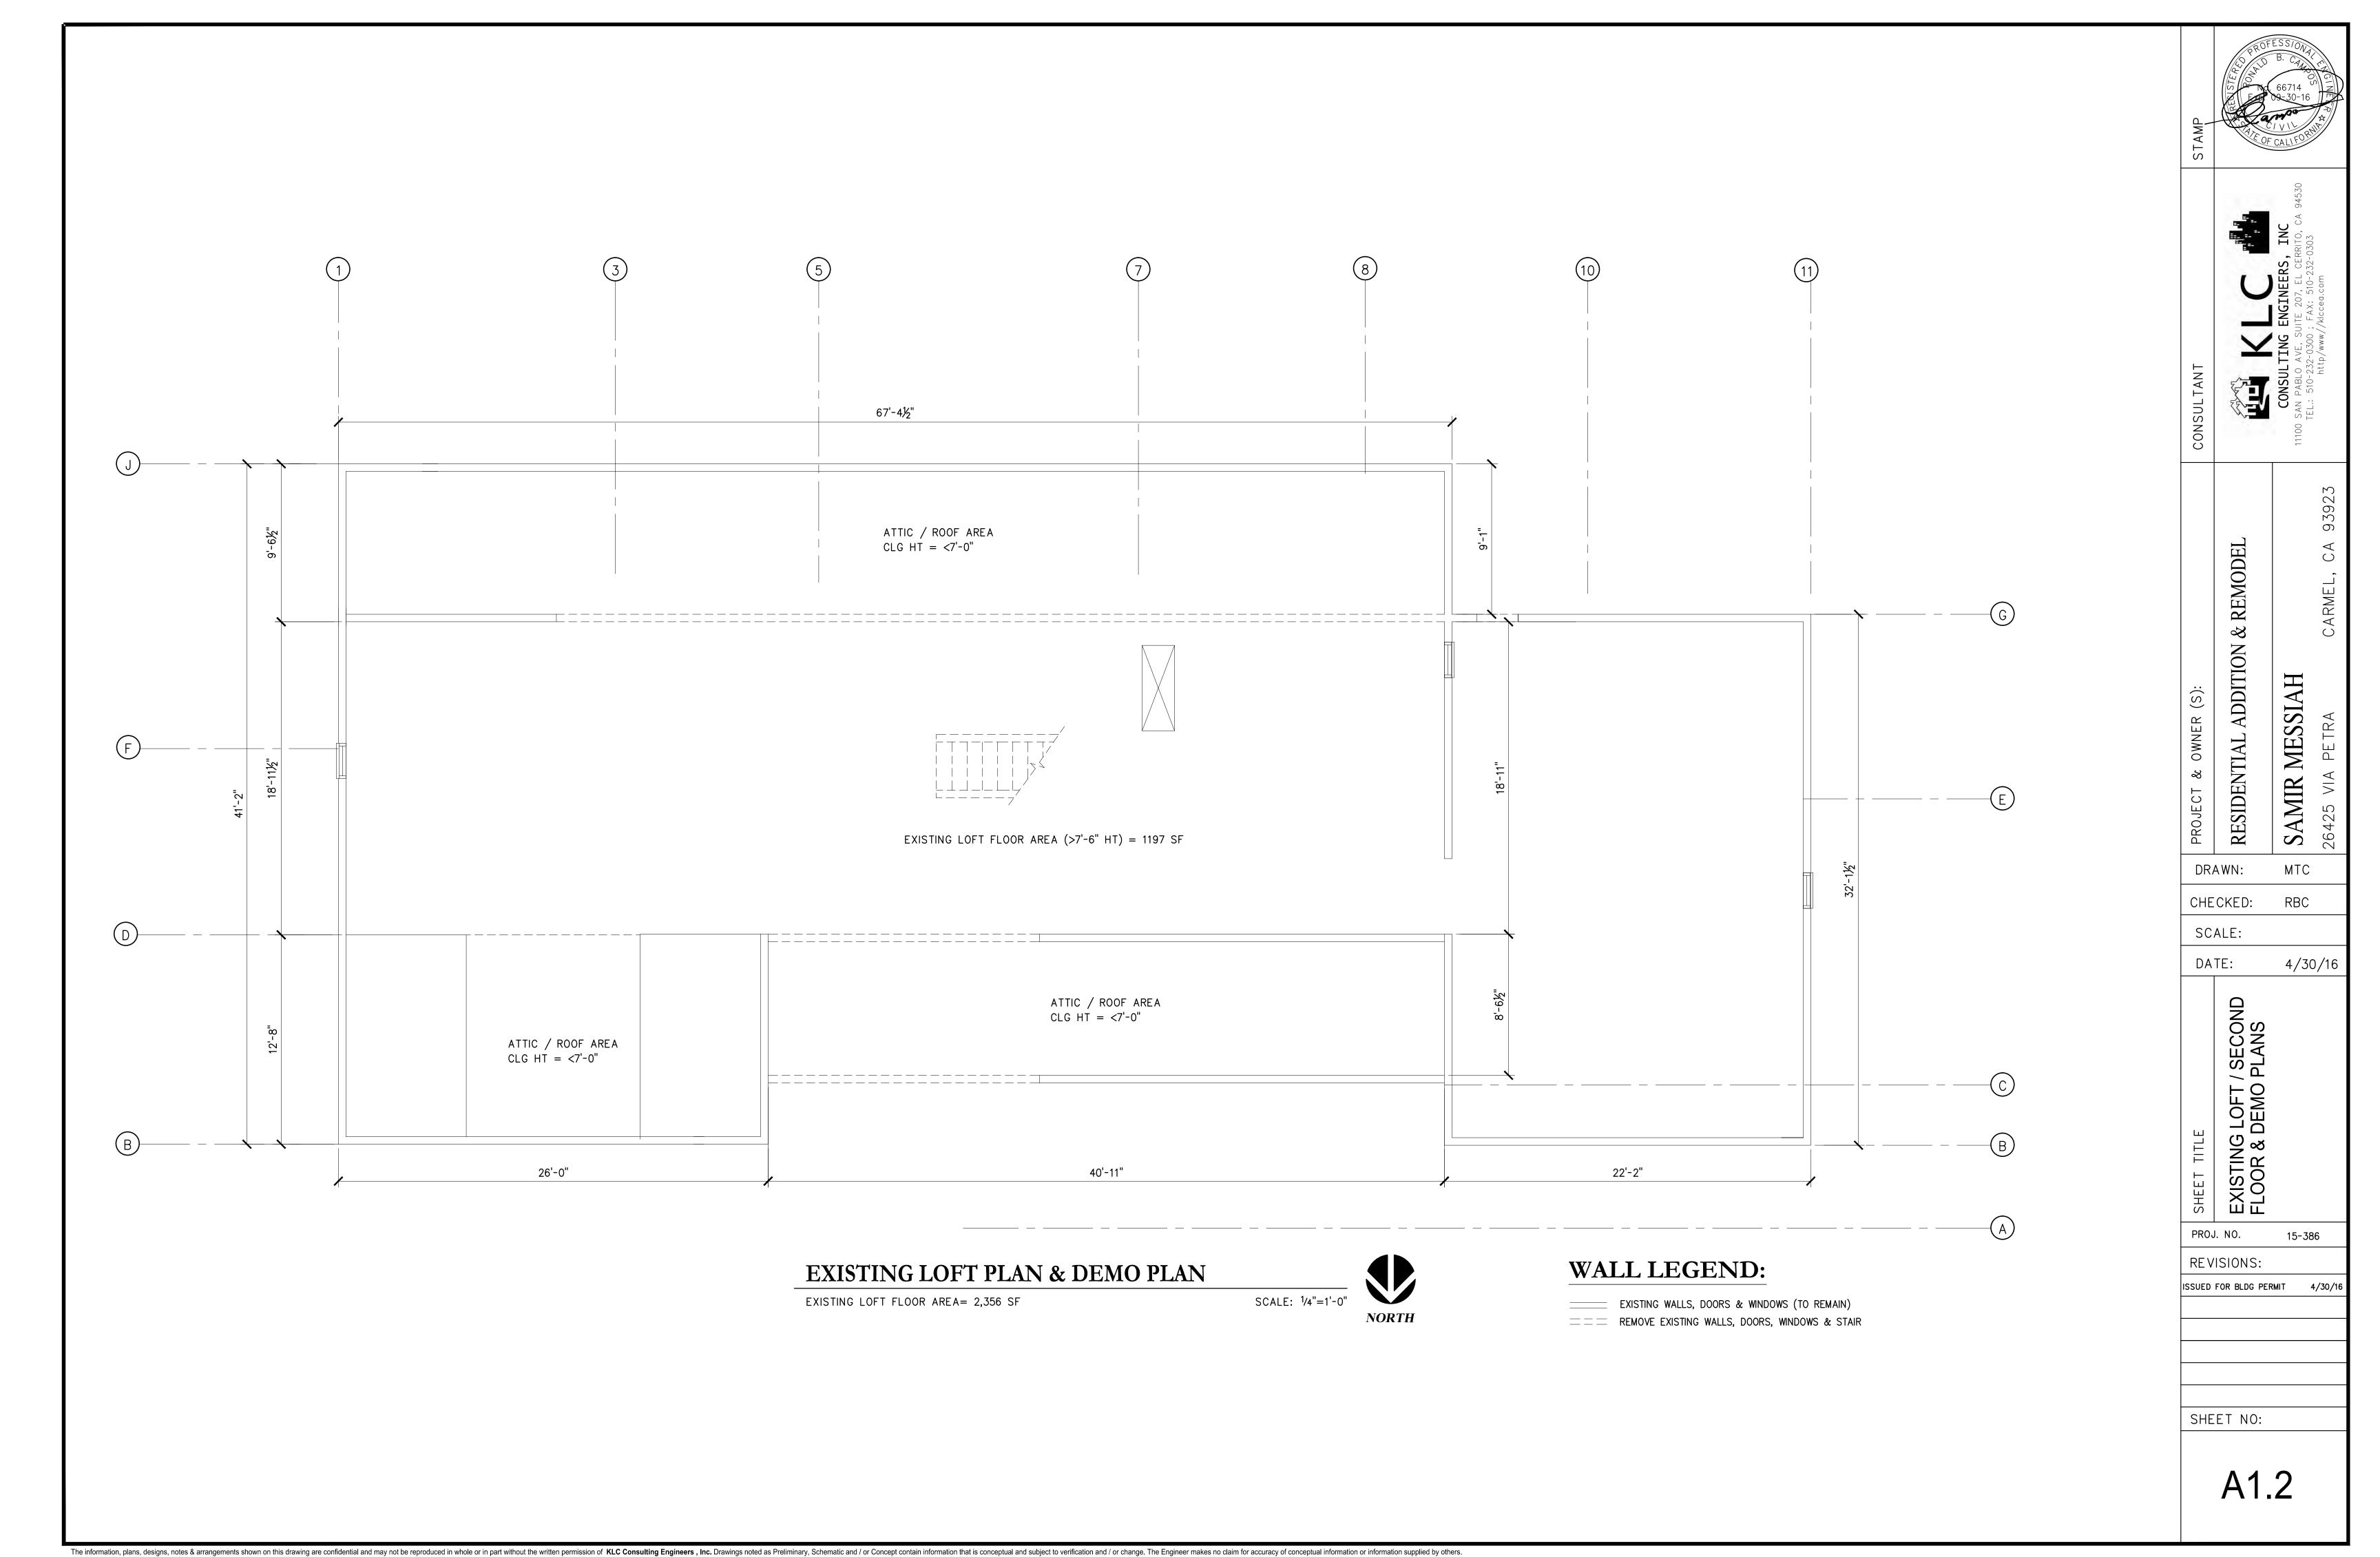


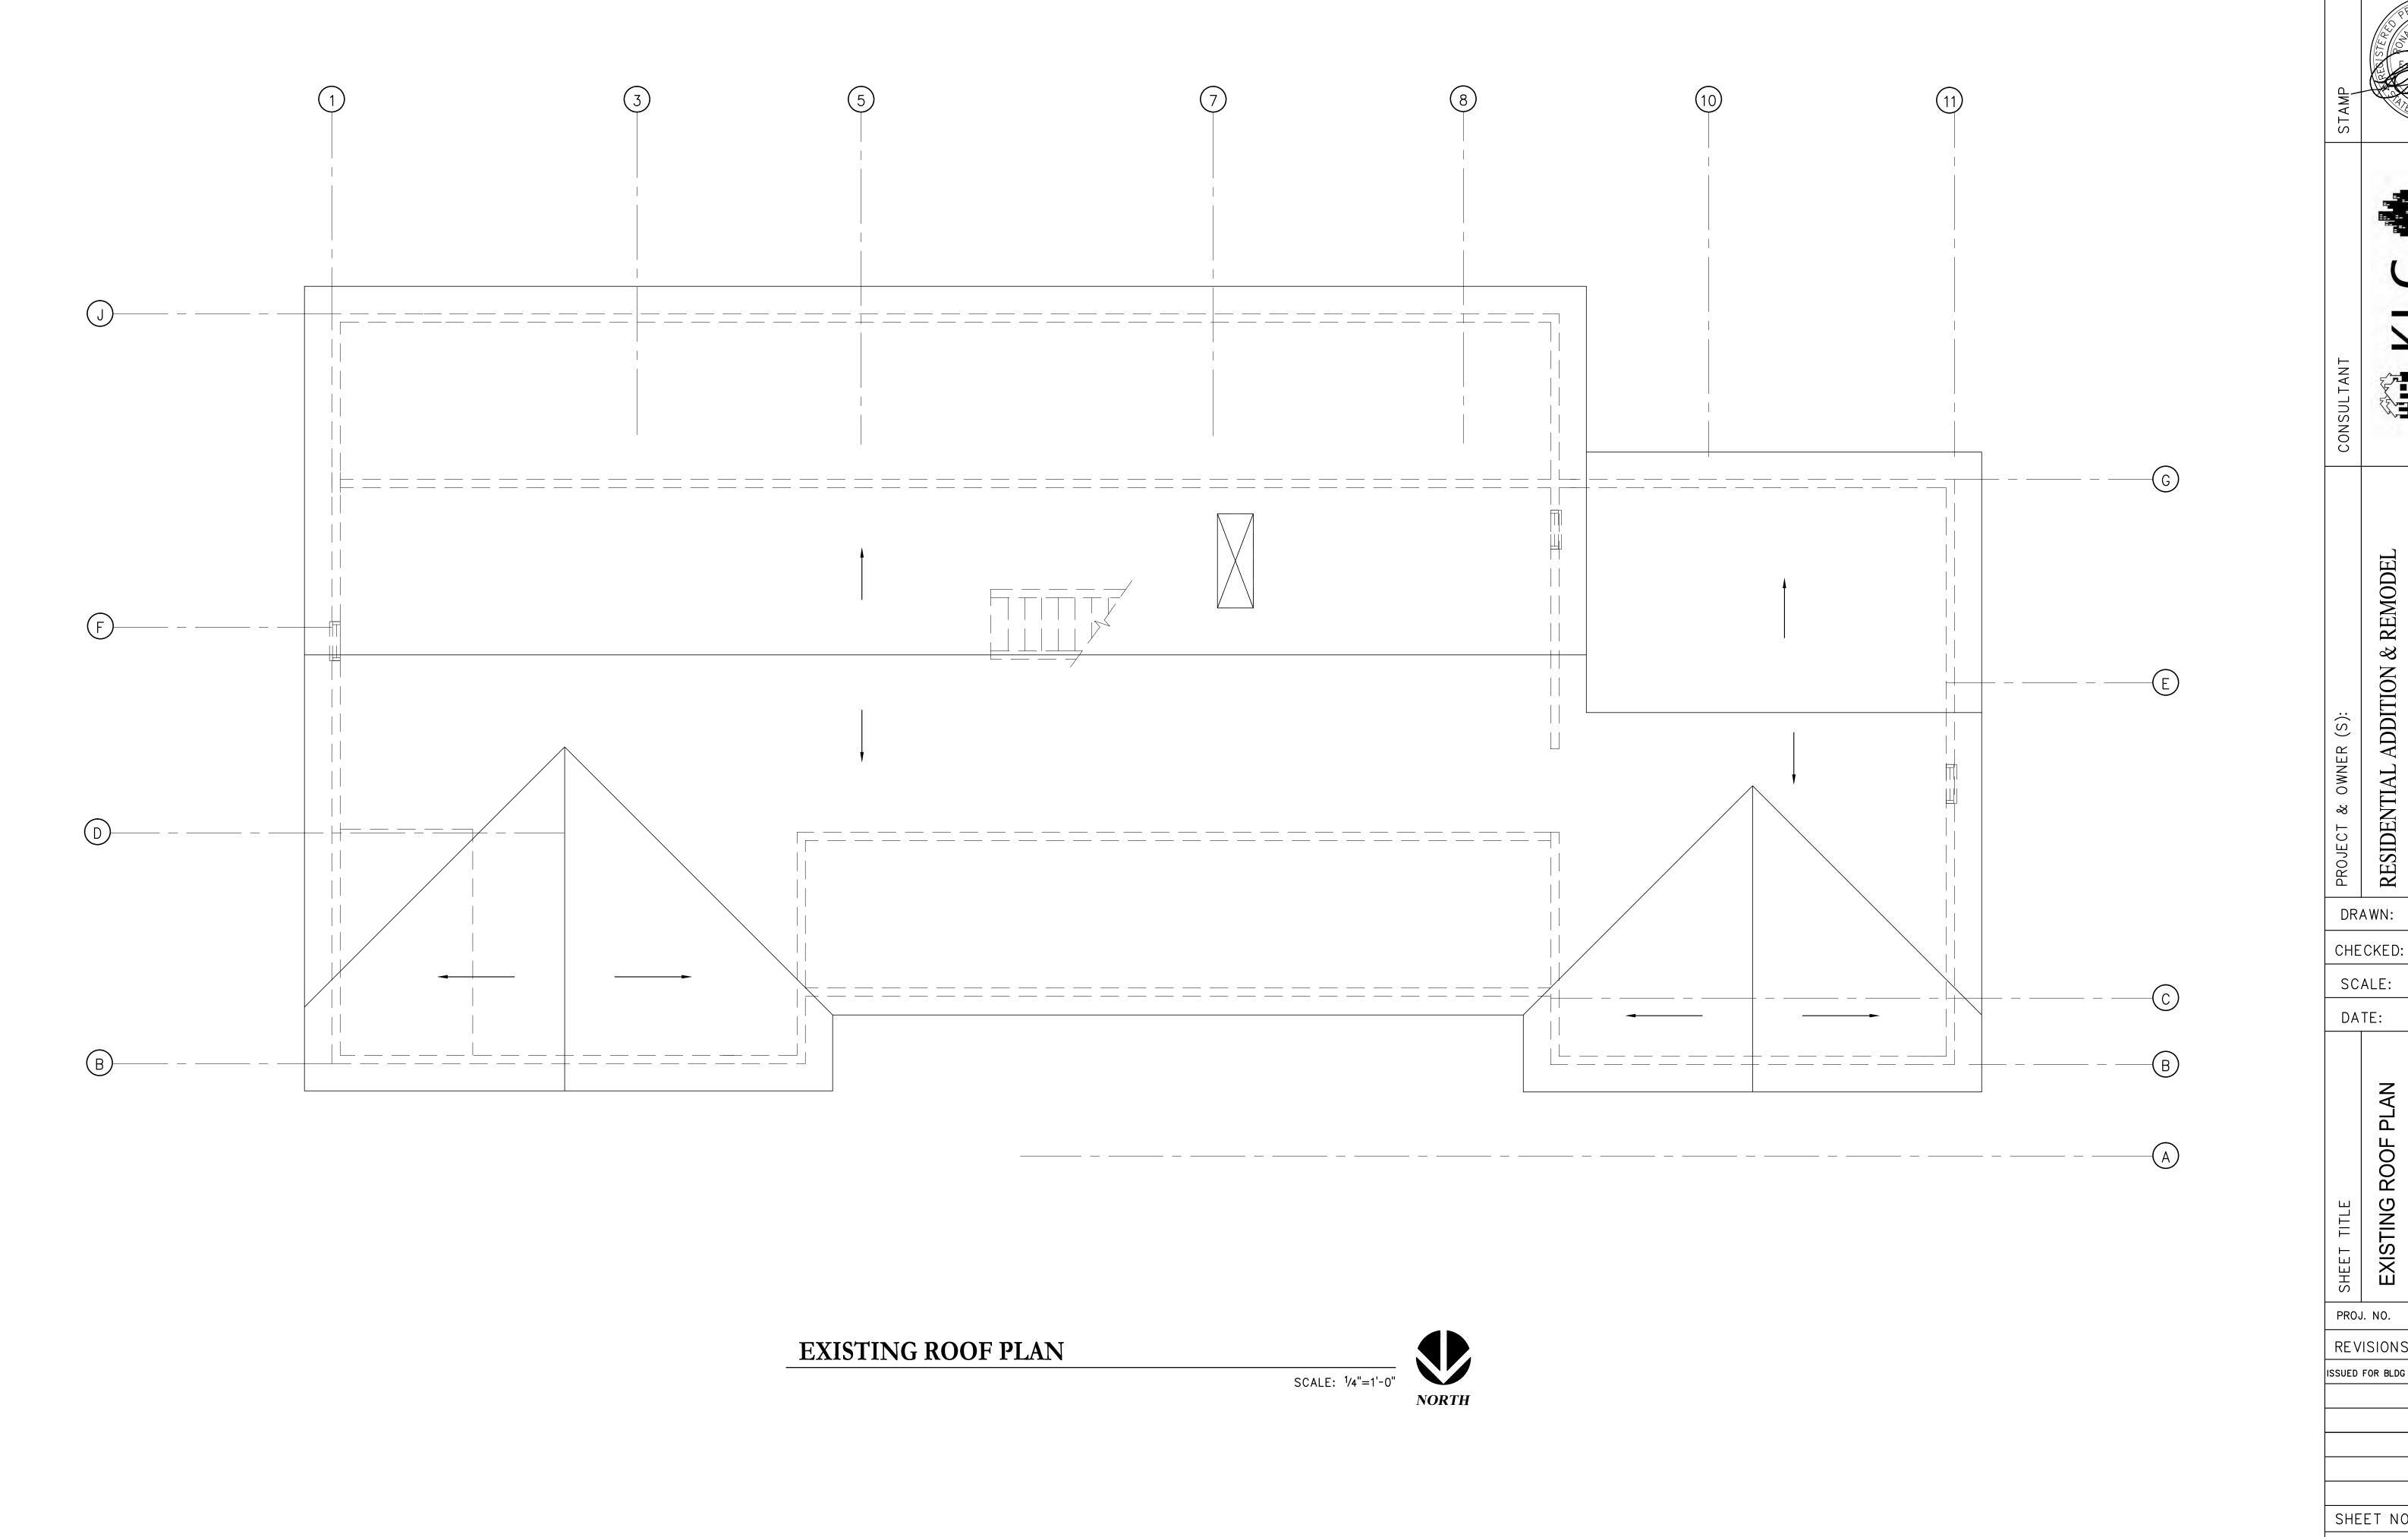


The information, plans, designs, notes & arrangements shown on this drawing are confidential and may not be reproduced in whole or in part without the written permission of **KLC Consulting Engineers**, **Inc.** Drawings noted as Preliminary, Schematic and / or Concept contain information that is conceptual and subject to verification and / or change. The Engineer makes no claim for accuracy of conceptual information or information supplied by others.

RESIDENTIAL ADDITION **SA**I 2642 CHECKED: 4/30/16 REVISIONS: ISSUED FOR BLDG PERMIT 4/30/16 SHEET NO:

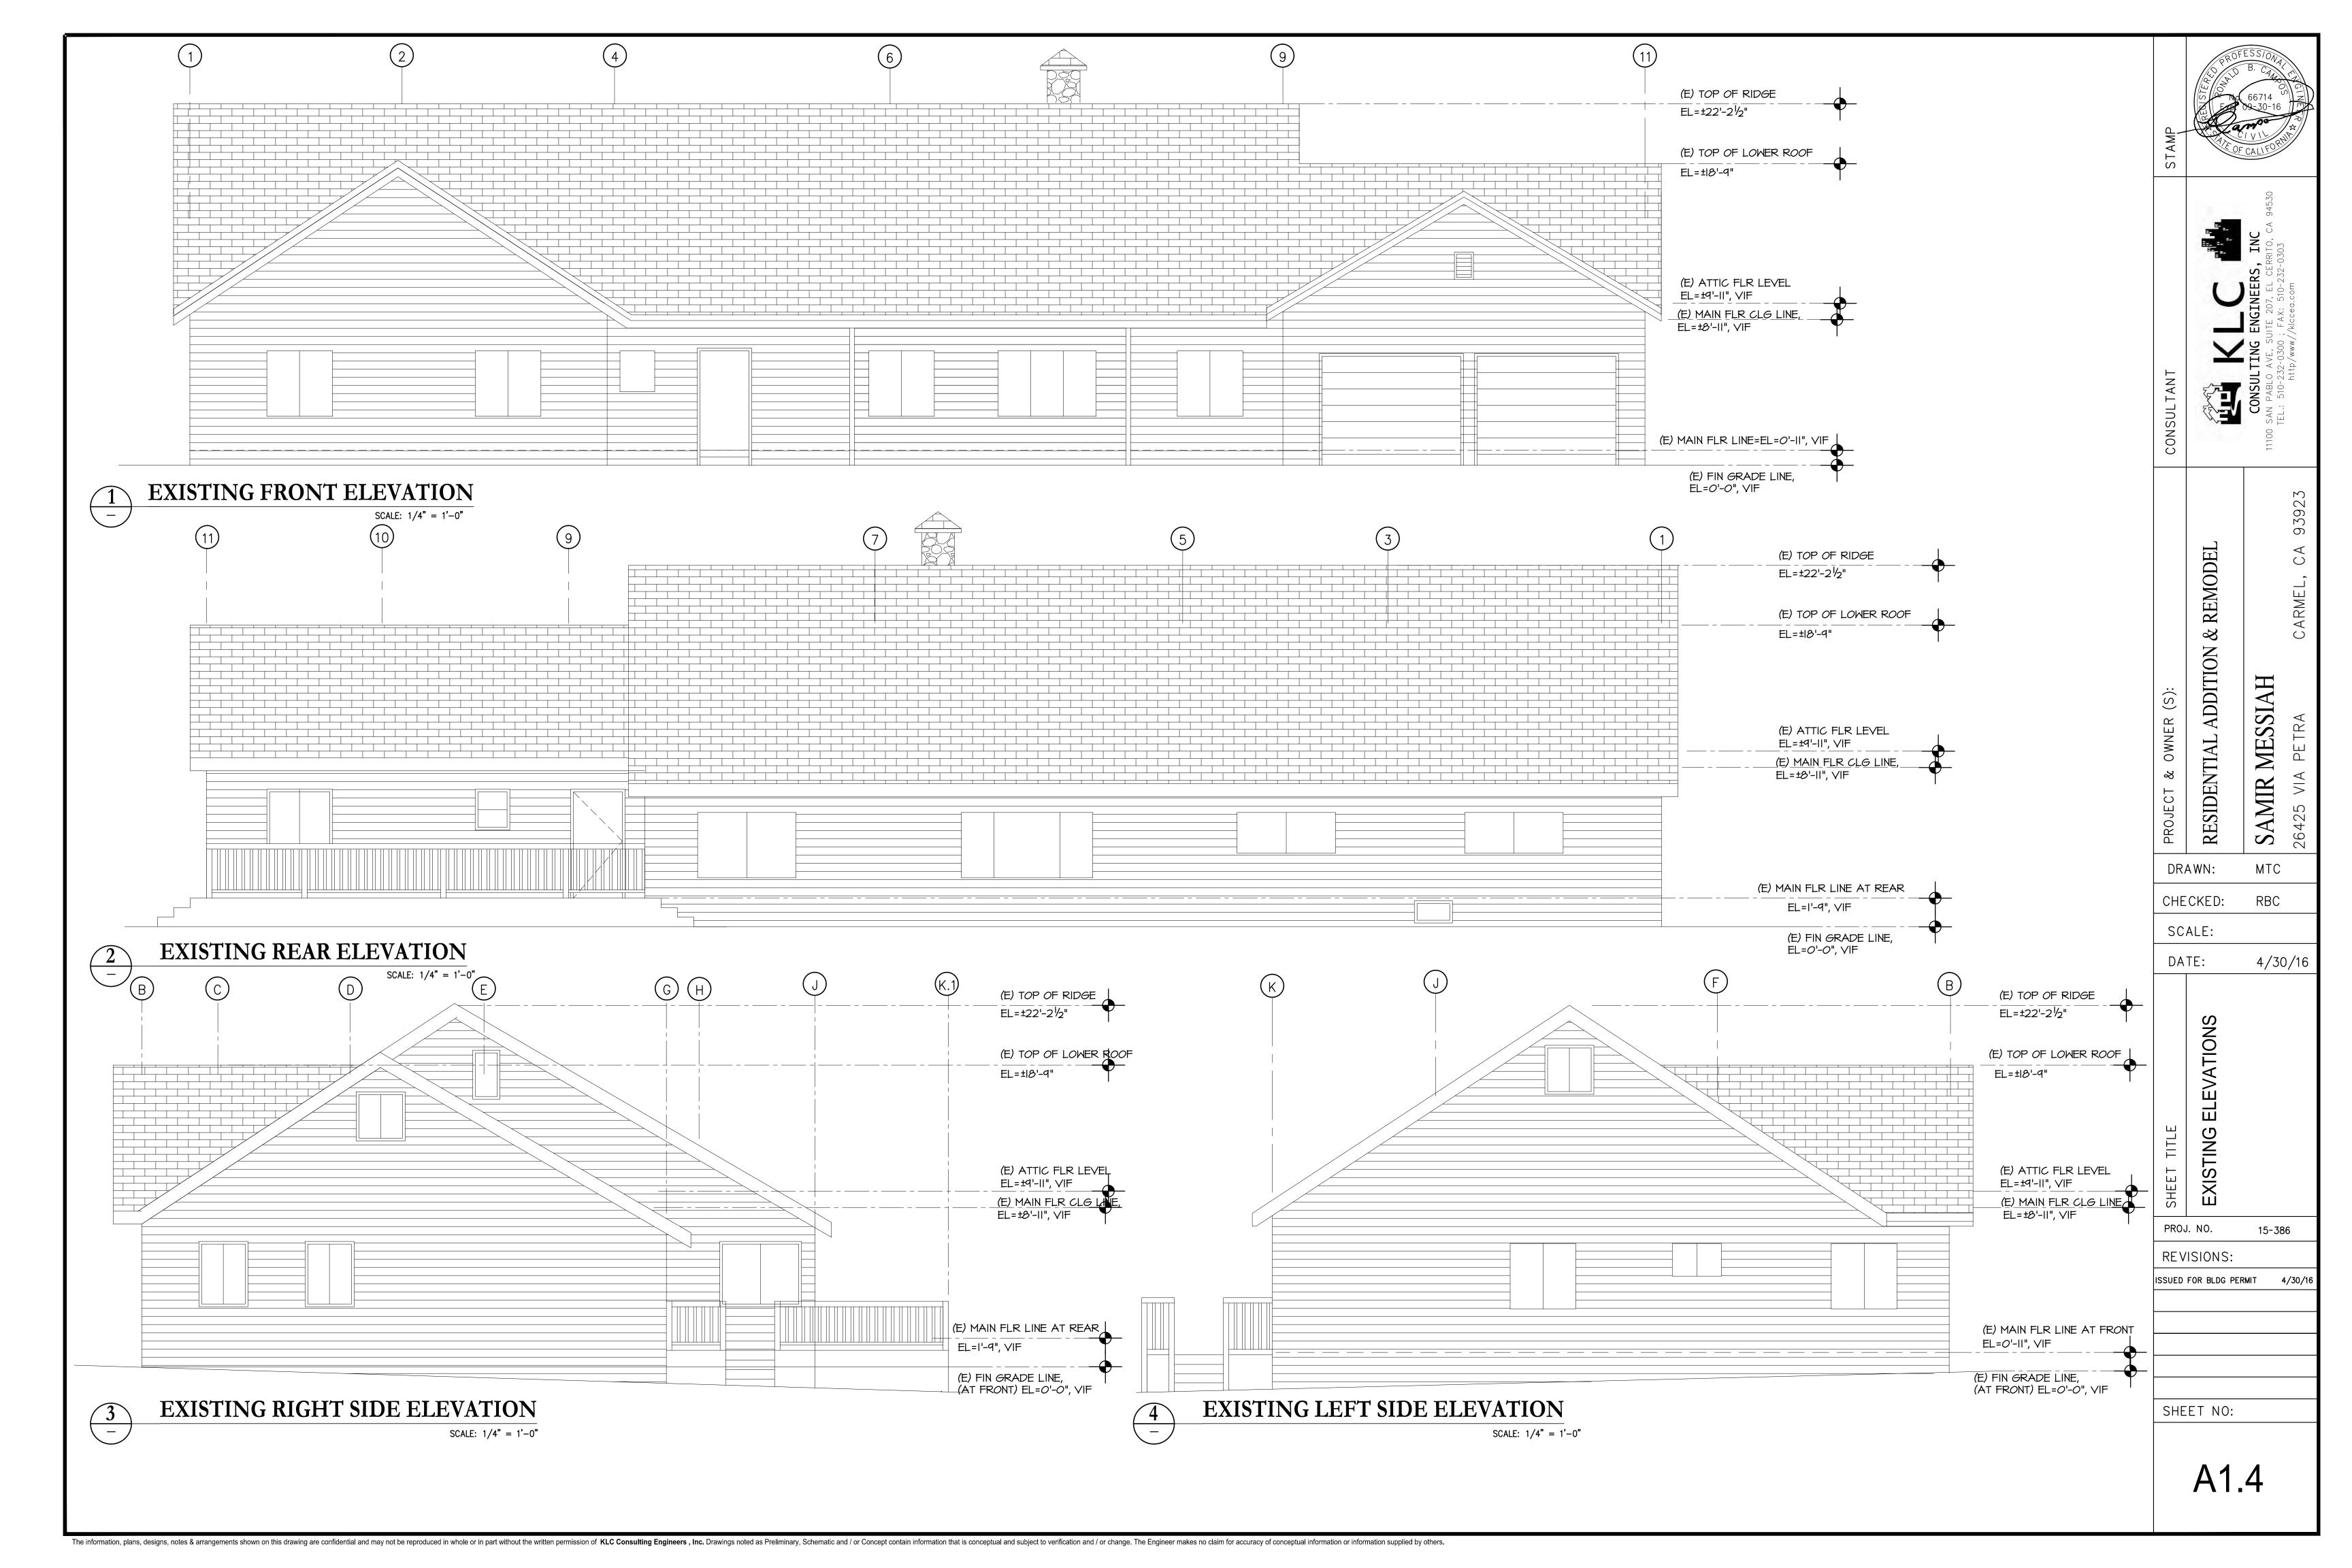

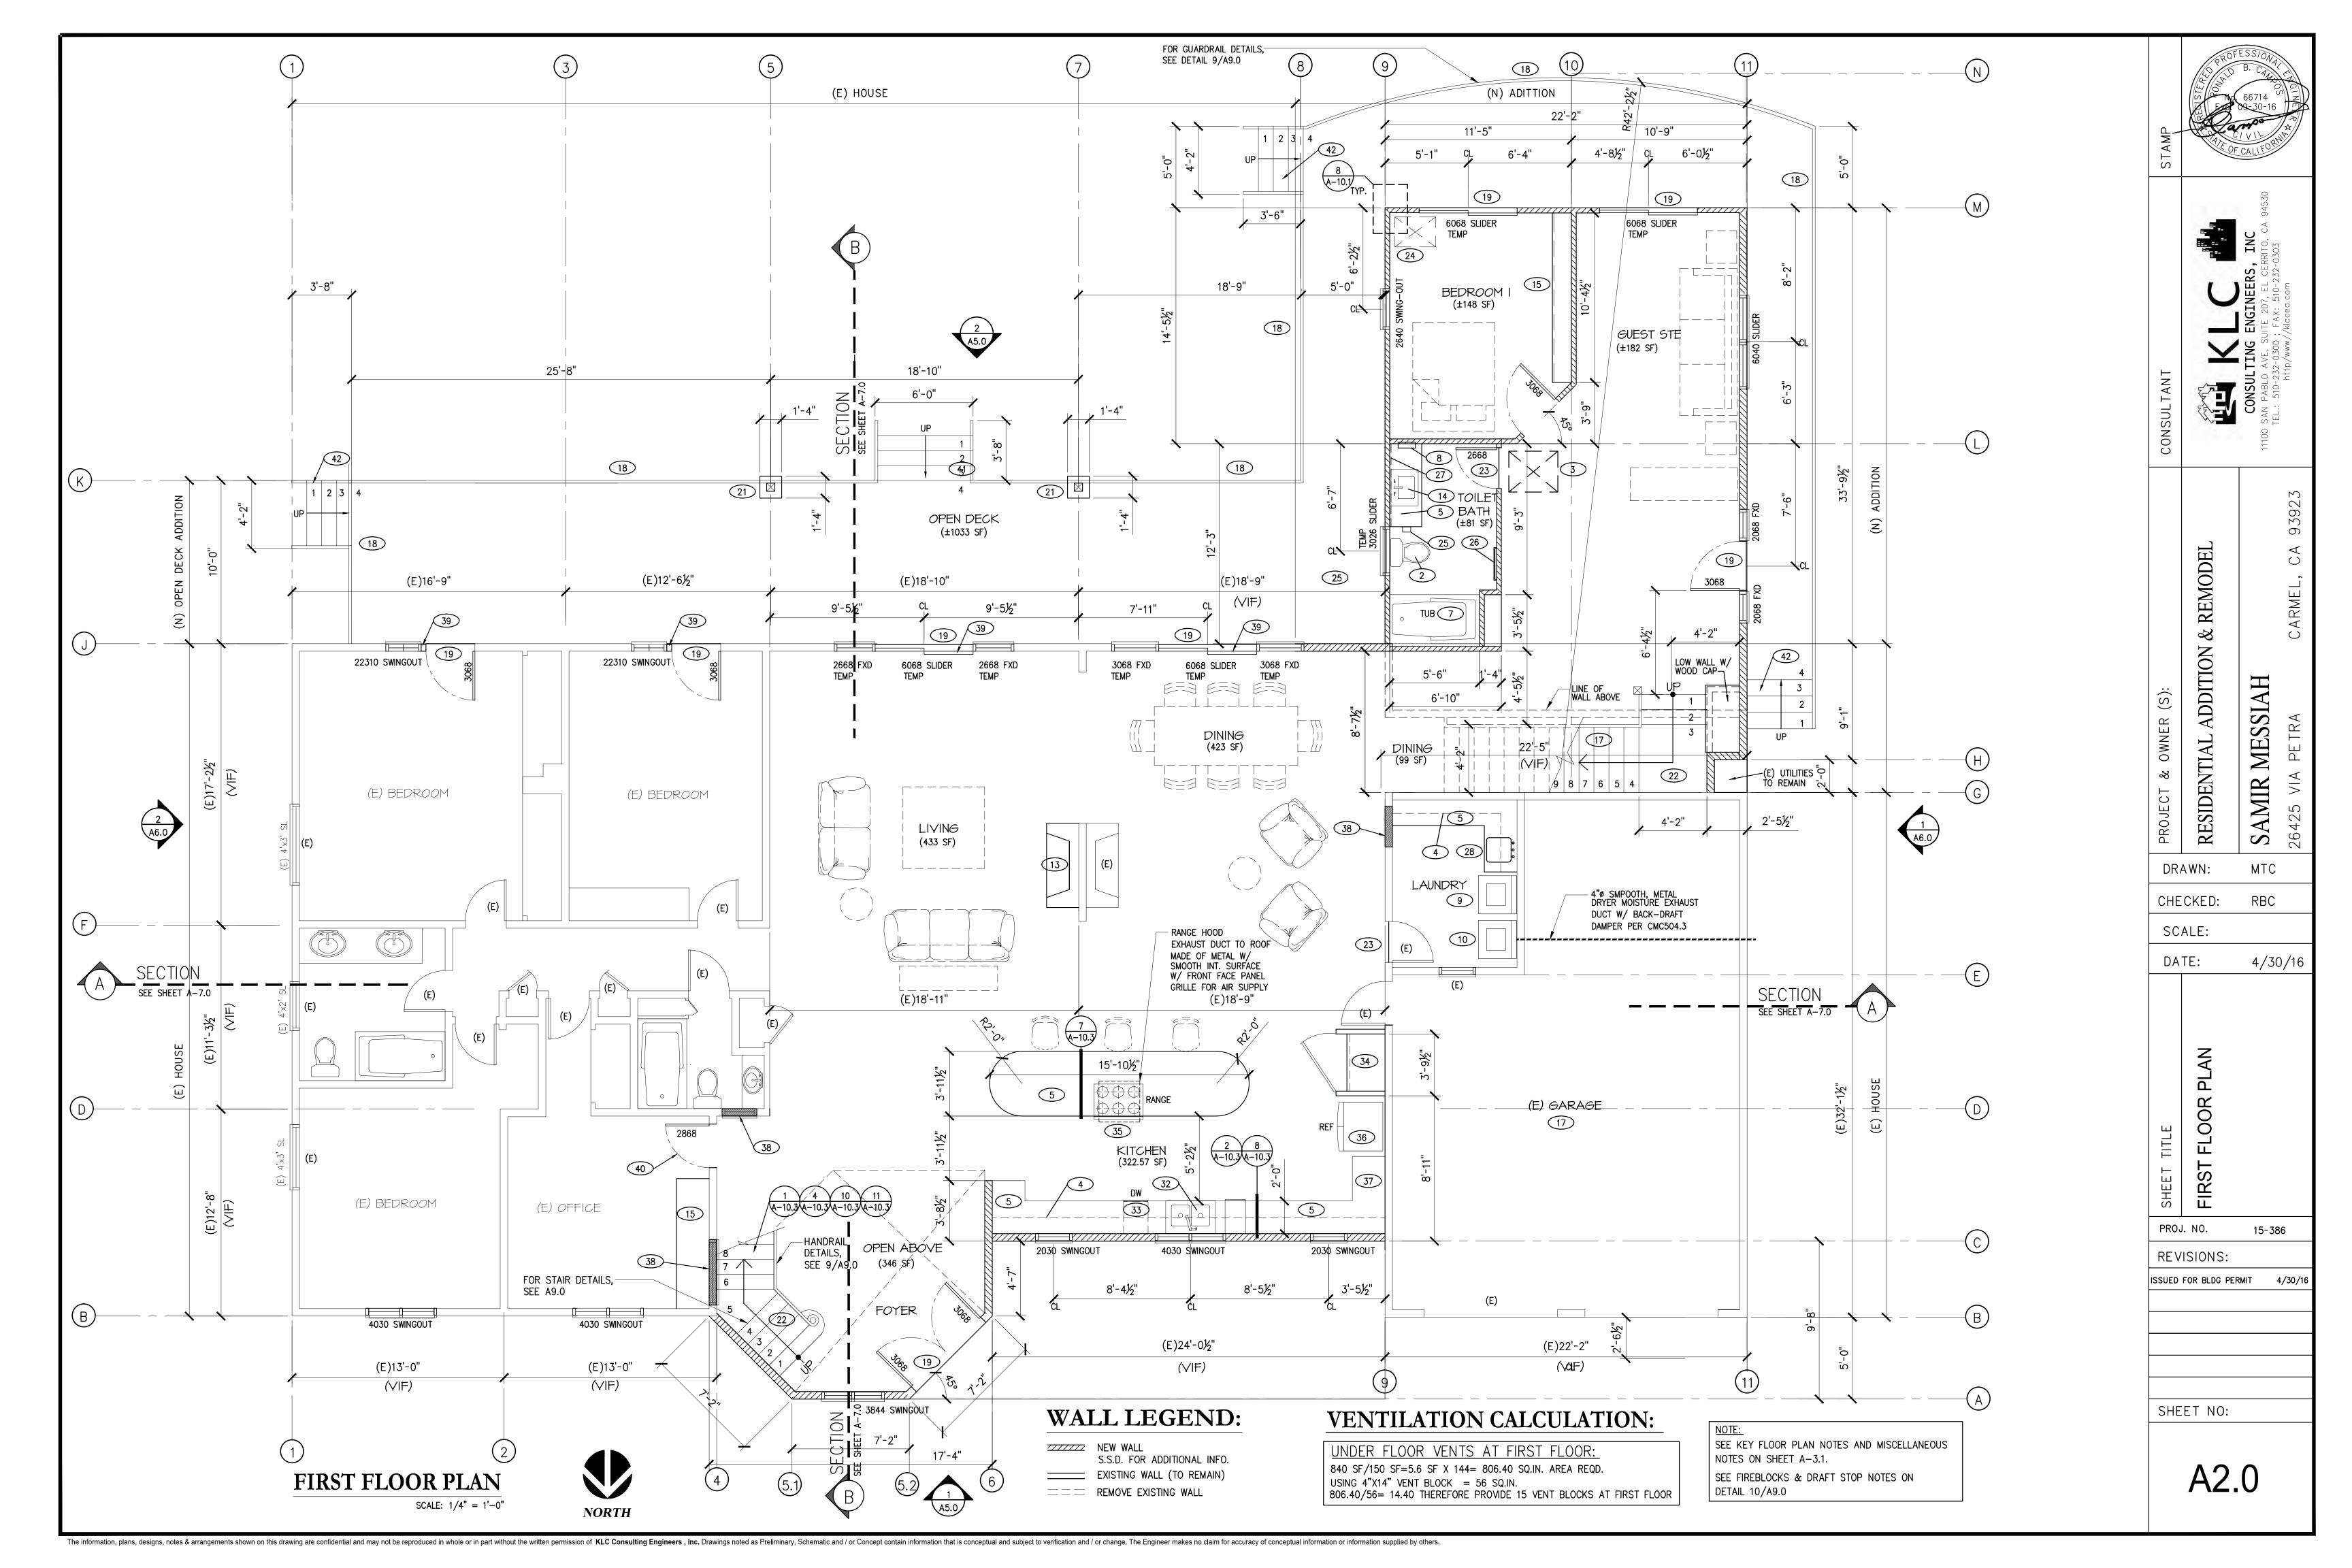

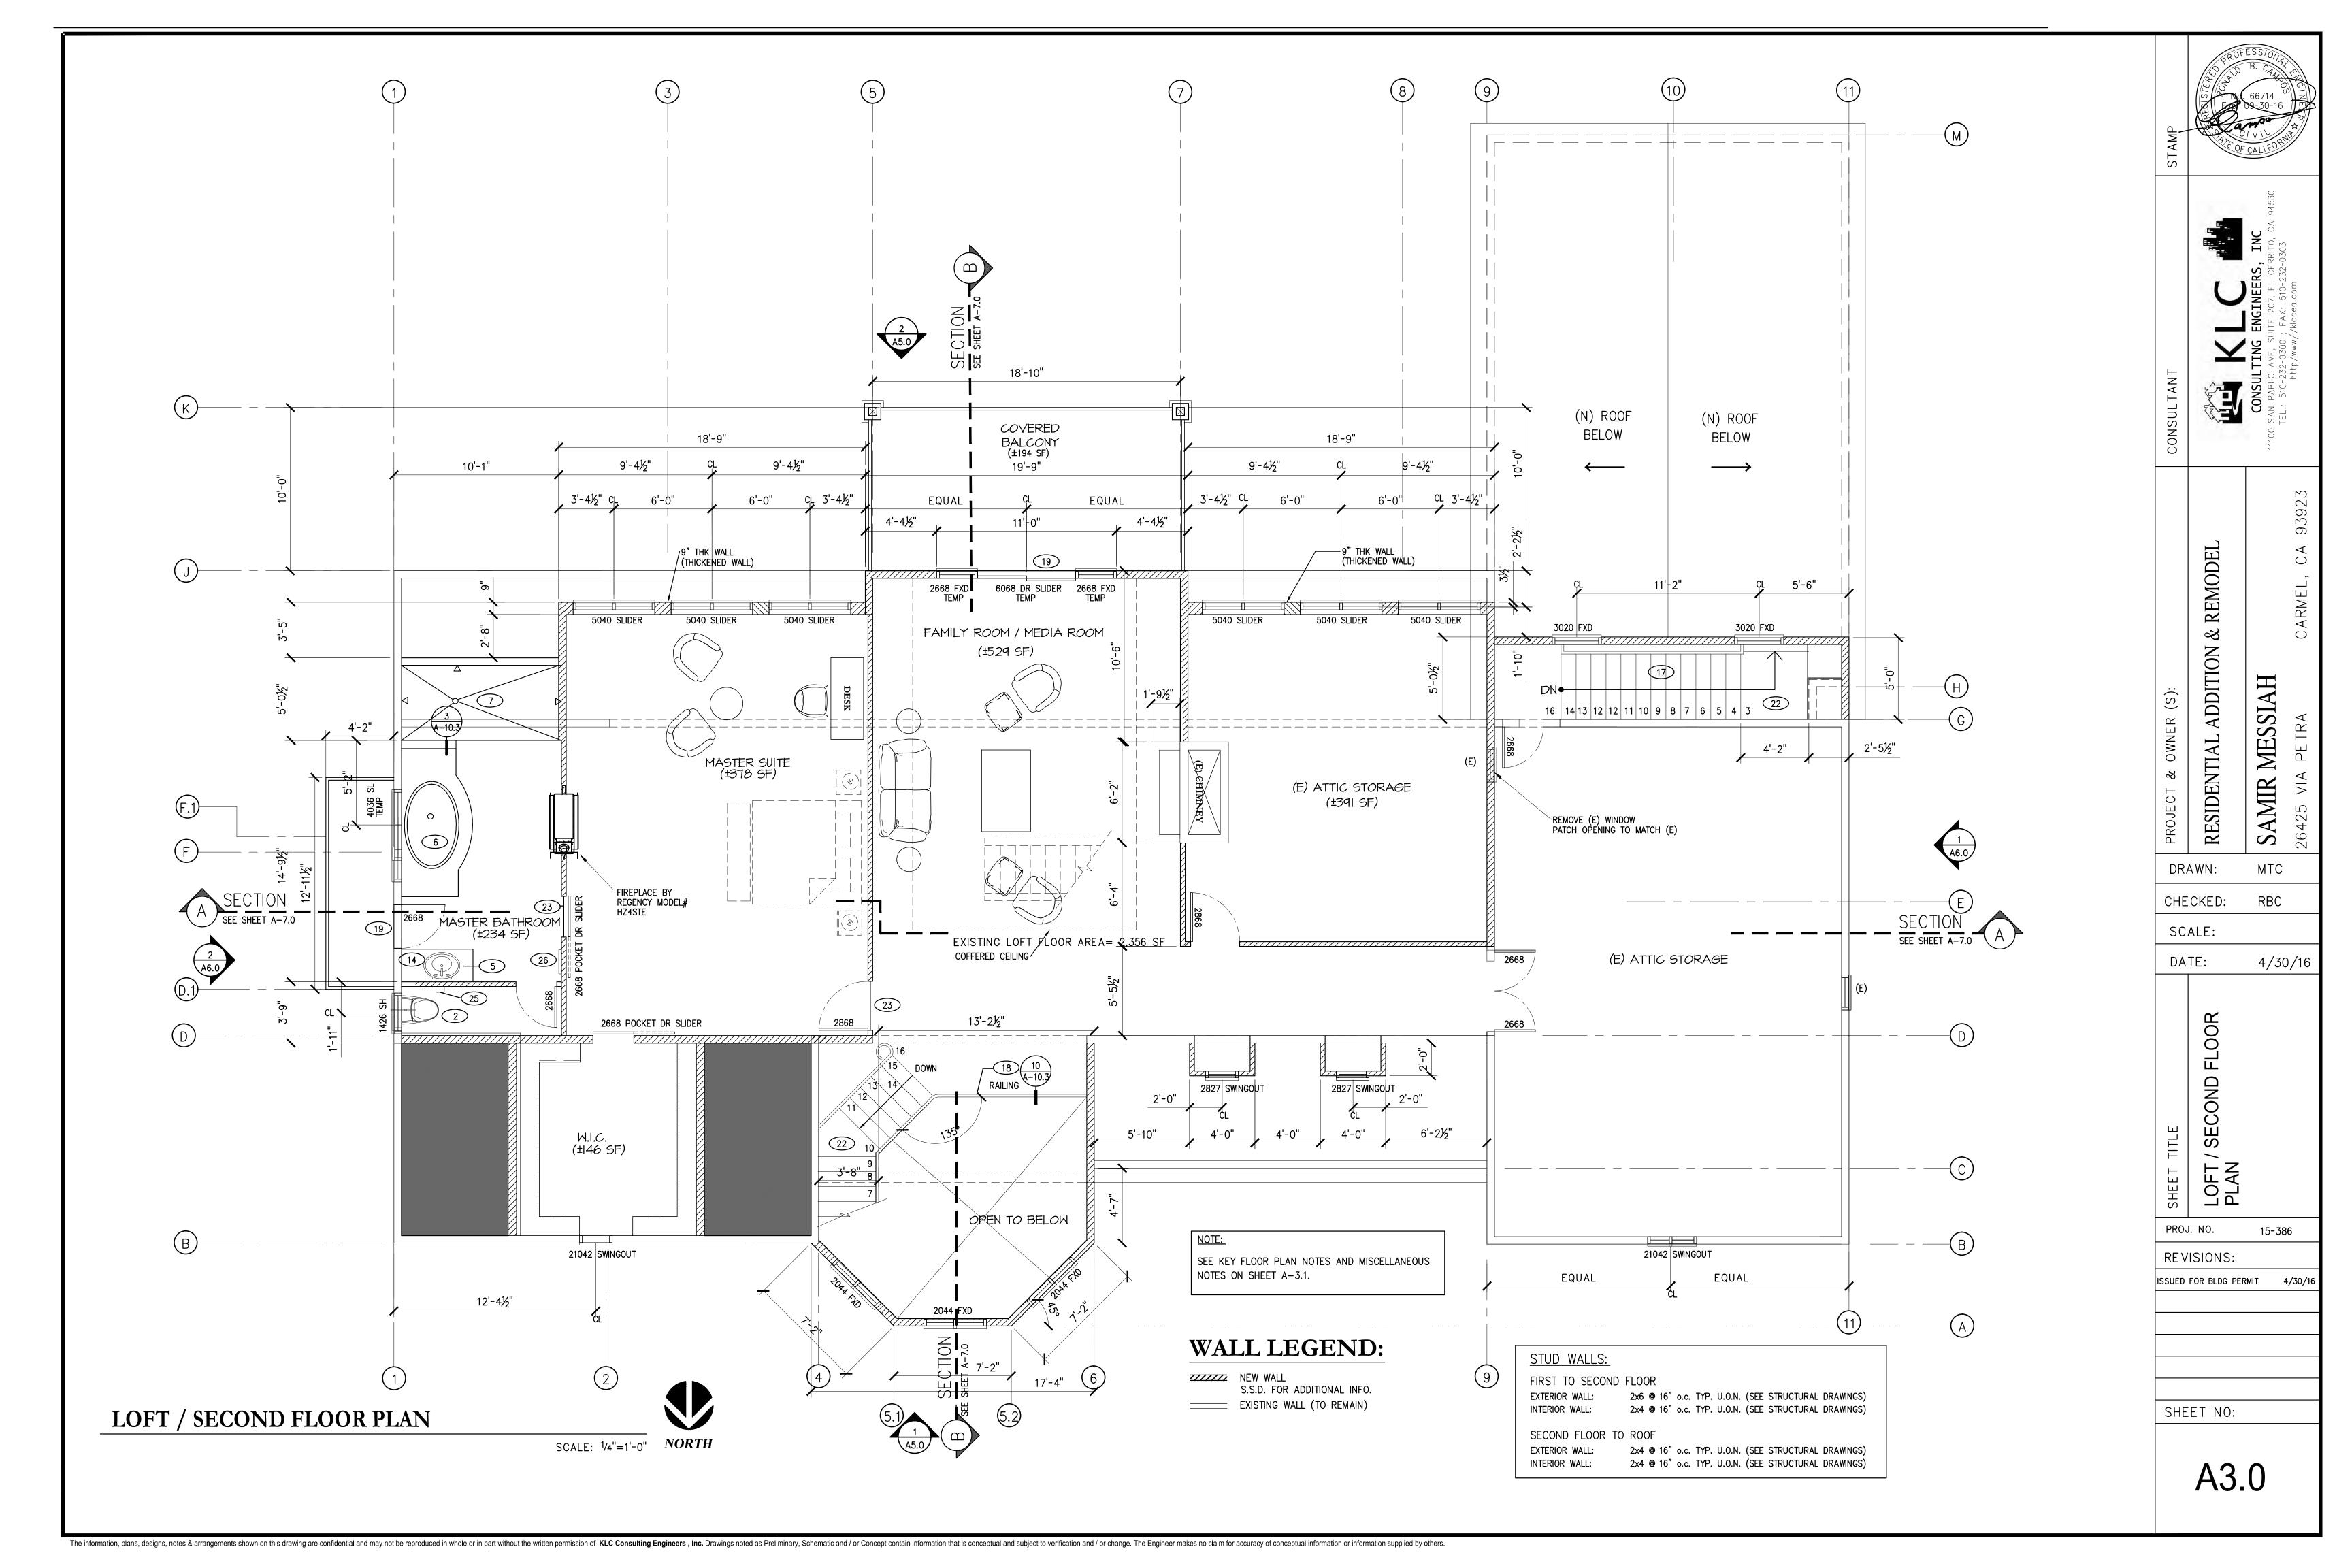

# **DEMOLITION NOTES:**

ALL DEMOLITION WORK SHALL BE DONE IN ACCORDANCE WITH AMERICAN NATIONAL STANDARDS INSTITUTE. "AMERICAN NATIONAL STANDARD SAFETY REQUIREMENTS FOR DEMOLITION" (ANSI A10.6-1) PROTECTION:

THE REMOVAL, CUTTING, DRILLING, ETC. OF EXISTING WORK SHALL BE PERFORMED WITH CARE AND SMALL TOOLS IN ORDER NOT TO JEOPARDIZE THE STRUCTURAL INTEGRITY OF THE EXISTING BUILDING. DO NOT OVERCUT. IF STRUCTURAL MEMBERS NOT INDICATED

FOR REMOVAL INTERFER WITH THE NEW WORK, THE STRUCTURAL ENGINEER SHALL BE IMMEDIATELY NOTIFIED AND PRIOR APPROVAL OBTAINED BEFORE REMOVAL OF MEMBERS.

REMOVE ALL CONCRETE BOLTS AND EMBEDED ITEMS IN CONCRETE FLOORS THAT PROTRUDE ABOVE THE CONCRETE FLOOR SURFACE. GRIND FLUSH ALL PROJECTING STEEL OR PATCH HOLES FLUSH WITH NON SHRINK GROUT.

THE GENERAL CONTRACTOR SHALL FURNISH ALL LABOR AND MATERIALS AS REQUIRED TO COMPLETE DEMOLITION NAD REMOVAL OF ALL ITEMS INDICATED ON THE DRAWINGS OR AS OTHERWISE DIRECTED BY THE OWNER.

DURING CONSTRUCTION, 100% OF CONCRETE MUST BE REUSED OR RECYCLED, AND AT LEAST 50% OF THE REMAINING DEBRIS MUST BE RE-USED OR RECYCLED.

#### CA GREEN MANDATORY MEASURES:

THE CONTRACTOR SHALL REVIEW THE LIMITATIONS AND BASELINES FOR THE SEALANT VOC LIMIT, ARCHITECTURAL COATING, WATER USE, FIXTURE FLOW RATES, AND FORMALDEHYDE LIMIT.

#### CA GREEN MANDATORY MEASURES:

- 1. GRADING AND PREVENTION OF WATER INTO THE BUILDING. NO STORM WATER RETENSION.
- 2. INDOOR FIXTURES REDUCES WATER USE.
- 3. RODENT PROOFING. SEAL PLATES WITH MORTAR.
- 4. MOISTURE CONTENT OF BUILDING MATERIALS IS 19%
- 5. BATHROOM EXHAUST FAN WITH HUMIDITY CONTROL 6. WILL RECYCLE 50% OF DEMOLITION. STUDS, JOISTS, DOORS, AND CABINETS
- 7. WASTE MANAGEMENT BY AUTHORITY HAVING JURIDICTION WILL HANDLE WASTE DISPOSALS.

#### VOC COMPLIANCE

 ADHESIVE MARLITE C-109 OR APPROVED EQUAL 2. SEALANT SHEET ROCK SAELANT LOW-VOC. 3. COATING

#### FORMALDEHYDE COMPLIANCE

- PER CARPET AND RUG INSTITUTES GREEN LABEL 2. PARTICLEBOARD, FIBERBOARD, PLYWOOD COMPOSIT NONESEALANT

# STORMWATER NOTES:

NEW RAINWATER DOWNSPOUT SHALL BE DIRECTED TO A LANDSCAPE AREA. DOWNSPOUTS MAY BE CONNECTED TO A POP-UP DRAIN EMITTER IN THE LANDSCAPED AREA OR MAY DRAIN TO SPLASH BLOCK THAT DIRECTS WATER AWAY FROM THE BUILDING. THRU-CURB DRAINS ARE NOT ALLOWED.

#### SOLID WASTE

GARBAGE AND WASTE HANDLING SHALL BE IN ACCORDANCE WITH THE CITY OF ALAMO "WASTE HANDLING GUIDELINES". THE CONTRACTOR AND THE OWNER SHALL ONTAIN A COPY AND INCORPORATE THE APPLICABLE PARTS.

### PLUMBING AND MECHANICAL REQMNT:

- PROVIDE ULTRA LOW FLUSH TOILET (1.28 GALLONS/FLUSH) AT ALL NEW BATHROOMS.
- 2) PROVIDE WATER CLOSET CLEAR SPACE NOT LESS THAN 30 INCHES IN WIDTH AND 24" INCHES CLEAR SPACE IN FRONT. (CBC 2904)
- PROVIDE MINIMUM SHOWER STALLS OF 1024 SQUARE INCHES CAPABLE OF ENCOMPASSING A 30 INCH CIRCLE. (UPC 410.4)
- ANCHOR OR STRAP WATER HEATER AT POINTS WITHIN THE UPPER AND LOWER ONE-THIRD OF ITS VERTICAL DIMENSION, THE LOWER ANCHOR/STRAP LOCATED TO MAINTAIN A MINIMUM DISTANCE OF 4 INCHES ABOVE THE CONTROLS. UPC 510.5

# **ELECTRICAL REQUIREMENTS:**

- RECEPTACLE OUTLETS SHALL BE INSTALLED IN ALL HABITABLE ROOMS:
- A. ON ALL WALL SPACES 2 FEET OR WIDER.
- B. NOT MORE THAN 6 FEET FROM OPENINGS.
- C. NOT MORE THAN 12 FEET ON CENTERS (NEC 210-52).
- RECEPTACLE OUTLETS SHALL BE INSTALLED IN KITCHENS:
- A. ON COUNTER SPACES 12 INCHES OR WIDER. B. NOT MORE THAN 4 FEET ON CENTERS.
- C. NOT MORE THAN 2 FEET FROM AN EDGE COUNTER.
- D. ON ISLAND/PENINSULAR COUNTER 12" OR WIDER (1 EVERY 4'). (NEC 210-52).
- 3) PROVIDE AT LEAST ONE RECEPTACLE OUTLET AT:
- A. BATHROOM
- B. OUTSIDE
- ALL 110 VOLT, SINGLE PHASE RECEPTACLE OUTLETS SHALL HAVE GROUND FAULT CIRCUIT PROTECTION AT THE FOLLOWING LOCATIONS:
- A. BATHROOM, ADJACENT TO BASIN
- B. OUTSIDE
- WITHIN 6 FEET FROM KITCHEN SINK (NEC 210-8).
- 5) PROVIDE RECEPTACLE OUTLET IN DWELLING UNIT HALLWAYS 10'-0" OR MORE IN LENGTH. (NEC 210-52H).
- PROVIDE WALL SWITCH (2-WAY) AT EACH FLOOR LEVEL TO CONTROL INTERIOR STAIRWAY LIGHTING OUTLET WHEN DIFFERENCE BETWEEN FLOOR LEVELS IS SIX
- STEPS OR MORE. (NEC 210-70-A). PROVIDE SWITCH AND LIGHT AT ATTIC, CRAWL SPACE, UTILITY ROOM OR AREAS WITH
- HVAC EQUIPMENT. (NEC 210-70-A). BATHROOM EXHAUST FAN SHALL HAVE 50 CUBIC FEET PER MINUTE OF INTERMITTENT VENTILLATION, 25 CUBIC
- FEET PER MINUTE OF CONTINUOUS VENTILATION PER CRC R303.3.
- ALL POWER AND LIGHTING OUTLETS IN FAMILY ROOMS, BEDROOMS, HALLWAYS & BEDROOMS SHALL BE PROTECTED BY A "LISTED AFCI BREAKER". KITCHEN AND BATHROOMS ARE EXEMPTED FROM THIS REQUIREMENTS PER CEC 210.12(A).
- 9) NOTE: INSTALL DEDICATED 20AMP CIRCUIT @ BATHROOMS, TYP.
- 10) ALL LIGHTS IN BATHROOM SHALL BE HIGH EFFICACY LUMINARIES.
- 11) ALL RECESSED LIGHT FIXTURES TO HAVE IC RATED ELECTRONIC BALLAST AND SHALL BE AIR-TIGHT.

#### **BATHROOMS**

WATER CLOSET TO HAVE A MINIMUM CLEAR STALL SPACE OF 30" AND A MINIMUM CLEAR SPACE OF 24" IN FRONT AND SHALL BE A LOW FLUSH TYPE 1.28 GALLON MAXIMUM.

SHOWERS TO HAVE A MINIMUM AREA OF 1024 SQ. IN AND MINIMUM CLEAR HORIZONTAL DIMENSION OF 10" MEASURED AT A POINT 7" ABOVE THE DRAIN. SHOWER DOOR TO BE MINIMUM 22" WIDE.

INSTALL TUB WITH FULL MORTAR SET TILE SURROUND EXTEND TILE SURROUND DOWN SIDES OF TUB A MINIMUM OF ONE FULL TILE WIDTH. INSTALL SHOWER HEAD OVER TUB WHERE SHOWN ON DRAWINGS.

SHOWERS SHALL BE FINISHED TO A HEIGHT OF NOT LESS THAN 70 INCHES ABOVE THE DRAIN INLET. MATERIALS OTHER THAN STRUCTURAL ELEMENTS USED IN SUCH WALLS SHALL BE OF A TYPE WHICH IS NOT ADVERSELY AFFECTED BY MOISTURE; I.E. CERAMIC TILE, WATER-RESISTANT GYPSUM, ETC. UBC 510.

WHEN GYPSUM IS USED AS A BASE FOR TILE OR WALL PANELS FOR TUB OR SHOWER ENCLOSURES OR WATER CLOSET COMPARTMENT WALLS, WATER-RESISTANT GYPSUM BACKING BOARD SHALL BE USED, EXCEPT THAT WATER-RESISTANT GYPSUM BOARD SHALL NOT BE USED IN THE FOLLOWING LOCATIONS: OVER A VAPOR RETARDER, IN AREAS SUBJECT TO CONTINUOUS HIGH HUMIDITY, SUCH AS SAUNAS, STEAM ROOMS OR GANG SHOWER ROOMS, AND ON CEILINGS WHERE FRAME SPACING EXCEEDS 12" ON CENTER. UBC 2512.

MAXIMUM ALLOWED RATE FOR WATER USE: 1.28 GPF 2.0 GPM WATER CLOSETS SHOWER HEADS

2.2 GPM.

STAGGER STUDS 6" WALL FOR PLUMBING WATER CLOSET VENT THROUGH ROOF, TYPICAL

FAUCETS

ALL THREE BATHROOMS SHALL RECEIVE MECHANICAL EXHAUST.

#### **VENTILATION**

- 1) PROVIDE ONE SQ.FT. OF VEND AREA FOR EACH 150 SQ. FT. OF UNDER FLOOR AREA TO CONFORM TO UBC SECTION 2317.7. CENTER VENTS UNDER WINDOWS WHERE POSSIBLE.
- 3) GIRDER ENTERING CONCRETE WALLS SHALL HAVE 1/2" AIR SPACE ON TOPS, SIDES AND
- 4) ALL PLUMBING VENTS TO BE MINIMUM 10 FT. FROM OPERABLE SKYLIGHTS.

- 1) PROVIDE 18" MIN. BY 24" MIN. ACCESS TO ALL FOUNDATION SPACES UBC 2317.3. PROVIDE ONE ACCESS WITHIN 20' OF BATHROOM AND KITCHEN PLUMBING.
- 2) PROVIDE 22" MIN. BY 30" MIN. ACCESS TO ALL ATTIC SPACES WITH 30" CLEAR

#### FIRE PROTECTION

- 1) ALL GARAGE WALLS AND CEILING COMMON WITH HOUSE, OR SUPPORTING LIVING AREA ABOVE, TO BE ONE HOUR CONSTRUCTION WITH 5/8" TYPE "X" GYPSUM BOARD MINIMUM ON EACH SIDE. DOORS FROM GARAGE TO HOUSE TO BE 20 MINUTES RATED WITH SELF-CLOSING DEVICE. TB-7 AND T3-B.
- 2) USEABLE SPACE UNDER STAIRS TO BE ONE HOUR CONSTRUCTION. 5/8" TYPE "X"
- 4) A SMOKE DETECTOR SHALL BE INSTALLED IN EACH BEDROOM, AT EACH CORRIDOR/AREA NEXT TO THE BEDROOM, AND EACH STORY AND BASEMENT. IT SHALL BE MOUNTED ON A CEILING OR WALL AT A POINT CENTRALLY LOCATED IN THE CORRIDOR OR AREA GIVING ACCESS TO BEDROOMS. WHEN BEDROOMS ARE ON AN UPPER LEVEL, THE SMOKE DETECTOR SHALL BE PLACED ON THE CEILING OF THE UPPER LEVEL, CLOSE TO THE STAIRWAY. SMOKE DETECTORS SHALL RECEIVE THEIR PRIMARY POWER FROM THE BUILDING WIRING. WIRING SHALL BE PERMANENT AND WITHOUT A DISCONNECTING SWITCH OTHER THAN THOSE REQUIRED FOR OVER CURRENT PROTECTION. PROVIDE HARDWIRE INTERCONNECTED SMOKE DETECTORS EQUIPPED WITH BATTERY BACK UP. EXCEPTIONS: SMOKE DETECTORS MAY BE SOLELY BATTERY OPERATED WHEN INSTALLED INTO EXISTING BUILDINGS; OR IN BUILDINGS WHICH UNDERGO ALTERATIONS, REPAIRS OR ADDITION. UBC SECTION 3109.1.2.
- 5) CEMENT PLASTER SHALL BE MINIMUM 7/8" THICK (3 COATS) WITH WIRE MESH OVER TWO LAYERS OF GRADE "D" PAPER AND WITH WEEP SCREED AT BOTTOM. WEEP SCREED TO BE 4" MIN CLEARANCE TO EARTH, AND 2" MIN. CLEARANCE TO CONCRETE

#### GLAZING

- ARCHITECTURAL GLAZING MATERIALS, AND WITH FEDERAL SPECIFICATIONS. UBC
- ALL ESCAPE OR RESCUE WINDOWS SHALL HAVE A MINIMUM NET CLEAR OPENABLE AREA OF 5.7 SQ.FT. THE MINIMUM NET CLEAR OPENABLE HEIGHT DIMENSION SHALL
- BE 24". THE MINIMUM NET CLEAR OPENABLE WIDTH DIMENSION SHALL BE 20"
- HAVE A FINISHED SILL HEIGHT NOT MORE THAN 44" ABOVE THE FLOOR. UBC 310.4.
- 5) ALL WINDOWS AND SKYLIGHTS MUST HAVE DUAL GLASS PANE. (FMC 7-1221, ITEM 3601.3.7)

#### STAIRS

- 1) RISERS ON STAIRWAYS SHALL NOT BE LESS THAN 4" NOR GREATER THAN 7". THE GREATEST RISER HEIGHT SHALL NOT EXCEED THE SMALLEST BY MORE THAN 3/8". THE RUN SHALL NOT BE LESS THAN 9". THE LARGEST RUN SHALL NOT EXCEED THE SMALLEST BY MORE THAN 3/8". UBC 1006.3.
- 2) THE TOP OF THE GUARDRAIL SHALL NOT BE LESS THAN 36" IN HEIGHT. INTERMEDIATE RAILS SHOULD BE SPACED SO THAT A 4" DIAMETER SPHERE CANNOT
- 3) THE HANDGRIP PORTION OF ALL STAIR HANDRAIL SHALL NOT BE LESS THAN 1 1/4" OR MORE THAN 2" IN CROSS SECTIONAL DIMENSION AND IT SHALL HAVE A SMOOTH SURFACE WITH NO SHARP CORNERS. UBC 1006.9.

# **KEY FLOOR PLAN NOTES:**

- 1 LINEN W/6 SHELVES
- 2 WATER CLOSET W/ 1.28 GPF (VENT THROUGH THE ROOF)
- 3 22"X30" ATTIC ACCESS, 30X30 IF ACCESS TO FURNACE
- 4 LINE OF CABINET ABOVE. CONRACTOR TO PROVIDE BLOCKING AS REQ'D. SEE DETAIL-8 / A-10.3 FOR ADDITIONAL INFO.
- 5 GRANITE SLAB. SEE DETAIL-2/A-10.3 FOR ADDITIONAL INFO.
- 6 WHIRLPOOL TUB AND PLATFORM-PROVIDE 14"X14" PUMP MOTOR ACCESS
- (7) TUB/SHOWER W/TEMP. GLASS ENCLOSURE
- 8 MEDICINE CABINET
- (9) WASHING MACHINE
- (10) DRYER-VENT TO OUTSIDE
- (11) WATER HEATER LOCATION W/SEISMIC STRAPPING. NOT USED
- 12) FURNACE LOCATION, T.B.D.
- ELECTRIC FIREPLACE SHALL BE SUPERIOR MODEL BBV-36 OR EQUAL W/ GRANITE HANSI Z2150 AGENCY LISTING BY WARROCK HERSEY J99025850
- 14 LAVATORY (15) CLOSET: VINLY COATED WIRE CLOTHES RACK /SHELF: 1 SHELF AND 1 POLE
- (16) CLOSET: VINLY COATED WIRE CLOTHES RACK /SHELF: 2 SHELVES AND 2 POLES
- 5/8" TYPE 'X' GWB AT WALLS AND CEILIND UNDER STAIRS (18) 36" WOODEN GUARD RAIL
- 19 THRESHOLD DIMENSION NOT TO EXCEED 0.75"
- 20 DUCT SPACE NOT USED
- (21) STUCCO BUILD OUT COLUMNS WITHCULTURED STONE BASE / WAINSCOT
- 22) STAIRS 16 RISERS @ 7.0" EA.- SEE DETAIL 1, 4, 10 & 11 / A-10.3
- 23 FLOORING TRANSITION STRIP— SEE DETAIL 9/A-10.3
- 24 22"X30" FLOOR ACCESS
- 25) TOILET PAPER HOLDER, PROVIDE BLOCKING +24" HIGH
- 26) TOWEL BAR, PROVIDE BLOCKING +52" HIGH
- 27 MIRROR W/ J MOLD FRAME
- 28 LAVATORY / SINK
- 29 FLOOR MATERIAL TRANSITION NOT USED
- 30) TOWEL RING, PROVIDE BLOCKING
- BARREL VAULT OR ARCH NOT USED
- 32 DUAL SINK W/FOOD DISPOSER
- 33 DISHWASHER UNDER COUNTER 34) PANTRY W/5 SHELVES
- 35) 36" GAS OVEN RANGE 36" REFRIGERATOR/FREEZER-PLUMB FOR ICE-MAKER
- 37) BUILT IN MICROWAVE
- 38) REMOVE (E) WINDOW & PATCH OPENING TO MATCH (E).
- 39) REMOVE (E) WINDOW & REPLACE W/ (N) DOOR W/ SIDELITE (SEE FLOOR PLAN). PATCH OPENING TOMATCH (E).
- 40) CUT (E) WLL TO ACCOMODATE (N) DOOR.
- (41) (N) OPEN DECK W/ STONE PAVER FINISH. (42) (N) STAIR W/ 3 THREADS @ 11" AND 4 RISERS @ 6.50". (V.I.F.).
- 8 **ADDITION** SI ME  $\mathbb{Z}$ S DRAWN: MTC CHECKED: RBC SCALE: 4/30/16 DATE:

AN S Ш NOT

のコヹ

PROJ. NO.

**REVISIONS:** 

ISSUED FOR BLDG PERMIT

15-386

SHEET NO:




2) PROVIDE UNDER ROOF CROSS VENTILATION AT THE RATE OF 1/150 OF THE ATTIC AREA. UBC SECTION 1505.3.


ENDS. UBC 2317.6


HEIGHT OR MORE. UBC 1505.1.

- GYPSUM BOARD MIN. AT ALL WALLS AND CEILING.
- 3) PROVIDE 6" MIN. CLEARANCE ON SIDES AND BACK OF FURNACE
- SLAB. T-25D SECTION 2506.
- ALL GLASS AND GLAZING SHALL COMPLY WITH THE U.S. SAFETY STANDARDS FOR CHAPTER 24 AND 26.
- 3) WHEN WINDOWS ARE PROVIDED AS A MEANS OF ESCAPE OR RESCUE THEY SHALL
- 4) GLASS SHOWER AND TUB ENCLOSURES TO BE TEMPERED GLASS. UBC 2406.

- PASS THROUGH. UBC 509.2 AND 509.3.

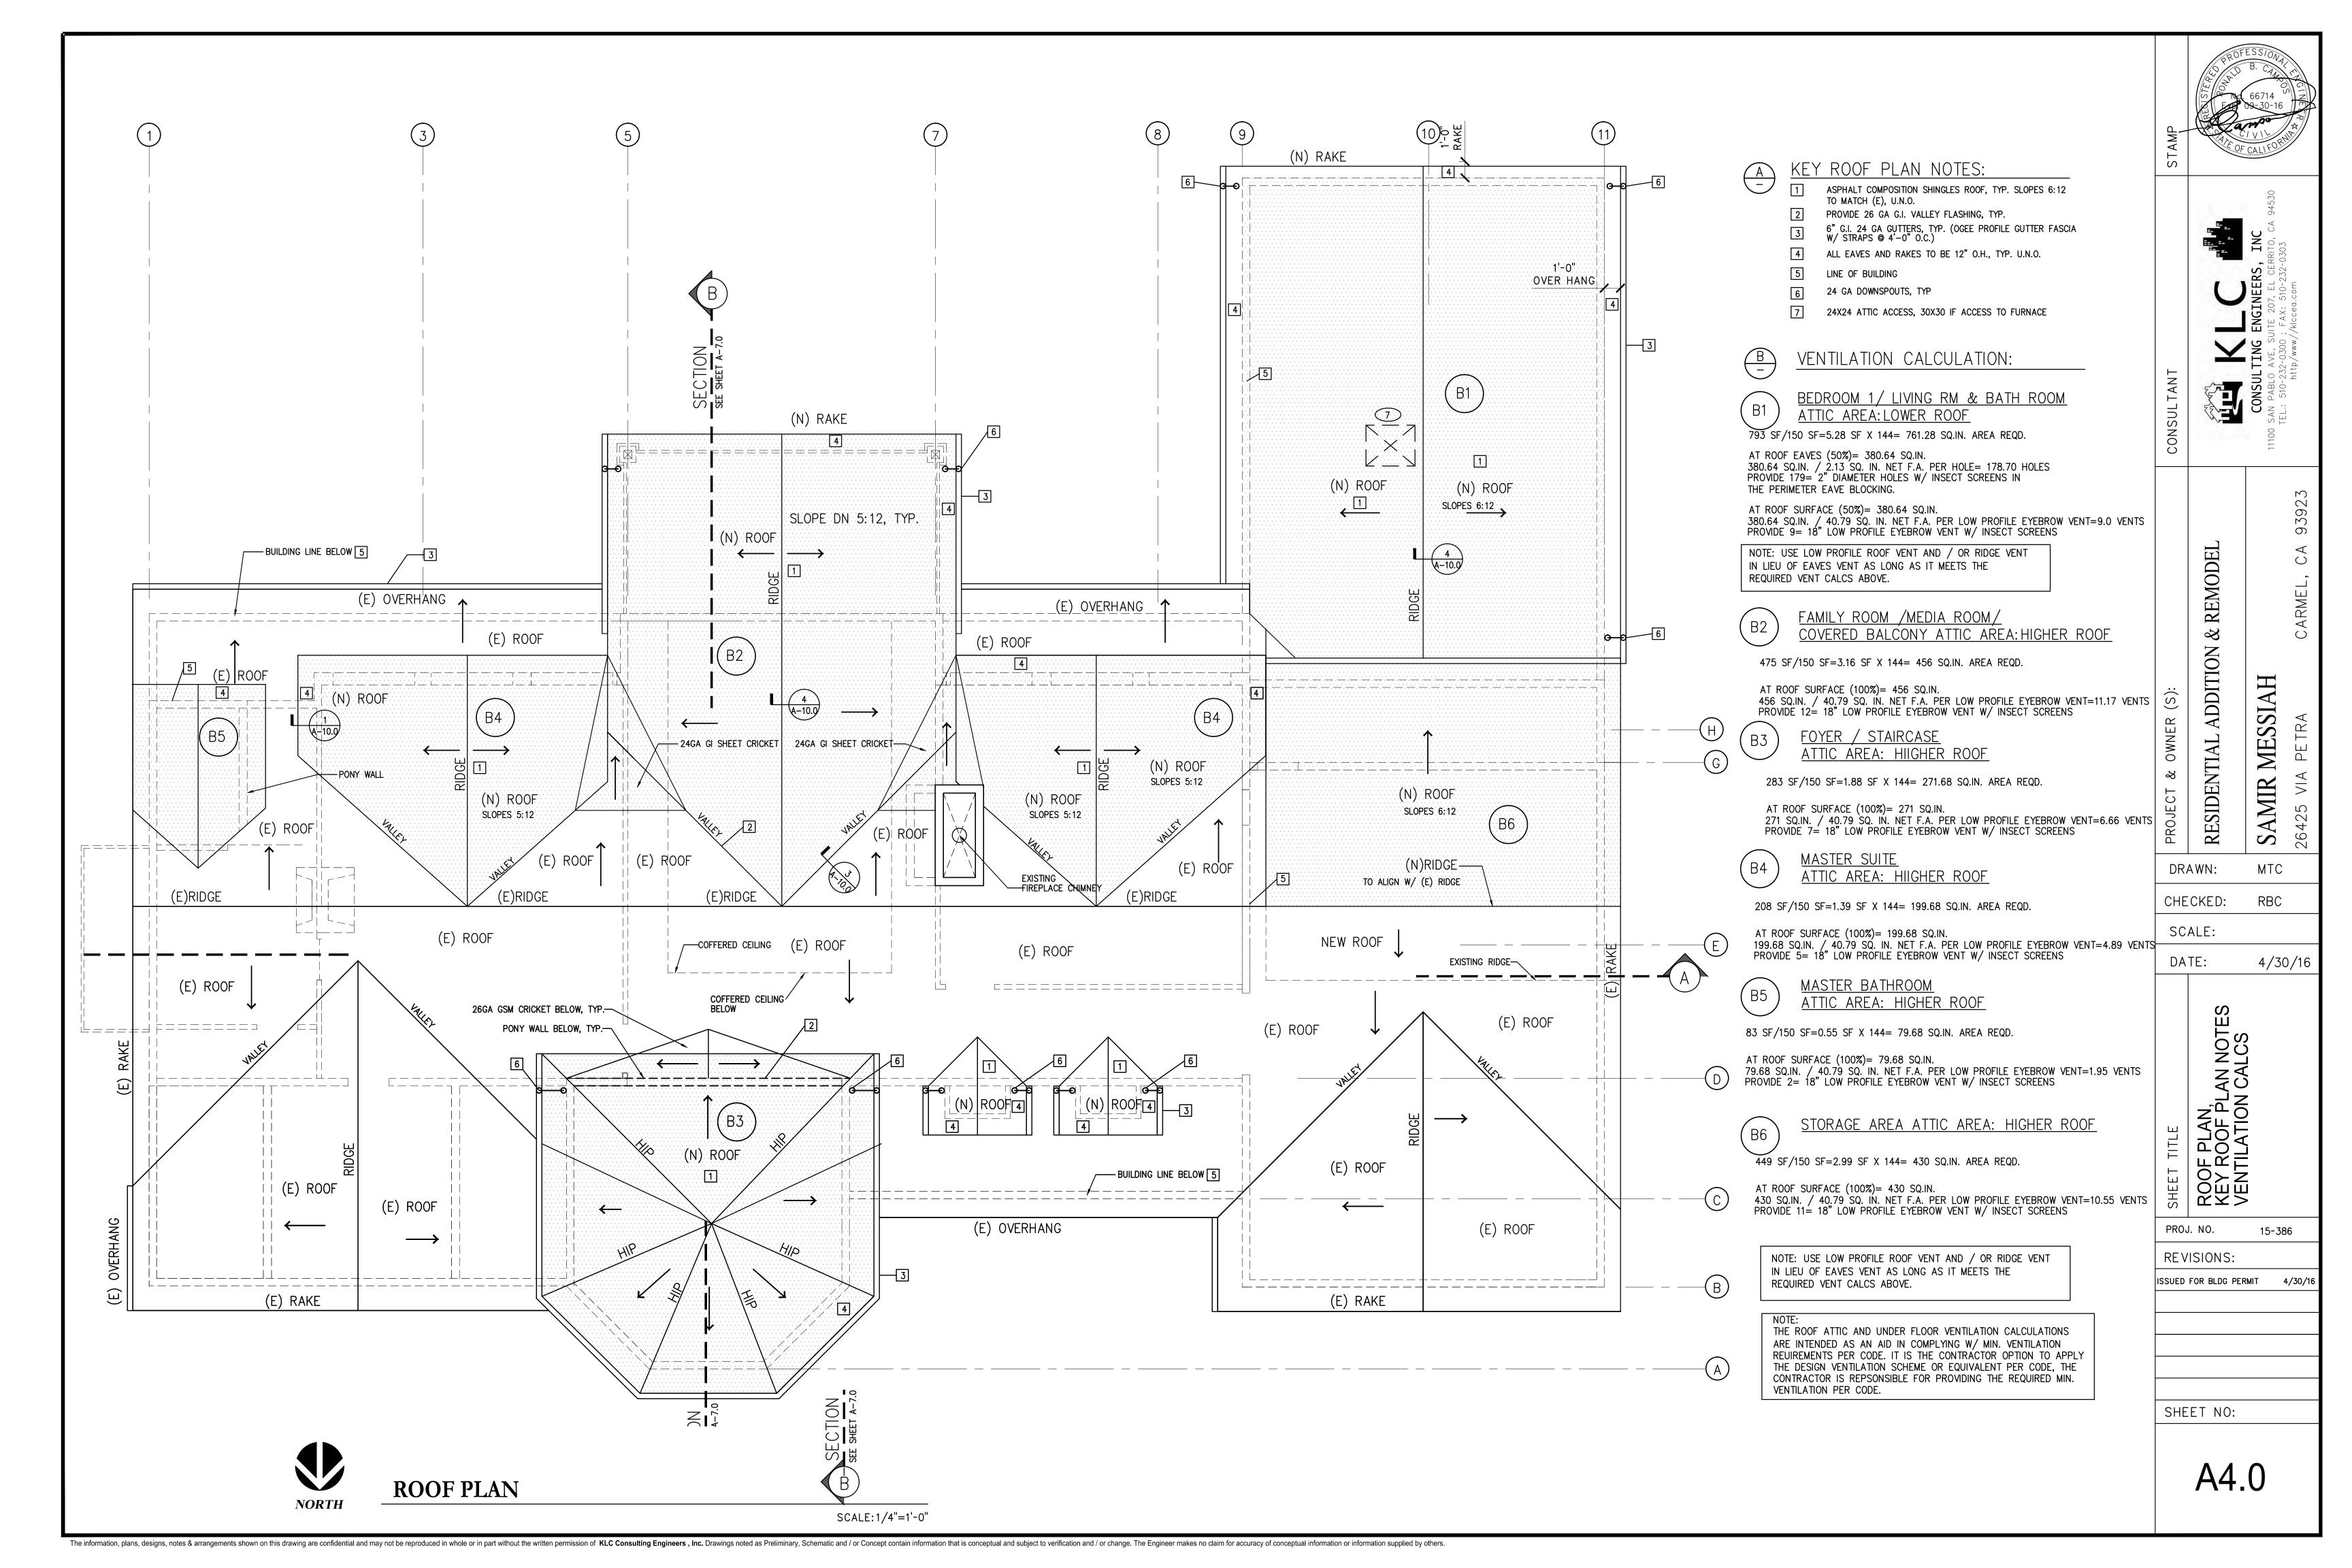

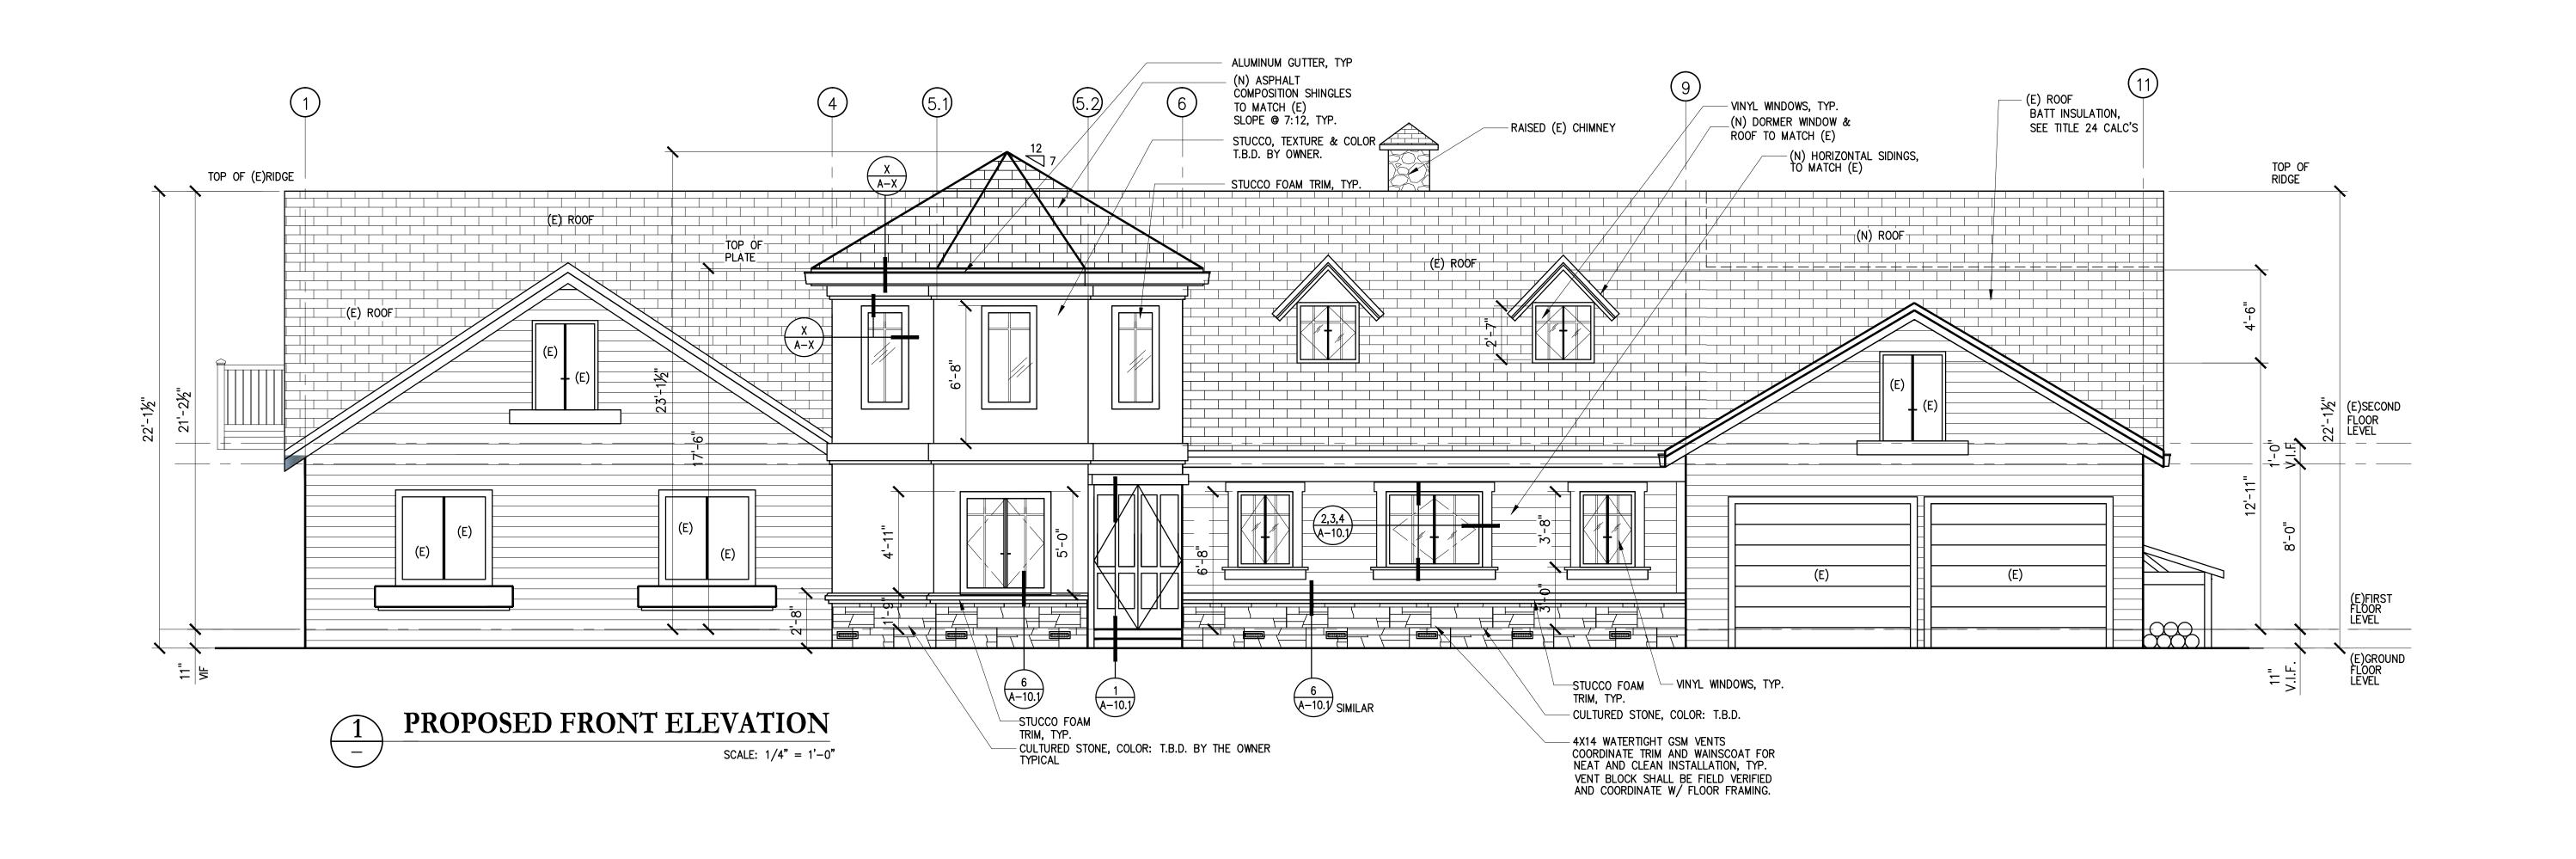

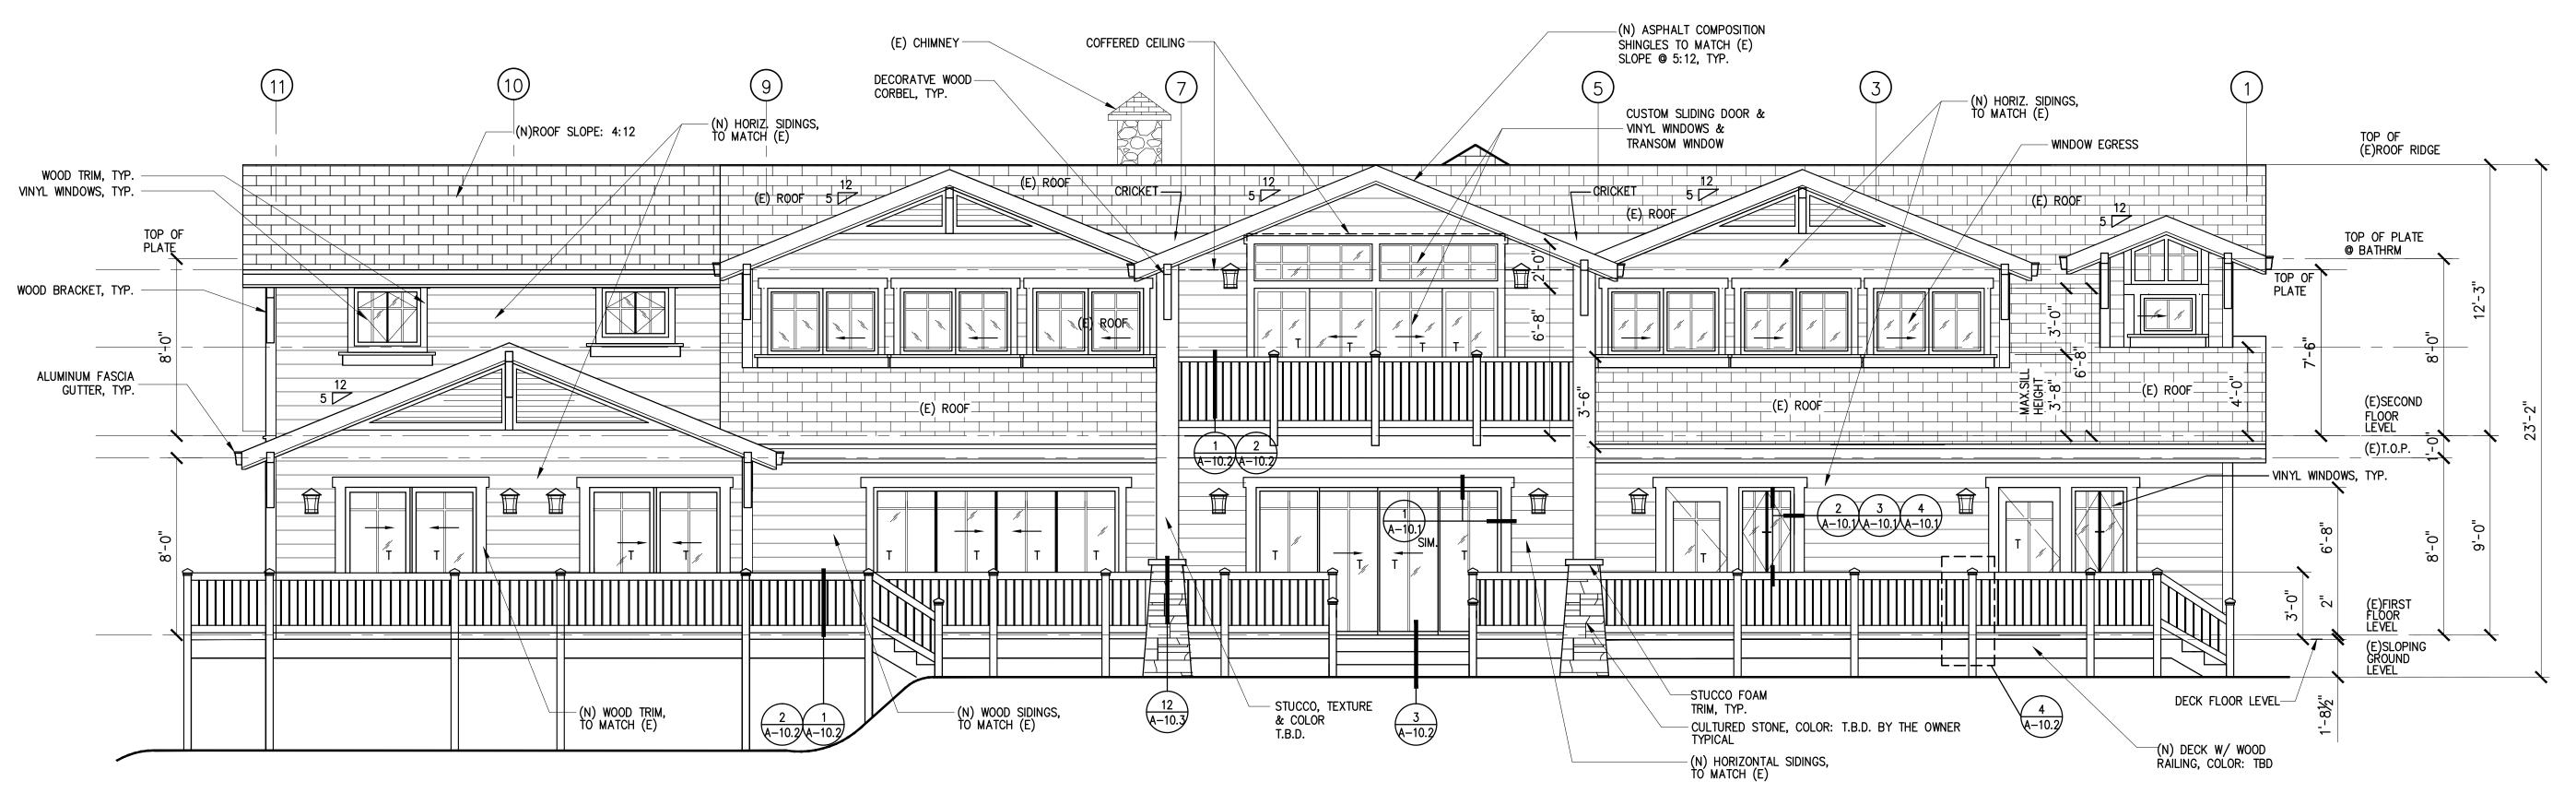

PROPOSED REAR ELEVATION

SCALE: 1/4" = 1'-0"

The information, plans, designs, notes & arrangements shown on this drawing are confidential and may not be reproduced in whole or in part without the written permission of KLC Consulting Engineers, Inc. Drawings noted as Preliminary, Schematic and / or Concept contain information that is conceptual and subject to verification and / or change. The Engineer makes no claim for accuracy of conceptual information or information supplied by others.

DESTONATION OF CALLED

ILTING ENGINEERS, INC

O AVE, SUITE 207, EL CERRITO, CA 94530
232-0300; FAX: 510-232-0303

CONSULTING ENGINE

THOO SAN PABLO AVE, SUITE 207,
TELL FALL-272-0700 : FAVE 51

93923

 $\circ$ 

MESSIAH

SA

MTC

PROJECT & OWNER (S):

RESIDENTIAL ADDITION & REMODEI

CHECKED: RBC

SCALE: 4/30/16

DRAWN:

SNOILY

SHEET TITLE

BUILDING ELEVATIONS
FRONT & REAR

PROJ. NO. 15-386


REVISIONS:


ISSUED FOR BLDG PERMIT 4/30/16

ISSOLD FOR BEDG FERWIT

SHEET NO:

A5.0

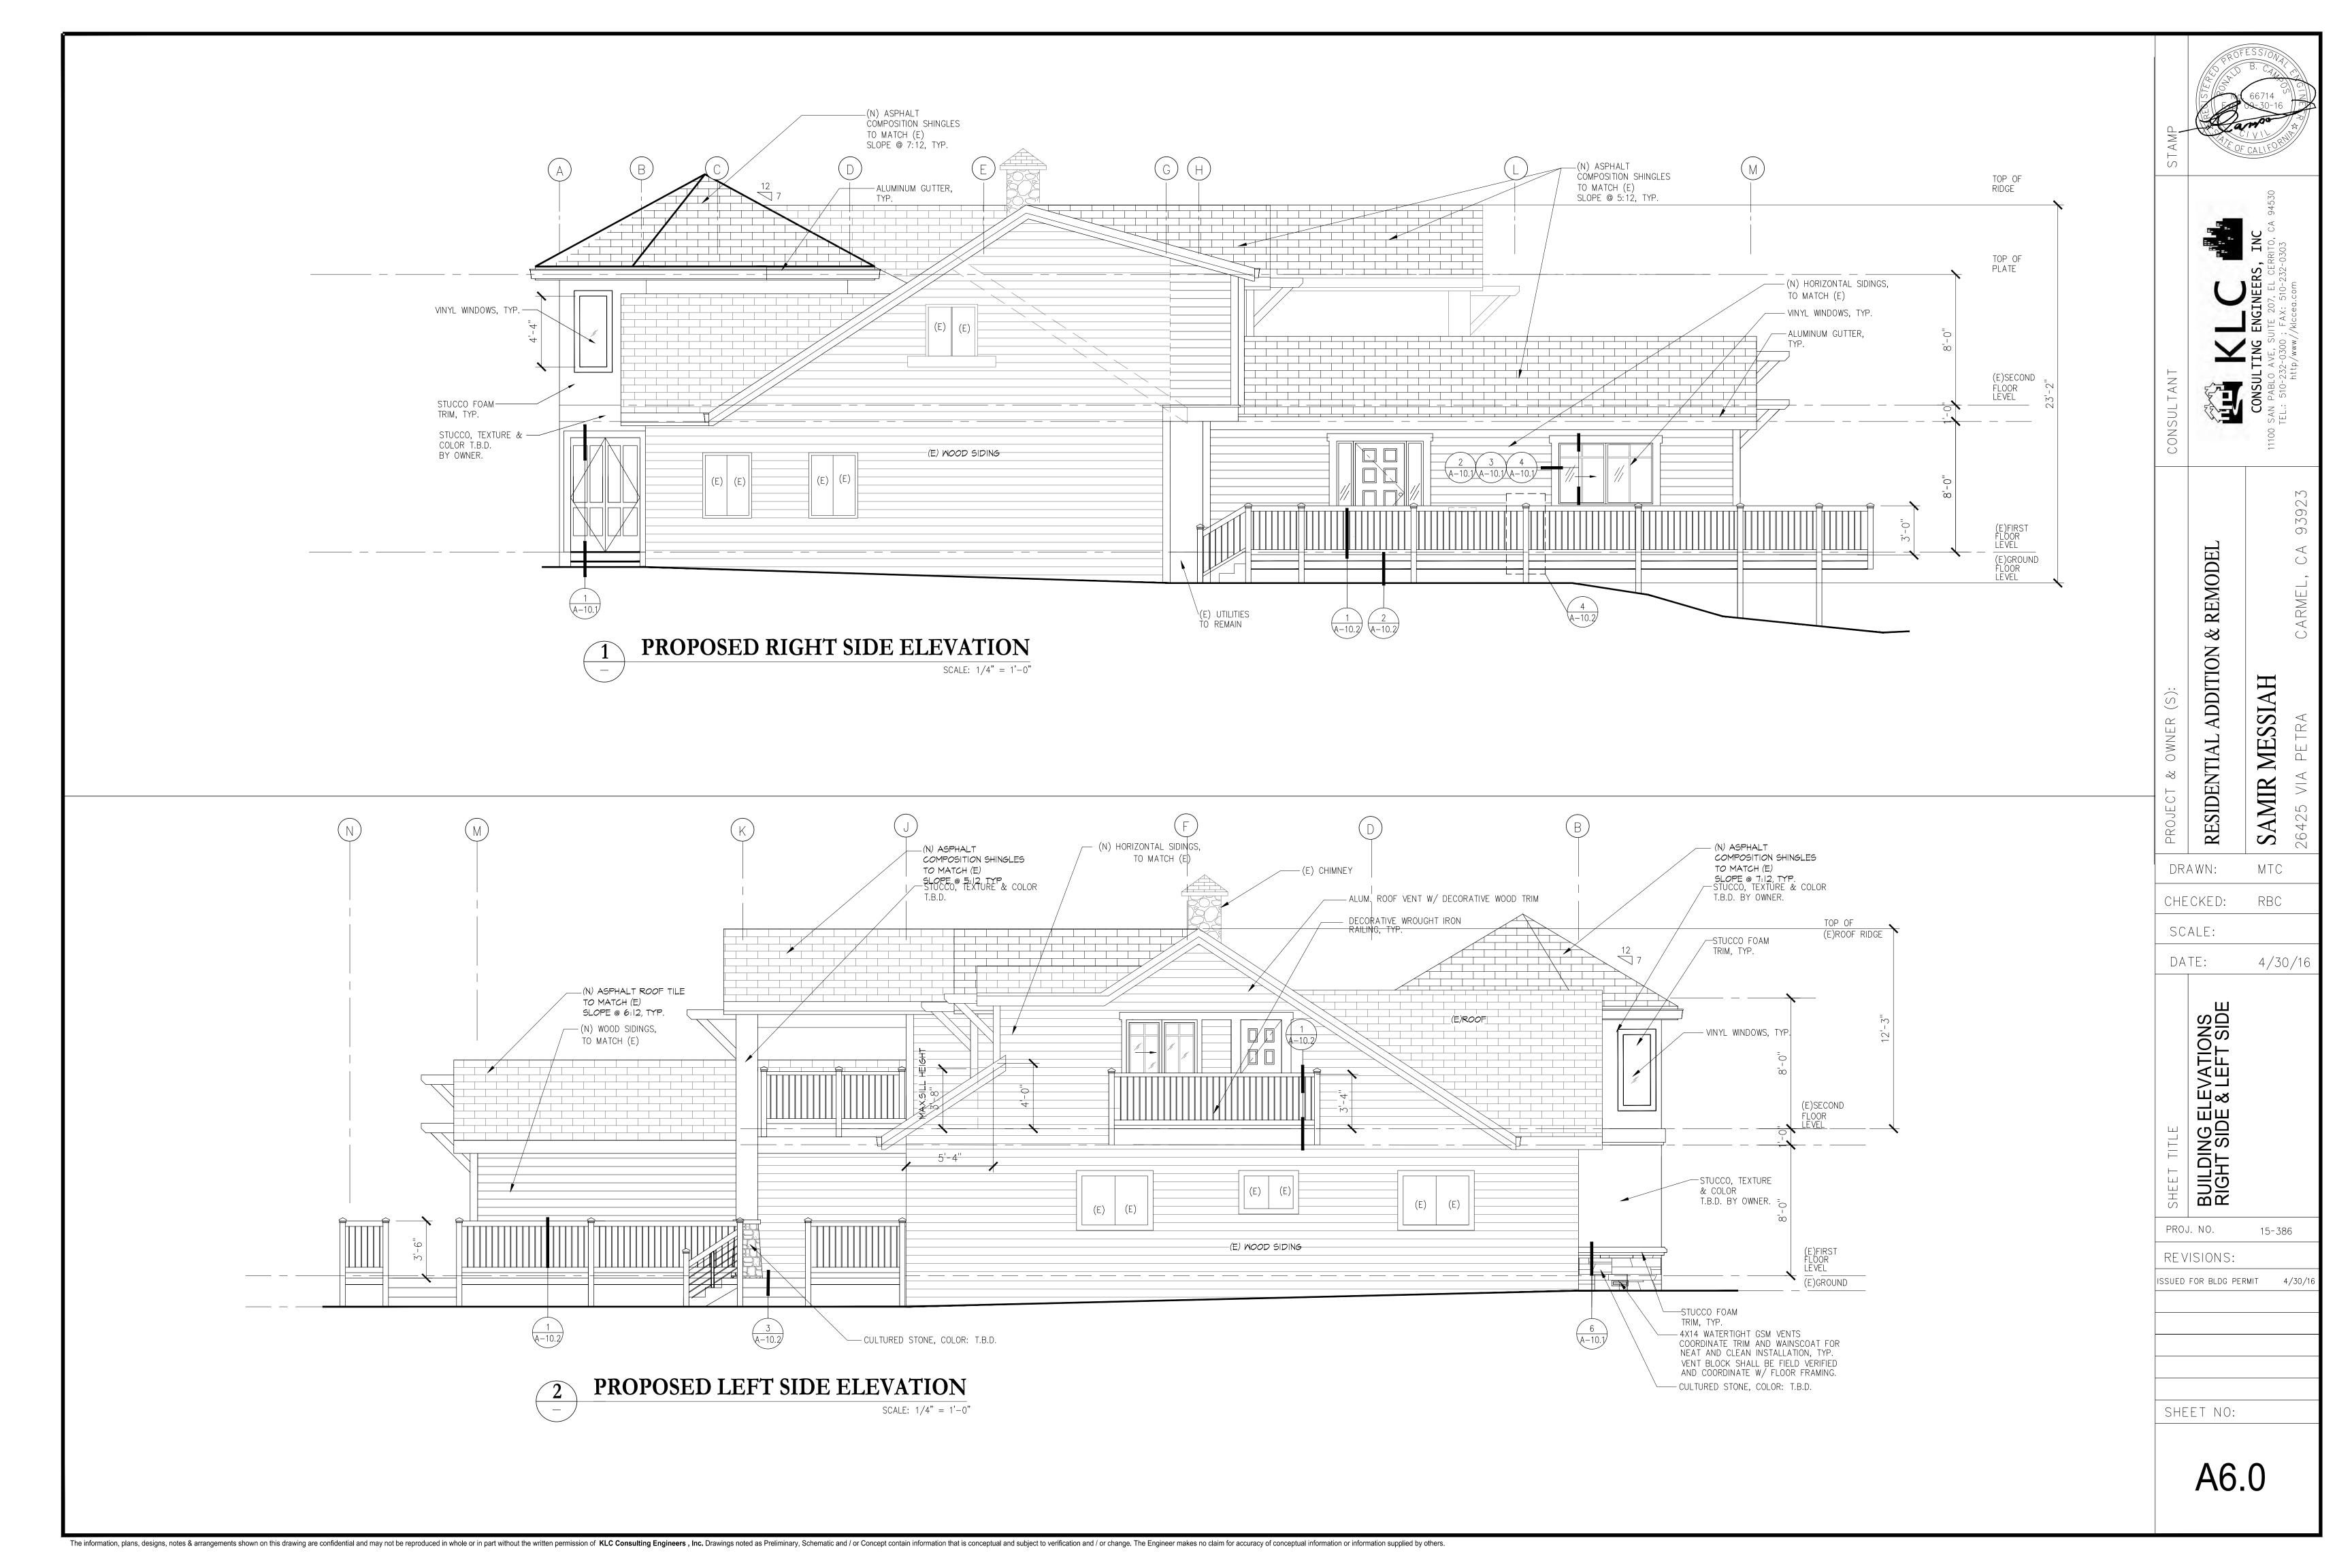

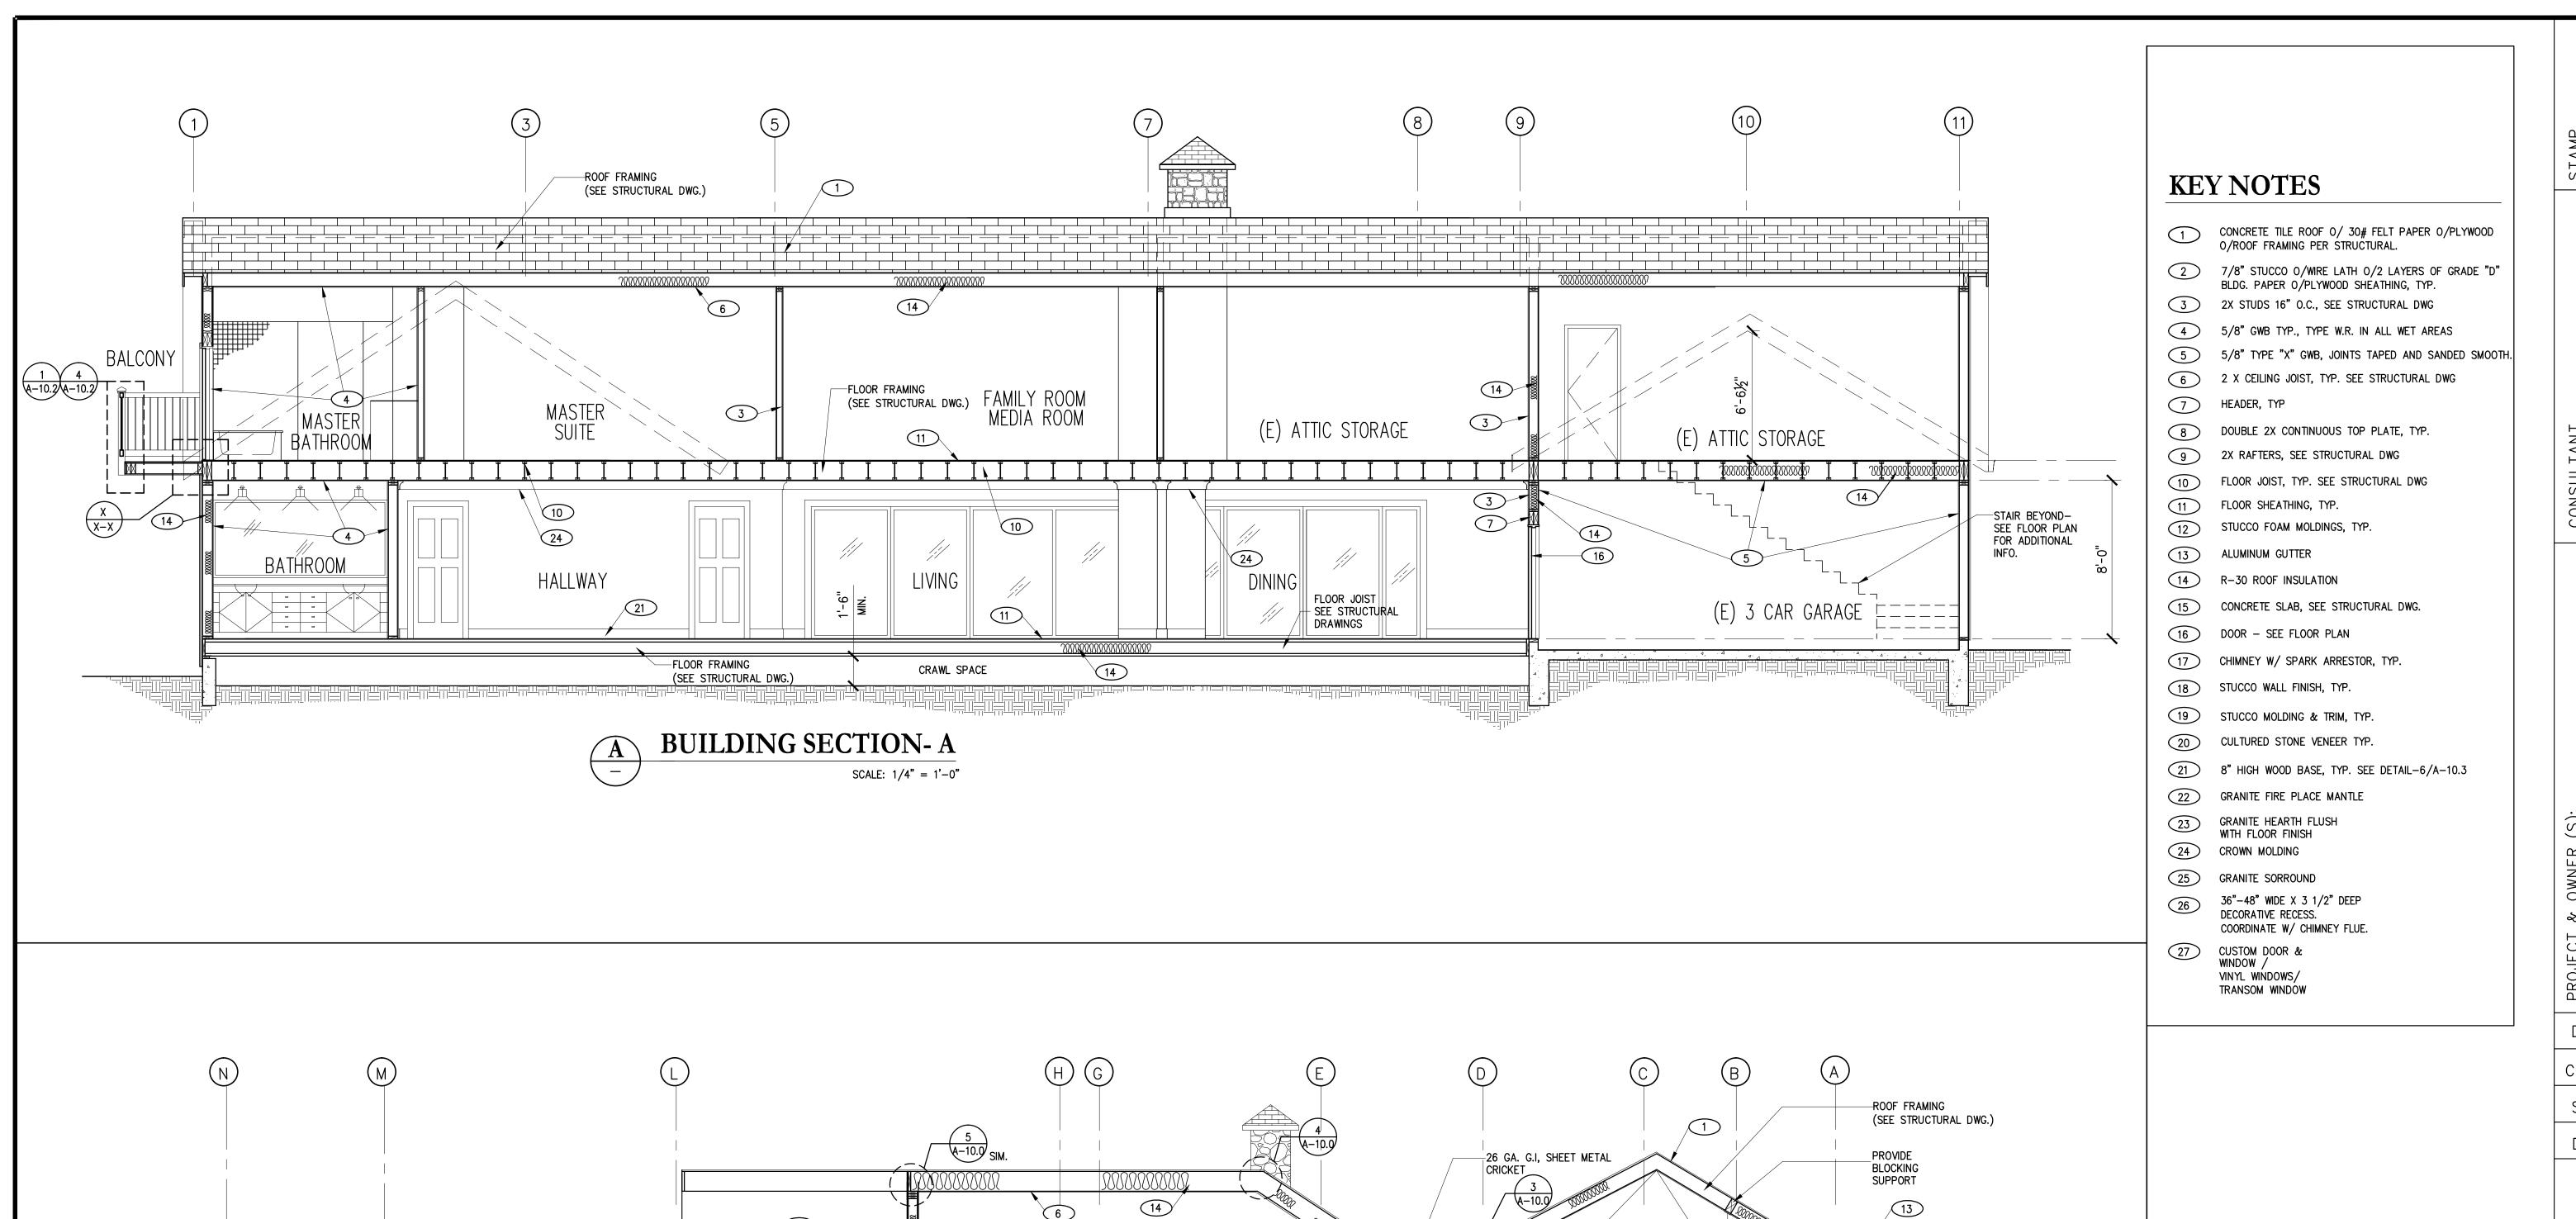

F.P. 23

26

LIVING

RECESSED

6 A-10.3

> REF. SPACE

CRAWL SPACE

OVERLOOKING | FOYER

6 A-10.3

FOYER


FAMILY ROOM

24

- CHANDELIER /

3

PENDANT LIGHT FIXTURE BY OWNER

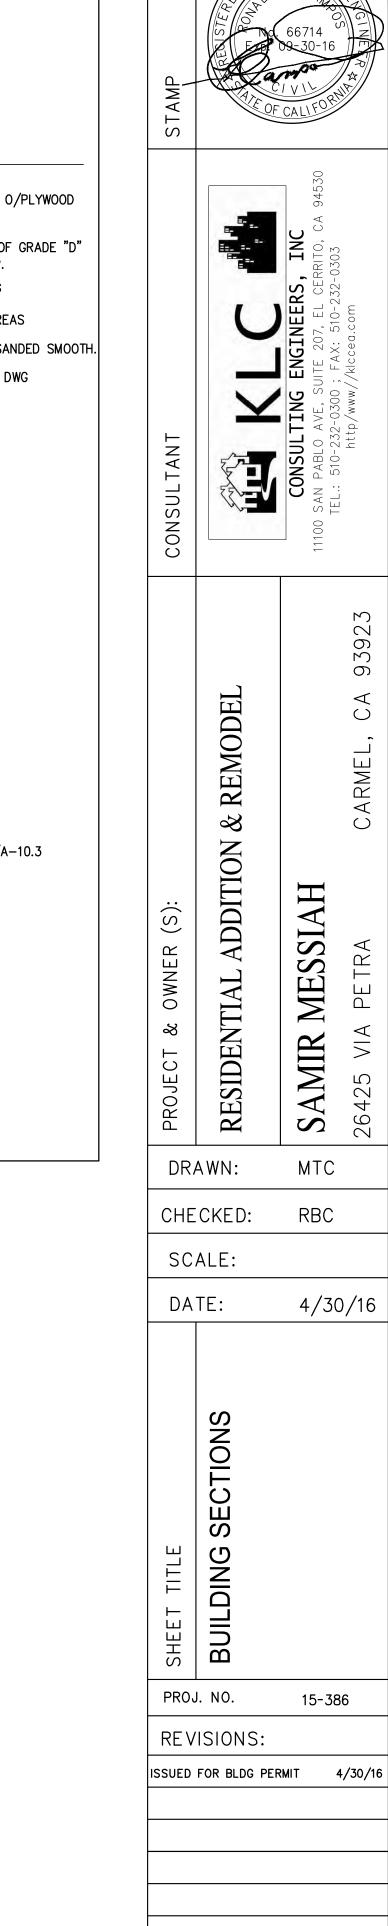

B BUILDING SECTION- B

SCALE: 1/4" = 1'-0"

COVERED DECK

DECK

1 A-10.2 A-10.2

> 1 4 A-10.2 A-10.2

COFFERRED CEIING-

MASTER BERROOM ROOM

8


10 24


FAMILY ROOM BEYOND


FLOOR JOIST — SEE STRUCTURAL DRAWINGS

A7.0


SHEET NO:

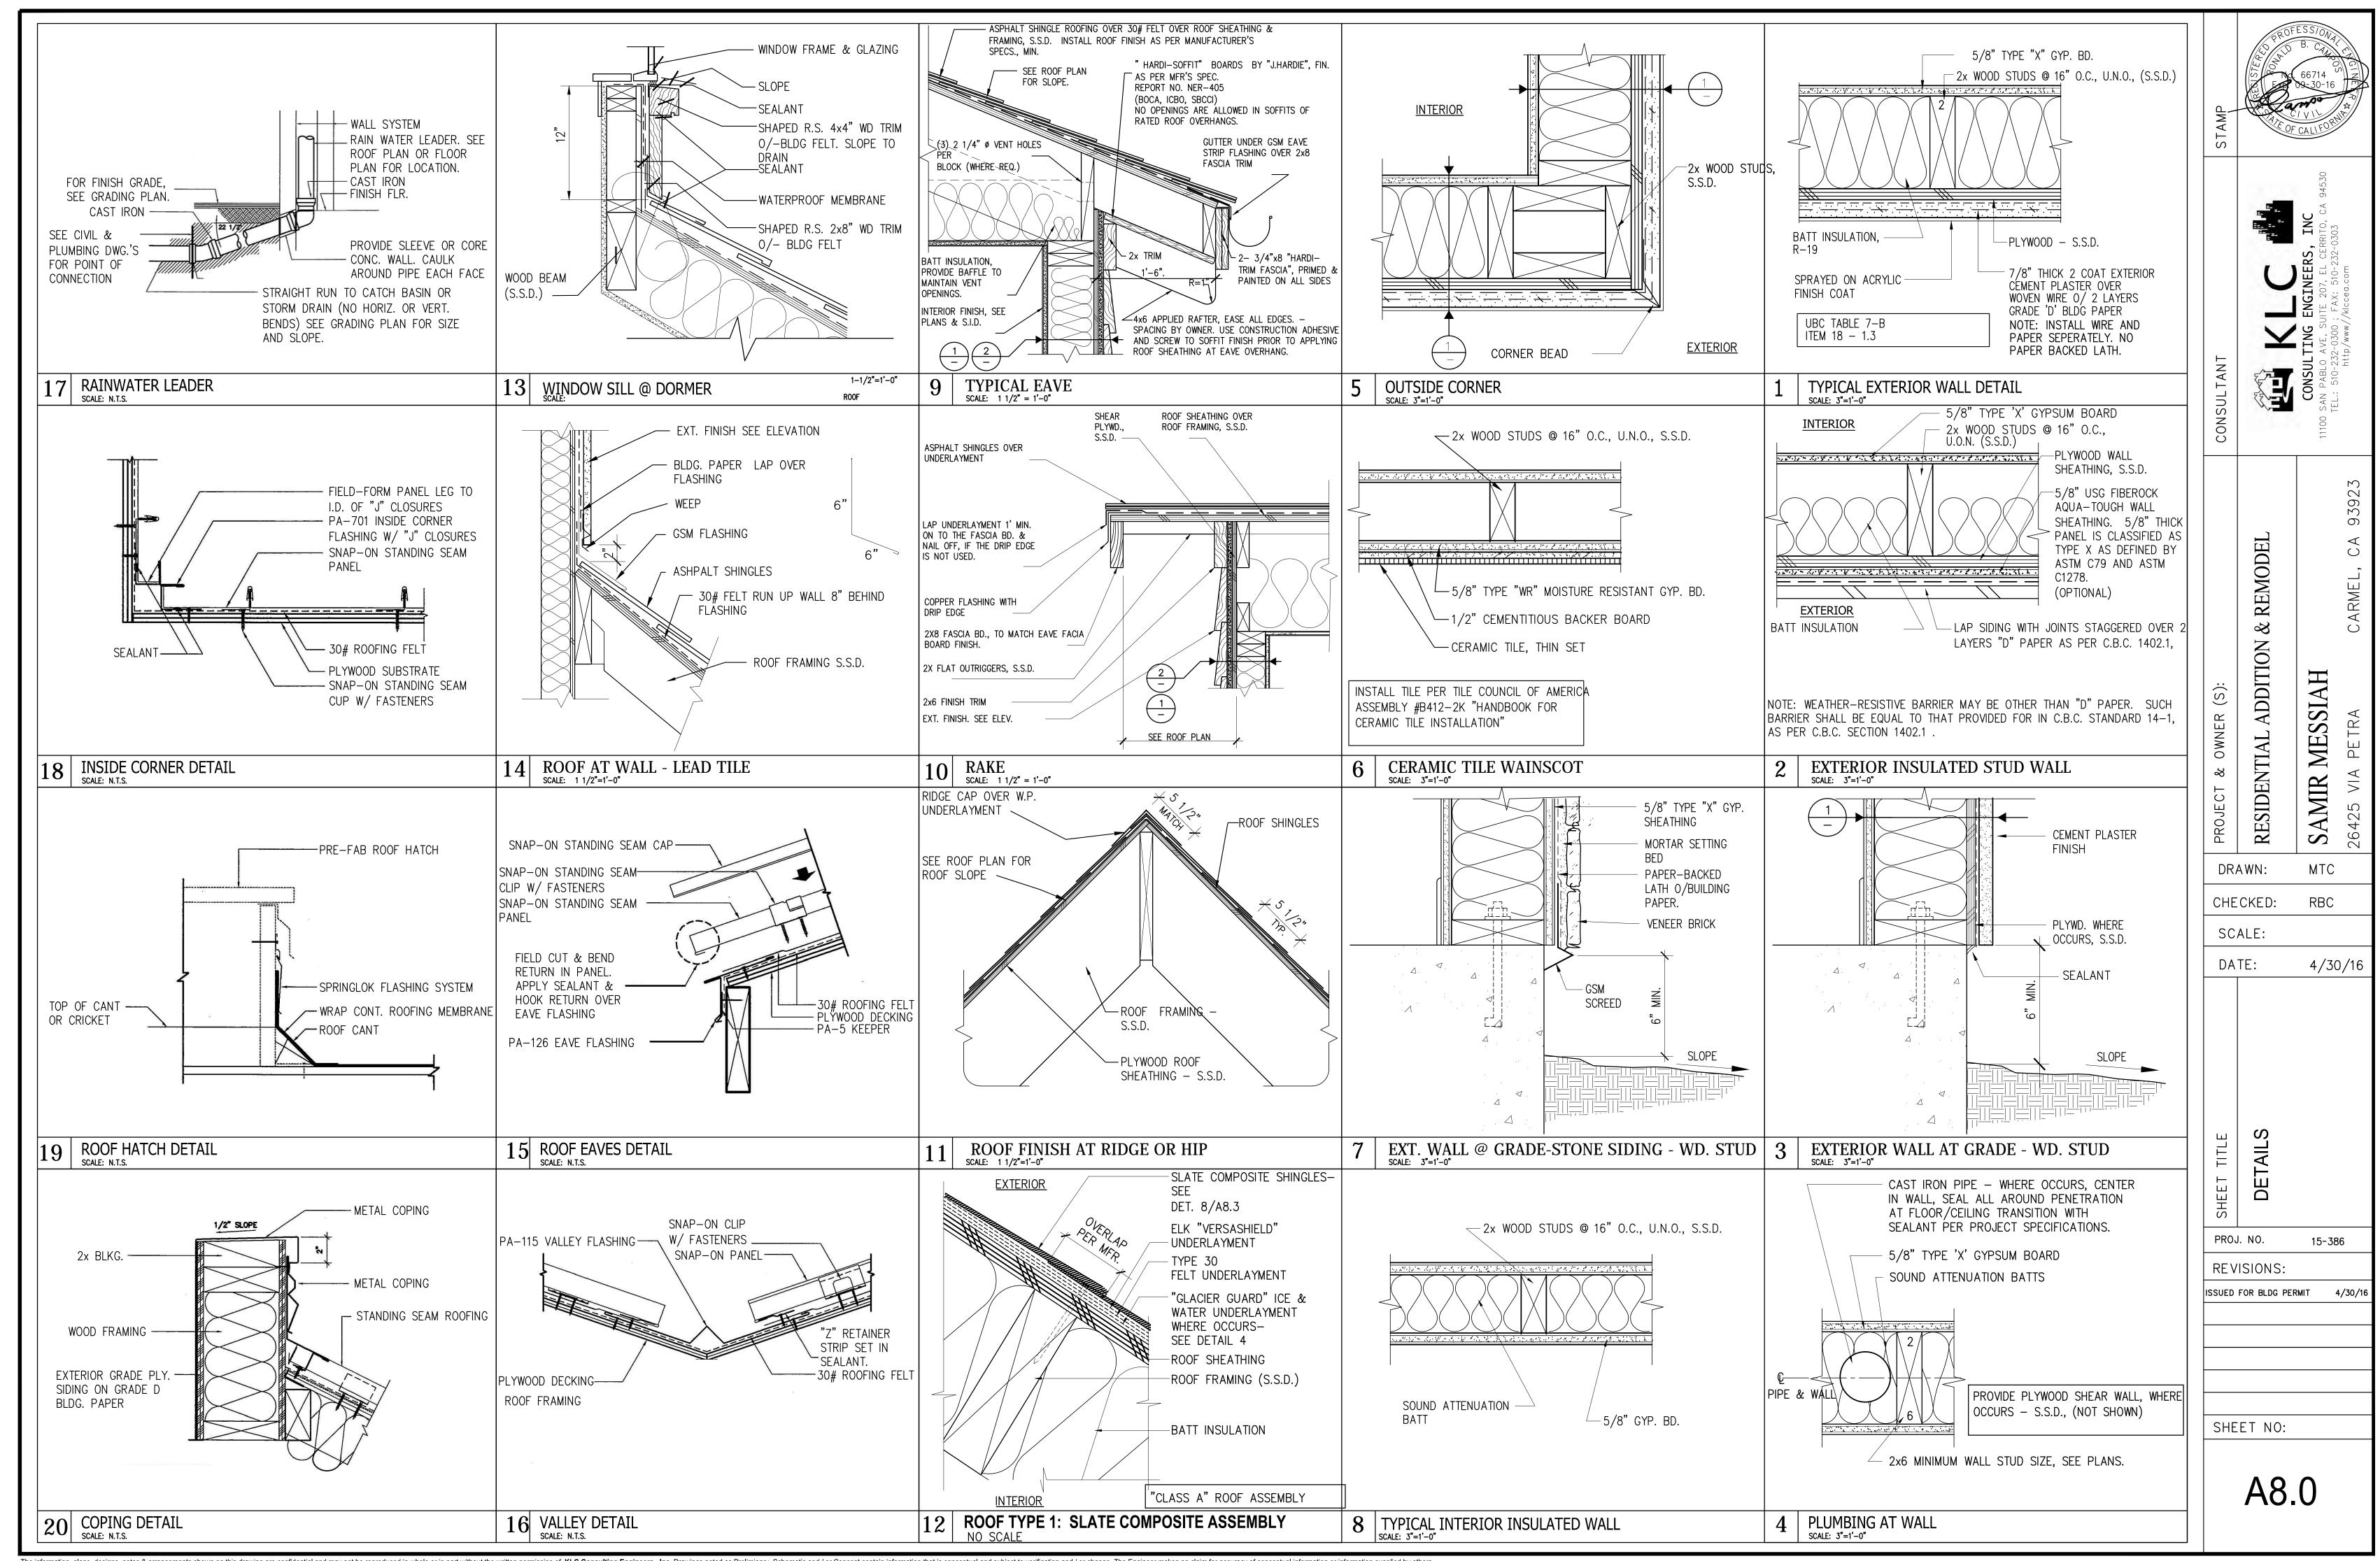

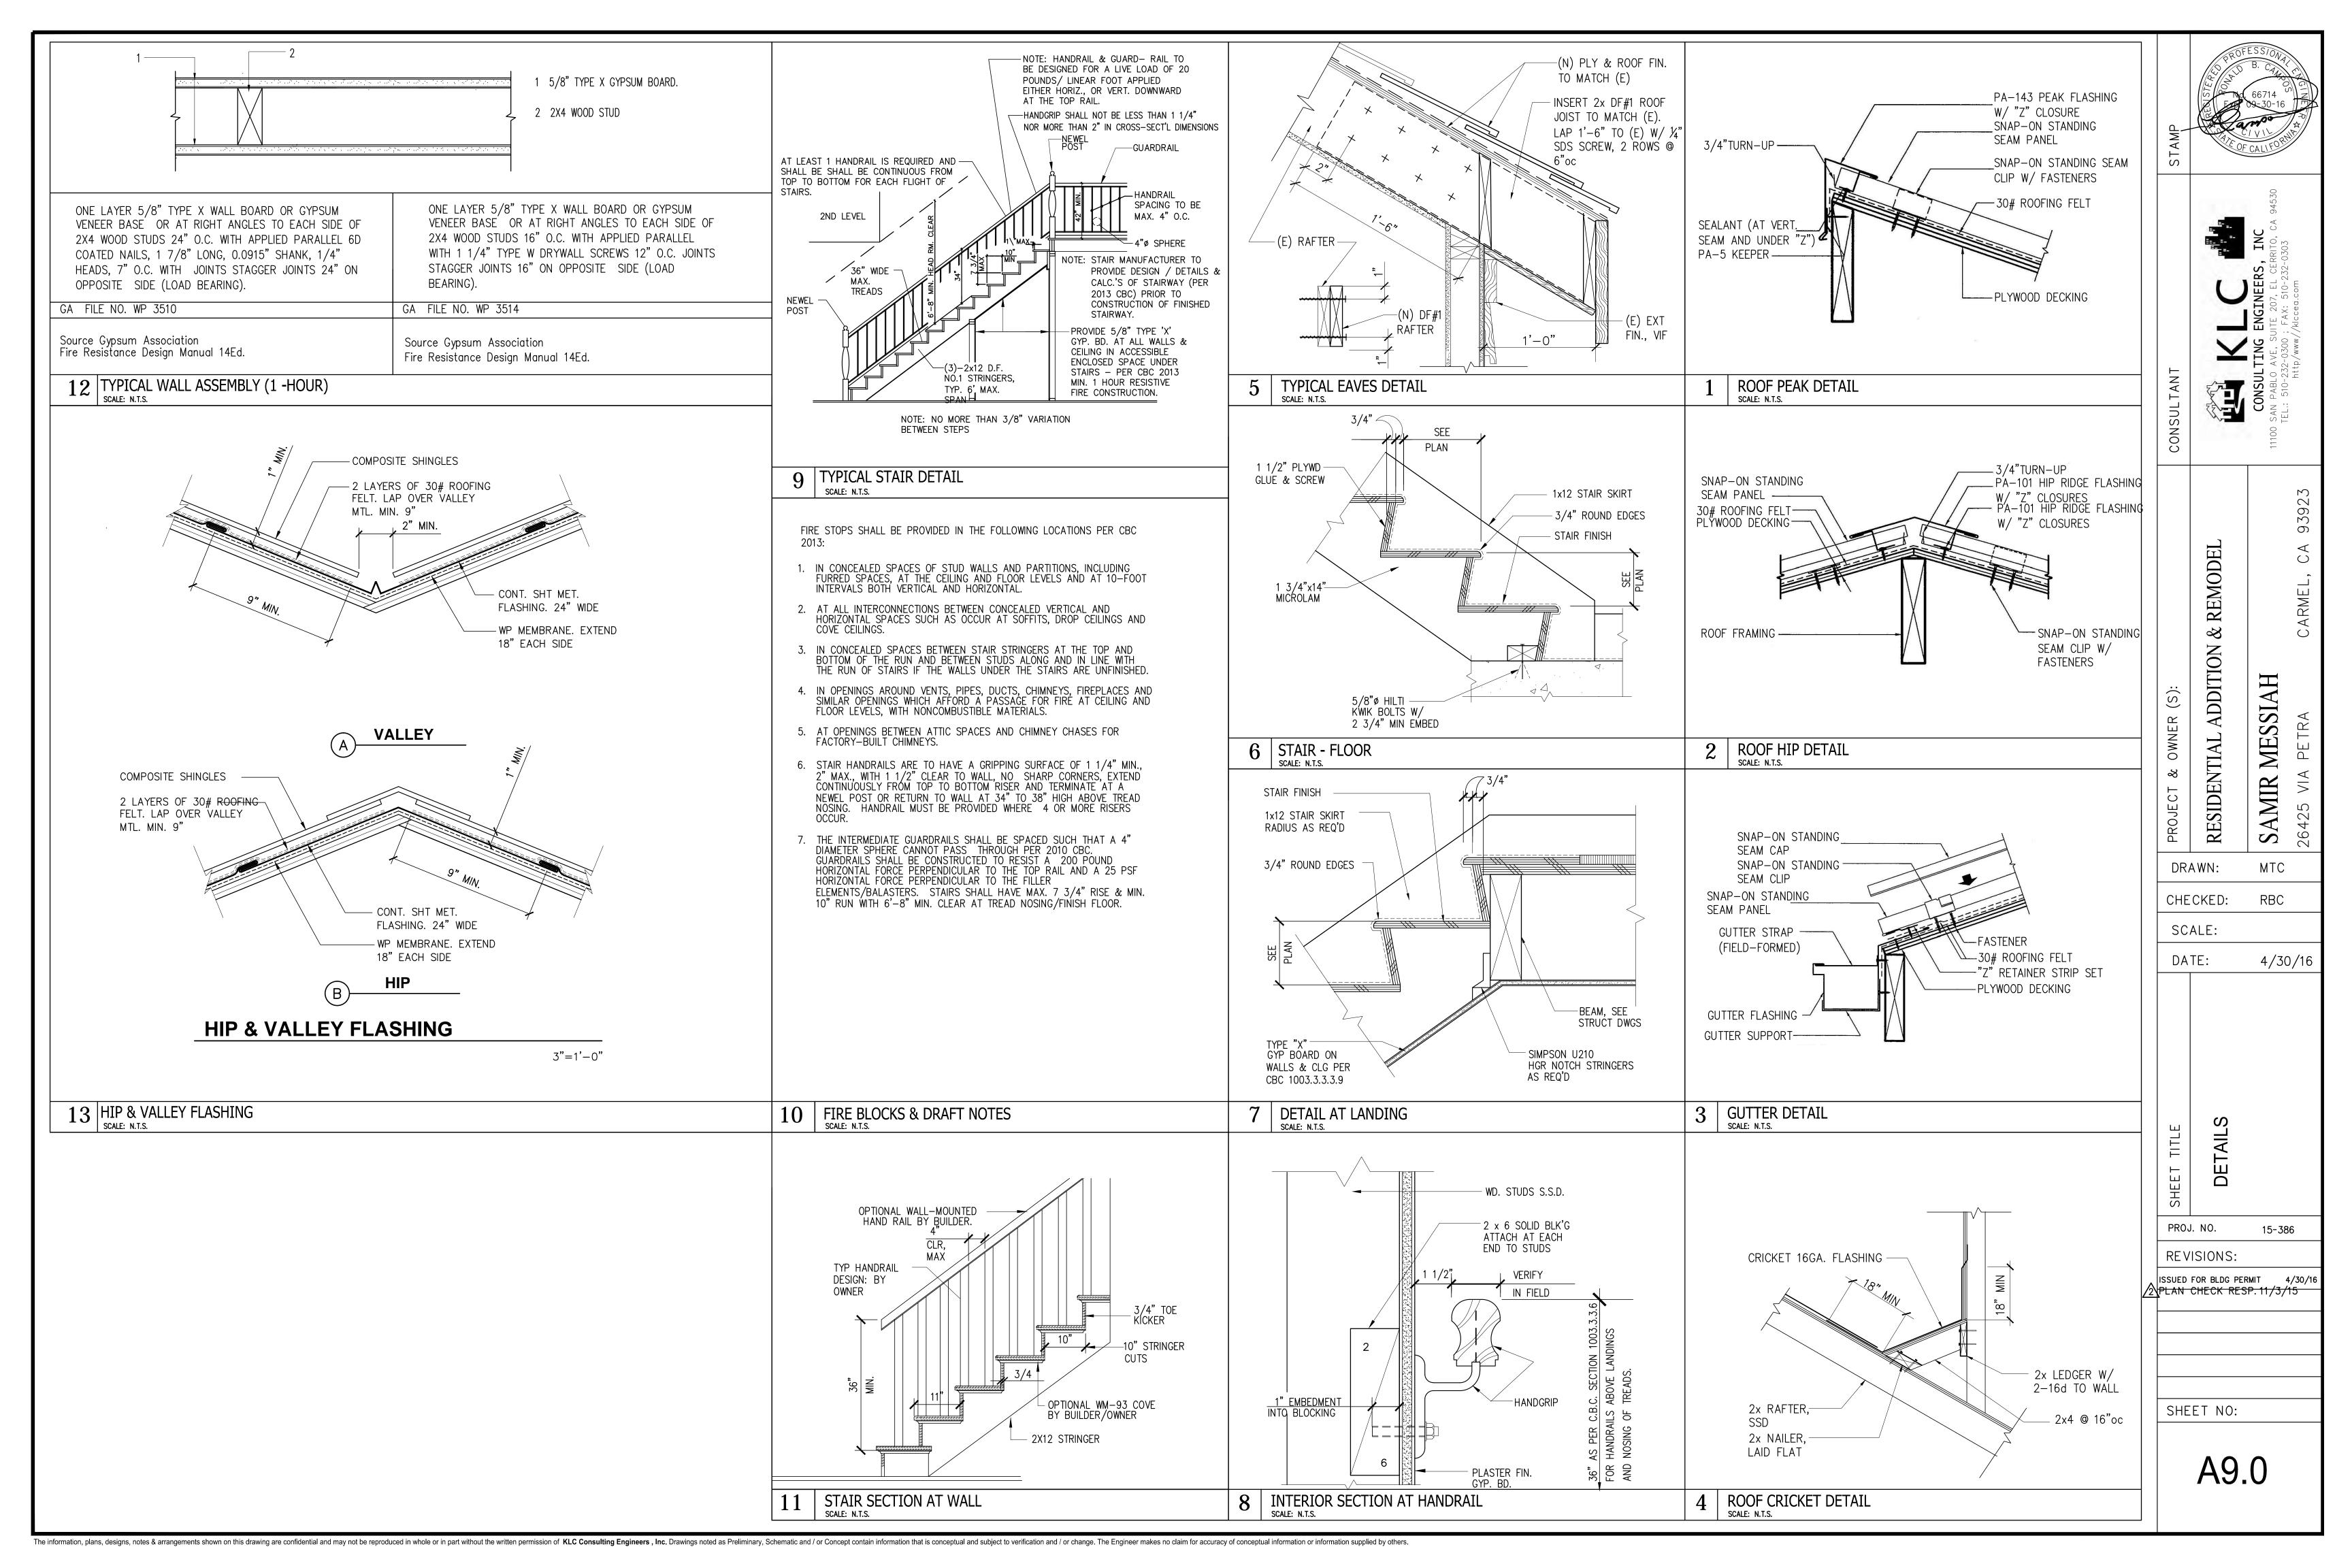

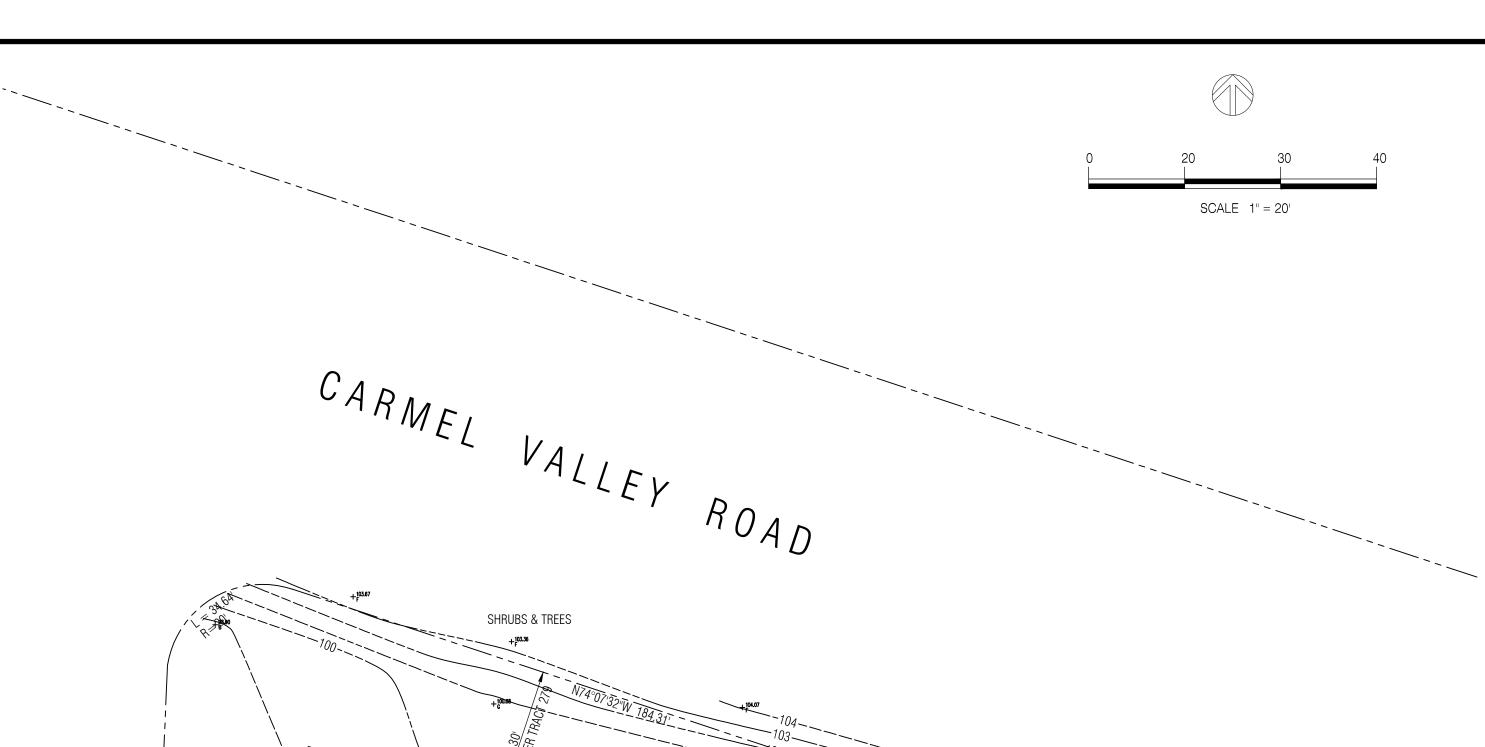

 $\triangleleft$ Ш Д  $\forall$ >

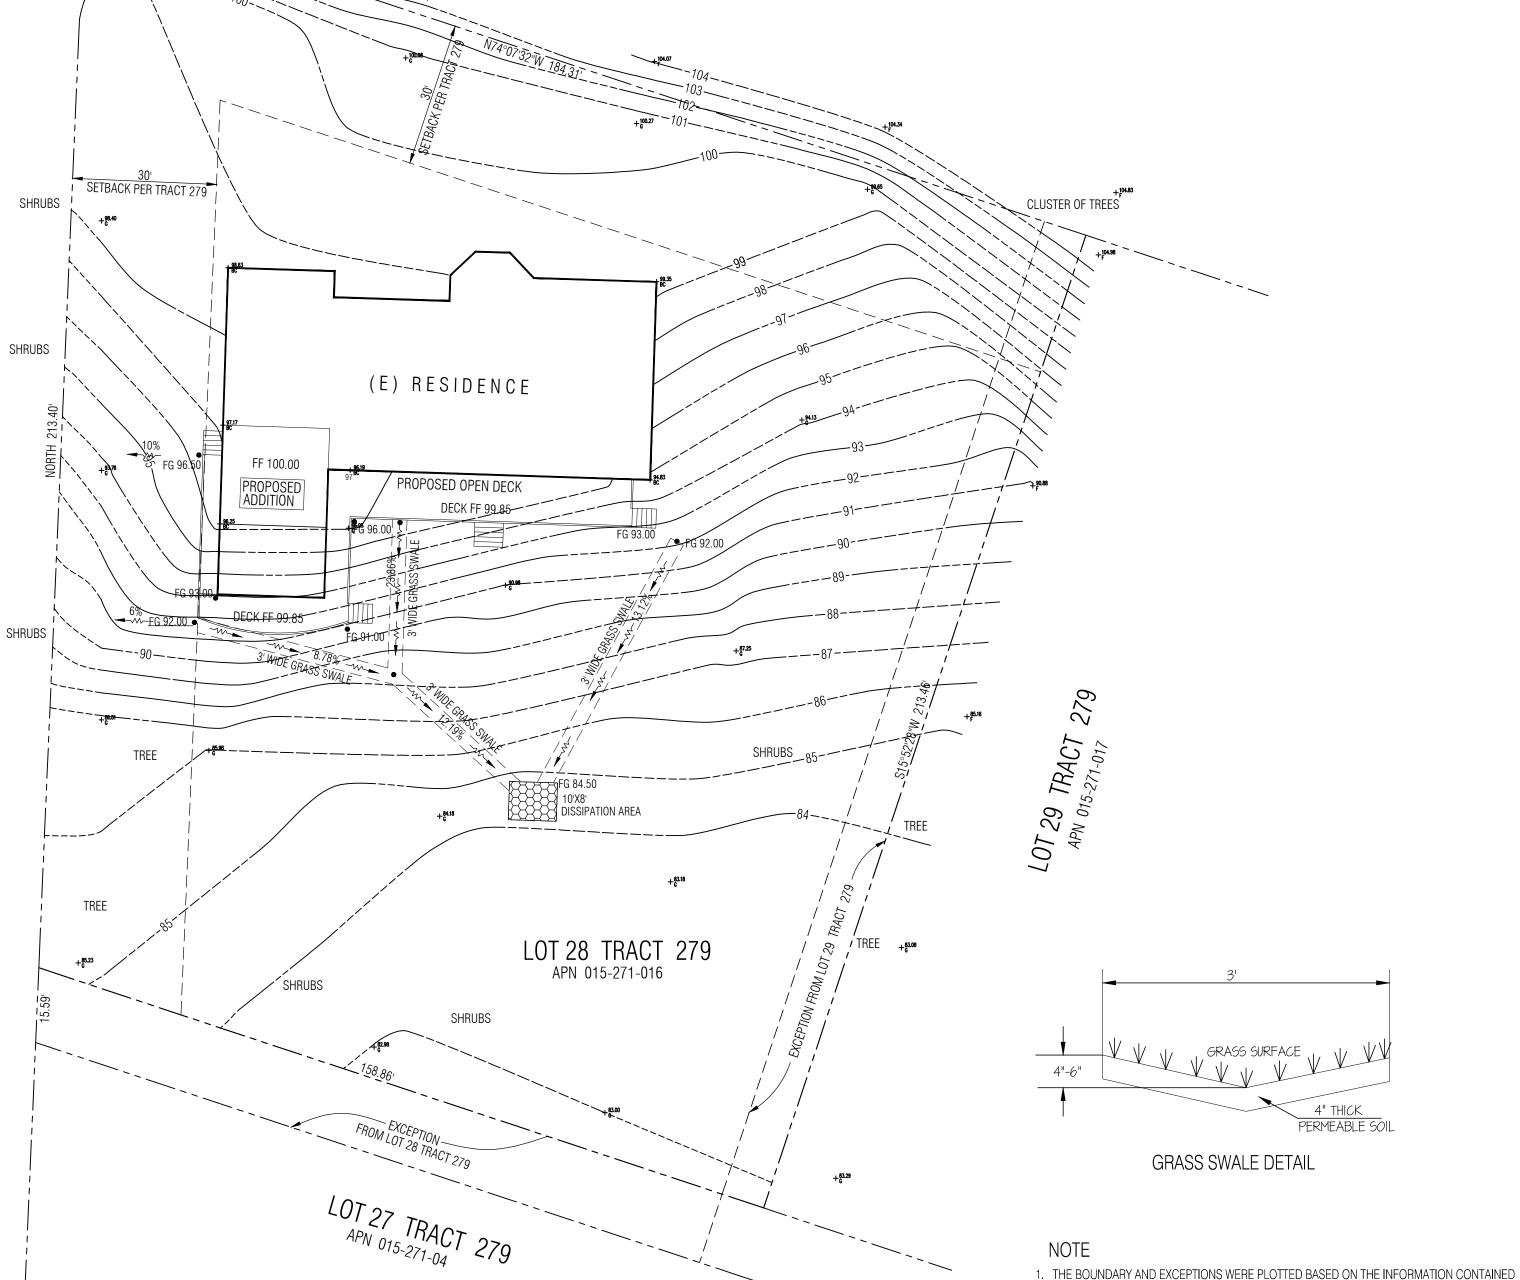

IN THE TITLE REPORT PROVIDED BY THE OWNER.

NO FIELD MEASUREMENT WERE CONDUCTED TO DETERMINE THE LOCATION OF THE PROPERTY

2. THE LOCATION AND DIMENSION OF THE EXISTING BUILDING WERE REFERENCED TO THE

3. THE TOPOGRAPHIC PLAN WAS GENERATED BASED ON FIELD MEASUREMENT OF POINTS

4. THE FINISH FLOOR OF THE (E) HOUSE WAS USED AS REFERENCE DATUM FOR THIS SURVEY.

PROVIDED BY THE OWNER AND DOES NOT GUARANTEE THE HORIZONTAL AND VERTICAL POSITION BASED ON CITY OR COUNTY RECORDED INFORMATION.

TO THE EXISTING FENCE AS MEASURED AND PROVIDED BY THE OWNER.

#### GENERAL GRADING & DRAINAGE NOTES:

- 1. A GRADING PERMIT MAY BE REQUIRED PRIOR TO COMMENCEMENT OF ANY EARTHWORK.
- 2. ALL GRADING SHALL CONFORM TO THE CITY SPECIFICATIONS AND STANDARDS.
- 3. CONTRACTOR WILL BE RESPONSIBLE FOR ADEQUATE TEMPORARY DRAINAGE FACILITIES DURING RAINY SEASON OPERATIONS AND PROTECT ALL GRADING AREAS FROM EROSION.
- 4. THE APPROXIMATE QUANTITY OF CUT= 20 CU. YD AND FILL= 20 CU. YD. THE CONTRACTOR SHALL ALSO BE RESPONSIBLE FOR VERIFICATION OF ABOVE EARTHWORK QUANTITIES PRIOR TO THE START OF THE GRADING OPERATION.
- 5. ADEQUATE PROVISIONS SHALL BE MADE FOR DUST CONTROL.
- 6. ANY DEVIATION FROM APPROVED PLANS DURING CONSTRUCTION WILL REQUIRE APPROVAL BY THE CITY ENGINEER.
- 7. GRADE BREAKS AT TOPS AND TOES OF CUT AND FILL SLOPES SHALL BE ROUNDED TO
- PRESENT A SMOOTH NATURAL APPEARANCE. 8. THE MINIMUM FILL DENSITY COMPACTION WILL BE IN ACCORDANCE WITH ASTM
- 9. THE CONTRACTOR SHALL NOTIFY THE ENGINEER 48 HOURS PRIOR TO THE START OF CONSTRUCTION REQUIRING FIELD STAKING.
- 10. RAIN WATER LEADERS FROM THE ROOF GUTTERS SHALL NOT BE PIPED DIRECTLY TO THE STORM DRAIN SYSTEM. THEY SHALL BE CONNECTED TO AN EARTHEN SWALE AND AREA DRAIN(S) CONNECTED TO THE STORM DRAIN SYSTEM, OR COMPARABLE METHOD TO EFFECTIVELY REDUCE THE ENTRY OF POLLUTANTS INTO THE STORM WATER RUNOFF. PROVIDE SPLASH BLOCKS AT ALL DOWNSPOUTS PER BUILDING CODE.

#### GENERAL NOTES

- AN ENCROACHMENT PERMIT IS REQUIRED FOR CONSTRUCTION IN THE CITY RIGHT OF WAY. THE ENCROACHMENT PERMIT SHALL BE ISSUED CONCURRENT WITH THE BLDG. PERMIT.
- UTILITY WORK IN THE STREET RIGHT OF WAY NOT INSTALLED BY CONTRACTOR WILL REQUIRE A SEPARATE PERMIT BY THE AGENCY PERFORMING SUCH WORK.
- LANDSCAPE FINISHED GRADE WITHIN FIVE FEET OF THE BUILDING OR STRUCTURE SHALL SLOPE AWAY AT A 5% MIN. FROM THE FOUNDATION . ALL EXTERIOR HARD SURFACING AREAS (INCL. TERRACES) SHALL BE INSTALLED WITH A 1% MIN. GRADIENT, AND SHALL DRAIN AWAY FROM THE BUILDING. FINISHED GRADE DRAINAGE SWALES SHALL HAVE A MIN. SLOPE OF 1%. MAXIMUM GRADED SLOPE IS 3:1 (3 HORIZONTAL TO 1 VERTICAL)
- PROVIDE A SPLASH BLOCK AND AT ALL DOWNSPOUTS LOCATIONS EXCEPT WHERE A CONCRETE WALKWAY IS PROPOSED.
- THE APPLICANT NEEDS TO CONTACT THE MONTEREY COUNTY WATER DISTRICT (MCWD), MONTEREY SANITARY DISTRICT (MSD), PG&E, AT&T, COMCAST FOR SPECIFIC UTILITY REQIREMENTS.
- ALL NEW UTILITY CONNECTIONS MUST BE BORED JACKED. OPEN STREET CUTS / TRENCHING WILL NOT BE PERMITTED ACROSS VIA PETRA UNLESS APPROVED BY THE CITY ENGINEER.
- ALL NEW ELECTRICAL, TELEPHONE, AND CABLE TELEVISION SERVICES NEEDS TO BE PROVIDED UNDRGROUND.
- THE CONTRACTOR MUST REPAIR ANY DAMAGE TO THE EXISTING FRONTAGE IMPROVEMENTS CAUSED BY THIS CONSTRUCTION PRIOR TO THE ISSUANCE OF A CERTIFICATE OF OCCUPANCY.

#### EROSION CONTROL NOTES

- 1. EROSION AND SEDIMENT CONTROL MEASURES SHALL BE EFFECTIVE FOR CONSTRUCTION DURING THE RAINY SEASON (OCT 1 TO APRIL 15).
- 2. NO STORM RUNOFF WATER SHALL BE ALLOWED TO DRAIN DIRECTLY INTO THE EXISTING UNDERGROUND STORM SYSTEM BEFORE THE ON-SITE STORM DRAIN SYSTEM IS INSTALLED.
- 3. PERSON RESPONSIBLE FOR IMPLEMENTATION OF THE EROSION AND SEDIMENT CONTROL PLAN: NAME: SAMIR MESSIAH

ADDRESS: 380 EL CAMINITO ROAD, CARMEL VALLEY, CA

- 4. ALL EROSION AND SEDIMENTATION CONTROL MEASURES SHALL BE MAINTAINED UNTIL DISTURBED AREAS ARE STABILIZED AND PERMANENT LANDSCAPE IN PLACE. CHANGES TO EROSION AND SEDIMENTATION CONTROL PLAN SHALL BE MADE TO TO MEET FIELD CONDITION, BUT ONLY WITH THE APPROVAL OF OR AT THE OR AT THE DIRECTION OF THE COUNTY GRADING INSPECTOR.
- 5. DURING THE RAINY SEASON SPECIFIED IN NOTE NO. 1, ALL PAVED AREAS SHALL BE KEPT CLEAR OF EARTH MATERIAL AND DEBRIS. THE SITE SHALL BE MAINTAINED SO AS TO MINIMIZE SEDIMENT LADEN RUNOFF FROM ENTERING ANY STORM DRAINAGE SYSTEM.
- 6. IT SHALL BE THE RESPONSIBILITY OF THE CONTRACTOR TO INSPECT AND REPAIR ALL EROSION CONTROL FACILITIES AT THE END OF EACH WORK DAY DURING THE RAINY SEASON.
- 7. THIS PLAN COVERS ONLY THE FIRST WINTER FOLLOWING GRADING. PLANS ARE TO BE RESUBMITTED FOR CITY APPROVAL PRIOR TO SEPTEMBER 1ST OF EACH SUBSEQUENT YEAR UNTIL THE SITE IMPROVEMENTS ARE ACCEPTED BY THE COUNTY GRADING INSPECTOR.
- 8. THIS PLAN IS INTENDED TO BE USED FOR EROSION CONTROL WORK ONLY. OTHER INFORMATION SHOWN HEREIN MAY NOT BE THE MOST CURRENT. REFER TO GRADING PLAN FOR OTHER INFORMATION.

ODEL	
ION & REMODE	
ITION	H

ME SIDEN MIR

 $\bigcirc$ 

RE S DRAWN: MTC

CHECKED: RBC SCALE: AS NOTED

04/30/15


DATE:

GRADING & DRAINAGE PLA

PROJ. NO. 15-386 REVISIONS:

ISSUED FOR BLDG PERMIT

SHEET NO:

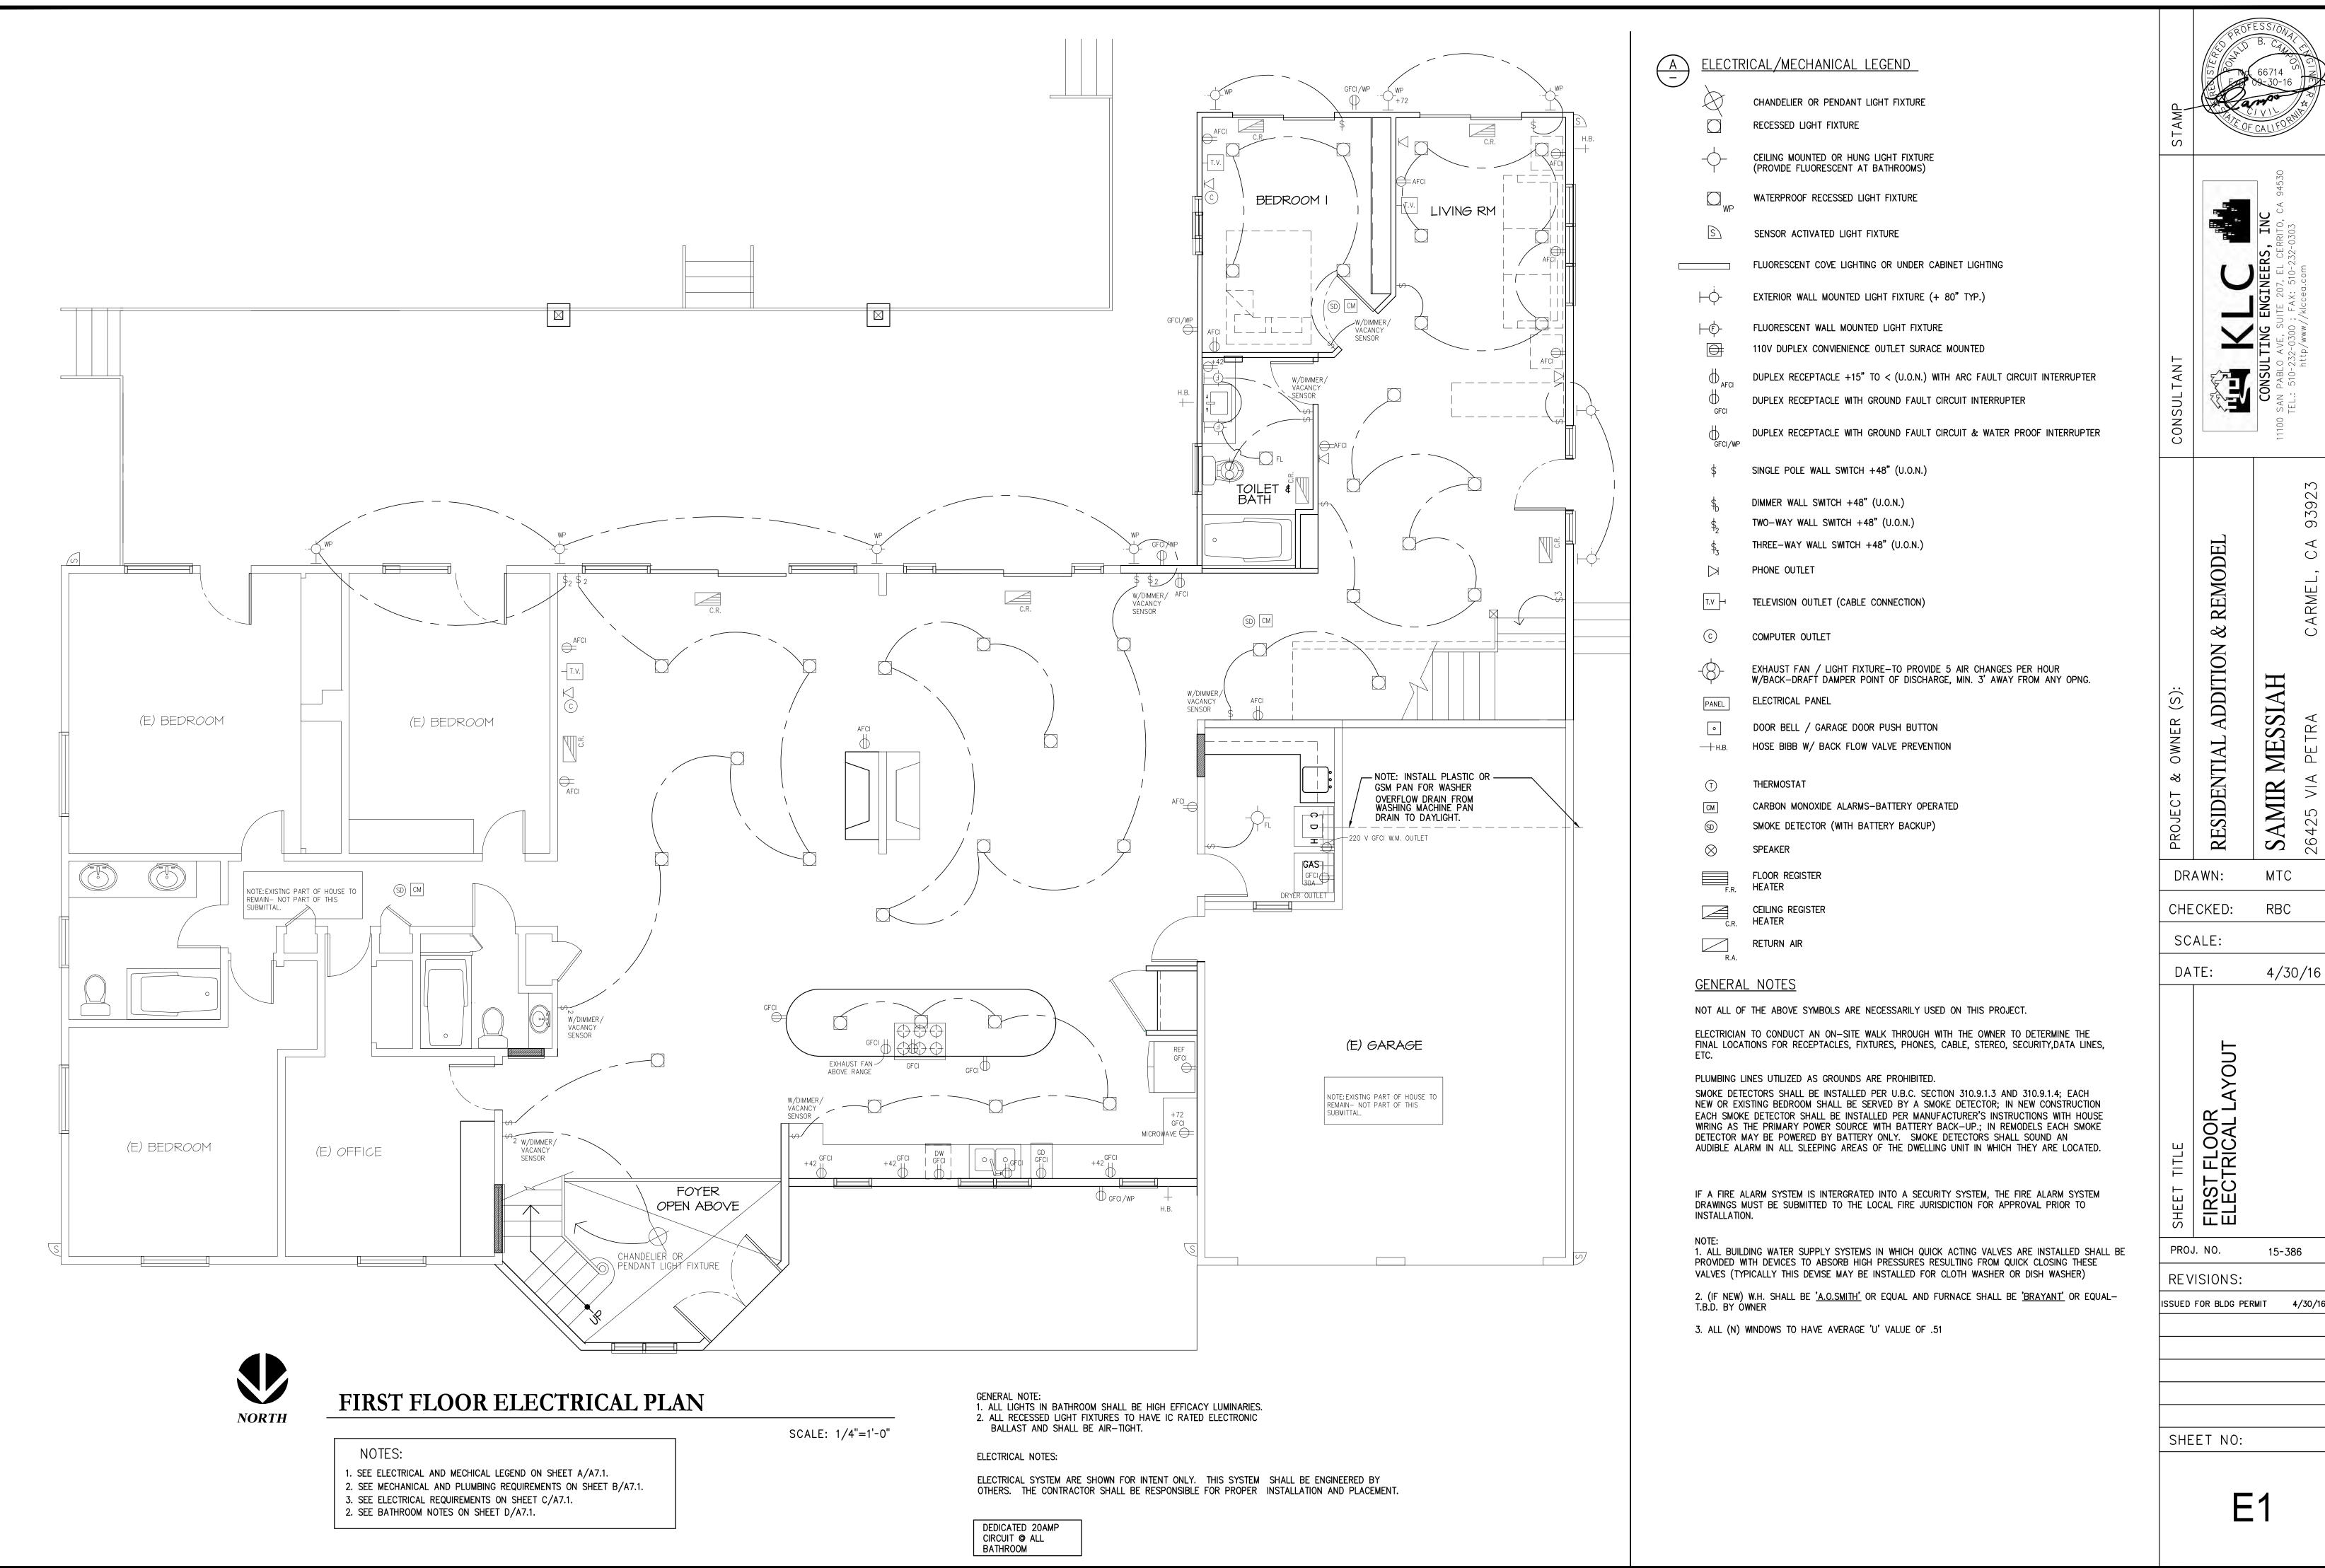

The information, plans, designs, notes & arrangements shown on this drawing are confidential and may not be reproduced in whole or in part without the written permission of **KLC Consulting Engineers**, **Inc.** Drawings noted as Preliminary, Schematic and / or Concept contain information that is conceptual and subject to verification and / or change. The Engineer makes no claim for accuracy of conceptual information or information supplied by others.

# This page intentionally left blank