Exhibit A



EXHIBIT A - DRAFT RESOLUTION

Before the Chief of Planning in and for the County of Monterey, State of California

In the matter of the application of:

SCHERLING JOSHUA BRET & STACEY LAUREN (PLN250029) RESOLUTION NO. 25-049

Resolution by the Monterey County Chief of Planning:

- 1) Finding that the project is Categorically Exempt pursuant to CEQA Guidelines section 15303, and there are no exceptions pursuant to Guidelines section 15300.2; and
- 2) Approving a Coastal Administrative Permit and Design Approval to allow the construction of a 1,463 square foot detached garage with a 777 square foot deck.

[PLN250029, Scherling Joshua Bret & Stacey Lauren, 3150 Don Lane, Pebble Beach, Del Monte Forest Land Use Plan (APN: 008-361-026-000)]

The SCHERLING JOSHUA BRET & STACEY LAUREN application (PLN250029) came on for an administrative hearing before the Monterey of County Chief of Planning on October 1st, 2025. Having considered all the written and documentary evidence, the administrative record, the staff report, oral testimony, and other evidence presented, the County of Monterey Chief of Planning finds and decides as follows:

FINDINGS

1. **FINDING: CONSISTENCY** – The Project, as conditioned, is consistent with the applicable plans and policies which designate this area as appropriate

for development.

EVIDENCE: a) During the course of review of this application, the project has been reviewed for consistency with the text, policies, and regulations in:

- the 1982 Monterey County General Plan;
- Del Monte Forest Land Use Plan (DMF LUP);
- Monterey County Coastal Implementation Plan, Part 5 (DMF CIP): and
- Monterey County Zoning Ordinance (Title 20).

No conflicts were found to exist. No communications were received during the course of review of the project indicating any inconsistencies with the text, policies, and regulations in these documents.

b) Allowed Use. The property is located at 3150 Don Lane, Pebble Beach (Assessor's Parcel Number 008-361-026-000), Del Monte Forest Land Use Plan, Coastal Zone. The parcel is split zoned Resource Conservation with a Design Overlay in the Coastal Zone and Low Density Residential with a maximum Density of 1.5 acres per unit and Design overlay in the Coastal Zone or "RC-D (CZ)|LDR/1.5-D(CZ)". The development is contained within the LDR/1.5-D(CZ) zoning portion of the parcel,

- which allows for the construction non-habitable accessory structures to any principle use as a principally allowed use, subject to a Coastal Administrative Permit. Pursuant to Title 20 section 20.44, the development in the underlying zoning district is also subject to a Design Approval. Therefore, the project is an allowed land use for this site. The project involves the construction of a 1,463 square foot detached garage with a 777 square foot deck that is over 24 inches above grade. Therefore, the development is an allowed use for this site. Grading will involve approximately 540 cubic yards of cut and 3 cubic yards of fill. Therefore, the development is an allowed use for this site.
- Lot Legality. The parcel (Assessor's Parcel Number 008-361-026-000, 1.35 acres, Lot 13) is shown in its current configuration in the 1964 El Pescadero RO Assessor's Map, Book 8, Page 36. Therefore, the County recognizes the subject property as a legal lot of record.
- Design/Neighborhood and Community Character. Pursuant to Title 20, Chapter 20.44, the project site and surrounding area are designated as a Design Control Zoning District ("D" zoning overlay), which is intended to regulate the location, size, configuration, materials, and colors of structures and fences to assure the protection of the public viewshed and neighborhood character. Del Monte Forest Land Use Plan (DMF LUP) Policy 48 indicates that new development within visually prominent settings, as illustrated on the Del Monte Forest Visual Resources Map (Figure 3), shall be sited and designed in such a manner that will not take away the scenic value of the area. Policy 53 is enforced by DMF CIP section 20.147.070.B.3, adding that adequate setbacks and minimal tree removal shall be required, and that architectural design, material, and color be consistent with the nature of the Plan area. According to Figure 3, the subject property is designated as being in the viewshed from Point Lobos; however, the subject property is not seen from Point Lobos and is not visible from a common public viewing area due to intervening vegetation and topography. Residences within the Pebble Beach area are eclectic in architecture, ranging from modern to California-ranch and Spanish-style. The proposed finishes of grey concrete siding, brown metal non-reflected roofing, bronze trim, and wood deck blend with the surrounding environment and are consistent with the surrounding residential neighborhood character. Retained trees will also continue to surround the property and shield the development from any public views. The project, as designed and sited, assures protection of the public viewshed, is consistent with neighborhood character, and assures visual integrity.
- Development Standards and Impervious Coverage. Title 20 section 20.14.060 establishes the site development standards applicable to structures within the LDR zoning district. Pursuant to Title 20 section 20.14.060, the minimum setbacks include a 50-foot front setback, 6-foot front one-half of property; one foot on rear one-half of property, and a one-foot rear setback with a maximum height of 15-feet. As proposed, the accessory dwelling unit will meet the minimum setbacks and height requirements, as it has an over 50-foot front setback, over 6-foot side and rear setback, and a height of 15 feet. County standard condition of approval (Condition No. 4) has been incorporated to ensure the height

of the structure meets this requirement. Additionally, Title 20 section 20.14.060 there is a minimum distance between structures of 50-feet, which is met as the workshop and deck maintains a distance of 80 feet. There is a building site coverage of 15 percent, the addition of the accessory structures will be 10.2 percent. According to Monterey County Geographic Information System (GIS) records identifies the subject property to be within the Area of Drainage of Carmel Area. Pursuant to Del Monte Forest LUP Policy 77, the impervious surface of the proposed development shall not exceed 9,000 square feet of site coverage. As proposed, the development will contain 8,416 square feet of impervious surface. Therefore, the property complies with the required site development standards based on the applicable LDR zoning district.

- f) Cultural Resources. According to Monterey County Geographic Information System (GIS) records identifies the subject property to be within a moderate archaeological sensitivity area and is not within a known or potential archaeological resource area. Therefore, an archaeological report is not required under the DMF CIP section 20.147.080.B.1. There is no evidence that any cultural resources would be disturbed, and the potential for inadvertent impacts to cultural resources is limited. This will be controlled by application of the County's standard project condition (Condition No. 3), which requires the contractor to stop work if previously unidentified resources are discovered during construction.
- g) <u>Public Access</u>. As demonstrated in Finding 6, the development is consistent with public access policies of the DMF LUP.
- h) <u>Land Use Advisory Committee.</u> The project does not involve a public hearing Design Approval, a Lot Line Adjustment in the Coastal Zone, preparation of an Initial Study, or a Variance. Therefore, the project was not referred to the North County Land Use Advisory Committee (LUAC) for review as outlined in the LUAC Guidelines contained in Board Order Resolution No. 15-043.
- The application, project plans, and related support materials submitted by the project applicant to Monterey County HCD-Planning found in Project File PLN250029.
- 2. **FINDING:** SITE SUITABILITY The site is physically suitable for the proposed development and/or use.
 - a) The project has been reviewed for site suitability by the following departments and agencies: HCD-Planning, HCD-Engineering Services, HCD-Environmental Services, Environmental Health Bureau, and Pebble Beach Community Services District. County staff reviewed the application materials and plans to verify that the project on the subject site conforms to the applicable plans and regulations, and there has been no indication from these departments/agencies that the site is not suitable for the development. Conditions recommended have been incorporated.
 - b) No reports have been prepared. County staff independently reviewed these reports and concurs with their conclusions. There are no physical

EVIDENCE:

- or environmental constraints that would indicate that the site is not suitable for the use.
- The application, project plans, and related support materials submitted by the project applicant to Monterey County HCD-Planning found in Project File PLN250029.

3. FINDING:

HEALTH AND SAFETY – The establishment, maintenance, or operation of the project applied for will not under the circumstances of this particular case be detrimental to the health, safety, peace, morals, comfort, and general welfare of persons residing or working in the neighborhood of such proposed use, or be detrimental or injurious to property and improvements in the neighborhood or to the general welfare of the County.

EVIDENCE:

- The project was reviewed by HCD-Planning, HCD- Engineering Services, HCD-Environmental Services, Environmental Health Bureau, and Pebble Beach Community Services District. The respective agencies have recommended conditions, where appropriate, to ensure that the project will not have an adverse effect on the health, safety, and welfare of persons either residing or working in the neighborhood.
- b) All necessary public facilities are available to the subject property. The subject parcel has an existing active connection to Pebble Beach Community Services District (PBCSD) for sewage disposal. The PBCSD wastewater collection and treatment system has adequate remaining capacity for sewage disposal. The subject parcel is located outside of any identified FEMA Flood Zones, floodways, and recharge areas. No graywater/rainwater catchment systems are proposed as part of the project. Potable water will be provided by the California American Water Company. A water entitlement from the Monterey Peninsula Water Management District was included in the application for the subject property for domestic water use.
- The application, project plans, and related support materials submitted by the project applicant to Monterey County HCD-Planning found in Project File PLN250029.

4. FINDING:

NO VIOLATIONS – The subject property is in compliance with all rules and regulations pertaining to zoning uses, subdivision, and any other applicable provisions of the County's zoning ordinance. No violations exist on the property.

EVIDENCE:

- a) Staff reviewed Monterey County HCD-Planning and HCD-Building Services records and is not aware of any violations existing on subject property.
- b) Staff conducted a virtual site inspection and researched County records to assess if any violation exists on the subject property.
- c) The application, project plans, and related support materials submitted by the project applicant to Monterey County HCD-Planning found in Project File PLN250029.

5. FINDING:

CEQA (Exempt) – The project is categorically exempt from environmental review and no unusual circumstances were identified to exist for the proposed project.

EVIDENCE:

- California Environmental Quality Act (CEQA) Guidelines Section 15303 categorically exempts new construction including accessory structures.
- b) This project qualifies for a Class 3 exemption as it consists of construction of a new accessory structure including a workshop and deck on a residentially zoned lot.
- c) None of the exceptions under CEQA Guidelines Section 15300.2 apply to this project. There is no significant effect on the environment due to unusual circumstances. There is no cumulative impact without any prior successive projects of the same type in the same place, over time and no new land use is proposed. The site is not included on any list compiled pursuant to Section 65962.5 of the Government Code to be considered on a hazardous waste site.
- d) No adverse environmental effects were identified during staff review of the development application.
- e) See supporting Finding Nos. 1 and 2. The application, project plans, and related support materials submitted by the project applicant to Monterey County HCD-Planning found in Project File PLN250029.

6. FINDING:

PUBLIC ACCESS – The project is in conformance with the public access and recreation policies of the Coastal Act (specifically Chapter 3 of the Coastal Act of 1976, commencing with Section 30200 of the Public Resources Code) and applicable Local Coastal Program, and does not interfere with any form of historic public use or trust rights.

EVIDENCE: a)

- a) No public access is required as part of the project as no substantial adverse impact on access, either individually or cumulatively, as described in NC CIP Section 20.144.150 of the Monterey County Coastal Implementation Plan can be demonstrated.
- b) No evidence or documentation has been submitted or found showing the existence of historic public use or trust rights over this property.
- c) The subject property is not described as an area where the Local Coastal Program requires visual or physical public access (Figure 6, North County General Plan Shoreline Access/Trails, in the NC LUP).
- d) The application, project plans, and related support materials submitted by the project applicant to Monterey County HCD-Planning found in Project File PLN250029.

7. FINDING:

APPEALABILITY – The decision on this project may be appealed to the Board of Supervisors.

EVIDENCE:

- a) Board of Supervisors. Pursuant to Title 20, Section 20.86.030, an appeal may be made to the Board of Supervisors by any public agency or person aggrieved by a decision of an Appropriate Authority other than the Board of Supervisors.
- b) Coastal Commission. This project is not appealable through the Coastal Commission as it is not fit the coastal permit descriptions described in 20.86.080.A.

DECISION

NOW, THEREFORE, based on the above findings and evidence, the Chief of Planning does hereby:

- 1. Find the project qualifies for a Class 3 Categorical Exemption pursuant to CEQA Guidelines section 15303, and that none of the exceptions pursuant to section 15300.2; and
- 2. Approve a Coastal Administrative Permit and Design Approval to allow the construction of a 1,463 square foot detached garage with a 777 square foot deck.

All of which are in general conformance with the attached sketch and subject to the attached conditions, all being attached hereto and incorporated herein by reference.

PASSED AND ADOPTED this 1st day of October 2025.

Fionna Jensen, AICP
HCD Chief of Planning

COPY OF THIS DECISION MAILED TO APPLICANT ON DATE

THIS APPLICATION IS APPEALABLE TO THE BOARD OF SUPERVISORS. IF ANYONE WISHES TO APPEAL THIS DECISION, AN APPEAL FORM MUST BE COMPLETED AND SUBMITTED TO THE CLERK TO THE BOARD ALONG WITH THE APPROPRIATE FILING FEE ON OR BEFORE

THIS PROJECT IS LOCATED IN THE COASTAL ZONE AND IS APPEALABLE TO THE COASTAL COMMISSION. UPON RECEIPT OF NOTIFICATION OF THE FINAL LOCAL ACTION NOTICE (FLAN) STATING THE DECISION BY THE FINAL DECISION-MAKING BODY, THE COMMISSION ESTABLISHES A 10 WORKING DAY APPEAL PERIOD. AN APPEAL FORM MUST BE FILED WITH THE COASTAL COMMISSION. FOR FURTHER INFORMATION, CONTACT THE COASTAL COMMISSION AT (831) 427-4863 OR AT 725 FRONT STREET, SUITE 300, SANTA CRUZ, CA.

This decision, if this is the final administrative decision, is subject to judicial review pursuant to California Code of Civil Procedure Sections 1094.5 and 1094.6. Any Petition for Writ of Mandate must be filed with the Court no later than the 90th day following the date on which this decision becomes final.

NOTES

1. You will need a building permit and must comply with the Monterey County Building Ordinance in every respect.

Additionally, the Zoning Ordinance provides that no building permit shall be issued, nor any use conducted, otherwise than in accordance with the conditions and terms of the permit granted or until ten days after the mailing of notice of the granting of the permit by the appropriate authority, or after granting of the permit by the Board of Supervisors in the event of appeal.

Do not start any construction or occupy any building until you have obtained the necessary permits and use clearances from Monterey County HCD-Planning and HCD-Building Services Department office in Salinas.

2.	This permit expires 3 years after the above date of granting thereof unless construction or use is started within this period.

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County of Monterey HCD Planning

DRAFT Conditions of Approval/Implementation Plan/Mitigation Monitoring and Reporting Plan

PLN250029

1. PD001 - SPECIFIC USES ONLY

Responsible Department:

Planning

Condition/Mitigation Monitoring Measure: This Coastal Development Permit and Design Approval (PLN250029) allows the construction of a 1,463 square foot detached garage with a 777 square foot deck. The property is located at 3150 Don Lane (Assessor's Parcel Number 008-361-026-000), Del Monte Forest Land Use Plan, Coastal Zone. This permit was approved in accordance with County ordinances and land use regulations subject to the terms and conditions described in the project file. Neither the uses nor the construction allowed by this permit shall commence unless and until all of the conditions of this permit are met to the satisfaction of the Director of HCD - Planning. Any use or construction not in substantial conformance with the terms and conditions of this permit is a violation of County regulations and may result in modification or revocation of this permit and subsequent legal action. No use or construction other than that specified by this permit is allowed unless additional permits are approved by the appropriate authorities. To the extent that the County has delegated any condition compliance or mitigation monitoring to the Monterey County Water Resources Agency, the Water Resources Agency shall provide all information requested by the County and the County shall bear ultimate responsibility to ensure that conditions and mitigation measures are properly fulfilled. (HCD - Planning)

Compliance or Monitoring Action to be Performed:

The Owner/Applicant shall adhere to conditions and uses specified in the permit on an on-going basis unless otherwise stated.

2. PD002 - NOTICE PERMIT APPROVAL

Responsible Department:

Planning

Condition/Mitigation Monitoring Measure: The applicant shall record a Permit Approval Notice. This notice shall state:

"A Coastal Development Permit and Design Approval (Resolution Number ______) was approved by the Chief of Planning for Assessor's Parcel Number 008-361-026-000 on October 1, 2025. The permit was granted subject to 4 conditions of approval which run with the land. A copy of the permit is on file with Monterey County HCD - Planning."

Proof of recordation of this notice shall be furnished to the Director of HCD - Planning prior to issuance of grading and building permits, Certificates of Compliance, or commencement of use, whichever occurs first and as applicable. (HCD - Planning)

Compliance or Monitoring Action to be Performed:

Prior to the issuance of grading and building permits, certificates of compliance, or commencement of use, whichever occurs first and as applicable, the Owner/Applicant shall provide proof of recordation of this notice to the HCD - Planning.

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3. PD003(A) - CULTURAL RESOURCES NEGATIVE ARCHAEOLOGICAL REPORT

Responsible Department:

Planning

Condition/Mitigation Monitoring Measure:

during course of construction, cultural, archaeological, paleontological resources are uncovered at the site (surface or subsurface resources) work shall be halted immediately within 50 meters (165 feet) of the find until a qualified professional archaeologist can evaluate it. Monterey County HCD - Planning and a archaeologist (i.e., archaeologist registered the Register qualified an with immediately Professional Archaeologists) shall be contacted by the responsible individual present on-site. When contacted, the project planner and the archaeologist shall immediately visit the site to determine the extent of the resources and to develop proper mitigation measures required for recovery. (HCD - Planning)

Compliance or Monitoring Action to be

Performed:

The Owner/Applicant shall adhere to this condition on an on-going basis.

Prior to the issuance of grading or building permits and/or prior to the recordation of the final/parcel map, whichever occurs first, the Owner/Applicant shall include requirements of this condition as a note on all grading and building plans. The note shall state "Stop work within 50 meters (165 feet) of uncovered resource and contact Monterey County HCD - Planning and a qualified archaeologist immediately if cultural, archaeological, historical or paleontological resources are uncovered."

When contacted, the project planner and the archaeologist shall immediately visit the site to determine the extent of the resources and to develop proper mitigation measures required for the discovery.

4. PD041 - HEIGHT VERIFICATION

Responsible Department:

Planning

Condition/Mitigation Monitoring Measure:

The applicant shall have a benchmark placed upon the property and identify the benchmark on the building plans. The benchmark shall remain visible on-site until final building inspection. The applicant shall provide evidence from a licensed civil engineer or surveyor to the Director of HCD - Building Services for review and approval, that the height of the structure(s) from the benchmark is consistent with what was approved on the building permit associated with this project. (HCD - Planning and HCD - Building Services)

Compliance or Monitoring Action to be Performed:

Prior to the issuance of grading or building permits, the Owner/Applicant shall have a benchmark placed upon the property and identify the benchmark on the building plans. The benchmark shall remain visible onsite until final building inspection.

Prior to the foundation pre-pour inspection, the Owner/Applicant shall provide evidence from a licensed civil engineer or surveyor, to the Director of HCD - Building Services for review and approval, that the height of first finished floor from the benchmark is consistent with what was approved on the building permit.

Prior to the final inspection, the Owner/Applicant/Engineer shall provide evidence from a licensed civil engineer or surveyor, to the Director of HCD - Building Services for review and approval, that the height of the structure(s) from the benchmark is consistent with what was approved on the building permit.

PLN250029

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GENERAL NOTES

ALL WORK SHALL BE DONE IN ACCORDANCE WITH APPLICABLE CODE AND ORDINANCE REQUIREMENTS SET FORTH BY THE PREVAILING GOVERNING BODY.

THIS PROJECT SHALL COMPLY WITH CALIFORNIA CODE OF REGULATIONS TITLE 24, BUILDING STANDARD CODE, 2022 EDITION:

CRC - CALIFORNIA RESIDENTIAL CODE, PART 2.5 CBC - CALIFORNIA BUILDING CODE, PART 2, VOL. 1 \$ 2 CEC - CALIFORNIA ELECTRICAL CODE, PART 3 CMC - CALIFORNIA MECHANICAL CODE, PART 4 CPC - CALIFORNIA PLUMBING CODE, PART 5

CENC - CALIFORNIA ENERGY CODE, PART 6 CFC - CALIFORNIA FIRE CODE, PART 9 CEBC - CALIFORNIA EXISTING BUILDING CODE, PART 10

CALGREEN - CALIFORNIA GREEN BUILDING REQUIREMENTS, PART 11

DURING THE COURSE OF CONSTRUCTION, THE PREVAILING BEST MANAGEMENT PRACTICE (BMP'S) SHALL BE OBSERVED.

THESE DRAWINGS ARE PREPARED FOR USE BY A PROPERLY LICENSED AND CERTIFIED CONTRACTOR.

ALL WRITTEN DIMENSIONS SHALL SUPERCEDE SCALED DIMENSIONS.

EXISTING CONDITIONS ARE SHOWN. CONTRACTOR SHALL VERIFY ALL DIMENSIONS, ELEVATIONS, MATERIALS, AND CONDITIONS PRIOR TO STARTING CONSTRUCTION.

CONTRACTOR SHALL VERIFY ALL DIMENSIONS, ELEVATIONS, MATERIALS, AND CONDITIONS PRIOR TO STARTING CONSTRUCTION AND REPORT ANY DISCREPANCIES TO THE DESIGNER OR OWNER PRIOR TO ORDERING MATERIALS.

CONTRACTOR IS RESPONSIBLE FOR COMPLETE FINAL DISPOSAL OF ALL CONSTRUCTION DEBRIS IN A MANNER CONSISTENT WITH ALL APPLICABLE FEDERAL, STATE AND LOCAL

CONTRACTOR TO PROTECT EXISTING CONDITIONS FROM DAMAGE, DUST, AND DEBRIS. MATERIALS PLANNED TO BE REUSED ARE TO BE PROTECTED FROM DAMAGE THROUGHOUT THE DEMOLITION PROCESS.

ADDRESS IDENTIFICATION:

PRIOR TO CONSTRUCTION, A LEGIBLE ADDRESS IDENTIFICATION SHALL BE PLACED IN A POSITION THAT IS VISIBLE FROM THE STREET OR ROAD FRONTING PROPERTY. ADDRESS IDENTIFICATION CHARACTERS SHALL CONTRAST WITH THEIR BACKGROUND. ADDRESS NUMBERS SHALL BE ALL ARABIC NUMBERS OR ALPHABETIC LETTERS. NUMBERS SHALL NOT BE SPELLED OUT. EACH CHARACTER SHALL NOT BE LESS THAN 4 INCHES IN HEIGHT WITH A STROKE WIDTH OF NOT LESS THAN 0.5 INCH. WHERE REQUIRED BY THE FIRE CODE OFFICIAL, ADDRESS IDENTIFICATION SHALL BE PROVIDED IN ADDITIONAL APPROVED LOCATIONS TO FACILITATE EMERGENCY RESPONSE. WHERE ACCESS IS BY MEANS OF PRIVATE ROAD AD THE BUILDING ADDRESS CANNOT BE VIEWED FROM THE PUBLIC WAY, A MONUMENT, POLE, OR OTHER SIGN OR MEANS SHALL BE USED TO IDENTIFY THE STRUCTURE. ADDRESS IDENTIFICATION SHALL BE MAINTAINED.

DISCOVERY OF PREHISTORIC OR ARCHAEOLOGICAL RESOURCES: SHOULD CONCENTRATIONS OF ARCHAEOLOGICAL OR PALEONTOLOGICAL MATERIALS BE ENCOUNTERED DURING CONSTRUCTION OR GRADING OPERATIONS, ALL GROUND-DISTURBING WORK SHALL BE TEMPORARILY HALTED ON THE SITE AND MONTEREY COUNTY HOUSING \$ COMMUNITY DEVELOPMENT SHALL BE NOTIFIED. WORK NEAR THE ARCHAEOLOGICAL FINDS SHALL NOT BE RESUMED UNTIL A QUALIFIED ARCHAEOLOGIST HAS EVALUATED THE MATERIALS AND OFFERED RECOMMENDATIONS FOR FURTHER ACTION.

IMMEDIATE AREA AND COUNTY CORONER SHALL BE CONTACTED IMMEDIATELY. SHOULD THE CORNER DETERMINE THAT HE REMAINS ARE LIKELY THOSE OF A NATIVE AMERICAN THE CALIFORNIA NATIVE AMERICAN HERITAGE COMMISSION MUST BE CONTACTED WITHIN 24 HOURS OF IDENTIFICATION AND SHALL DETERMINE THE APPROPRIATE TREATMENT OF THE REMAINS.

ABBREVIATIONS

A.B.	ANCHOR BOLT	GA.	GAUGE	R.A.	RETURN AIR
ABV.	ABOYE	G.A.	GALYANIZED ALUMINUM	RAD.	RADIUS
A.C.	ASPHALTIC CONCRETE	G.I.	GALVANIZED IRON	RD.	ROUND
A/C	AIR CONDITIONING	GFI	GROUND FAULT INTERRUPTER	REC.	RECESSED
ALUM.	ALUMINUM	GL OR GLS	GLASS	REF.	REFRIGERATOR
APPROX.	APPROXIMATE	GM GLO	GAS METER	REINF.	REINFORCED/ING
ARCH.	ARCHITECTURAL	GND.	GROUND	RES.	RESILIENT
ANOD.	ANODIZED	GYP. BD.	GYPSUM BOARD	RM.	ROOM
ASPH.	ASPHALT	G11 . DD.	an san boars	R.O.	ROUGH OPENING
AWN.	AWNING	H.C.	HOLLOW CORE	REQ.	REQUIRED
AWN.	AWNING	H.D.	HOLD DOWN	R.O.W.	RIGHT OF WAY
BA.	BATIL	HDR.	HEADER	RWD.	REDWOOD
BD.	BATH BOARD	HWD.	HARDWOOD	R.W.L.	RAINWATER LEADER
BLDG.	BUILDING	HORIZ.	HORIZONTAL	N.W.L.	RAINWATER LEADER
BLKG.	BLOCKING	HR.	HOUR	SCHED.	SCHEDULE
BLW.	BELOW	H.B.	HOSE BIBB	9.C.	SOLID CORE
BM.	BEAM	HT.	HEIGHT	SECT.	SECTION
BOTT.	BOTTOM	HC.	HANDICAP	9.F.	SQUARE FOOT/FEET
BR.	BEDROOM				
DK.	BEDROOM	HYAC	HEATING VENTILATION \$	9Q. FT.	SQUARE FOOT/FEET
CAB.	CABINET	1.101	AIR CONDITIONING	SH	SINGLE HUNG
CEM.	CEMENT	HW	HOT WATER	SHT.	SHEET
CET.	CERAMIC TILE	. D	INCIDE DIAMETER	SHWR.	SHOWER
C.1.	CAST IRON	I.D.	INSIDE DIAMETER	SIM.	SIMILAR
CLR.	CLEAR	INS.	INSULATION	SLD	SUDER
CLR. CLST.	CLOSET	INT.	INTERIOR	SLD. GL. DR.	SLIDING GLASS DOOR
COMP.	COMPOSITION	150	IIIICTION BOX	SLD. GLS. DR.	SLIDING GLASS DOOR
CONC.	CONCRETE	J.B.	JUNCTION BOX	5 \$ P	SHELF \$ POLE
CLG.	CEILING	JST.	JOIST	SPECS.	SPECIFICATIONS
C.M.U.	CONCRETE MASONRY UNIT	KIT.	KITCHEN	SQ.	SQUARE
	CLEAN OUT	KP		SF OR SQ.FT.	SQUARE FEET
C. <i>O</i> . COL.	COLUMN	K5	KICKER POST	STD.	STANDARD
COL.		K5	KING STUD	STL.	STEEL
CONN. CONST.	CONNECTION CONSTRUCTION	LAU	LAUNDON	STOR.	STORAGE
CONST.	CASEMENT	LAU. LAV	LAUNDRY LAVAT <i>O</i> RIES	STRUCT.	STRUCTURAL
C.W.	COLD WATER			9.9.L.	SEE STRUCTURAL DRAWINGS
C.W.	COLD WATER	L.F.	LINEAR FOOT/FEET	99	STAINLESS STEEL
CSMT.	DOUBLE	LIN.	LINEN	SYM.	SYMMETRICAL
DET.	DETAIL	LT.	LIGHT		
DET. DF.	DOUGLAS FIR			TB	TOWEL BAR
DIA. OR Ø		₩ 4+	MATERIAL	TEL.	TELEPHONE
DIM.	DIAMETER DIMENSION	MAT.	MATERIAL	TEMP.	TEMPERED
D.S.	DOWNSPOUT	MAX.	MAXIMUM	THRSH.	THRESHOLD
DRY	DRYER	M.B.	MACHINE BOLT	†\$G	TONGUE \$ GROOVE
DW	DISHWASHER	MECH.	MECHANICAL MEDICINE CABINET	T.O.F.	TOP OF FOOTING
DWG	DRAWING	M.A.		T.O.	TOP OF
DwG	DRAWING	MFR.	MANUFACTURER MANUFACTURER	T.O.P.	TOP OF PLATE
EA.	EACH	MANUF.		T.O.S.	TOP OF SLAB
ELEC.	ELECTRICAL	MANUF.	MINIMUM MISCELLANE <i>O</i> US	T.O.W.	TOP OF WALL
ELEV.	ELEVATION	MISC. MTD.		TP	TOLET PAPER
EM	ELECTRIC METER	11110.	MOUNTED	THRSH.	TYPICAL
ENCL.	ENCLOSURE	(A)	NEW CONTRACTOR		
	EQUAL	(N)	NEW	U.N.O.	UNLESS NOTED OTHERWISE
EQ EXH.	EXHAUST	N.I.C.	NOT IN CONTRACT	u.c.	UNDER CABINET
EXP.	EXPANSION	NO. OR #	NUMBER		
EXIST. OR (E)		N.T.S.	NOT TO SCALE	VERT.	VERTICAL
	EXISTING	-1			
EXT.	EXTERIOR	01	OVER	w/	WITH
FRRCI	FIREDOL AGG	0.C.	ON CENTER	WASH.	WASHER
FBRGL.	FIBERGLASS	O.F.S.	OUTSIDE FACE OF STUD	WAINS	WAINSCOT
FD	FLOOR DRAIN	OPP.	OPPOSITE	WC	WATER CLOSET
FND.	FOUNDATION	O.A.	OUTSIDE DIAMETER	WD	W00D
F.F.	FINISH FLOOR	_	51.455	w/D	WASHER \$ DRYER STACKED
F.G.	FINISH GRADE	ዊ "	PLATE	WDW	WINDOW
F.S.	FINISH SLAB	P/L	PROPERTY LINE	WM	WATER METER
FLR.	FLOOR	PLAS.	PLASTER	w/ <i>o</i>	WITH OUT
FL.	FLUORESCENT	PLY.	PLYWOOD	WP	WATERPROOF
F.O.C.	FACE OF CONCRETE	PNL.	PANEL	wwp	WELDED WIRE FABRIC
F.O.S.	FACE OF STUD	₽¢s	POLE \$ SHELF		
FR. DR.	FRENCH DOOR	PT.	PONT		
FT.	FOOT OR FEET	PR.	PAIR		

PROJECT DIRECTORY

APPLICANT

OWNER

Josh Scherling

3150 Don Lane Pebble Beach, CA 93953 (831) 238-6296 joshua@scherlingproperties.com

Bradley Green Hastings Construction Inc. 11 Thomas Owens Way, Suite 201 Monterey, CA 93940 (831) 620-0920 ex. 708


bradley@hastingsconstruction.com

SURVEYOR


Jennifer Rudolph, P.E. QSD David T. Edson Central Coast Surveyors C3 Engineering Inc. 5 Harris Court, Suite N-11 126 Bonifacio Place, Suite C Monterey, CA 93940 Monterey, CA 93940 (831) 394-4930 (831) 214-2201 jrudolph@c3engineering.net dave@ccsurveyors.com

APN MAP

CIVIL

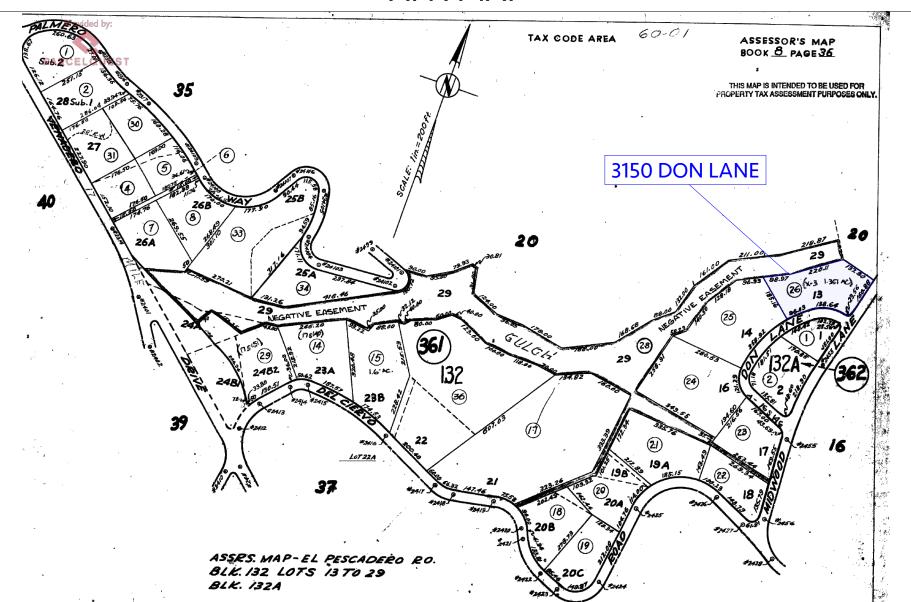

VICINITY MAP

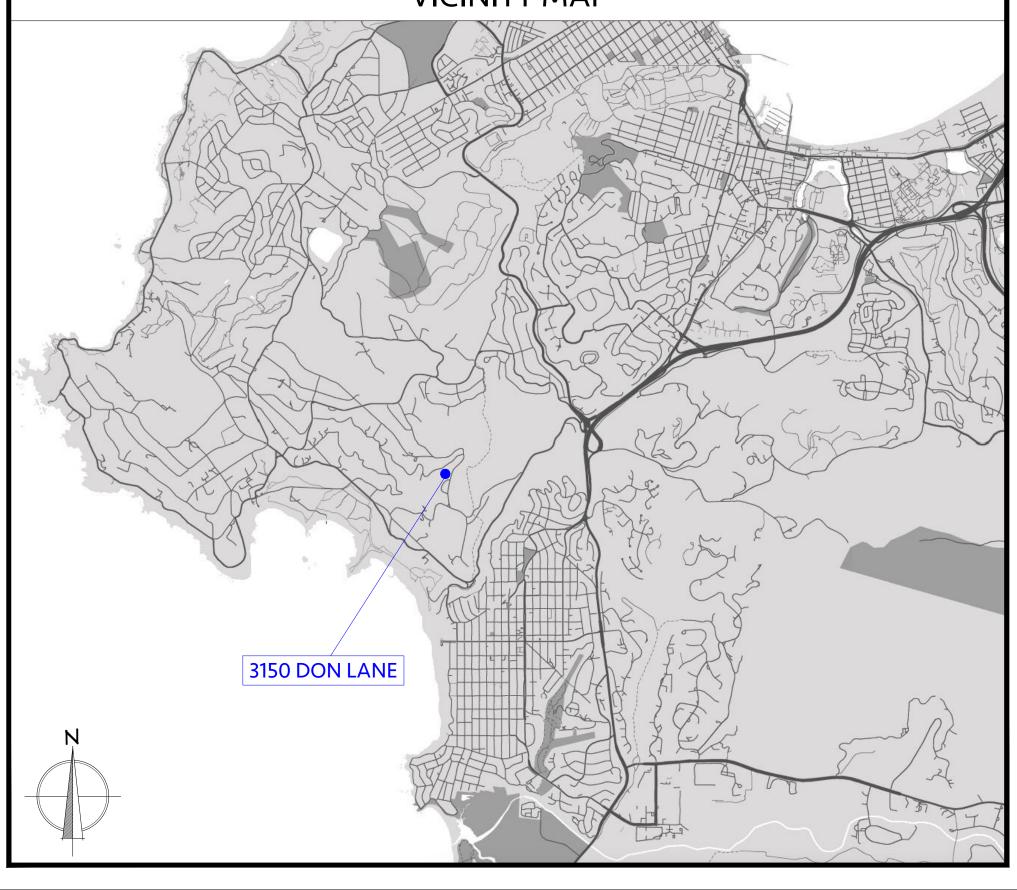

DRAWING INDEX

GENERAL

T1 Title Sheet

SURVEY

1 of 1 Topographic Map

CIVIL

- C1 Title Sheet
- C2 Grading Plan
- C3 Stormtech Details C4 Erosion Control Plan

ARCHITECTURAL

- A1 Existing Site Plan
- A2 Proposed Site Plan
- A3 Forest Management Plan

A6 Proposed Elevations and Roof Plan

- A4 Proposed Floor Plan
- A5 Proposed Elevations

SCOPE OF WORK

New construction 1463 sq. ft. detached workshop with 777 sq. ft. deck and gravel courtyard; Accessory to existing 3432 sq. ft. single family residence with 750 sq. ft. attached garage.

PROJECT DATA

LOT DATA: 2022 California Building Code

2022 California Residential Code 2022 California Mechanical Code 2022 California Plumbing Code

2022 California Fire Code 2022 California Electrical Code 2022 California Energy Code

2022 California Green Building Standards Code

Governing Jurisdiction: Monterey County Housing and

Community Development

R-3

VΒ

Project Address:

3150 Don Lane Pebble Beach, California, 93953

008-361-026-000 APN: LDR / 1.5-D(CZ) Zoning:

58,850 sq. ft. (1.350 Acres) Parcel Size:

1985

Use: Single Family Residential

California American Water:

Pebble Beach Community Services District Sewer: Construction Type:

Fire Sprinklers: Not Required


BUILDING DATA:


Occupancy:

CODE DATA:

Codes:


BUILDING DATA:		
	Existing:	Proposed
ootage:		
Main Residence (2-story):	2932 SQ. FT.	2932 SQ. FT.
Decks and Porch	195 SQ. FT.	195 SQ. FT.
Attached Garage:	750 SQ. FT.	750 SQ. FT.
Detached Workshop:		1463 SQ. FT.
Deck:		777 SQ. FT.
Total F.A.R.	3877 SQ. FT. or 6.5%	5340 SQ. FT. or 9.0%
		(Note: F.A.R. maximum 17.5% per title 20.14.060 and includes gross floor area of all floors per title 20.06.564)
tructure Site Coverage:		
Main Residence (Footprint):	3739 SQ. FT.	3739 SQ. FT.
Detached Workshop (Footprint):		2288 SQ. FT.
Total Site Coverage:	3739 SQ. FT. or 6.3%	6027 SQ. FT. or 10.2%
		(Note: 15% coverage allowed per title 20.14.060 and includes all area covered by a structure, structures or structure protrusions including deck twenty-four (24) inches or more above grade per title 20.06.250)
Impervious Site Coverage (Pescadero Waters	shed):	
Total:	6953 SQ. FT.	8416 SQ. FT.
		(Note: 9000 square feet maximum impervious coverage allowed)

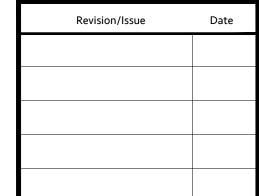

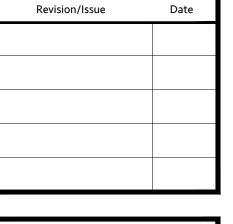



CONSTRUCTION, HASTINGS

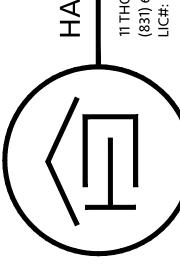


93953 CALIFORNIA , PEBBLE BEACH, 0 26-000

SCHERLING RESIDENCE WORKSHOP HC-24060 7.8.2025

Drawn By: **BGREEN**

Scale:

N.T.S.

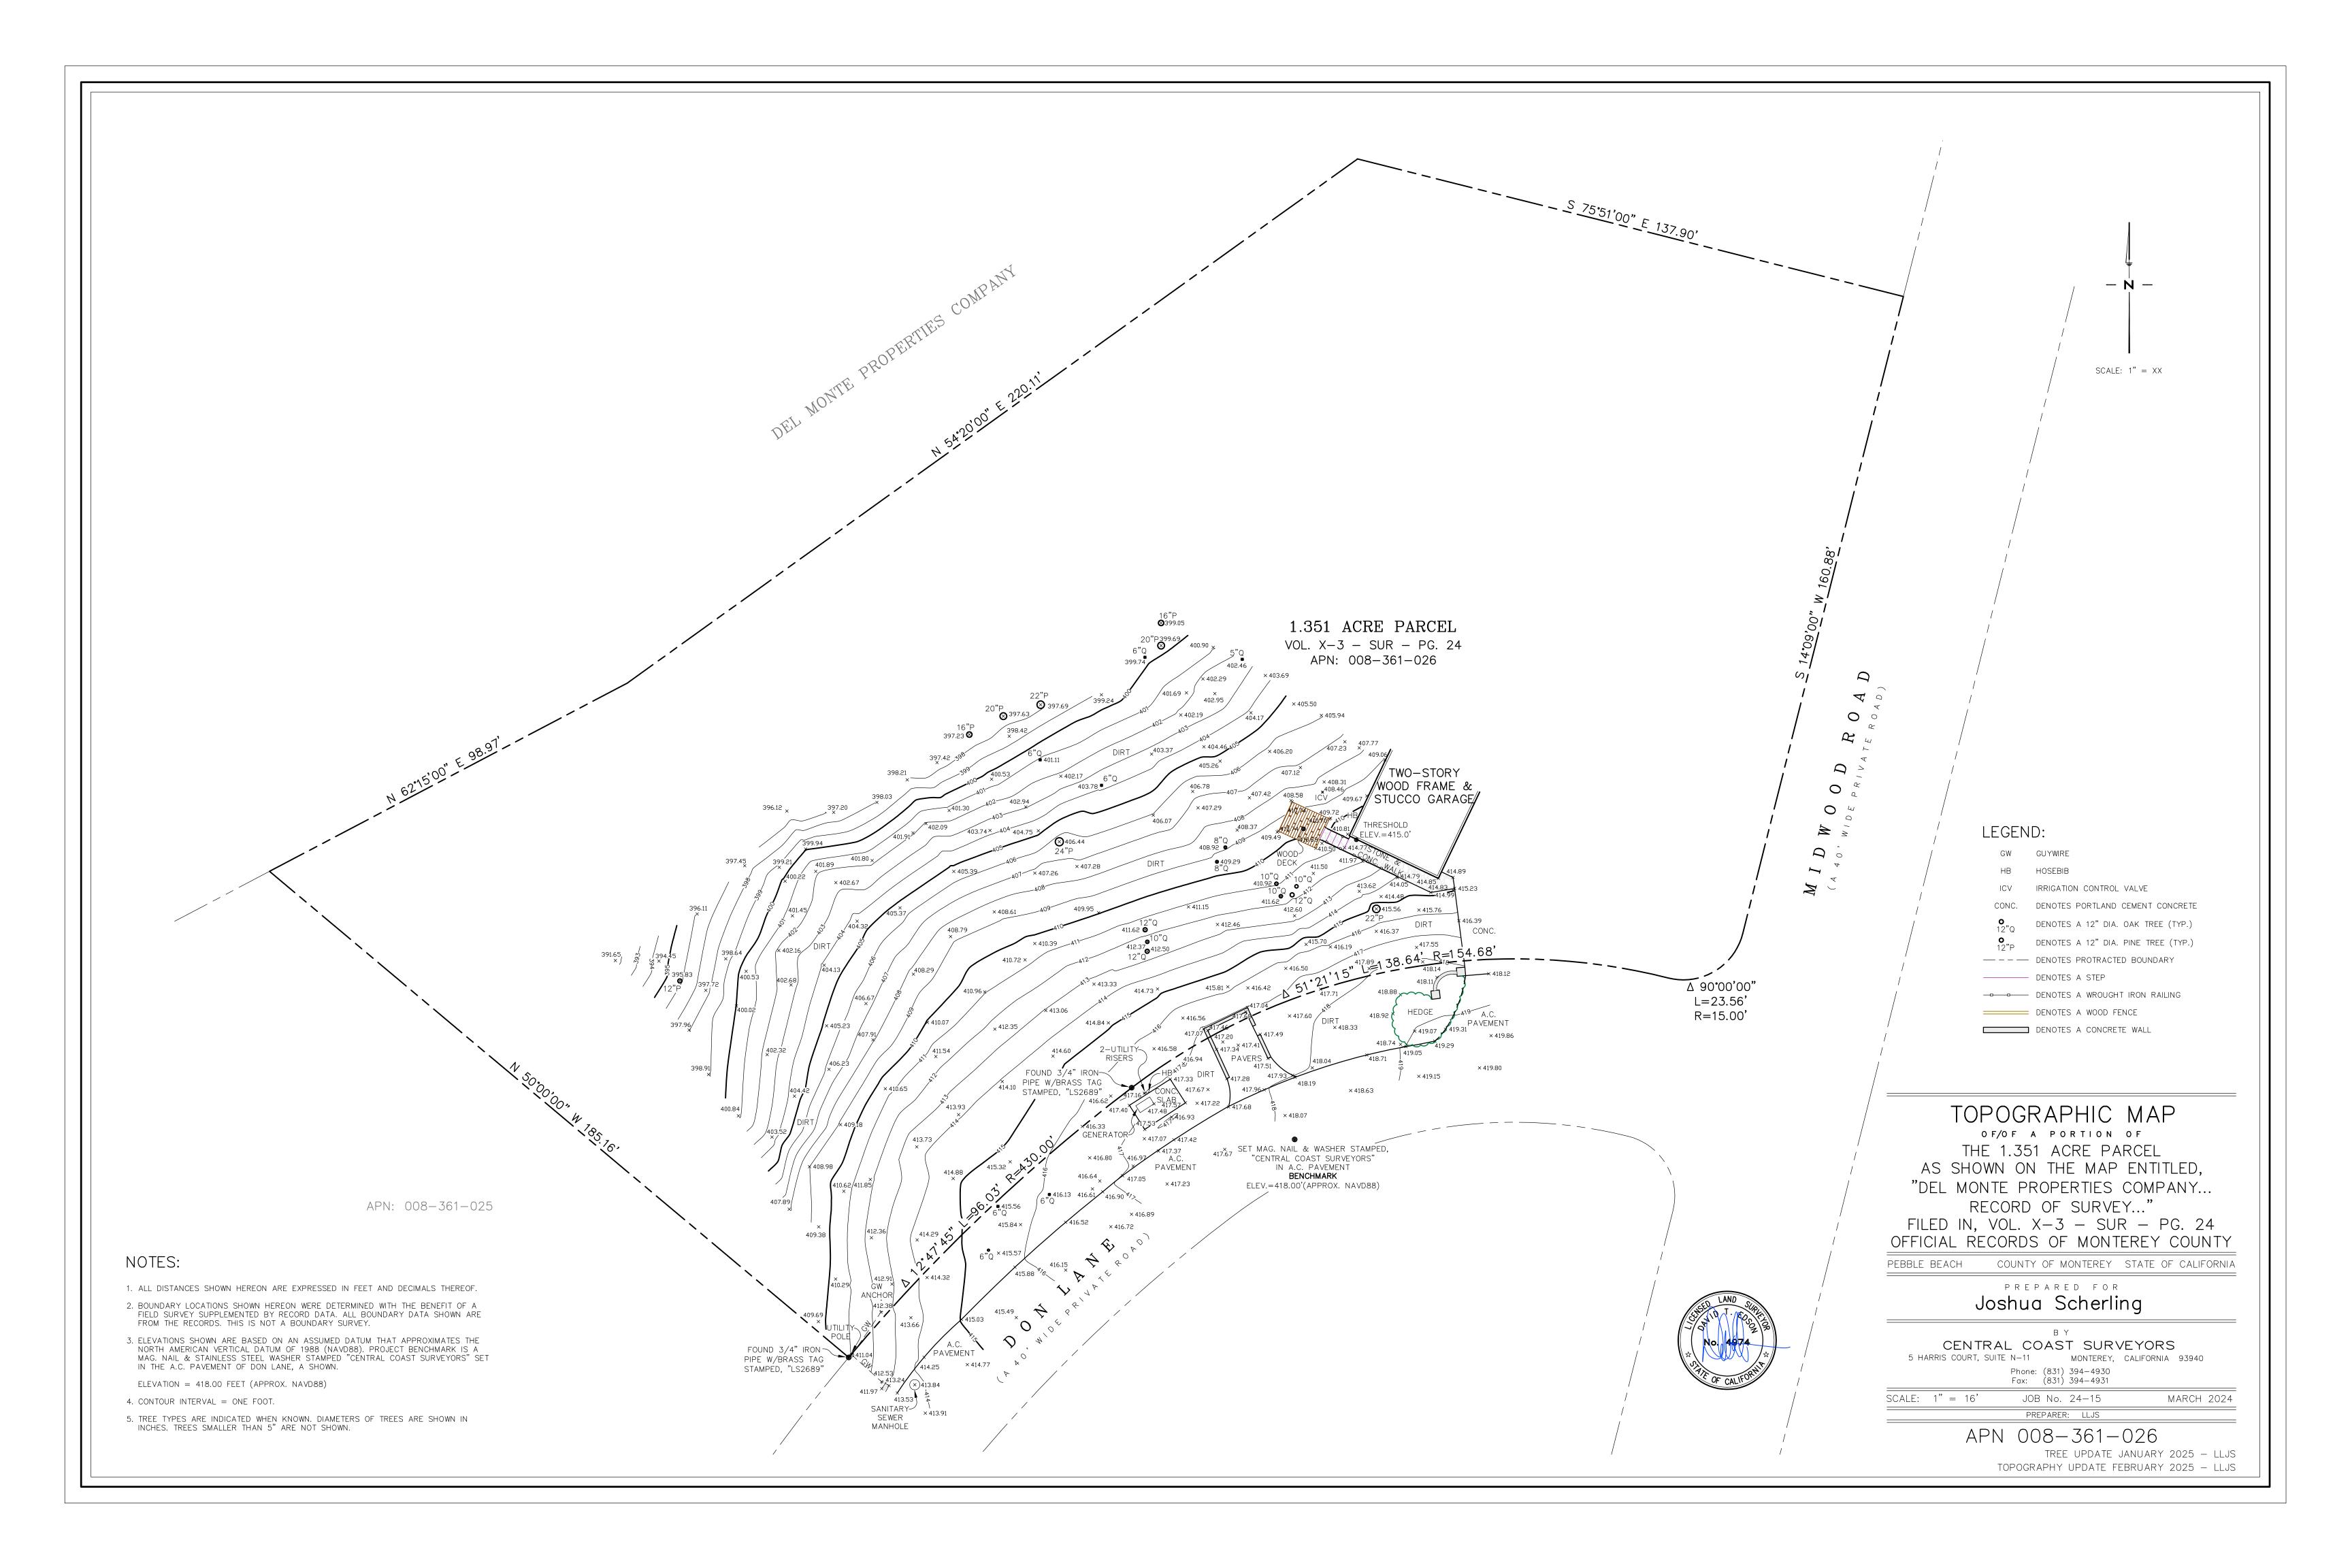

CALIFORNIA ENERGY CODE (CEnC), CALIFORNIA ELECTRICAL CODE (CEC).

- 1. ALL WORK SHALL BE COMPLETED IN ACCORDANCE WITH THESE PLANS AND ACCOMPANYING SPECIFICATIONS, IN ADDITION ALL WORK SHALL ALSO CONFORM WITH THE FOLLOWING:
- LATEST REVISION OF THE COUNTY OF MONTEREY DESIGN STANDARDS AND SPECIFICATIONS
 THE LATEST REVISION OF THE STATE OF CALIFORNIA DEPARTMENT OF TRANSPORTATION STANDARDS AND SPECIFICATIONS (STATE SPECIFICATIONS)
 THE 2025 EDITIONS OF THE CALIFORNIA BUILDING CODE (CBC), CALIFORNIA PLUMBING CODE (CPC), CALIFORNIA MECHANICAL CODE (CMC),
- 2. THE CONTRACTOR SHALL FAMILIARIZE THEMSELVES WITH THE PLANS, DETAILS, AND SPECIFICATIONS AND SITE CONDITIONS PRIOR TO THE START OF CONSTRUCTION. IN THE EVENT THAT THE CONTRACTOR FINDS ANY DISCREPANCIES, OMISSIONS, OR DEFICIENCIES IN THE PLANS, THE CONTRACTOR SHALL NOTIFY THE DESIGN ENGINEER AND THE OWNER'S REPRESENTATIVE IMMEDIATELY.
- 3. IT IS THE CONTRACTORS RESPONSIBILITY TO SECURE ALL REQUIRED PERMITS PRIOR TO THE START OF CONSTRUCTION. THE CONTRACTOR SHALL NOTIFY THE ENGINEER AND THE MONTEREY COUNTY BUILDING SERVICES DEPARTMENT (COUNTY) AT LEAST 24 HOURS PRIOR TO THE START OF CONSTRUCTION
- 4. THE TOPOGRAPHY, LOCATIONS AND SIZE OF UNDERGROUND UTILITIES AND OR OTHER STRUCTURES SHOWN HEREON WERE OBTAINED FROM A FIELD SURVEY (BY OTHERS) AND OR FROM RECORD INFORMATION. NEITHER THE ENGINEER NOR THE OWNER MAKES ANY REPRESENTATION TO THE ACCURACY OF TOPOGRAPHY. SIZE AND OR LOCATION OF ANY OF THE UTILITIES OR STRUCTURES SHOWN ON THESE PLANS NOR FOR THE EXISTENCE OF ANY OTHER BURIED OBJECTS OR UTILITIES WHICH MAY BE ENCOUNTERED THAT ARE NOT SHOWN ON THIS PLAN. IT IS THE CONTRACTOR'S RESPONSIBILITY TO FIELD VERIFY THE SIZE AND LOCATION OF EXISTING UNDERGROUND UTILITIES, SURFACE IMPROVEMENTS, AND OTHER STRUCTURES AND TAKE ALL NECESSARY PRECAUTIONS TO PROTECT THEM FROM DAMAGE DURING CONSTRUCTION.
- 5. THE CONTRACTOR SHALL BE RESPONSIBLE FOR CONTACTING APPROPRIATE UTILITY COMPANIES AND REQUESTING VERIFICATION OF SERVICE POINTS, FIELD VERIFICATION OF LOCATION, SIZE, DEPTH, ETC. FOR ALL THEIR FACILITIES AND TO COORDINATE WORK SCHEDULES.
- 6. THE CONTRACTOR SHALL NOTIFY UNDERGROUND SERVICE ALERT AT (800) 227-2600 AT LEAST 48 HOURS PRIOR TO EXCAVATION TO VERIFY THE LOCATION OF EXISTING UNDERGROUND UTILITIES.
- 7. CONTRACTOR IS RESPONSIBLE FOR COMPLIANCE WITH ANY CURRENTLY APPLICABLE SAFETY LAW OF ANY JURISDICTIONAL BODY. FOR INFORMATION REGARDING THIS PROVISION, THE CONTRACTOR IS DIRECTED TO CONTACT THE STATE OF CALIFORNIA, DIVISION OF OCCUPATIONAL SAFETY AND HEALTH. THE CONTRACTOR SHALL BE RESPONSIBLE FOR ALL BARRICADES, SAFETY DEVICES, AND THE CONTROL OF TRAFFIC WITHIN THE CONSTRUCTION AREA. FOR ALL TRENCH EXCAVATION FIVE (5) FEET OR MORE IN DEPTH, THE CONTRACTOR SHALL OBTAIN A PERMIT FROM THE DIVISION OF OCCUPATIONAL SAFETY AND HEALTH PRIOR TO BEGINNING ANY EXCAVATION. A COPY OF THIS PERMIT SHALL BE AVAILABLE AT THE CONSTRUCTION SITE AT ALL TIMES.
- 8. EXISTING CURB, GUTTER, SIDEWALK, SURVEY MONUMENTS, AND OTHER IMPROVEMENTS WITHIN PROJECT SITE THAT ARE DAMAGED OR DISPLACED AS A RESULT OF THE CONTRACTOR'S ACTIVITIES SHALL BE REPLACED BY THE CONTRACTOR.
- 9. THE CONTRACTOR SHALL ASSUME SOLE AND COMPLETE RESPONSIBILITY FOR THE JOB SITE CONDITIONS AND SAFETY OF ALL PERSONS AND PROPERTY DURING THE COURSE OF CONSTRUCTION OF THE PROJECT. THE CONTRACTOR AGREES TO HOLD HARMLESS, INDEMNIFY AND DEFEND THE OWNER, THE ENGINEER, AND ALL DESIGN CONSULTANTS FROM ANY AND ALL LIABILITY, CLAIMS, LOSSES OR DAMAGES ARISING FROM THE PERFORMANCE OF THE WORK DESCRIBED HEREIN EXCEPT THOSE ARISING FROM THE SOLE NEGLIGENCE OF ANY OF THE PREVIOUSLY MENTIONED PEOPLE OR ENTITIES. THIS REQUIREMENT SHALL BE MADE TO APPLY CONTINUOUSLY AND NOT BE LIMITED TO NORMAL WORKING HOURS. THE CONTRACTOR SHALL LEAVE A 24-HOUR EMERGENCY TELEPHONE NUMBER WITH THE POLICE, FIRE DEPARTMENTS AND PRIVATE SECURITY COMPANY (IF APPLICABLE), AND KEEP THEM INFORMED DAILY REGARDING ANY CONSTRUCTION RELATED ACTIVITY IN THE PUBLIC RIGHT OF WAY.
- 10. CONTRACTOR SHALL BE RESPONSIBLE FOR REMOVAL, OFF-HAUL, AND PROPER DISPOSAL OF ALL ITEMS TO BE REMOVED INCLUDING BUT NOT LIMITED TO: CONCRETE, ASPHALT CONCRETE, STRIPING, ANY AND ALL OTHER DEBRIS FROM THE SITE, EXCESS MATERIAL FROM TRENCHING AND PAVEMENT CONSTRUCTION, TREES AND ROOT BALLS, FENCING AND SPOILS FROM EXCAVATION AT THE CONTRACTOR'S EXPENSE AND SHALL BE DISPOSED OF IN A LAWFUL MANNER.
- 11. IF, DURING THE COURSE OF CONSTRUCTION, CULTURAL, ARCHAEOLOGICAL, HISTORICAL OR PALEONTOLOGICAL RESOURCES ARE UNCOVERED AT THE SITE (SURFACE OR SUBSURFACE RESOURCES) WORK SHALL BE HALTED IMMEDIATELY WITHIN 50 METERS (165 FEET) OF THE FIND UNTIL A QUALIFIED PROFESSIONAL ARCHAEOLOGIST CAN EVALUATE IT. MONTEREY COUNTY HCD PLANNING AND A QUALIFIED ARCHAEOLOGIST (I.E., AN ARCHAEOLOGIST REGISTERED WITH THE REGISTER OF PROFESSIONAL ARCHAEOLOGISTS) SHALL BE IMMEDIATELY CONTACTED BY THE RESPONSIBLE INDIVIDUAL PRESENT ON-SITE. WHEN CONTACTED, THE PROJECT PLANNER AND THE ARCHAEOLOGIST SHALL IMMEDIATELY VISIT THE SITE TO DETERMINE THE EXTENT OF THE RESOURCES AND TO DEVELOP PROPER MITIGATION MEASURES REQUIRED FOR RECOVERY.
- 12. ALL REVISIONS TO THESE PLANS MUST BE APPROVED BY THE ENGINEER AS WELL AS THE OWNER PRIOR TO THEIR CONSTRUCTION AND SHALL BE ACCURATELY SHOWN ON RECORD DRAWINGS PRIOR TO THE ACCEPTANCE OF THE WORK AS COMPLETE. ANY CHANGES TO OR DEVIATIONS FROM THE PLANS MADE WITHOUT AUTHORIZATION SHALL BE AT THE CONTRACTOR'S SOLE RISK AND SHALL ABSOLVE THE ENGINEER OF ANY AND ALL RESPONSIBILITY ASSOCIATED WITH THE THE CHANGE OR DEVIATION.
- 13. THE CONTRACTOR SHALL TAKE ALL NECESSARY MEASURES TO KEEP THE SITE AND ADJACENT AREAS FREE FROM DIRT AND DEBRIS. SHOULD ANY DIRT OR DEBRIS BE DEPOSITED IN THE PUBLIC RIGHT-OF-WAY, THE CONTRACTOR SHALL REMOVE IT IMMEDIATELY.
- 14. THE CONTRACTOR SHALL TAKE ALL NECESSARY MEASURES TO PREVENT AIRBORNE DUST FROM BECOMING A NUISANCE. DUST CONTROL MEASURES TO BE IMPLEMENTED INCLUDE BUT ARE NOT LIMITED TO THE FOLLOWING:
- A) PROVIDE EQUIPMENT AND MANPOWER REQUIRED FOR WATERING ALL EXPOSED OR DISTURBED EARTH
- B) COVER STOCKPILES OF DEBRIS, SOIL, OR OTHER MATERIALS WHICH MAY CONTRIBUTE TO AIRBORNE DUST.
- C) KEEP CONSTRUCTION AREAS AND ADJACENT STREET FREE OF MUD AND DUST.

 D) LANDSCAPE, SEED, OR COVER PORTIONS OF THE SITE AS SOON AS CONSTRUCTION IS COMPLETE.
- 15. A COPY OF ALL FIELD REPORTS/COMPACTIONS TESTS AND FINAL GRADING REPORT SHALL BE SUBMITTED TO THE COUNTY AT SCHEDULED INSPECTIONS.
- 16. PAD ELEVATION/S SHALL BE CERTIFIED TO 0.1 FEET, PRIOR TO DIGGING ANY FOOTINGS OR SCHEDULING ANY INSPECTIONS.

GRADING AND DRAINAGE


- 1. CONTRACTOR SHALL NOTIFY THE COUNTY 48 HOURS BEFORE STARTING ANY GRADING OPERATIONS.
- 2. ALL GRADING SHALL CONFORM TO THE COUNTY GRADING ORDINANCE (CHAPTER 16.08) AND THE EROSION CONTROL ORDINANCE (CHAPTER 16.12) AS APPLICABLE.
- 3. IT IS THE CONTRACTOR'S RESPONSIBILITY TO SECURE THE REQUIRED PERMITS PRIOR TO THE COMMENCEMENT OF GRADING. RIGHT-OF-ENTRY, PERMISSION TO GRADE, AND ENCROACHMENT PERMIT(S) MAY BE REQUIRED PRIOR TO GRADING.
- 4. IT IS THE CONTRACTORS RESPONSIBILITY TO PREPARE THE GROUND SURFACE TO RECEIVE THE FILLS AND TO PLACE, SPREAD, MIX, WATER, AND COMPACT THE FILL. THE CONTRACTOR SHALL ALSO REMOVE ALL MATERIAL CONSIDERED UNSATISFACTORY.
- 5. WHERE UNSTABLE OR UNSUITABLE MATERIALS ARE ENCOUNTERED DURING SUBGRADE PREPARATION, THE AREA IN QUESTION SHALL BE OVER EXCAVATED AND BACKFILLED WITH SELECT MATERIAL.
- 6. MAXIMUM CUT AND FILL SLOPE SHALL BE 2 HORIZONTAL TO 1 VERTICAL.
- 7. ALL CUT SLOPES SHALL BE ROUNDED TO MEET EXISTING GRADES AND BLEND WITH SURROUNDING TOPOGRAPHY. ALL GRADED SLOPES SHALL BE PLANTED WITH SUITABLE GROUND COVER.
- 8. TREE REMOVAL SHALL INCLUDE REMOVAL OF TRUNKS, STUMPS, AND ROOTBALLS. THE REMAINING CAVITY SHALL BE CLEARED OF ALL ROOTS LARGER THAN 1/2" TO A DEPTH OF NOT LESS THAN 18" AND BACKFILLED WITH SUITABLE MATERIAL THEN COMPACTED TO CONFORM WITH THE EXISTING GROUND.
- 9. CONTRACTOR SHALL USE CAUTION WHEN GRADING AROUND AND/OR OVER EXISTING UNDERGROUND UTILITIES.
- 10. ALL SURFACE DRAINAGE SHALL MAINTAIN 2% SLOPE MINIMUM UNLESS NOTED OTHERWISE.
- 11. PERVIOUS SURFACES IMMEDIATELY ADJACENT TO THE FOUNDATION SHALL BE SLOPED AWAY FROM THE BUILDING AT A SLOPE OF NOT LESS THAN 5% FOR A MINIMUM DISTANCE OF 10 FEET MEASURED PERPENDICULAR TO THE FACE OF THE WALL. IF PHYSICAL OBSTRUCTIONS OR LOT LINES PROHIBIT 10 FEET OF HORIZONTAL DISTANCE, A 5% SLOPE SHALL BE PROVIDED TO AN APPROVED ALTERNATIVE METHOD OF DIVERTING WATER AWAY FROM THE FOUNDATION. SWALES USED FOR THIS PURPOSE SHALL BE SLOPED A MINIMUM OF 2% WHERE LOCATED WITHIN 10 FEET OF THE BUILDING FOUNDATION. IMPERVIOUS SURFACES WITHIN 10 FEET OF THE BUILDING FOUNDATION SHALL BE SLOPED A MINIMUM OF 2% AWAY FROM THE BUILDING.
- 12. DURING WINTER OPERATIONS (BETWEEN OCTOBER 15 AND APRIL 15) THE FOLLOWING MEASURES MUST BE TAKEN:
- A. DISTURBED SURFACES NOT INVOLVED IN IMMEDIATE OPERATIONS MUST BE PROTECTED BY MULCHING AND OR OTHER EFFECTIVE MEANS OF SOIL PROTECTION.
- B. ALL ROADS AND DRIVEWAYS SHALL HAVE DRAINAGE FACILITIES SUFFICIENT TO PREVENT EROSION ON OR ADJACENT TO THE ROADWAY OR ON DOWNHILL PROPERTIES.
- C. RUN-OFF FROM THE SITE SHALL BE DETAINED OR FILTERED BY BERMS, VEGETATED FILTER STRIPS, AND OR CATCH BASINS TO PREVENT THE ESCAPE OF SEDIMENT FROM THE SITE.
- D. DRAINAGE CONTROL MEASURES SHALL BE MAINTAINED AND IN PLACE AT THE END OF EACH DAY AND CONTINUOUSLY THROUGH THE LIFE OF THE PROJECT DURING WINTER OPERATIONS


- 13. VEGETATION REMOVAL. ACTUAL GRADING SHALL BEGIN WITHIN 30 DAYS OF VEGETATION REMOVAL OR THAT AREA SHALL BE PLANTED.
- 14. NO VEGETATION REMOVAL OR GRADING WILL BE ALLOWED WHICH WILL RESULT IN SILTATION OF WATER COURSES OR UNCONTROLLABLE EROSION.

UNDERGROUND UTILITIES

- 1. CONTRACTOR SHALL EXPOSE AND VERIFY LOCATION AND ELEVATION OF EXISTING UTILITIES, INCLUDING STORM DRAINS, SANITARY SEWERS AND WATER LINES, BEFORE ORDERING MATERIALS AND/OR CONSTRUCTING NEW FACILITIES.
- 2. ALL EXISTING MANHOLES AND UTILITY BOXES WITHIN THE PROJECT AREA ARE TO BE SET FLUSH WITH FINISHED GRADE, UNLESS OTHERWISE NOTED.
- 3. ALL TRENCHES AND EXCAVATIONS SHALL BE CONSTRUCTED IN STRICT COMPLIANCE WITH THE APPLICABLE SECTIONS OF CALIFORNIA AND FEDERAL O.S.H.A. REQUIREMENTS AND OTHER APPLICABLE SAFETY ORDINANCES, CONTRACTOR SHALL BEAR FULL RESPONSIBILITY FOR TRENCH SHORING DESIGN AND INSTALLATION.
- 4. PIPE MATERIALS AND INSTALLATION PROCEDURE SHALL BE IN ACCORDANCE WITH APPLICABLE SECTIONS OF THE STANDARD SPECIFICATIONS AND THE MANUFACTURER'S RECOMMENDATIONS.
- 5. DAMAGE SHALL BE REPAIRED IN ACCORDANCE WITH THE STANDARD SPECIFICATIONS OF THE COUNTY.

Inspection:	When:	Who:	Inspection By:	Date of Inspection:
Inspect and test	1)Prior to backfilling	Soils Engineer		
Keyway/Subexcavation/overexcavation:	2)During backfill placement – ongoing	Soils Engineer		
Inspect and Test Building Pad Subgrade:	Prior to excavation footings or placement of slab-on-grade materials	Soils Engineer		
Inspect Slab-on-grade installation:	Prior to concrete placement	Soils Engineer		
Inspect Foundation and/or retaining wall footing excavations:	Prior to reinforcement placement	Soils Engineer		
Inspect and Test Retaining wall backfill:	During backfill placement – ongoing	Soils Engineer		
	1)During fill placement	Soils Engineer		
Inspect and Test Driveway Fill, Subgrade and Baserock Placement:	2)Subgrade, prior to baserock placement	Soils Engineer		
	3)Baserock prior to AC, Concrete or Pavement	Soils Engineer		
Inspect and Test Drainage Installation	1)After pipe placement, prior to backfill placement	Soils Engineer		
Inspect and Test Drainage Installation:	2)During backfill placement – ongoing	Soils Engineer		
Inspect site stripping and clearing	After clearing complete	Soils Engineer		
Inspect utility trench compaction	After utility trench backfill	Soils Engineer		

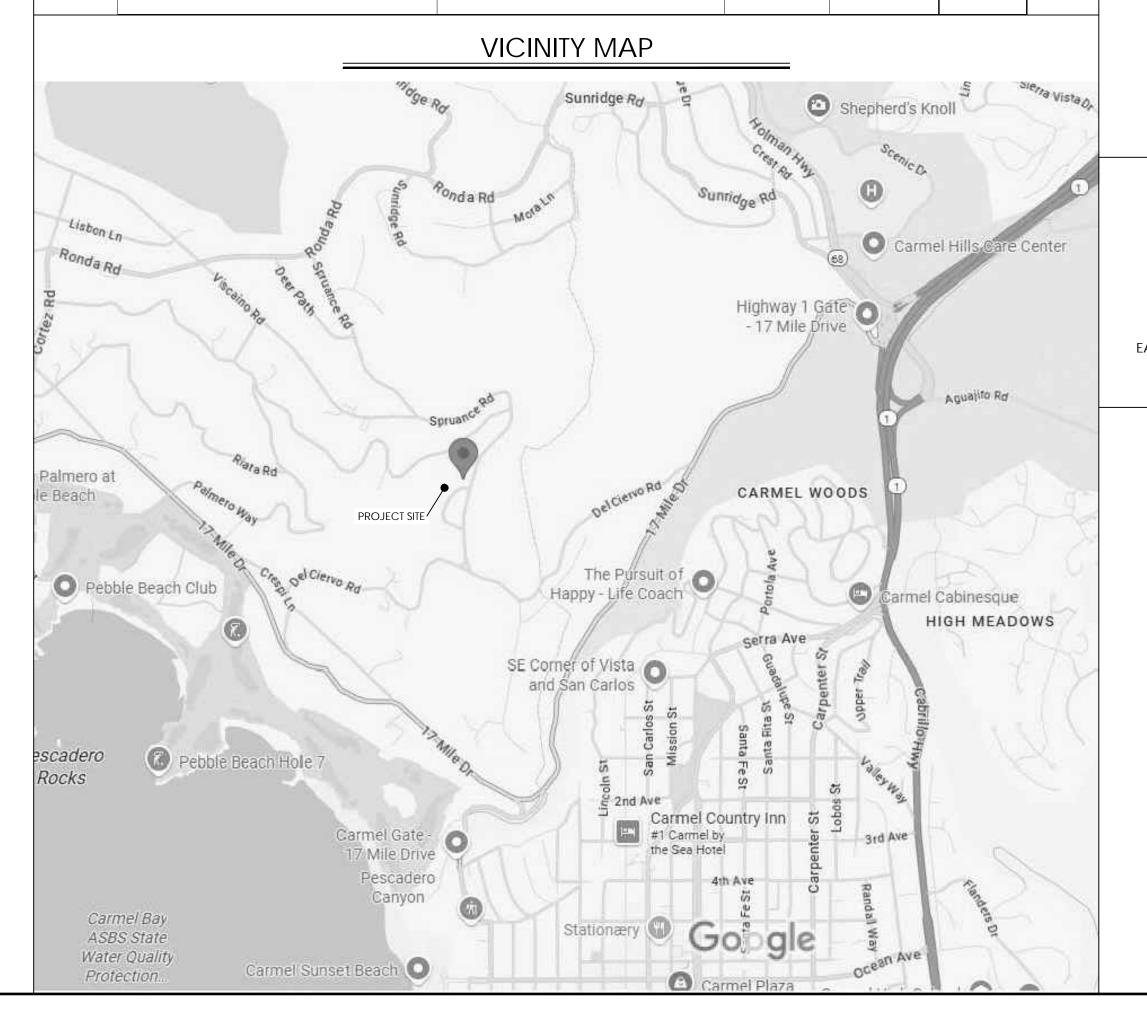

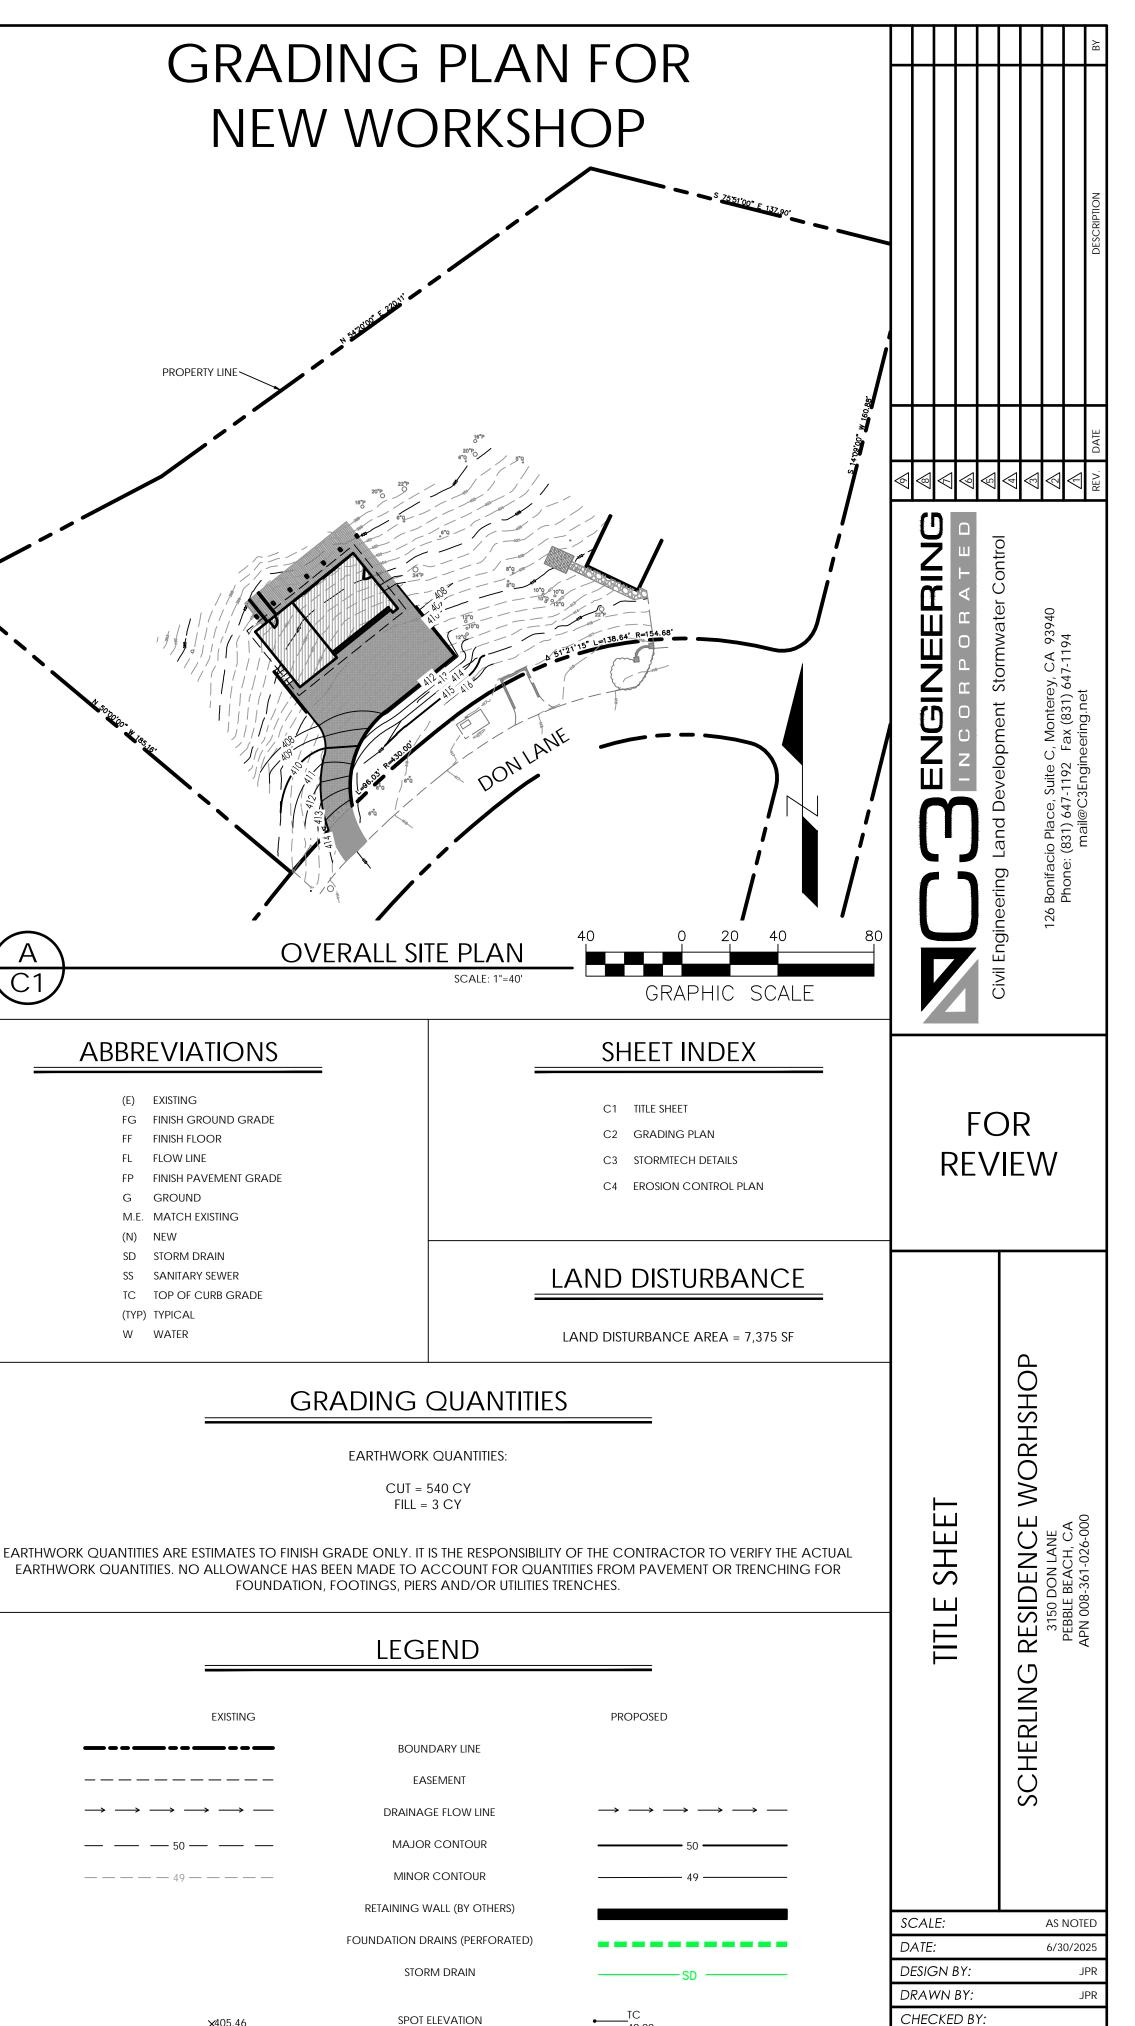

DRAINAGE FLOW

GRAVEL PAVEMENT

BUILDING (SEE ARCH PLANS)


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SHEET NUMBER:

OF 4 SHEETS

PROJECT#

Plotted: Jun 30, 2025 – 1:29pm

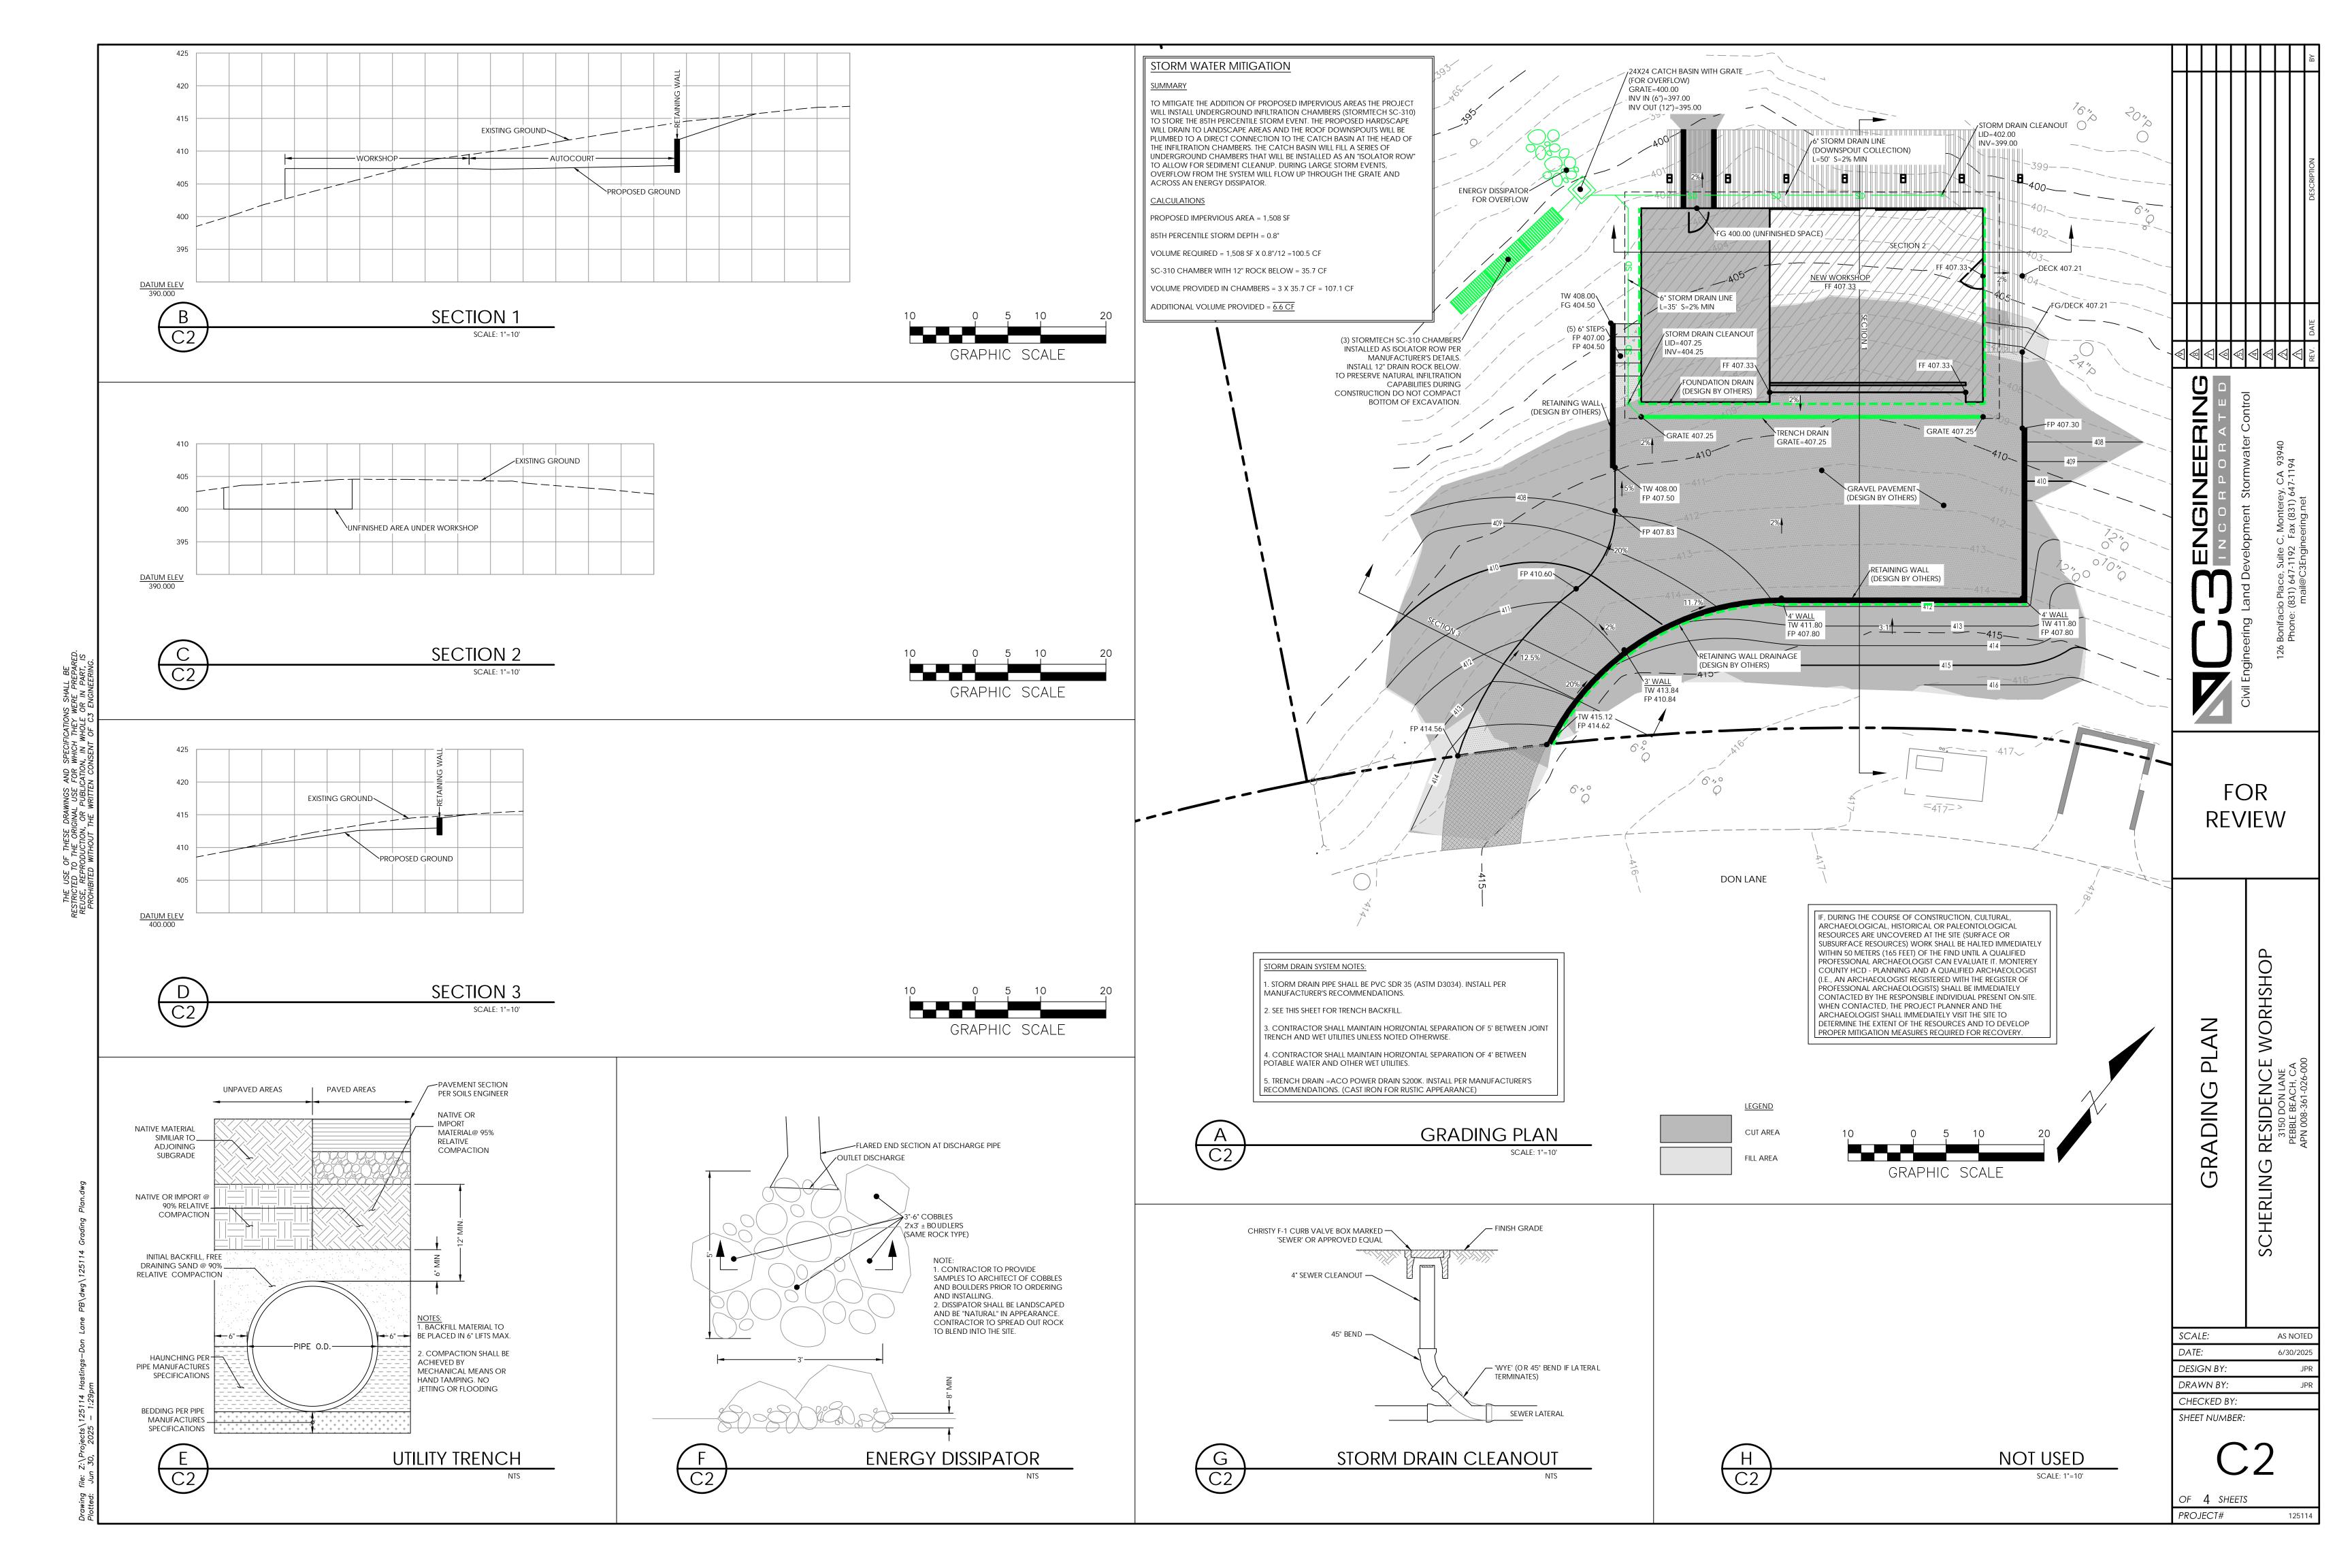

- 1. CHAMBERS SHALL BE STORMTECH SC-740 OR SC-310.
- CHAMBERS SHALL BE MANUFACTURED FROM VIRGIN POLYPROPYLENE OR POLYETHYLENE RESINS.
- CHAMBER ROWS SHALL PROVIDE CONTINUOUS, UNOBSTRUCTED INTERNAL SPACE WITH NO INTERNAL SUPPORT PANELS THAT WOULD IMPEDE FLOW OR LIMIT ACCESS FOR INSPECTION.
- THE STRUCTURAL DESIGN OF THE CHAMBERS, THE STRUCTURAL BACKFILL, AND THE INSTALLATION REQUIREMENTS SHALL ENSURE THAT THE LOAD FACTORS SPECIFIED IN THE AASHTO LRFD BRIDGE DESIGN SPECIFICATIONS, SECTION 12.12, ARE MET FOR: 1) LONG-DURATION DEAD LOADS AND 2) SHORT-DURATION LIVE LOADS, BASED ON THE AASHTO DESIGN TRUCK WITH CONSIDERATION FOR IMPACT AND MULTIPLE VEHICLE
- CHAMBERS SHALL MEET ASTM F2922 (POLYETHYLENE) OR ASTM F2418-16 (POLYPROPYLENE), "STANDARD SPECIFICATION FOR THERMOPLASTIC CORRUGATED WALL STORMWATER COLLECTION CHAMBERS".
- CHAMBERS SHALL BE DESIGNED AND ALLOWABLE LOADS DETERMINED IN ACCORDANCE WITH ASTM F2787, "STANDARD PRACTICE FOR STRUCTURAL DESIGN OF THERMOPLASTIC CORRUGATED WALL STORMWATER
- ONLY CHAMBERS THAT ARE APPROVED BY THE SITE DESIGN ENGINEER WILL BE ALLOWED. THE CHAMBER MANUFACTURER SHALL SUBMIT THE FOLLOWING UPON REQUEST TO THE SITE DESIGN ENGINEER FOR APPROVAL BEFORE DELIVERING CHAMBERS TO THE PROJECT SITE:
 - a. A STRUCTURAL EVALUATION SEALED BY A REGISTERED PROFESSIONAL ENGINEER THAT DEMONSTRATES THAT THE SAFETY FACTORS ARE GREATER THAN OR EQUAL TO 1.95 FOR DEAD LOAD AND 1.75 FOR LIVE LOAD, THE MINIMUM REQUIRED BY ASTM F2787 AND BY AASHTO FOR THERMOPLASTIC PIPE.
 - A STRUCTURAL EVALUATION SEALED BY A REGISTERED PROFESSIONAL ENGINEER THAT DEMONSTRATES THAT THE LOAD FACTORS SPECIFIED IN THE AASHTO LRFD BRIDGE DESIGN SPECIFICATIONS, SECTION 12.12. ARE MET. THE 50 YEAR CREEP MODULUS DATA SPECIFIED IN ASTM F2418 OR ASTM F2922 MUST BE USED AS PART OF THE AASHTO STRUCTURAL EVALUATION TO VERIFY LONG-TERM PERFORMANCE.
 - c. STRUCTURAL CROSS SECTION DETAIL ON WHICH THE STRUCTURAL EVALUATION IS BASED.
- 8. CHAMBERS AND END CAPS SHALL BE PRODUCED AT AN ISO 9001 CERTIFIED MANUFACTURING FACILITY.

- STORMTECH SC-310 & SC-740 CHAMBERS SHALL NOT BE INSTALLED UNTIL THE MANUFACTURER'S REPRESENTATIVE HAS
- 2. STORMTECH SC-310 & SC-740 CHAMBERS SHALL BE INSTALLED IN ACCORDANCE WITH THE "STORMTECH SC-310/SC-740/DC-780
- CHAMBERS ARE NOT TO BE BACKFILLED WITH A DOZER OR AN EXCAVATOR SITUATED OVER THE CHAMBERS.
 - BACKFILL AS ROWS ARE BUILT USING AN EXCAVATOR ON THE FOUNDATION STONE OR SUBGRADE.
- 5. JOINTS BETWEEN CHAMBERS SHALL BE PROPERLY SEATED PRIOR TO PLACING STONE.
- MAINTAIN MINIMUM 6" (150 mm) SPACING BETWEEN THE CHAMBER ROWS.
- EMBEDMENT STONE SURROUNDING CHAMBERS MUST BE A CLEAN, CRUSHED, ANGULAR STONE 3/4-2" (20-50 mm).
- 8. THE CONTRACTOR MUST REPORT ANY DISCREPANCIES WITH CHAMBER FOUNDATION MATERIALS BEARING CAPACITIES TO THE
- ADS RECOMMENDS THE USE OF "FLEXSTORM CATCH IT" INSERTS DURING CONSTRUCTION FOR ALL INLETS TO PROTECT THE SUBSURFACE STORMWATER MANAGEMENT SYSTEM FROM CONSTRUCTION SITE RUNOFF.

NOTES FOR CONSTRUCTION EQUIPMENT

- STORMTECH SC-310 & SC-740 CHAMBERS SHALL BE INSTALLED IN ACCORDANCE WITH THE "STORMTECH SC-310/SC-740/DC-780
 - NO RUBBER TIRED LOADERS, DUMP TRUCKS, OR EXCAVATORS ARE ALLOWED UNTIL PROPER FILL DEPTHS ARE REACHED IN ACCORDANCE WITH THE "STORMTECH SC-310/SC-740/DC-780 CONSTRUCTION GUIDE". WEIGHT LIMITS FOR CONSTRUCTION EQUIPMENT CAN BE FOUND IN THE "STORMTECH SC-310/SC-740/DC-780 CONSTRUCTION
- 3. FULL 36" (900 mm) OF STABILIZED COVER MATERIALS OVER THE CHAMBERS IS REQUIRED FOR DUMP TRUCK TRAVEL OR DUMPING. USE OF A DOZER TO PUSH EMBEDMENT STONE BETWEEN THE ROWS OF CHAMBERS MAY CAUSE DAMAGE TO THE CHAMBERS AND IS NOT AN ACCEPTABLE BACKFILL METHOD. ANY CHAMBERS DAMAGED BY THE "DUMP AND PUSH" METHOD ARE NOT COVERED UNDER THE STORMTECH STANDARD WARRANTY.

CONSTRUCTION EQUIPMENT.

ACCEPTABLE FILL MATERIALS: STORMTECH SC-310 CHAMBER SYSTEMS AASHTO MATERIAL MATERIAL LOCATION DESCRIPTION

	WATERIAL LOCATION	DESCRIPTION	CLASSIFICATIONS	REQUIREMENT
D	FINAL FILL: FILL MATERIAL FOR LAYER 'D' STARTS FROM THE TOP OF THE 'C' LAYER TO THE BOTTOM OF FLEXIBLE PAVEMENT OR UNPAVED FINISHED GRADE ABOVE. NOTE THAT PAVEMENT SUBBASE MAY BE PART OF THE 'D' LAYER	ANY SOIL/ROCK MATERIALS, NATIVE SOILS, OR PER ENGINEER'S PLANS. CHECK PLANS FOR PAVEMENT SUBGRADE REQUIREMENTS.	N/A	PREPARE PER SITE DESIGN ENGINEER'S PLANS. PAVED INSTALLATIONS MAY HAVE STRINGENT MATERIAL AND PREPARATION REQUIREMENTS.
С	INITIAL FILL: FILL MATERIAL FOR LAYER 'C' STARTS FROM THE TOP OF THE EMBEDMENT STONE ('B' LAYER) TO 18" (450 mm) ABOVE THE TOP OF THE CHAMBER. NOTE THAT PAVEMENT SUBBASE MAY BE A PART OF THE 'C' LAYER.	GRANULAR WELL-GRADED SOIL/AGGREGATE MIXTURES, <35% FINES OR PROCESSED AGGREGATE. MOST PAVEMENT SUBBASE MATERIALS CAN BE USED IN LIEU OF THIS LAYER.	AASHTO M145 ¹ A-1, A-2-4, A-3 OR AASHTO M43 ¹ 3, 357, 4, 467, 5, 56, 57, 6, 67, 68, 7, 78, 8, 89, 9, 10	BEGIN COMPACTIONS AFTER 12" (300 mm) OF MATERIAL OVER THE CHAMBERS IS REACHED. COMPACT ADDITIONAL LAYERS IN 6" (150 mm) MAX LIFTS TO A MIN. 95% PROCTOR DENSITY FOR WELL GRADED MATERIAL AND 95% RELATIVE DENSITY FOR PROCESSED AGGREGATE MATERIALS. ROLLER GROSS VEHICLE WEIGHT NOT TO EXCEED 12,000 lbs (53 kN). DYNAMIC FORCE NOT TO EXCEED 20,000 lbs (89 kN).
В	EMBEDMENT STONE: FILL SURROUNDING THE CHAMBERS FROM THE FOUNDATION STONE ('A' LAYER) TO THE 'C' LAYER ABOVE.	CLEAN, CRUSHED, ANGULAR STONE	AASHTO M43 ¹ 3, 357, 4, 467, 5, 56, 57	NO COMPACTION REQUIRED.
А	FOUNDATION STONE: FILL BELOW CHAMBERS FROM THE SUBGRADE UP TO THE FOOT (BOTTOM) OF THE CHAMBER.	CLEAN, CRUSHED, ANGULAR STONE	AASHTO M43 ¹ 3, 357, 4, 467, 5, 56, 57	PLATE COMPACT OR ROLL TO ACHIEVE A FLAT SURFACE. ^{2,3}

CHAMBER STORAGE

MINIMUM INSTALLED STORAGE*

PRE CORED END CAPS END WITH "PC"

PART#

SC310EPE06T / SC310EPE06TP

SC310EPE06B / SC310EPE06BPC

SC310EPE08T / SC310EPE08TPC

SC310EPE08B / SC310EPE08BP0

SC310EPE10T / SC310EPE10TPC

SC310EPE10B / SC310EPE10BPC

NOTE: ALL DIMENSIONS ARE NOMINAL

85.4" (2169 mm) INSTALLED LENGTH ---

BUILD ROW IN THIS DIRECTION

34.0" X 16.0" X 85.4" (864 mm X 406 mm X 2169 mm)

(0.88 m³)

(16.8 kg)

11.9" (302 mm)

12.7" (323 mm)

SC-310 TECHNICAL SPECIFICATIONS

COMPACTION / DENSITY

5.8" (147 mm)

3.5" (89 mm)

0.5" (13 mm)

0.7" (18 mm)

0.9" (23 mm)

14.7 CUBIC FEET

31.0 CUBIC FEET

35.0 lbs.

6" (150 mm)

8" (200 mm)

10" (250 mm)

12" (300 mm) 13.5" (343 mm)

BACKFILL MATERIAL SHOULD BE REMOVED FROM BELOW THE N-12 STUB SO THAT THE FITTING SITS LEVEL.

ALL STUBS, EXCEPT FOR THE SC310EPE12B ARE PLACED AT BOTTOM OF END CAP SUCH THAT THE OUTSIDE DIAMETER OF THE STUB IS FLUSH WITH THE BOTTOM OF THE END CAP. FOR ADDITIONAL INFORMATION CONTACT STORMTECH AT

* FOR THE SC310EPE12B THE 12" (300 mm) STUB LIES BELOW THE BOTTOM OF THE END CAP APPROXIMATELY 0.25" (6 mm).

*ASSUMES 6" (152 mm) ABOVE, BELOW, AND BETWEEN CHAMBERS

PRE-FAB STUBS AT BOTTOM OF END CAP FOR PART NUMBERS ENDING WITH "B"

PRE-FAB STUBS AT TOP OF END CAP FOR PART NUMBERS ENDING WITH "T"

- OVERLAP NEXT CHAMBER HERE (OVER SMALL CORRUGATION)

- 1. THE LISTED AASHTO DESIGNATIONS ARE FOR GRADATIONS ONLY. THE STONE MUST ALSO BE CLEAN, CRUSHED, ANGULAR. FOR EXAMPLE, A SPECIFICATION FOR #4 STONE WOULD STATE: "CLEAN, CRUSHED, ANGULAR NO. 4 (AASHTO M43) STONE".
- STORMTECH COMPACTION REQUIREMENTS ARE MET FOR 'A' LOCATION MATERIALS WHEN PLACED AND COMPACTED IN 6" (150 mm) (MAX) LIFTS USING TWO FULL COVERAGES WITH A VIBRATORY COMPACTOR. 3. WHERE INFILTRATION SURFACES MAY BE COMPROMISED BY COMPACTION, FOR STANDARD DESIGN LOAD CONDITIONS, A FLAT SURFACE MAY BE ACHIEVED BY RAKING OR DRAGGING WITHOUT COMPACTION EQUIPMENT. FOR SPECIAL LOAD DESIGNS, CONTACT STORMTECH FOR COMPACTION REQUIREMENTS.

ADS GEOSYNTHETICS 601T NON-WOVEN GEOTEXTILE ALL AROUND PAVEMENT LAYER (DESIGNED CLEAN CRUSHED, ANGULAR STONE IN A & B LAYERS BY SITE DESIGN ENGINEER) *TO BOTTOM OF FLEXIBLE PAVEMENT. FOR UNPAVED INSTALLATIONS WHERE RUTTING FROM VEHICLES MAY OCCUR, INCREASE COVER TO 24" (600 mm). PERIMETER STONE 6" (150 mm) (SEE NOTE 5 (450 mm) MIN* MAX EXCAVATION WALL (CAN BE SLOPED OR VERTICAL) (406 mm) DEPTH OF STONE TO BE DETERMINED BY SITE DESIGN ENGINEER 6" (150 mm) MIN 12" (300 mm) MIN END CAP (150 mm) MIN SUBGRADE SOILS -

(SEE NOTE 4)

NOTES:

- 1. SC-310 CHAMBERS SHALL CONFORM TO THE REQUIREMENTS OF ASTM F2418 "STANDARD SPECIFICATION FOR POLYPROPYLENE (PP) CORRUGATED WALL STORMWATER COLLECTION CHAMBERS", OR ASTM F2922 "STANDARD SPECIFICATION FOR POLYETHYLENE (PE) CORRUGATED WALL STORMWATER COLLECTION CHAMBERS".
- 2. SC-310 CHAMBERS SHALL BE DESIGNED IN ACCORDANCE WITH ASTM F2787 "STANDARD PRACTICE FOR STRUCTURAL DESIGN OF THERMOPLASTIC CORRUGATED WALL STORMWATER COLLECTION
- 3. "ACCEPTABLE FILL MATERIALS" TABLE ABOVE PROVIDES MATERIAL LOCATIONS, DESCRIPTIONS, GRADATIONS, AND COMPACTION REQUIREMENTS FOR FOUNDATION, EMBEDMENT, AND FILL MATERIALS.
- 4. THE SITE DESIGN ENGINEER IS RESPONSIBLE FOR ASSESSING THE BEARING RESISTANCE (ALLOWABLE BEARING CAPACITY) OF THE SUBGRADE SOILS AND THE DEPTH OF FOUNDATION STONE WITH
- CONSIDERATION FOR THE RANGE OF EXPECTED SOIL MOISTURE CONDITIONS.
- 5. PERIMETER STONE MUST BE EXTENDED HORIZONTALLY TO THE EXCAVATION WALL FOR BOTH VERTICAL AND SLOPED EXCAVATION WALLS.
- 6. ONCE LAYER 'C' IS PLACED, ANY SOIL/MATERIAL CAN BE PLACED IN LAYER 'D' UP TO THE FINISHED GRADE. MOST PAVEMENT SUBBASE SOILS CAN BE USED TO REPLACE THE MATERIAL REQUIREMENTS OF LAYER 'C' OR 'D' AT THE SITE DESIGN ENGINEER'S DISCRETION.

IMPORTANT - NOTES FOR THE BIDDING AND INSTALLATION OF THE SC-310/SC-740 SYSTEM


- COMPLETED A PRE-CONSTRUCTION MEETING WITH THE INSTALLERS.
- STORMTECH RECOMMENDS 3 BACKFILL METHODS: STONESHOOTER LOCATED OFF THE CHAMBER BED.
- BACKFILL FROM OUTSIDE THE EXCAVATION USING A LONG BOOM HOE OR EXCAVATOR.
- 4. THE FOUNDATION STONE SHALL BE LEVELED AND COMPACTED PRIOR TO PLACING CHAMBERS.

- CONSTRUCTION GUIDE".
- THE USE OF CONSTRUCTION EQUIPMENT OVER SC-310 & SC-740 CHAMBERS IS LIMITED:
 - NO EQUIPMENT IS ALLOWED ON BARE CHAMBERS.

CONTACT STORMTECH AT 1-888-892-2694 WITH ANY QUESTIONS ON INSTALLATION REQUIREMENTS OR WEIGHT LIMITS FOR

COVER ENTIRE ISOLATOR ROW WITH ADS GEOSYNTHETICS 601T NON-WOVEN GEOTEXTILE 5' (1.5 m) MIN WIDE OPTIONAL INSPECTION PORT STORMTECH HIGHLY RECOMMENDS SC-310 CHAMBER FLEXSTORM PURE INSERTS IN ANY UPSTREAM STRUCTURES WITH OPEN GRATES ELEVATED BYPASS MANIFOLD -- SC-310 END CAP SUMP DEPTH TBD BY CATCH BASIN SITE DESIGN ENGINEER OR MANHOLE (24" [600 mm] MIN RECOMMENDED) TWO LAYERS OF ADS GEOSYNTHETICS 315WTK WOVEN GEOTEXTILE BETWEEN FOUNDATION STONE AND CHAMBERS 12" (300 mm) HDPE ACCESS PIPE REQUIRED 4' (1.2 m) MIN WIDE CONTINUOUS FABRIC WITHOUT SEAMS USE FACTORY PRE-FABRICATED END CAP PART #: SC310EPE12B

SC-310 ISOLATOR ROW DETAIL

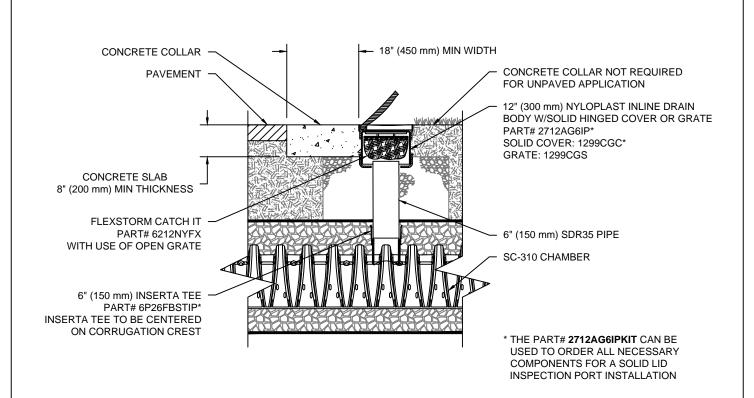

STEP 1) INSPECT ISOLATOR ROW FOR SEDIMENT

INSPECTION & MAINTENANCE

- A. INSPECTION PORTS (IF PRESENT)
 - REMOVE/OPEN LID ON NYLOPLAST INLINE DRAIN REMOVE AND CLEAN FLEXSTORM FILTER IF INSTALLED
 - USING A FLASHLIGHT AND STADIA ROD, MEASURE DEPTH OF SEDIMENT AND RECORD ON
 - A.4. LOWER A CAMERA INTO ISOLATOR ROW FOR VISUAL INSPECTION OF SEDIMENT LEVELS A.5. IF SEDIMENT IS AT, OR ABOVE, 3" (80 mm) PROCEED TO STEP 2. IF NOT, PROCEED TO STEP 3.
 - B. ALL ISOLATOR ROWS
 - B.1. REMOVE COVER FROM STRUCTURE AT UPSTREAM END OF ISOLATOR ROW USING A FLASHLIGHT, INSPECT DOWN THE ISOLATOR ROW THROUGH OUTLET PIPE
-) MIRRORS ON POLES OR CAMERAS MAY BE USED TO AVOID A CONFINED SPACE ENTRY ii) FOLLOW OSHA REGULATIONS FOR CONFINED SPACE ENTRY IF ENTERING MANHOLE
- IF SEDIMENT IS AT, OR ABOVE, 3" (80 mm) PROCEED TO STEP 2. IF NOT, PROCEED TO STEP 3.
- STEP 2) CLEAN OUT ISOLATOR ROW USING THE JETVAC PROCESS A. A FIXED CULVERT CLEANING NOZZLE WITH REAR FACING SPREAD OF 45" (1.1 m) OR MORE IS
- B. APPLY MULTIPLE PASSES OF JETVAC UNTIL BACKFLUSH WATER IS CLEAN VACUUM STRUCTURE SUMP AS REQUIRED
- STEP 3) REPLACE ALL COVERS, GRATES, FILTERS, AND LIDS; RECORD OBSERVATIONS AND ACTIONS. STEP 4) INSPECT AND CLEAN BASINS AND MANHOLES UPSTREAM OF THE STORMTECH SYSTEM.

- 1. INSPECT EVERY 6 MONTHS DURING THE FIRST YEAR OF OPERATION. ADJUST THE INSPECTION INTERVAL BASED ON PREVIOUS OBSERVATIONS OF SEDIMENT ACCUMULATION AND HIGH WATER ELEVATIONS.
- 2. CONDUCT JETTING AND VACTORING ANNUALLY OR WHEN INSPECTION SHOWS THAT MAINTENANCE IS

REVIEW

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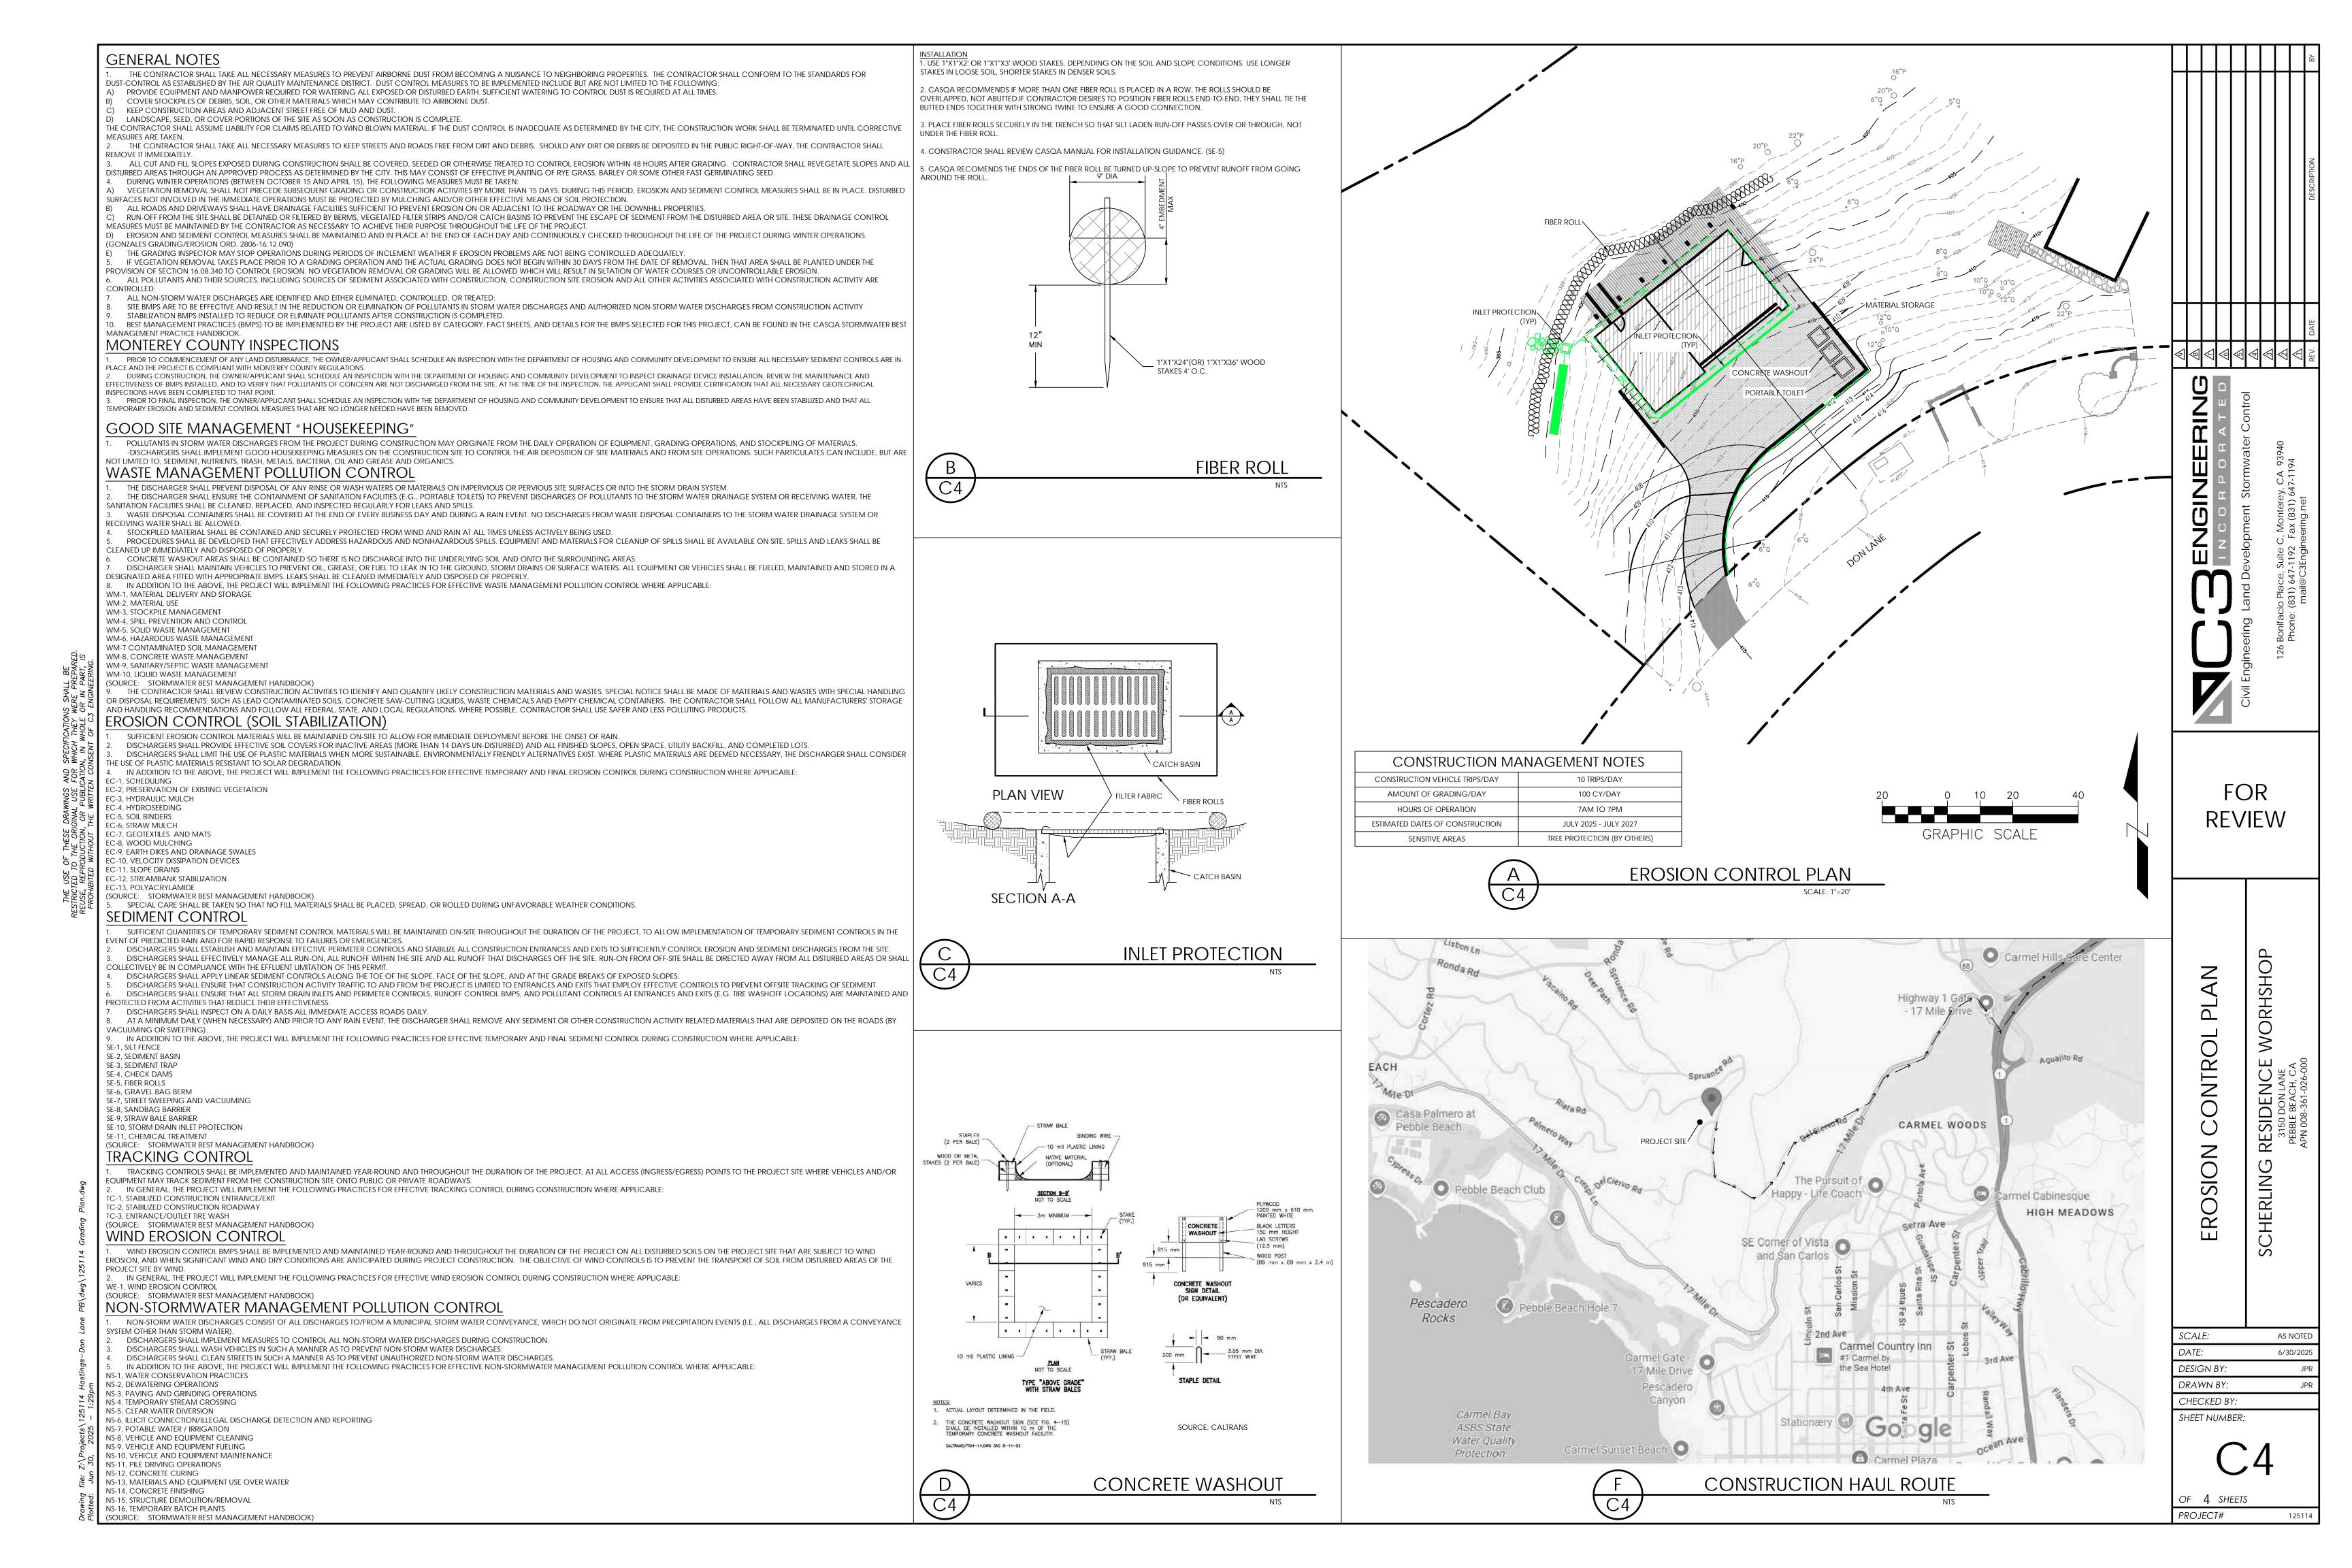
RE CHERLIN

SCALE: AS NOTED 6/30/2025 DESIGN BY: DRAWN BY: CHECKED BY: SHEET NUMBER:

PROJECT#


SC-310 6" (150 mm) INSPECTION PORT DETAIL

SC-310 CROSS SECTION DETAIL





HASTINGS CONSTRUCTION, INC.

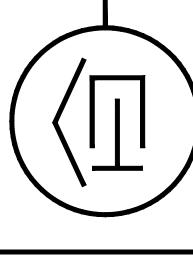


Project Address & APN:
3150 DON LANE, PEBBLE BEACH, CALIFORNIA 93953
APN: 008-361-026-000


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Project: HC-24060 Date: 7.8.2025 Drawn By: BGREEN

Scale: 1/16" = 1'-0"

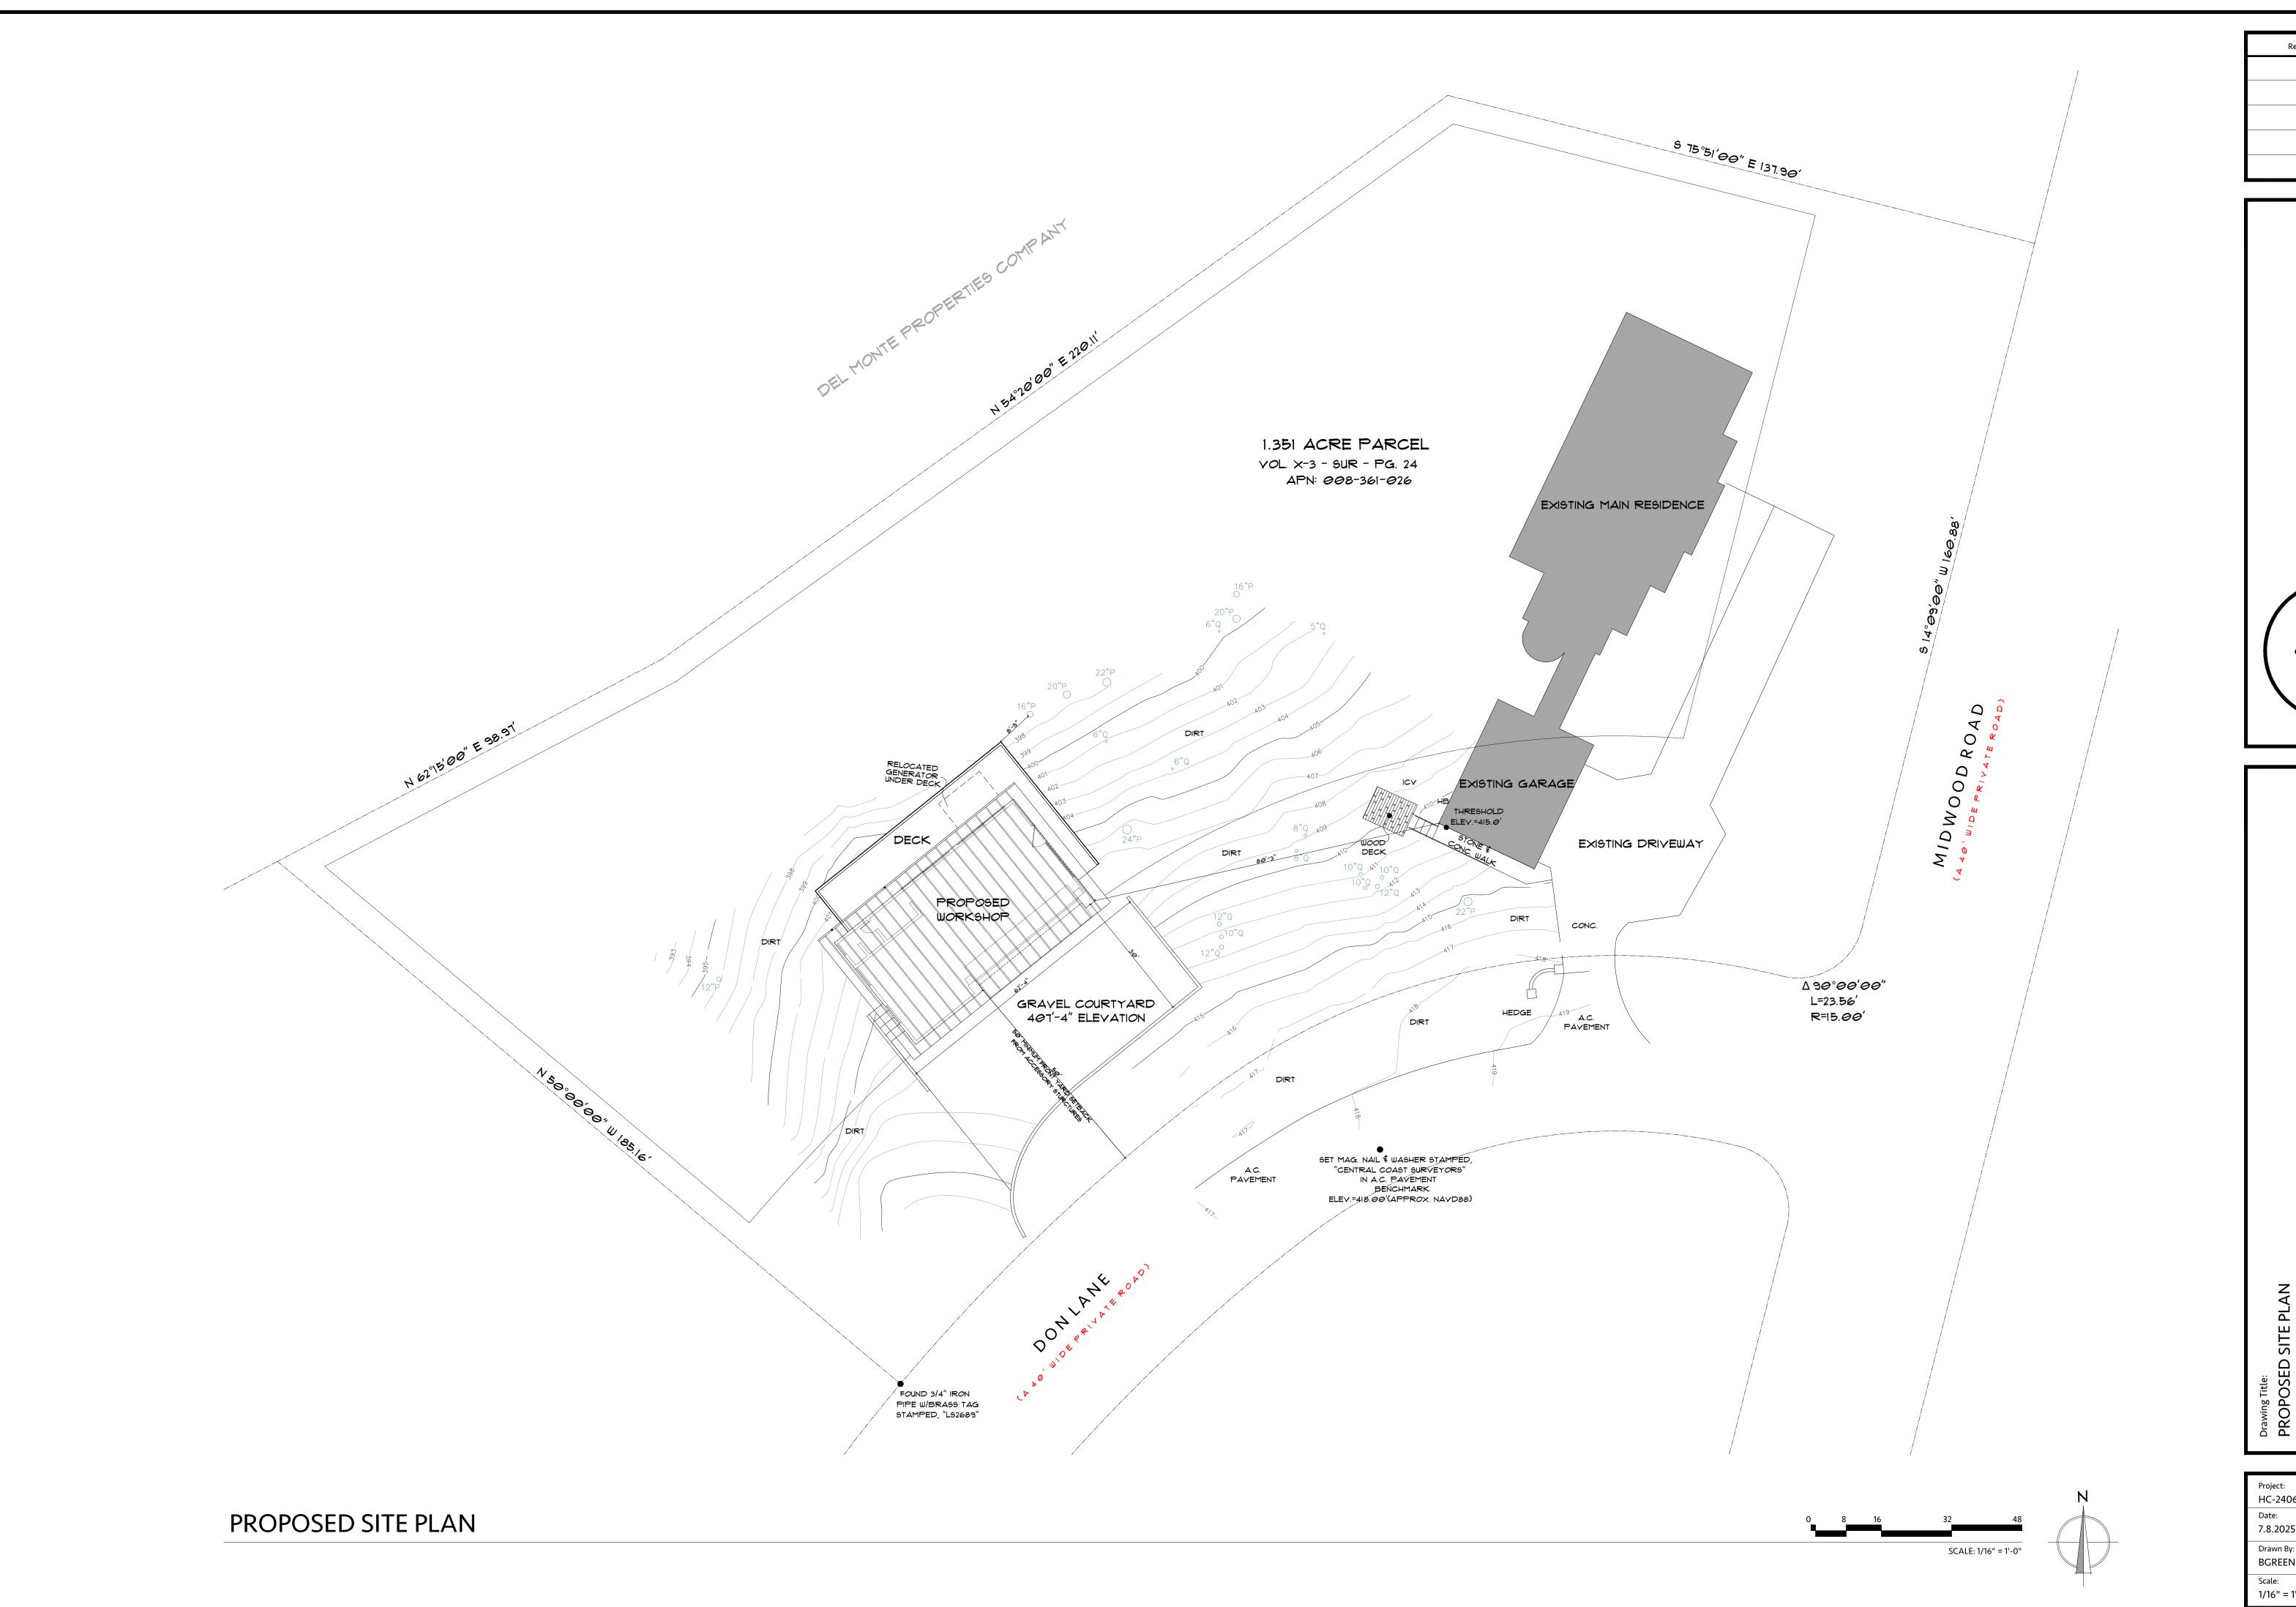


HASTINGS CONSTRUCTION, INC.

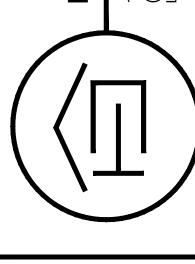



Project Address & APN:
3150 DON LANE, PEBBLE BEACH, CALIFORNIA 93953
APN: 008-361-026-000

Job Title: SCHERLING RESIDENCE WORKSHOP

Project: HC-24060 Date: 7.8.2025 Drawn By: BGREEN

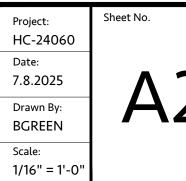

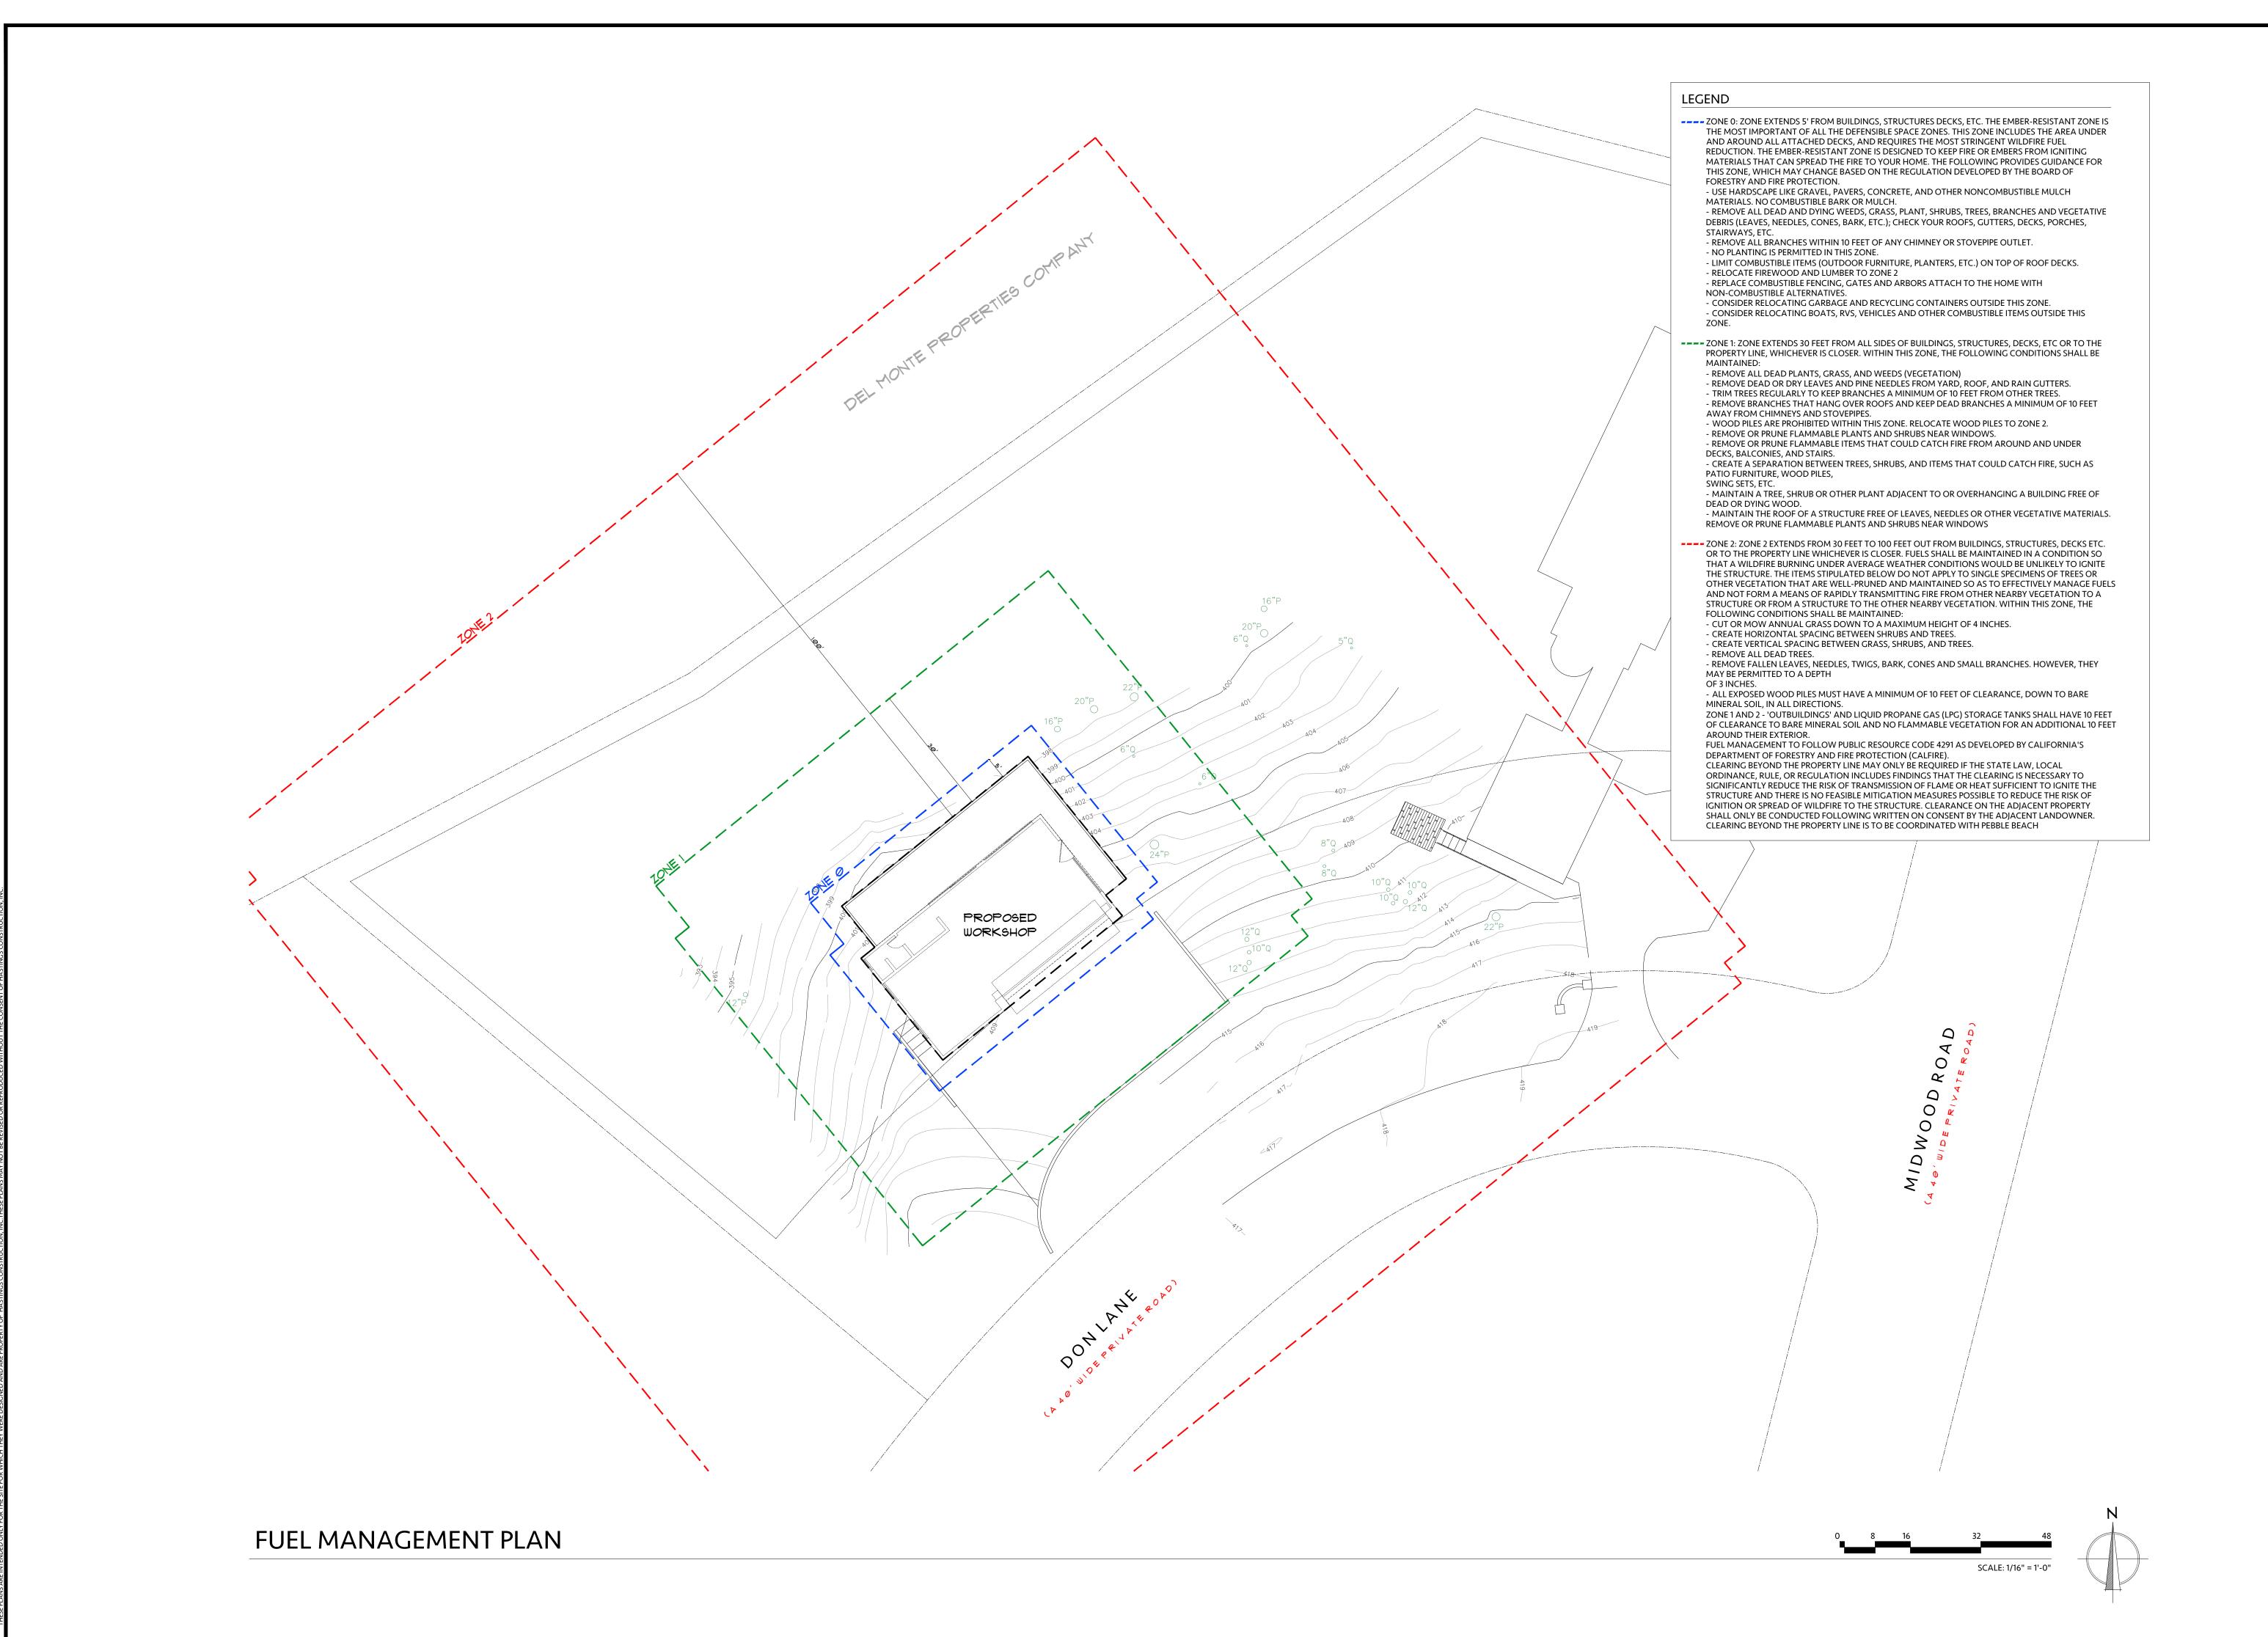

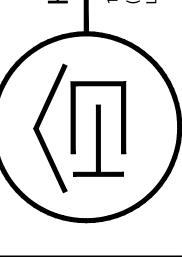


Job Title: SCHERLING RESIDENCE WORKSHOP

3150 DON LANE, PEBBLE BEACH, CALIFORNIA 93953 APN: 008-361-026-000


Project: HC-24060 Date: 7.8.2025

Drawn By: BGREEN Scale: 1/16" = 1'-0

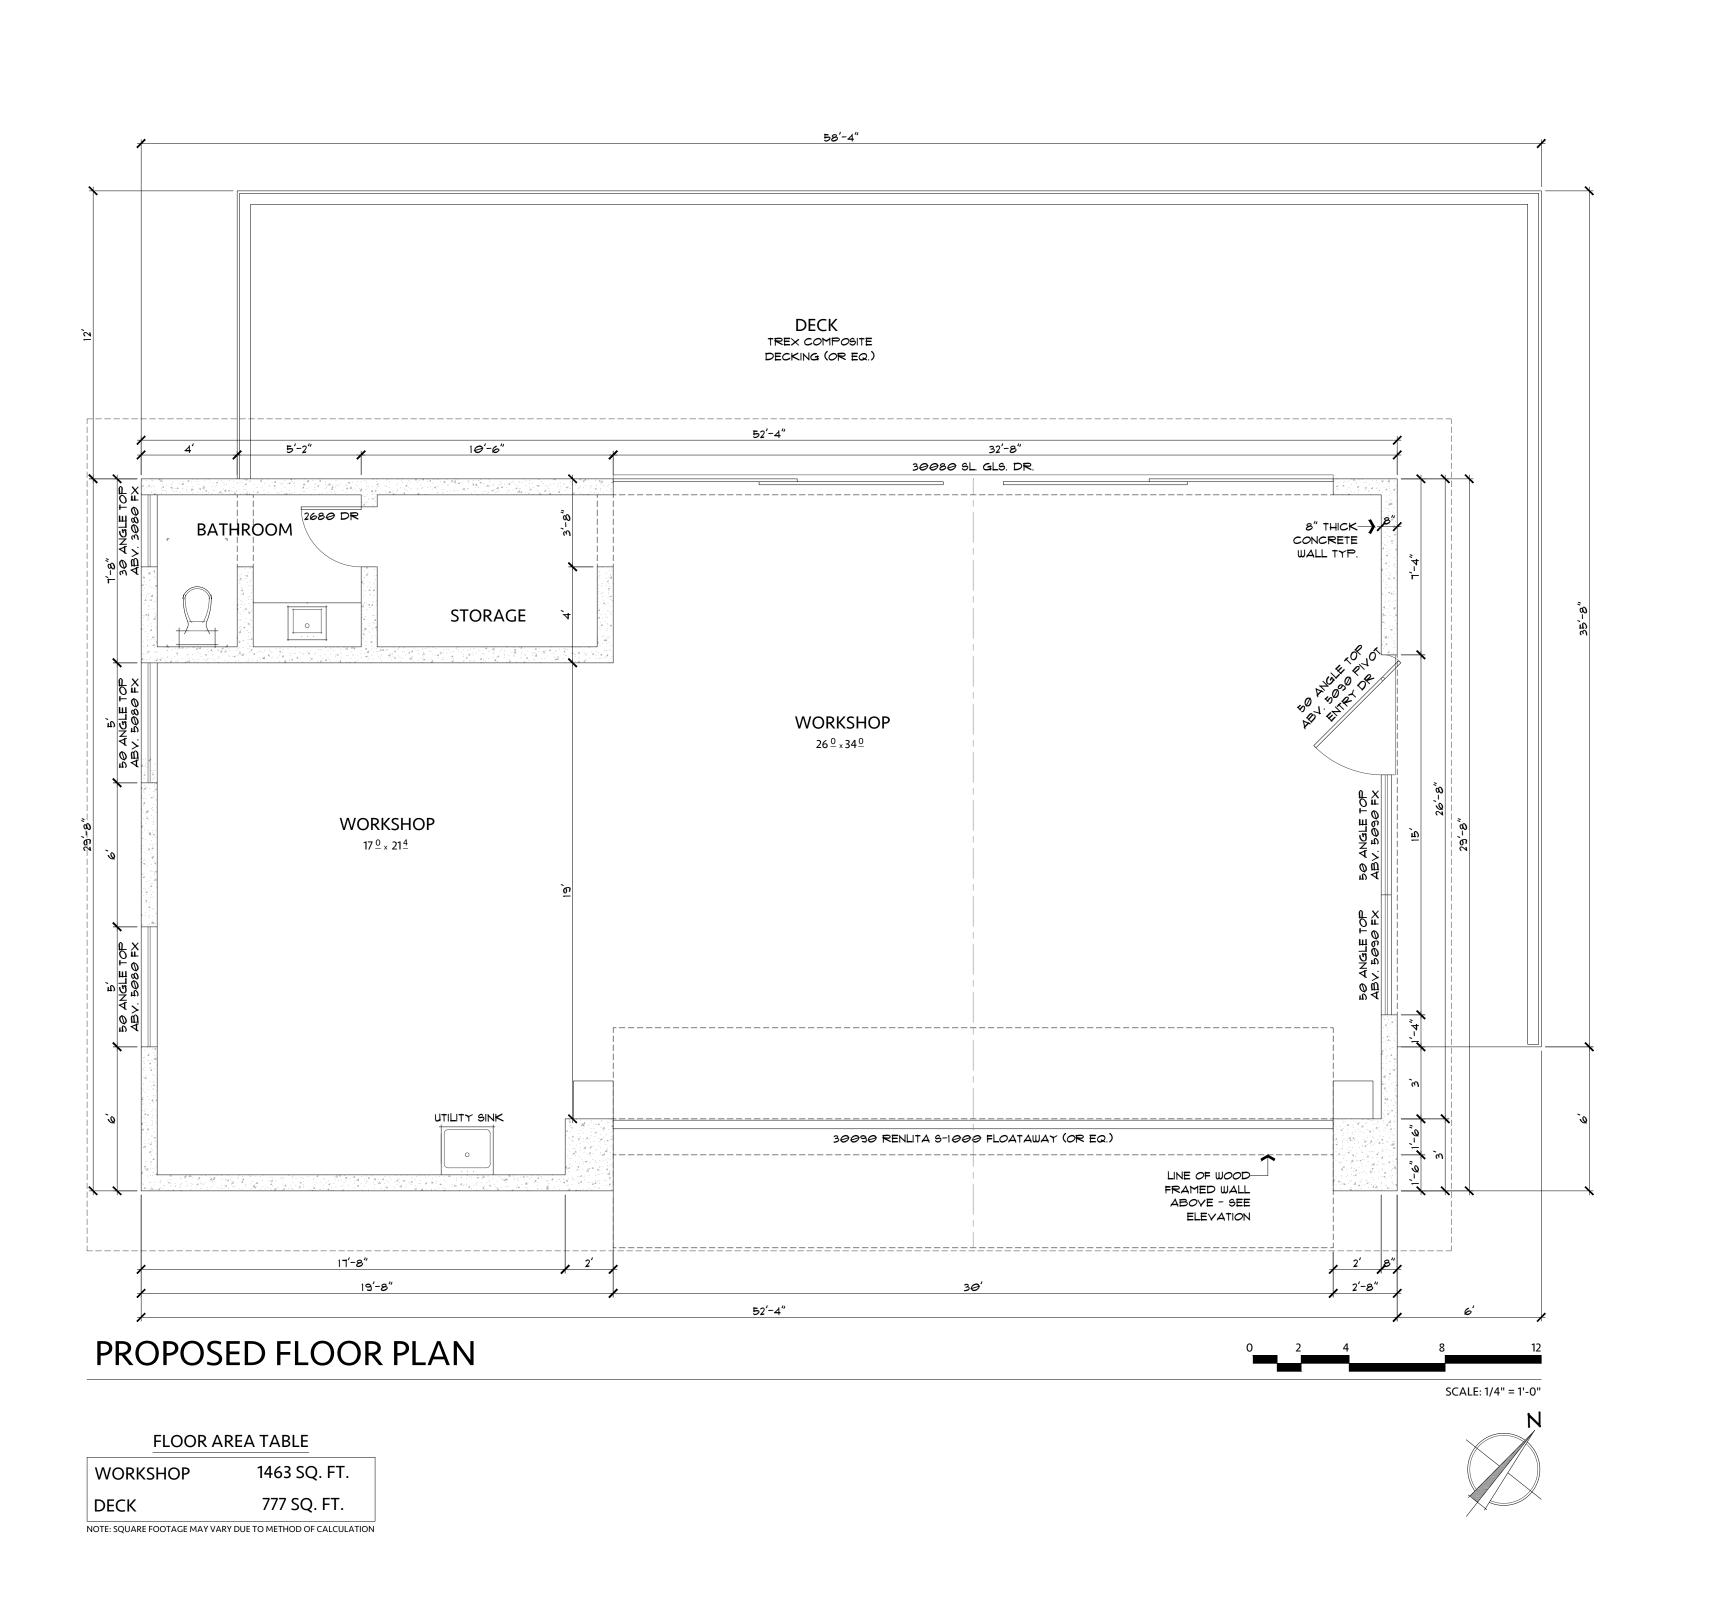


Date: 7.8.2025 Drawn By: BGREEN

Scale: 1/4" = 1'-0"

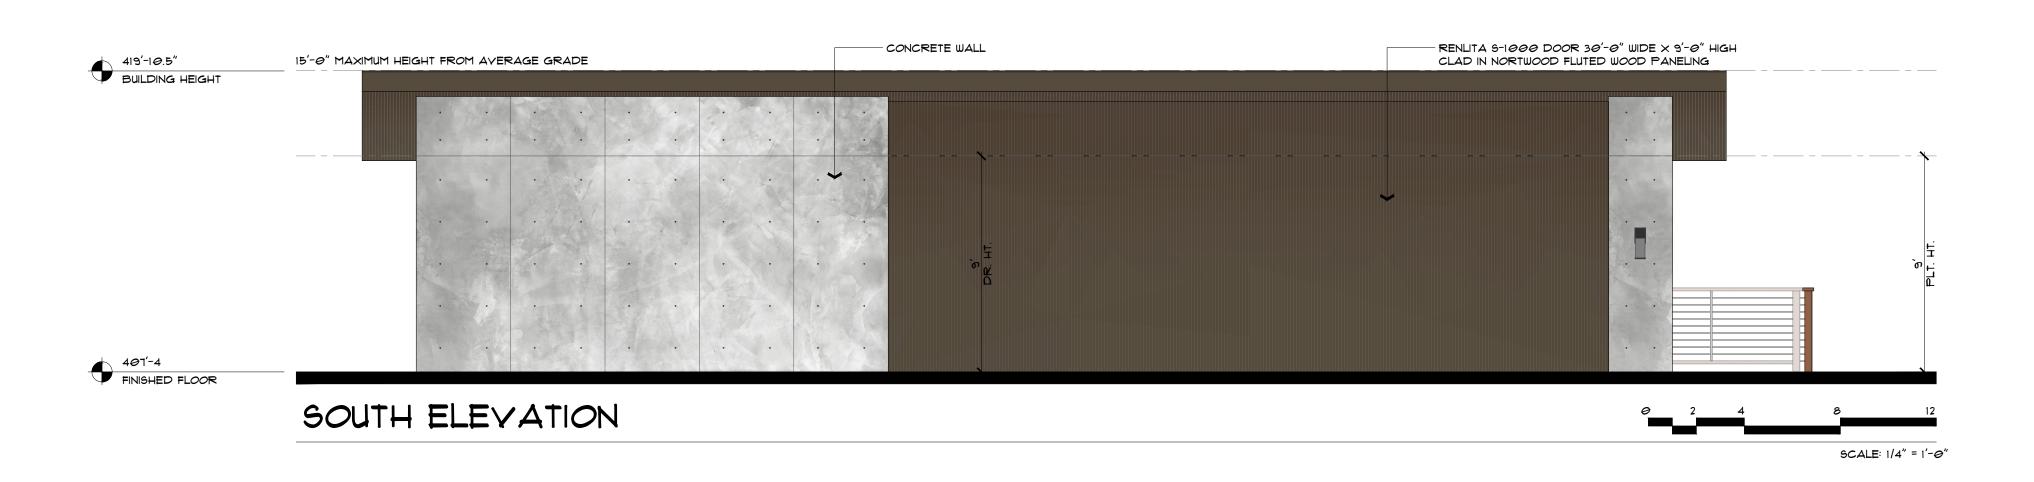



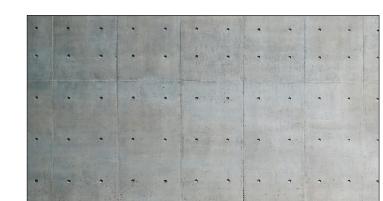


EXTERIOR SIDING BOARD FORM CONCRETE NATURAL FINISH



ROOFING METAL SALES 1" MINI BATTEN (OR EQ.) WEATHERED COPPER



EAVE AND TRIM PAINTED FASCIA SHERWIN WILLIAMS ENDURING BRONZE (SW 7055) COLOR: BRAZIL IPE

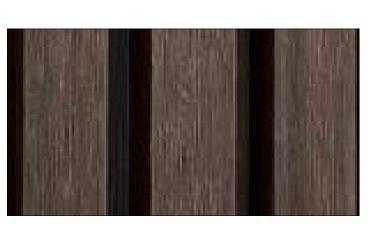


RENLITA DOOR CLADDING NORTWOOD FLUTED PANELING - ECO 25 (OR EQ.)




DECK RAILING FEENEY CABLE RAIL (OR EQ.) NATURAL WOOD WITH METAL CABLES (OR EQ.)



EXTERIOR LIGHTING HINKLEY LIGHTING (OR EQ.) ARIA SMALL WALL MOUNT LANTERN (OR EQ.)

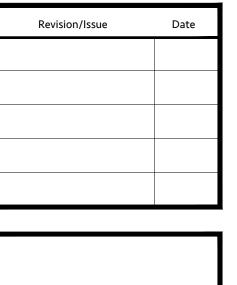

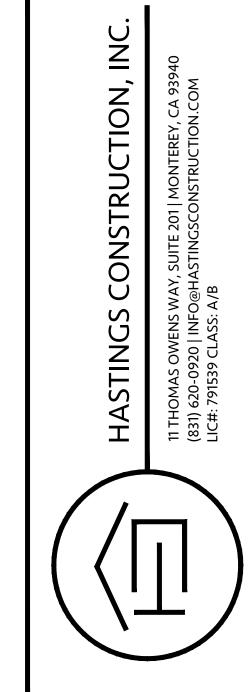



ELEVATIONS
Job Title:
SCHERLING RESIDENCE WORKSHOP
Project Address & APN:
3150 DON LANE, PEBBLE BEACH, CALIFORNIA 93953
APN: 008-361-026-000


HC-24060

7.8.2025 Drawn By: **BGREEN**

Scale: 1/4" = 1'-0"

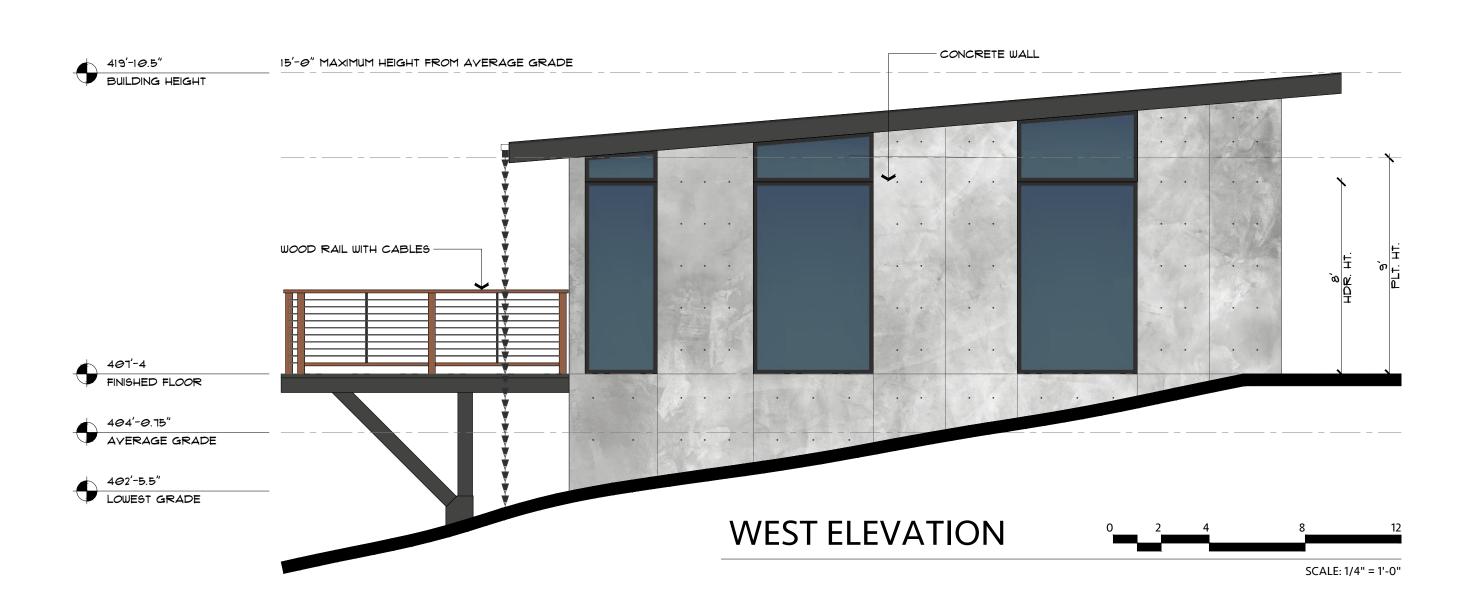


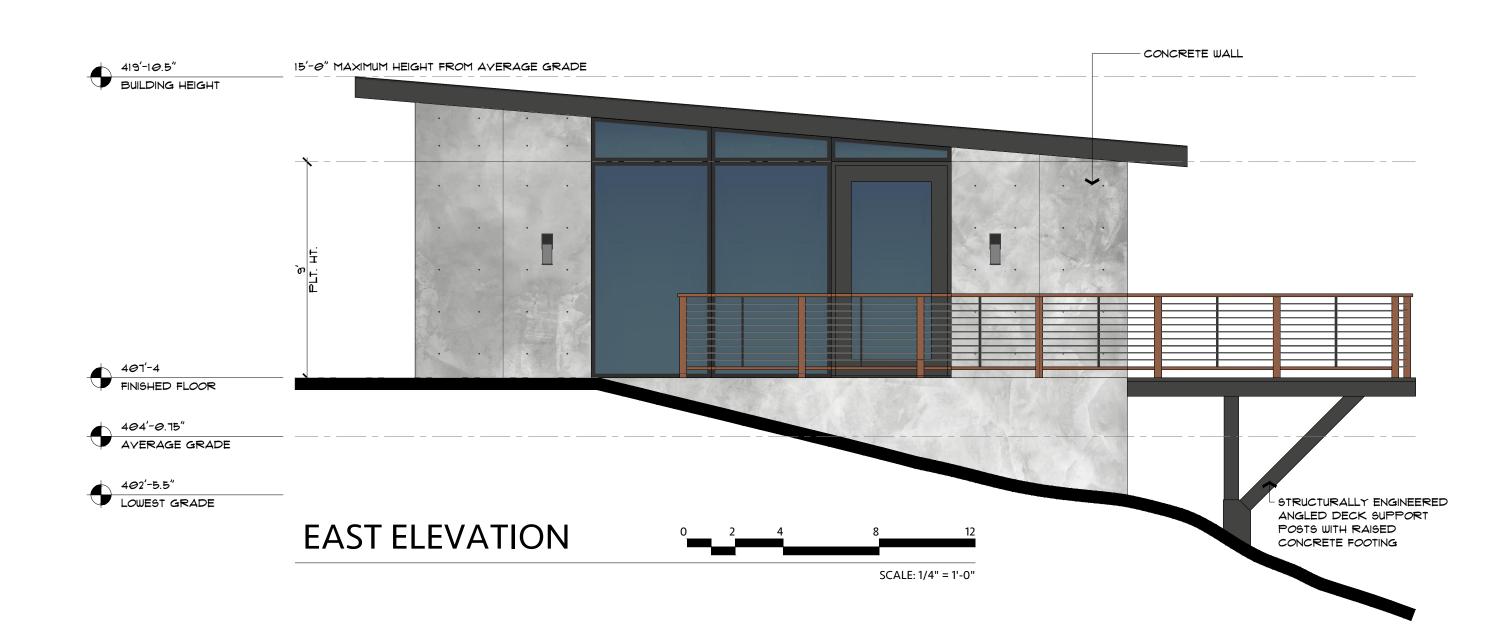

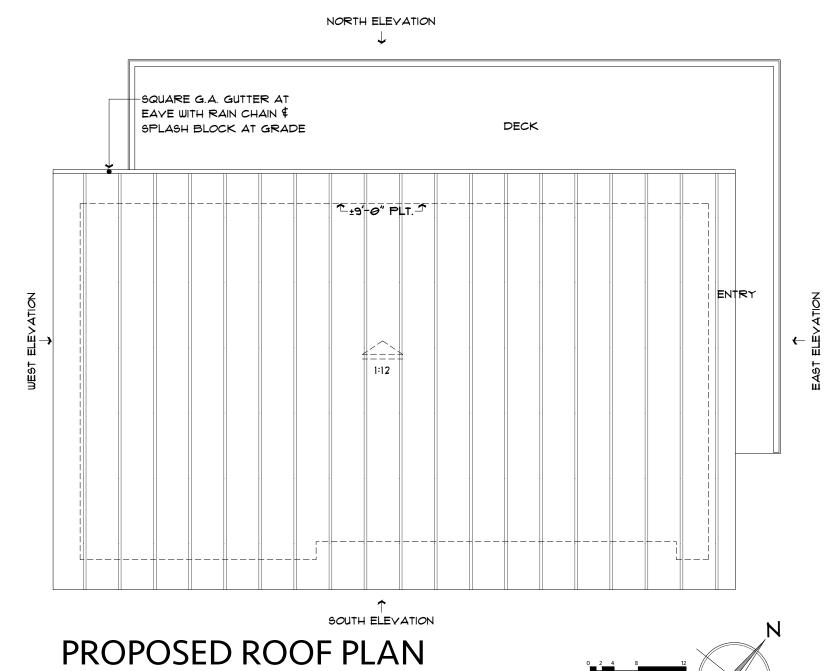

ROOF SLOPE: 1:12
RAKE OVERHANG: 30"
EAVE OVERHANG: 30"
ROOF MATERIAL: STANDING SEAM METAL
METAL SALES - 1" MINI BATTEN (OR EQ.)

Revision/Issue	Date

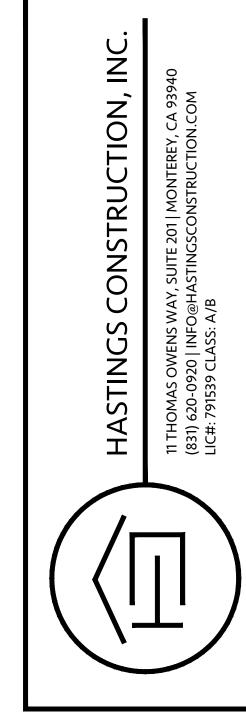

Project Address & APN:
3150 DON LANE, PEBBLE BEACH, CALIFORNIA 93953
APN: 008-361-026-000 Job Title:
SCHERLING RESIDENCE WORKSHOP

Project: HC-24060 Date: 7.8.2025 Drawn By: BGREEN Scale: 1/4" = 1'-0"