Exhibit A



DRAFT RESOLUTION

Before the Zoning Administrator in and for the County of Monterey, State of California

In the matter of the application of:

CALIFORNIA AMERICAN WATER COMPANY (Various Owners) / (PLN230172)

RESOLUTION NO. 25--

Resolution by the County of Monterey Zoning Administrator:

- 1) Finding that the project qualifies for a Class 1 Categorical Exemption pursuant to CEQA Guidelines Section 15301 and that none of the exceptions set forth in CEQA Guidelines section 15300.2 apply; and
- 2) Approving a Combined Development Permit consisting of: 1) Administrative Permit and Design Approval for the removal of one 10,000-gallon water tank, construction of two water tanks (10,000 gallons and 60,000 gallons), modifications to a 50,000-gallon water tank, construction of a bypass pipeline with a pressure control valve, and relocation of a fire hydrant; and 2) Use permit to allow development on slopes in excess of 25%.

[PLN230172 CALIFORNIA AMERICAN WATER COMPANY AND VARIOUS OWNERS: CARVELL JOHN RANDALL TR & BELLIS CAROLE HUTCHINS TR, 7 OAK MEADOW LN, CARMEL VALLEY (APN: 187-031-020-000); HOCH STEPHEN & TSCHIRGI JUDITH E, 15 OAK MEADOW LN, CARMEL VALLEY (APN: 187-031-023-000); MURRAY CONSTANCE TR, 10 OAK MEADOW LN, CARMEL VALLEY (APN: 187-031-025-000); AND SCOTT LINDA SUE & TAGG TERRYL M TRS, 6 OAK MEADOW LN, CARMEL VALLEY (187-031-027-000), CARMEL VALLEY MASTER PLAN]

The CALIFORNIA AMERICAN WATER COMPANY application (PLN230172) came on for a public hearing before the Zoning Administrator on August 28, 2025. Having considered all the written and documentary evidence, the administrative record, the staff report, oral testimony, and other evidence presented the Zoning Administrator finds and decides as follows:

FINDINGS

1. **FINDING:**

CONSISTENCY – The Project, as conditioned, is consistent with the applicable plans and policies which designate this area as appropriate for development.

EVIDENCE:

- During the course of review of this application, the project has been reviewed for consistency with the text, policies, and regulations in:
 - the 2010 Monterey County General Plan;
 - Carmel Valley Master Plan (CVMP); and
 - Monterey County Zoning Ordinance (Title 21).

No conflicts were found to exist. No communications were received during the course of review of the project indicating any inconsistencies with the text, policies, and regulations in these documents.

- Project. The proposed development includes two different sites, the Upper Rancho Fiesta Tank site and the Lower Rancho Fiesta tank site. Both sites consist of improvements to the existing water supply infrastructure that is owned and operated by the California American Water Company (CalAm) as a part of the Rancho Fiesta Subdivision water system, as well as the relocation of one fire hydrant and the construction of a bypass pipeline and pressure control valve. The Lower Rancho Fiesta Tank site is contained within an existing easement that was established at the same time as the subdivision and contains one existing 10,000-gallon water tank. The existing water tank does not meet seismic standards and needs to be replaced and upgraded in order to meet standards. A new 10,000-gallon water tank shall be installed prior to the removal of the existing water tank to ensure service is not disrupted and will be located within the same Tank site, east of the existing water infrastructure, partially buried and installed prior to the demolition of the existing water tank. The Upper Rancho Fiesta Tank site is also contained with an existing easement that was established at the time of the creation of the subdivision and contains one existing 50,000-gallon water tank. The proposed development includes modifications to this existing 50,000-gallon water tank to increase the capacity to 60,000 gallons and construct a second water tank with a capacity of 60,000 gallons. The easement and the proposed work are within an area that is sloped greater than 25%. The project includes grading of approximately 2,675 cubic yards.
- Allowed Use. The properties are located at 6, 7, 10, and 15 Oak Meadow Lane, Carmel Valley, within the Carmel Valley Master Plan. The properties at 6 Oak Meadow Lane [APN: 187-031-027-000] and 10 Oak Meadow Lane [APN: 187-031-025-000] are zoned as Low Density Residential with Building Site Zoning-6, Design Control, Site Plan Review and Residential Allocation Zoning Overlay districts, or "LDR/B-6-D-S-RAZ". The properties at 7 Oak Meadow Lane [APN: 187-031-020-000] and 15 Oak Meadow Lane [APN:187-031-023-000] are zoned as Low Density Residential, 5 acres per unit with a Design Control, Site Plan Review and Residential Allocation Zoning Overlay districts, or "LDR/5-D-S-RAZ". Pursuant to Title 21 section 21.14.030, LDR zoning allows water system storage tanks and replacement of water tanks where no increase in service connections is created. As proposed, both project sites are within established easements for the water tanks and water system facilities including storage tanks and no

increase in service connections is created. The properties are all subject to the Site Plan Review "S" Zoning district pursuant to Title 21 Chapter 21.45, which provides regulations for development, with by reason of its location, has the potential to adversely affect or be adversely affected by natural resources or site constraints and requires an Administrative Permit pursuant to these regulations. A biological resources report was included in the application which included measures to minimize potential impacts to biological resources. The applicants provided a grading and erosion control plan and geologic hazards to demonstrate the feasibility of their proposed project. No other hazards or impacts to resources were identified during staff's review of the project (See Findings 2 and 3 and supporting evidence). Therefore, the project is an allowed land use for this site.

- d) Lot Legality. Two parcels (APNs 187-031-025-000 and 187-031-027-000) are shown in their current size and configuration as Lot 4 and Lot 6, respectively, within the Rancho del Sol Subdivision (Tract No 907) in Volume 14 page 42, Cities and Towns Map. The remaining two parcels (APNs 187-031-020-000 and 187-031-023-000) are shown in their current size and configuration as Lot 1 and Lot 4, respectively, within Volume 14 page 25, Parcel Map (MS-77-227). Therefore, the County recognizes all four parcels as a legal lots of record.
- e) Design/Development Standards. The existing water tank locations are within water tank easements that were established during the creation of the subdivision. Both water tank locations are within the easement boundaries. The Upper Rancho Fiesta Tank site easement is located at 15 Oak Meadow Lane (APN: 187-031-023-000) and adjacent work is contained within an existing 15 foot wide utility easement. The proposed development at this site includes modifications to an existing 50,000-gallon water tank to increase the water capacity to 60,000 gallons with associated site improves and construct a new 60,000-gallon water tank that will be partially buried and installed adjacent to the existing tank. The Lower Rancho Fiesta Tank site easement is located at 10 Oak Meadow Lane (APN:187-031-025-000). There is an existing 10,000-gallon water tank that is partially buried and will remain in place until the new 10,000-gallon water tank has been installed. The existing tank will be demolished at that time.

Pursuant to Title 21, Chapter 21.44, the project site and surrounding area are subject to the Design Control District overlay, which regulates the location, size, configuration, materials, and colors of structures and fences to assure the protection of the public viewshed and neighborhood character. The water tanks at both Tank sites will be painted a tan color to help them blend in with the surrounding areas. The existing vegetation used to screen the tanks is proposed for removal, however, new vegetation shall be planted to screen the new water tanks and shall be implemented through the County's standard water tank approval condition. Therefore, the project, as designed and conditioned, is consistent with the applicable design control regulations.

f) <u>Biological Resources.</u> Pursuant to Title 21 section 21.66.202, a Biological Resources Report (LIB240118 – see Finding 2, Evidence

- "b") has been provided by Denise Duffy and Associates, Inc. (DD&A) with the application. A site visit was conducted and three natural communities were observed around the proposed development areas, however, no special status plant or animal species were observed during the site visit. The report noted that two special status species, the burrowing owl and the Crotch bumble bee, have the potential for being within the project site as well as raptors and other avian species have the potential to nest in trees and shrubs within or adjacent to the project site. It was also noted in the report that the California Red-legged Frog is mapped within the Lower Rancho Fiesta Tank project site but has a low potential to occur within the project site. Consistent with General Plan Policy OS-5.4, the project has been sited in an area to avoid any potential impacts to special status species that may occur on the site. The proposed project will be sited adjacent to existing infrastructure and areas previously disturbed for the construction of the existing water tanks and associated water pipes. The report recommends the following specific measure to be incorporated into the project, and therefore minimizing impacts: a preconstruction meeting with the biologist to educate the construction crew to identify special-status species, tree and root protection, implementing erosion control measures for all grading, excavation and other ground-disturbing activities, all food-related trash to be fully enclosed and disposed of at least once per week to avoid attracting wildlife, and all temporarily disturbed areas shall be returned to pre-project contours and revegetated with a native seed mix. Additionally, the biologist recommended for construction activities to be scheduled between October 31 and February 1 to avoid disturbing the Crotch bumble bee's lifecycle, a pre-construction survey for active burrowing owl nests within 250 feet of the project site, and for construction activities to be scheduled between September 15 and February 1 to avoid raptor and bird nesting activities; and will be implemented through the County's standard conditions for notice of report and tree and root protection. In accordance with the Migratory Bird Treaty Act, a pre-construction nesting survey will be required through implementation of the County's standard condition.
- Development on Slopes in Excess of 25%. The proposed project includes approximately 2,675 cubic yards of cut, which includes 6,990 square feet of development on slopes in excess of 25%. Pursuant to General Plan OS-3.5, development on slopes in excess of 25% may be allowed pursuant to a Use Permit. Therefore, the project is subject to the granting of a Use Permit. The project meets the required findings to allow existing and proposed development on slopes in excess of 25%, as demonstrated in Finding No. 5 and supporting evidence.
- Cultural Resources. According to Monterey County Geographic Information System (GIS) records, the subject parcel has a moderate archaeological sensitivity, is not within 250 feet of a known archaeological resource, and is Categorically Exempt from CEQA review, see Finding No. 6 and supporting evidence. Therefore, no archaeological assessment was prepared for the project pursuant to Title 21 Section 21.66.050.C. The potential for inadvertent impacts to cultural resources is limited and will be controlled by use of the County's

- standard condition, which requires the contractor to stop work if previously unidentified resources are discovered during construction
- i) Geologic Hazards. The Monterey County GIS records identified a fault in proximity to the proposed well location. Further investigation has been reported (LIB250225) and confirmed that the fault, identified as the Pfeiffer Fault, is no longer active and does not pose a hazard or threat to the proposed project or surrounding area. (see Finding 1, evidence "c")
- Land Use Advisory Committee (LUAC) Review. County staff referred i) the project to the Carmel Valley Land Use Advisory Committee (LUAC) for review. The LUAC reviewed the project at a duly noticed public meeting on April 7, 2025. The Rancho Fiesta Subdivision Homeowners Association (HOA) were in attendance at the meeting and brought up concerns that the private road upon which CalAm will be using to gain access to the water tank locations might be damaged during construction. Since the road is privately owned, all repairs to the road are paid by the HOA directly. County Staff took the comment into consideration and recommended that the HOA pursue an agreement with CalAm privately to address any potential damages and repairs that may occur during construction. The LUAC brought up visual impacts of the water tanks and recommended for vegetative screening to reduce visual impacts. The project has been conditioned to ensure the appropriate screening is applied and thus being subordinate to the surrounding environment (see evidence "e"). The LUAC voted 6-0 to support the project with recommendations.
- k) The application, project plans, and related support materials submitted by the project applicant to County of Monterey HCD-Planning found in Project File PLN230172.
- 2. FINDING: SITE SU

SITE SUITABILITY – The site is physically suitable for the proposed development and/or use.

EVIDENCE:

- The project has been reviewed for site suitability by the following departments and agencies: HCD-Planning, HCD-Engineering Services, HCD-Environmental Services, Environmental Health Bureau, and Monterey County Regional Fire Protection District. County staff reviewed the application materials and plans to verify that the project on the subject site conforms to the applicable plans and regulations, and there has been no indication from these departments/agencies that the site is not suitable for the development. Conditions recommended have been incorporated.
- b) Staff identified potential impacts to biological resources, geological hazards and soil/slope impacts. The following reports have been prepared:
 - "Biological Resources Report" (LIB240118) prepared by Denise Duffy & Associates, Inc., Monterey, CA, November 2023.
 - "Geotechnical Investigation" (LIB240119) prepared by Pacific Crest Engineering, Inc., Watsonville, CA, July 11, 2023.
 - "Preliminary Geological Investigation" (LIB250225) prepared by Pacific Crest Engineering, Inc., Watsonville, CA, November 15, 2024.

- County staff independently reviewed these reports and concurs with their conclusions. There are no physical or environmental constraints that would indicate that the site is not suitable for the use. All development shall be in accordance with these reports.
- c) Geological Hazards In accordance with Title 21 section 21.66.040, a geologic report shall be required if the project site is in any area of known or suspected geologic hazards. The GIS records show that the Laureles Fault is within proximity of the project sites. A Geological Investigation Report (LIB250225 see Finding 2, Evidence "b") confirmed that the fault is not active and there is no presence of ground water that would interfere with the underground tanks, and does not pose a threat to the proposed development.
- d) The application, project plans, and related support materials submitted by the project applicant to County of Monterey HCD-Planning found in Project File PLN230172.

3. FINDING:

HEALTH AND SAFETY – The establishment, maintenance, or operation of the project applied for will not under the circumstances of this particular case be detrimental to the health, safety, peace, morals, comfort, and general welfare of persons residing or working in the neighborhood of such proposed use, or be detrimental or injurious to property and improvements in the neighborhood or to the general welfare of the County.`

EVIDENCE:

- The project was reviewed by HCD-Planning, HCD- Engineering Services, HCD-Environmental Services, Environmental Health Bureau, and Monterey County Regional Fire Protection District. The respective agencies have recommended conditions, where appropriate, to ensure that the project will not have an adverse effect on the health, safety, and welfare of persons either residing or working in the neighborhood.
- b) Potable Water is provided by CalAm within the Racho Fiesta Subdivision; however, the purpose of the water storage tanks is for fire suppression and will not be used as potable water. The Environmental Health Bureau (EHB) reviewed the application and is requiring the water system improvement to be reviewed and accepted by the State Water Resources Control Board and shall be implemented through a special condition.
- c) The application, project plans, and related support materials submitted by the project applicant to County of Monterey HCD-Planning found in Project File PLN230172.

4. FINDING:

NO VIOLATIONS – The subject property is in compliance with all rules and regulations pertaining to zoning uses, subdivision, and any other applicable provisions of the County's zoning ordinance. No violations exist on the property.

EVIDENCE:

- a) Staff reviewed County of Monterey HCD-Planning and HCD-Building Services records and is not aware of any violations existing on subject property.
- b) The application, project plans, and related support materials submitted by the project applicant to County of Monterey HCD-Planning found in Project File PLN230172.

5. FINDING: DEVELOPMENT ON SLOPES IN EXCESS OF 25% - The

Proposed Project is located in the most feasible location, minimizes development on slopes in excess of 25 percent, and better measures the resource protection goals and policies of the 2010 General Plan and Carmel Valley Master Plan.

EVIDENCE:

- The project consists of grading approximately 2,675 cubic yards of cut to accommodate the removal of one existing 10,000-gallon water tanks, construction of two water tanks (10,000-gallons and 60,000 gallons), and modifications to an existing 50,000 water tank. The proposed two water tanks will be partially submerged into the ground. The area known as the Upper Rancho Fiesta Tank easement is heavily sloped and the proposed development includes approximately 6,990 square feet of grading and excavation that will occur on slopes in excess of 25%.
- b) As proposed, a portion of work designated at the Upper Rancho Fiesta Tank is within slopes in excess of 25%. The site is within an existing water tank easement that was established at the same time as the subdivision that the water tanks are designated for. The water tanks will hold a total of 130,000 gallons that will only be used as fire suppression in the event of a fire hazard. The location is ideal as it is at the uppermost section of the neighborhood and relies on gravity feed to help maintain the proper water pressure for the Lower Rancho Fiesta Tank as well as the fire hydrant. Other sites were assessed and no other feasible alternatives were identified for the proposed water tanks. Additionally, the proposed water tanks would connect to existing infrastructure, thereby reducing the amount of additional ground disturbance and impacts to slopes greater than 25%.
- c) Carmel Valley Master Plan Policy CV-3.22 states that non-agricultural development on slopes in excess of 25% that is not on highly erodible soils shall be subject to the General Plan Policy 3.5(1). A geotechnical Investigation Report (LIB240119) confirmed that the soils at each proposed development location is not highly erodible and therefore Policy 3.5(1) would apply.
- d) The proposed development includes a total of two new water tanks and modifications to an existing water tank, capable of holding up to 130,000 gallons of water combined are solely designated for fire suppression. The GIS records show that the Rancho Fiesta neighborhood is within a very high fire hazard zone and the placement of the water tanks are essential to minimize loss of life and maintain safety of the neighborhood inhabitants in the event of a fire. Therefore, the proposed development better achieves the goals, policies, and objectives of the County of Monterey General Plan and Carmel Valley Master Plan.
- e) The application, plans, and supporting materials submitted by the project applicant to County of Monterey HCD-Planning for the proposed development are found in Project File PLN230172.

6. **FINDING:** CEQA (Exempt) – The project is categorically exempt from environmental review and no unusual circumstances were identified to exist for the proposed project.

EVIDENCE: a) California Environmental Quality Act (CEQA) Guidelines Section 15301, categorically exempts maintenance or minor alterations of

- existing private facilities and equipment that involve no expansion of use.
- b) The project consists of the alteration and maintenance to two existing water tanks as well as two additional water tanks that does not result in any new water connections, and moving the location of a fire hydrant within previously disturbed areas. The water tanks will remain located within an already established water tank easement within a residential neighborhood.
- c) None of the exceptions under CEQA Guidelines Section 15300.2 apply to this project. A Biological Assessment was provided with the project application concluding that there are no significant impacts to ESHA (see Finding 1, Evidence "f"). No adverse environmental effects were identified during staff review of the development application. Therefore, there is no significant effect on the environment due to unusual circumstances. There are no successive projects of similar size and location would not contribute to a cumulative impact and no new land use is proposed.
- d) The project does not propose to remove any scenic resources such as trees. The closest scenic roads are Laureles Grade, which is approximately 0.36 miles east of the site and Carmel Valley Road, which is approximately 0.6 miles south of the site. No development from this project will be visible from the scenic roads.
- e) See supporting Finding Nos. 1 and 2. The application, project plans, and related support materials submitted by the project applicant to County of Monterey HCD-Planning found in Project File PLN230172.
- 7. **FINDING:** APPEALABILITY The decision on this project may be appealed to the Planning Commission.
 - **EVIDENCE:** Pursuant to Title 21 Section 21.80.040, the project is subject to appeal to the Planning Commission because it requires the Zoning Administrator to make a discretionary decision.

DECISION

NOW, THEREFORE, based on the above findings and evidence, the Planning Commission does hereby:

- 1. Find that the project qualifies for a Class 1 Categorical Exemption pursuant to CEQA Guidelines Section 15301 and that none of the exceptions set forth in CEQA Guidelines section 15300.2 apply; and
- 2. Approve a Combined Development Permit consisting of: 1) Administrative Permit and Design Approval for the removal of one 10,000-gallon water tank, construction of two water tanks (10,000 gallons and 60,000 gallons), modifications to a 50,000-gallon water

tank, construction of a bypass pipeline with a pressure control valve, and relocation of a fire hydrant; and 2) Use permit to allow development on slopes in excess of 25%. All of which are in general conformance with the attached sketch and subject to the attached conditions, all being attached hereto and incorporated herein by reference.

PASSED AND ADOPTED this 28th day of August, 2025.

	Mike Novo, AICP
Z	oning Administrator

COPY OF THIS DECISION MAILED TO APPLICANT ON DATE

THIS APPLICATION IS APPEALABLE TO THE PLANNING COMMISSION.

IF ANYONE WISHES TO APPEAL THIS DECISION, AN APPEAL FORM MUST BE COMPLETED AND SUBMITTED TO THE SECRETARY OF THE PLANNING ALONG WITH THE APPROPRIATE FILING FEE ON OR BEFORE DATE.

This decision, if this is the final administrative decision, is subject to judicial review pursuant to California Code of Civil Procedure Sections 1094.5 and 1094.6. Any Petition for Writ of Mandate must be filed with the Court no later than the 90th day following the date on which this decision becomes final.

NOTES

You will need a building permit and must comply with the Monterey County Building Ordinance 1. in every respect.

Additionally, the Zoning Ordinance provides that no building permit shall be issued, nor any use conducted, otherwise than in accordance with the conditions and terms of the permit granted or until ten days after the mailing of notice of the granting of the permit by the appropriate authority, or after granting of the permit by the Board of Supervisors in the event of appeal.

Do not start any construction or occupy any building until you have obtained the necessary permits and use clearances from Monterey County HCD-Planning and HCD-Building Services Department office in Salinas.

This permit expires 3 years after the above date of granting thereof unless construction or use is 2. started within this period.

Form Rev. 1-27-2021

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Exhibit A



County of Monterey HCD Planning

DRAFT Conditions of Approval/Implementation Plan/Mitigation Monitoring and Reporting Plan

PLN230172

1. PD001 - SPECIFIC USES ONLY

Responsible Department:

Planning

Condition/Mitigation Monitoring Measure: This Combined Development Permit (PLN230172) allows the removal one 10,000-gallon water tank, construction of two water tanks (10,000-gallons 60,000-gallons), modifications to an existing 50,000-gallon water tank, construction of a bypass pipeline with a pressure control valve, relocation of a fire hydrant on slopes in excess of 25%. The property is located at 6, 7, 10, and 15 Oak Meadow Lane, Carmel Valley (Assessor's Parcel 187-031-020-000, Numbers 187-031-023-000. 187-031-025-000, 187-031-027-000), Carmel Valley Master Plan. This permit was approved in accordance with County ordinances and land use regulations subject to the terms and conditions described in the project file. Neither the uses nor the construction allowed by this permit shall commence unless and until all of the conditions of this permit are met to the satisfaction of the Director of HCD - Planning. Any use or construction not in substantial conformance with the terms and conditions of this permit is a violation of County regulations and may result in modification or revocation of this permit and subsequent legal action. No use or construction other than that specified by this permit is allowed unless additional permits are approved by the appropriate authorities. To the extent that the County has delegated any condition compliance or mitigation monitoring to the Monterey County Water Resources Agency, the Water Resources Agency shall provide all information requested by the County and the County shall bear ultimate responsibility to ensure that conditions and mitigation measures are properly fulfilled. (HCD - Planning)

Compliance or Monitoring Action to be Performed: The Owner/Applicant shall adhere to conditions and uses specified in the permit on an on-going basis unless otherwise stated.

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2. PD002 - NOTICE PERMIT APPROVAL

Responsible Department:

Planning

Condition/Mitigation Monitoring Measure:

The applicant shall record a Permit Approval Notice. This notice shall state:

"A Combined Development Permit (Resolution Number ______) was approved by the Zoning Administrator for Assessor's Parcel Numbers 187-031-020-000, 187-031-023-000, 187-031-025-000, and 187-031-027-000 on August 28, 2025. The permit was granted subject to 10 conditions of approval which run with the land. A copy of the permit is on file with Monterey County HCD - Planning."

Proof of recordation of this notice shall be furnished to the Director of HCD - Planning prior to issuance of grading and building permits, Certificates of Compliance, or commencement of use, whichever occurs first and as applicable. (HCD - Planning)

Compliance or Monitoring Action to be Performed:

Prior to the issuance of grading and building permits, certificates of compliance, or commencement of use, whichever occurs first and as applicable, the Owner/Applicant shall provide proof of recordation of this notice to the HCD - Planning.

3. PD003(A) - CULTURAL RESOURCES NEGATIVE ARCHAEOLOGICAL REPORT

Responsible Department:

Planning

Condition/Mitigation Monitoring Measure:

construction, cultural, during the course of archaeological, paleontological resources are uncovered at the site (surface or subsurface resources) work shall be halted immediately within 50 meters (165 feet) of the find until a qualified professional archaeologist can evaluate it. Monterey County HCD - Planning and a archaeologist registered qualified archaeologist (i.e., an with the Register Professional Archaeologists) shall be immediately contacted by the responsible individual present on-site. When contacted, the project planner and the archaeologist shall immediately visit the site to determine the extent of the resources and to develop proper mitigation measures required for recovery. (HCD - Planning)

Compliance or Monitoring Action to be Performed:

The Owner/Applicant shall adhere to this condition on an on-going basis.

Prior to the issuance of grading or building permits and/or prior to the recordation of the final/parcel map, whichever occurs first, the Owner/Applicant shall include requirements of this condition as a note on all grading and building plans. The note shall state "Stop work within 50 meters (165 feet) of uncovered resource and contact Monterey County HCD - Planning and a qualified archaeologist immediately if cultural, archaeological, historical or paleontological resources are uncovered."

When contacted, the project planner and the archaeologist shall immediately visit the site to determine the extent of the resources and to develop proper mitigation measures required for the discovery.

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4. PD006(A) - CONDITION COMPLIANCE FEE

Responsible Department:

Planning

Condition/Mitigation Monitoring Measure:

The Owner/Applicant shall pay the Condition Compliance fee, as set forth in the fee schedule adopted by the Board of Supervisors, for the staff time required to satisfy conditions of approval. The fee in effect at the time of payment shall be paid prior to clearing any conditions of approval.

Compliance or Monitoring Action to be Performed:

Prior to clearance of conditions, the Owner/Applicant shall pay the Condition Compliance fee, as set forth in the fee schedule adopted by the Board of Supervisors.

5. PD016 - NOTICE OF REPORT

Responsible Department:

Planning

Condition/Mitigation Monitoring Measure:

Prior to issuance of building or grading permits, a notice shall be recorded with the Monterey County Recorder which states:

"A(n) [the Name of the report] (Library No. LIB***), was prepared by [report preparer Name] on [Date of the report] and is on file in Monterey County HCD - Planning. All development shall be in accordance with this report."

(HCD - Planning)

Compliance or Monitoring Action to be Performed:

Prior to the issuance of grading and building permits, the Owner/Applicant shall submit proof of recordation of this notice to HCD - Planning.

Prior to occupancy, the Owner/Applicant shall submit proof, for review and approval, that all development has been implemented in accordance with the report to the HCD - Planning.

6. PD038 - WATER TANK APPROVAL

Responsible Department:

Planning

Condition/Mitigation Monitoring Measure: The water tank shall be painted an earth tone color to blend into the area and landscaped (including land sculpturing and fencing, where appropriate), subject to the approval of the Director of HCD - Planning, prior to the issuance of building permits. (HCD - Planning)

Compliance or Monitoring Action to be Performed:

Prior to the issuance of grading or building permits, the Owner/Applicant shall submit proposed color of water tank and landscaping plans to HCD - Planning for review and approval.

Prior to final inspection or occupancy, the Owner/Applicant shall provide evidence to the Director of HCD - Planning that the water tank has been painted and the landscaping has been installed according to the plans approved by HCD - Planning.

On an on-going basis, the Owner/Applicant shall continuously maintain all landscaped areas and fences; all plant material shall be continuously maintained in a litter-free, weed-free, healthy, growing condition.

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7. PD050 - RAPTOR/MIGRATORY BIRD NESTING

Responsible Department:

Planning

Condition/Mitigation Monitoring Measure:

Any tree removal activity that occurs during the typical bird nesting season (February 22-August 1), the County of Monterey shall require that the project applicant retain a County qualified biologist to perform a nest survey in order to determine if any active raptor or migratory bird nests occur within the project site or within 300 feet of proposed tree removal activity. During the typical nesting season, the survey shall be conducted no more than 30 days prior to ground disturbance or tree removal. If nesting birds are found on the project site, an appropriate buffer plan shall be established by the project biologist. (HCD - Planning)

Compliance or Monitoring Action to be Performed:

No more than 30 days prior to ground disturbance or tree removal, the Owner/Applicant/Tree Removal Contractor shall submit to HCD -Planning a nest survey prepare by a County qualified biologist to determine if any active raptor or migratory bird nests occur within the project site or immediate vicinity.

8. PD011 - TREE AND ROOT PROTECTION

Responsible Department:

Planning

Condition/Mitigation Monitoring Measure:

Trees which are located close to construction site(s) shall be protected from inadvertent damage from construction equipment by fencing off the canopy driplines and/or critical root zones (whichever is greater) with protective materials, wrapping trunks with protective materials, avoiding fill of any type against the base of the trunks and avoiding an increase in soil depth at the feeding zone or drip-line of the retained trees. Said protection, approved by certified arborist, shall be demonstrated prior to issuance of building permits subject to the approval of HCD - Director of Planning. If there is any potential for damage, all work must stop in the area and a report, with mitigation measures, shall be submitted by certified arborist. Should any additional trees not included in this permit be harmed, during grading or construction activities, in such a way where removal is required, the owner/applicant shall obtain required permits. (HCD - Planning)

Compliance or Monitoring Action to be Performed:

Prior to issuance of grading and/or building permits, the Owner/Applicant shall submit evidence of tree protection to HCD - Planning for review and approval.

During construction, the Owner/Applicant/Arborist shall submit on-going evidence that tree protection measures are in place through out grading and construction phases. If damage is possible, submit an interim report prepared by a certified arborist.

Prior to final inspection, the Owner/Applicant shall submit photos of the trees on the property to HCD-Planning after construction to document that tree protection has been successful or if follow-up remediation or additional permits are required.

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9. EHSP01 - DESIGN WATER SYSTEM IMPROVEMENTS (Non-Standard)

Responsible Department: Health Department

Condition/Mitigation
Monitoring Measure:

The water system improvement design shall be reviewed and accepted by the State
Water Resources Control Board, Division of Drinking Water prior to construction, as

specified by California Code of Regulations, Title 22, Section 64585, Subsection (b)).

(Environmental Health)

Compliance or Monitoring Action to be Performed: Prior to issuance of construction permit, the applicant shall submit evidence to the Environmental Health Bureau that the water system improvement design has been accepted by the State Water Resources Co0ntrol Board, Division of Drinking Water.

10. CALIFORNIA CONSTRUCTION GENERAL PERMIT

Responsible Department: Environmental Services

Condition/Mitigation Monitoring Measure:

The proposed project would disturb greater than one or more acres of soil, and therefore, is required to obtain coverage under the General Permit for Discharges of Storm Water Associated with Construction Activity Construction General Permit Order 2009-0009-DWQ. Construction activity subject to this permit includes clearing, grading and disturbances to the ground such as stockpiling, or excavation, but does not include regular maintenance activities performed to restore the original line, grade, or capacity of the facility.

If the project is exempt from obtaining coverage under the California Construction General Permit, the applicant shall provide a letter of exemption or erosivity waiver, with a valid waiver identification number, from the Central Coast Regional Water Quality Control Board to HCD-Environmental Services for review and approval.

Compliance or Monitoring Action to be Performed:

Prior to issuance of any grading or construction permits, the applicant shall submit a SWPPP including the WDID number certifying the project is covered under the California Construction General Permit or a letter of exemption from the Central Coast Regional Water Quality Control Board.

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RANCHO FIESTA STORAGE IMPROVEMENTS MONTEREY COUNTY, CALIFORNIA CALIFORNIA AMERICAN WATER OCTOBER 2023



VICINITY MAP




LOCATION MAP





REVISIONS REVISIONS **Environmental Engineers, LLC** 200 Clock Tower Pl Building B, Suite B200 Carmel, California 93923-8723 Phone: (831) 200 - 9093 Fax: (480) 283 - 0082

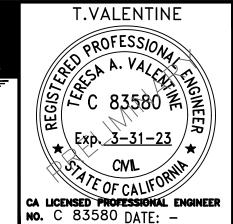

Website: http://www.valentineengineers.com

VALENTINE ENVIRONMENTAL ENGINEERS, LLC 200 CLOCK TOWER PL BUILDING B, SUITE B200 CARMEL, CA 93923-8723
CALIFORNIA AMERICAN WATER
DRAWN BY R.OMALIA PROJECT ENG'R T.VALENTINE

RANCHO FIESTA STORAGE IMPROVEMENTS
GENERAL COVER

DATE OCTOBER 2023 PROJECT ----

USE DIMENSIONS ONLY SCALE AS NOTED CALIFORNIA AMERICAN WATER CO. CENTRAL COAST DIVISION USE APPROVED DRAWINGS ONLY FOR CONSTRUCTION PURPOSES 90% DESIGN G1.0

G1.0.DWG

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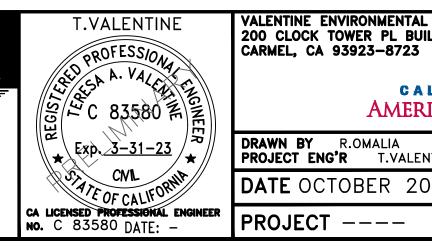
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TITLE





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CALIFORNIA AMERICAN WATER

RANCHO FIESTA STORAGE IMPROVEMENTS

DRAWN BY R.OMALIA PROJECT ENG'R T.VALENTINE	
DATE OCTOBER 2023	

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GENERAL ABBREVIATIONS

304SS 316SS	TYPE 304/304L STAINLESS STEEL TYPE 316/316L STAINLESS STEEL	Ε	E EA	EAST, EASTERLY, EASTING EACH	L	L LAB	LITER, LENGTH, LEFT R	R/		RESTRAINED V V
A AB	ANCHOR BOLT		ECC EF	ECCENTRIC EACH FACE		LAT LF	LATERAL LINEAR FEET	R& RAI)	REMOVE AND RECONSTRUCT V RADIUS V
ABAN ABC	ABANDONED AGGREGATE BASE COURSE		EG ELEC	EXISTING GRADE ELECTRICAL		LB LG	POUND LONG	RD REG	0	ROAD, ROOF DRAIN V RECIRCULATION V
AC ADH	ASPHALTIC CONCRETE OR ASPHALT ADHESIVE		ELEV ELL	ELEVATION ELBOW		LH LLWL	LEFT HAND LOW_LOW WATER LEVEL	REI REI	F	REDUCER V REFERENCE V
AFF AG	ABOVE FINISHED FLOOR ABOVE GRADE		EMERG ENG	EMERGENCY ENGINEER		LO LONG	LUBE OIL LONGITUDINAL	REI	HAB NF	REHABILITATION V REINFORCING REQUIRED W W
AHS ALT	AIR HOSE STATION ALTERNATE		EOP EQ	EDGE OF PAVEMENT EQUAL		LPT LR	LOW POINT LONG RADIUS	RH	Q'D	RIGHT HAND
AMT AP	AMOUNT ACCESS PANEL		EQUIP EW	EQUIPMENT EACH WAY		LRF LWL	LOWER RANCHO FIESTA LOW WATER LEVEL	RJ RL(RESTRAINED JOINT WARAILING W
APPROX AR	APPROXIMATE AIR RELEASE VALVE		EXH EXIST	EXHAUST EXISTING	М	М	MOTOR	RM RN		ROOM WAROUND WARD
ARCH ARRGT	ARCHITECTURAL ARRANGEMENT		EXP EXT	EXPANSION EXTERNAL	•••	MAN MAS	MANUAL MASONRY	RO'		RIGHT OF WAY
ARV ASSY	AIR RELEASE VALVE OR COMBINATION AIR/VAC VALVE ASSEMBLY	Г		FAHRENHEIT		MATL MAX	MATERIAL MAXIMUM	RPI RPI	М	REVOLUTION PER MINUTE
ASTM AT	AMERICAN INSTITUTE OF TESTING & MATERIALS AIR TIGHT	'	FA FAB	FLANGE ADAPTER, FOUL AIR		MCC MECH	MOTOR CONTROL CENTER	RS ⁻ RUI	В	RUBBER W
AUTO AUX	AUTOMATIC AUXILIARY		FC	FABRICATED FLEXIBLE COUPLING OR CONNECTION,		MED	MECHANICAL MEDIUM	RW		RECLAIMIED WATER
AVAR, AV/AR	AIR VACUUM RELIEF/AIR RELEASE VALVE		FCA	FERRIC CHLORIDE FLANGE COUPLING ADAPTER AUTOMATIC CONTROL VALVE		MFR MGD	MANUFACTURER S MILLION GALLONS PER DAY	S SAN	M	SAMPLE W
AVE AVG	AVENUE AVERAGE		FCV FD	FLOOR DRAIN		MH MIN	MANHOLE MINIMUM	SCI SCI	E H	SOUTHERN CALIFORNIA EDISON SCHEDULE X X
AWWA	AMERICAN WATER WORKS ASSOCIATION		FDN FE	FOUNDATION FLOW ELEMENT		MISC MJ	MISCELLANEOUS MECHANICAL JOINT	SCI SD		SCREW SANITARY DRAIN
BF BFV	BLIND FLANGE BUTTERFLY VALVE		FF FG	FINISH FLOOR FINISHED GRADE		MO MTD	MASONRY OPENING MOUNTED	SE(SE)	2	SECONDARY, SECONDS, SECTION SEWER Y
BGS BLDG	BELOW GRADE SURFACE BUILDING		FH FHV	FIRE HYDRANT FIRE HOSE VALVE		MTL	METAL	SF SG		SQUARE FEET SLIDE GATE
BLVD	BOULEVARD		FIN FIT	FINISHED FLOW INDICATING TRANSMITTER	N	N	NORTH, NORTHERLY, NORTHING	SH	Τ	SHEET
BM BO	BENCH MARK BLOW OFF		FL FLG	FLUSH FLANGE	. •	NAD83 NAT	NORTH AMERICAN DATUM 1983 NATURAL	SIM	NT	SIMILAR SEALANT
BOT BRG	BOTTOM BEARING		FLEX	FLEXIBLE		NAVD29 NC	NORTH AMERICAN VERTICAL DATUM 1929 AMERICAN NATIONAL COARSE THREAD	SL\ SM		SLEEVE SHEET METAL
BRK BS	BRICK BOTTOM SLUDGE		FLR FLG	FLOOR FLANGED		NC ND	NORMALLY CLOSED	SP SPI		STATIC PRESSURE, STAND PIPE SPECIFICATION, SPECIFIED
BWS BWW	BACKWASH SUPPLY BACKWASH WASTE		FLV FPM	FLAP VALVE FEET PER MINUTE		NF	NOT DETECTED AMERICAN NATIONAL FINE THREAD		PWC	STANDARD PLANS FOR PUBLIC WORKS CONSTRUCTION
BYP	BYPASS		FPS FRP	FEET PER SECOND FIBERGLASS REINFORCED PLASTIC OR PIPE		NO. NO	NUMBER NORMALLY OPEN	SPI SQ		SPRINKLER SQUARE
CAL/OSHA	CALIFORNIA OCCUPATIONAL SAFETY AND HEALTH ASSOCIATION		FS FSW	FLOW SWITCH, FINISHED SURFACE FIRE SUPPLY WATER		NOM NPDES	NOMINAL NATIONAL POLLUTANT DISCHARGE	SR		SHORT RADIUS
CAT	CATALOG		FT FV	FEET AUTOMATIC VALVE		NPSF	ELIMINATION SYSTEM AMERICAN NATIONAL STRAIGHT PIPE	SSI SSI	PWC	SERVICE SINK STANDARD SPECIFICATIONS FOR PUBLIC
CB CEM	CATCH BASIN CEMENT		FW	FILTERED WATER		NTS	THREADS FOR DRY SEAL PRESSURE JOINTS NOT TO SCALE	ST		WORKS CONSTRUCTION STREET
CENT CFM	CENTRIFUGAL CUBIC FEET PER MINUTE	G	G GA	GROUND, GAS GAUGE, GAGE	0	0 TO 0	OUT TO OUT	STA STI)	STATION STANDARD
CFS CG	CUBIC FEET PER SECOND CENTER OF GRAVITY		GAL	GALLON	U	0/C 0D	ON CENTER	ST(STL	; -	STORAGE STEEL, GENERAL
CHAM CHEM	CHAMFER CHEMICAL		GALV GEN	GALVANIZE, GALVANIZED (HOT DIPPED) GENERATOR		OED	OUTSIDE DIAMETER OPEN END OR OPEN EQUIPMENT DRAIN	STL STF	_/L	STEEL PIPE, LINED STRAIGHT
CIR ແ	CIRCLE CENTER LINE		GLV GPM	GLOBE VALVE GALLONS PER MINUTE		OF OFF	OUTSIDE FACE, OVERFLOW OFFSET		RUCT	STRUCTURE, STRUCTURAL SUBMERGED
CLG	CEILING		GR GRTG	GRADE, GRIT GRATING		OPNG OPP	OPENING OPPOSITE	SUI SUI	С	SUCTION
CLR CM	CLEARANCE CENTIMETER		GV GVL	GATE VALVE GRAVEL		OR OS&Y	OUTSIDE RADIUS OUTSIDE STEM AND YOKE	SUI	RF	SUPERINTENDENT SURFACE
CO COL	CLEAN OUT COLUMN	Н	Н	HIGH		OSHA OVHD	OCCUPATIONAL SAFETY AND HEATH ASSOCIATION OVERHEAD	SU:		SUSPENDED SOCKET WELDED, SEAL WATER
COMB COMP	COMBINATION COMPANION	• •	HB	HOSE BIBB	Р		PUMP, PUMPING, PROPANE	SYN	М	SYMMETRICAL
CONC	CONCRETE		HD HDPE	HEAVY DUTY HIGH DENSITY POLYETHYLENE PIPE	•	P&ID PB	PROCESS AND INSTRUMENTATION DIAGRAM T PULLBOX	T TDH	J	TREADS TOTAL DYNAMIC HEAD
COND CONN	CONDENSATE CONNECTION		HDR HDW	HEADER HARDWARE		PC PCC	POLLBOX POINT OF CURVATURE PORTLAND CEMENT CONCRETE	TEL	_	TELEPHONE
CONST CONT	CONSTRUCTION CONTINUOUS, CONTINUE		HEV HGL	HOSE END VALVE HYDRAULIC GRADE LINE		PCHV	PINCH VALVE	TEN TES	3	TEMPERATURE THROUGH EXISTING SLAB
CONTR COORD	CONTRACTOR OR CONTRACT COORDINATE		HGR HGT	HANGER HEIGHT		PD PE	PROCESS DRAIN PRESSURE ELEMENT, POLYETHYLENE, PRIMARY EFFLUENT	TEV TF		THROUGH EXISTING WALL TOP FACE
COR CORR	CORRUGATED CORRIDOR		HH HORIZ	HANDHOLE HORIZONTAL		PFP PH	PLATE AND FRAME PRESS POTHOLE	THI THI		THICK THREADED, THREAD
CP CPLG	CONTROL POINT COUPLING		HP HRT	HORSEPOWER HIGH POINT		PI PIT	PRESSURE INDICATOR, POINT OF INTERSECTION, PRIMARY INFLUENT PRESSURE INDICATING TRANSMITTER	TIT		TEMPERATURE INDICATOR TEMPERATURE INDICATING TRANSMITTER
CPVC CRE	CHLORINATED POLYVINYL CHLORIDE PIPE CORROSION RESISTANT		HRL	HANDRAIL		PL PLMG	PLATE, PROPERTY LINE PLUMBING	TK TO	C	TANK TOP OF CONCRETE
CS	CHLORINE SOLUTION		HS HV	HIGH STRENGTH HAND VALVE		PV PLYWD	PLUG VALVE PLYWOOD	TO:	S	TOP OF STEEL, TOP OF SWALE TOP OF WALL
CTR CV	CENTER CHECK VALVE		HVAC HVY	HEATING, VENTILATING AND AIR CONDITIONING HEAVY		PN	PNEUMATIC	TP(3	TOP OF WALL TOPPING TREATED WATER
D/S	DOWNSTREAM		HW HWL	HOT WATER HIGH WATER LEVEL		POL POTW	POLYMER POTABLE WATER	TYI		TYPICAL
D ['] DBL	DRAIN DOUBLE		HYD HZ	HYDRAULIC HERTZ		PP PPM	POWER POLE, POLYPROPYLENE PIPE PARTS PER MILLION U	U/	'S	UNDERSIDE, UPSTREAM
DEF DEMO	DEFLECTION DEMOLITION	1	ID	INTERNAL DIAMETER		PR PRV	PAIR PRESSURE REGULATING VALVE	UG UM	;	UNDERGROUND, MICROGRAM MICROMETER
DEPT DET	DEPARTMENT DETAIL	1	IE IM	INVERT ELEVATION		PS PSF	PRESSURE SWITCH, PIPE SUPPORT, PRIMARY SLUDGE POUNDS PER SQ. FOOT	UN UN	IK	UNKNOWN UNLESS NOTED OTHERWISE
DIA	DIAMETER		IM IN	IRON AND MANGANESE INCH		PSI PSV	POUNDS PER SQUARE INCH PRESSURE SAFETY VALVE	uР	VC	UV RESISTANT PVC PIPE (PAINTED OR WITH UV RESISTANT RESIN)
DIAG DIAP	DIAGONAL DIAPHRAGM		INF INS	FILTER INFLUENT INSULATION, INSULATE		PTD PVC	PAINTED POLYVINYL CHLORIDE PIPE		JUSA	UPPER RANCHO FIESTA UNITED STATES, UNDERGROUND SERVICE ALERT
DIM DIP	DIMENSION DUCTILE IRON PIPE		INSTA INSTR	INSTANTANEOUS INSTRUMENTATION, INSTRUMENT		PVMT	PAVEMENT	US		UNITED STATES COAST AND GEODETIC SURVEY UNDER SEPARATE CONTRACT
DIPS DIR	DUCTILE IRON PIPE SIZE DIRECTION		INT INV	INTERIOR INVERT		PW	PLANT WATER	UT	IL	UTILITY
DISCH DIST	DISCHARGE DISTANCE, DISTRIBUTION		IPS IRR / IRRIG	IRON PIPE SIZE IRRIGATION WATER	Q	Q QTY	FLOW QUANTITY			
DS DWG	DIGESTER SLUDGE DRAWING		IW	INDUSTRIAL WATER		•				
5110	S.W.IIIII I	J	JT	JOINT						





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	CALIFORNIA AMERICAN WATER
ı	

PROJECT ----

RANCHO FIESTA STORAGE IMPROVEMENTS GENERAL ABBREVIATIONS

AMERICAN WATER	
DRAWN BY R.OMALIA PROJECT ENG'R T.VALENTINE	

VALVE, VOLTS VACUUM VALVE BOX VERTICAL VACUUM FILTER

VOLUME

WITHOUT

WOOD WEIGHT

VENT

VARIABLE FREQUENCY DRIVE

WORK AREA TRAFFIC CONTROL HANDBOOK

WATER SURFACE, WATER STOP

VENT THROUGH ROOF

WATER, WEST, WIDE

WHERE APPLICABLE

WATER CLOSET

WALL HYDRANT WASH HOSE STATION WATER LEVEL WEATHER PROOF

WATERTIGHT, WEIGHT WATER VALVE

EXTRA HEAVY EXTRA STRONG

YARD HYDRANT DIAMETER AT

DELTA


EXPLOSION PROOF

Y R.OMALIA ENG'R T.VALENTINE			
OCTOBER 2023	CALIFORNIA AMERICAN WATER CO.	CENTRAL COAST DIVISION	
CT	USE APPROVED DRAWINGS ONLY FOR CONSTRUCTION PURPOSES	90% DESIGN	

USE DIMENSIONS ONLY SCALE AS NOTED

G2.0


SYMBOL LEGEND

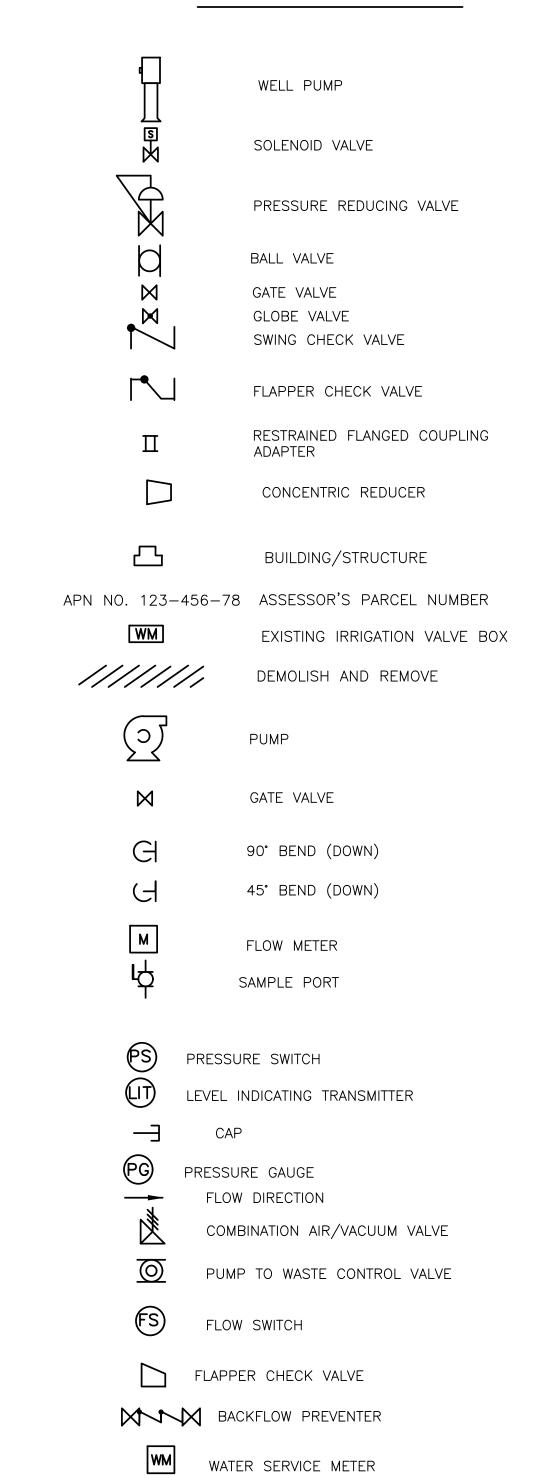


LEGEND

	LIGHT GRAY, CONTINUOUS = EXISTING, ABOVE GROUND
	LIGHT GRAY, DASHED = EXISTING, BELOW GROUND
	BOLD, CONTINUOUS = NEW, ABOVE GROUND
	BOLD, DASHED = NEW, BELOW GROUND
E	ELECTRICAL
G	GAS
W	WATER
SS	SANITARY SEWER
SD	STORM DRAIN
COMM	COMMUNICATION
OH	ELECTRICAL OVERHEAD WIRE
	CURB LINE, EDGE OF PAVEMENT
<u> </u>	CHAIN LINK FENCE
× ×	WIRE FENCE
445	CONTOUR LINE, NEW GRADE
445	CONTOUR LINE, EXISTING GRADE
4A1.6	EXISTING SPOT ELEVATION
— — — — -TOS — — -TOS —	TOP OF SLOPE/ TOE OF SLOPE
	EXISTING EASEMENT
	PROPERTY LINE
R/W	RIGHT OF WAY
	CENTERLINE
00+00 10+00	PLAN AND PROFILE STATIONING

MECHANICAL LEGEND

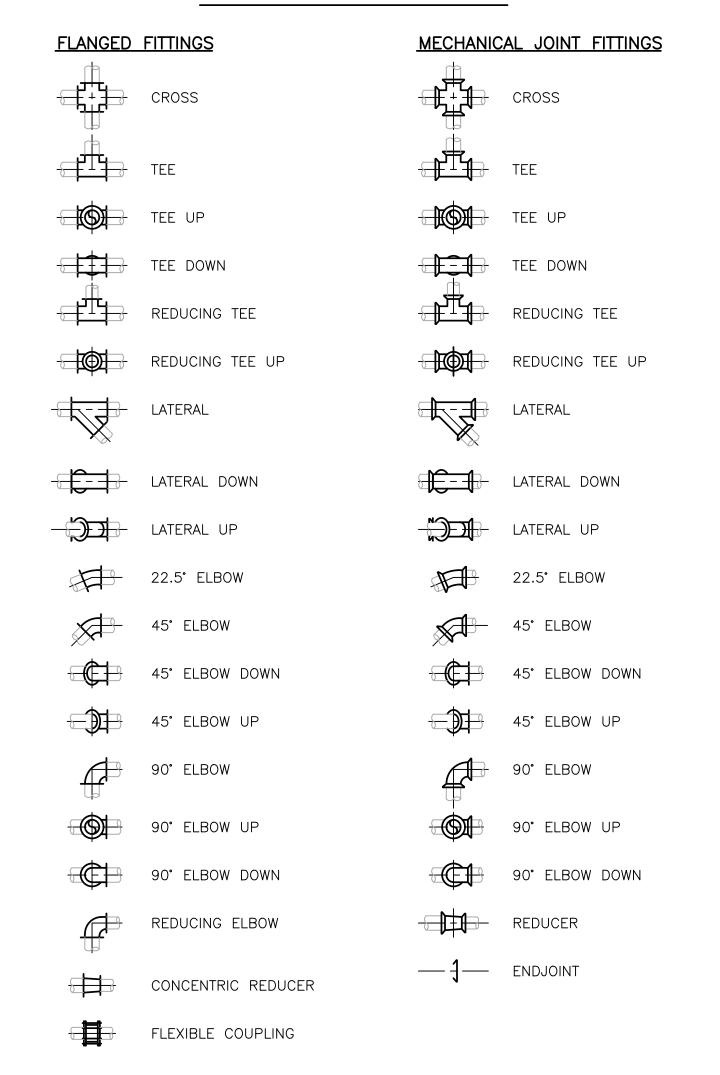

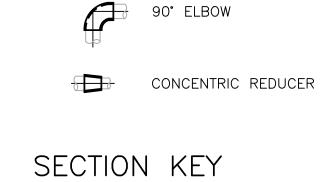

SINGLE LINE FITTINGS

TEE

TEE UP

TEE DOWN

LATERAL

90° ELBOW

45° ELBOW

GH 90° ELBOW DOWN

⊚— 90° ELBOW UP

UNION

c— CAP PLUG


CONCRETE FITTINGS

45° ELBOW


TEE

CONCENTRIC REDUCER

ECCENTRIC REDUCER

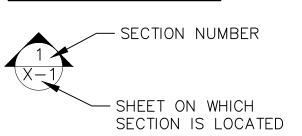


DETAIL KEY

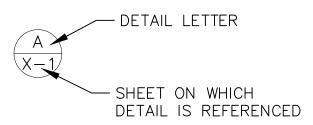





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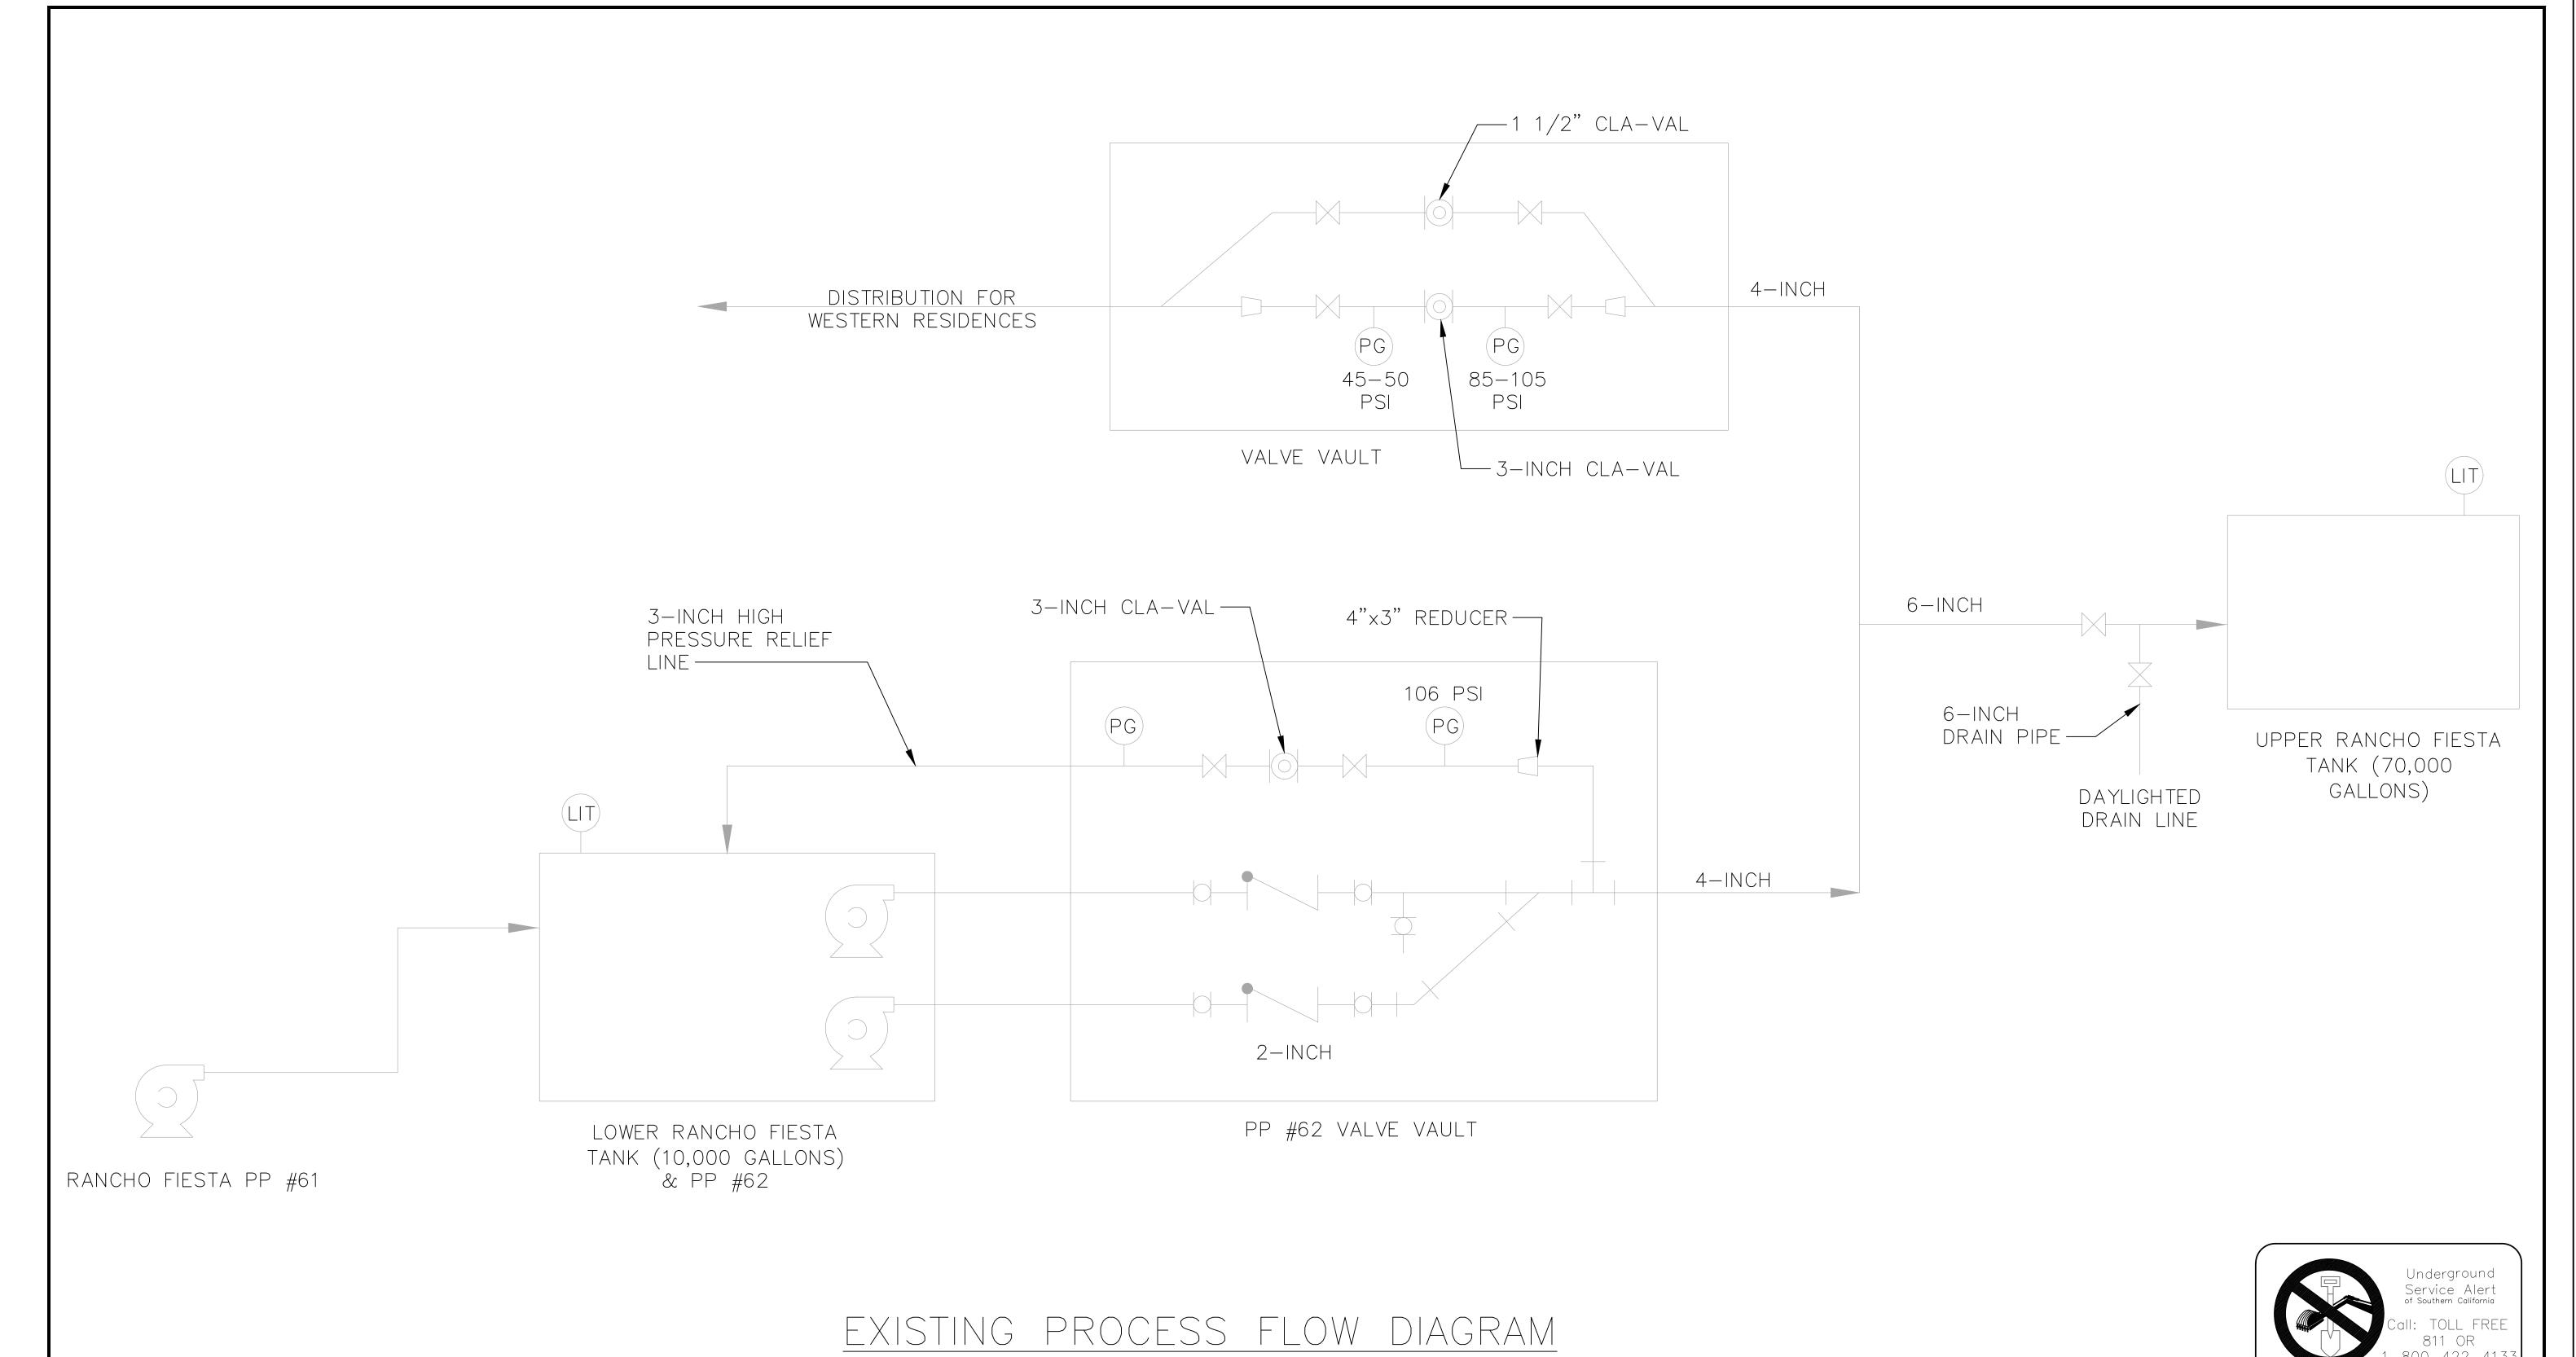
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CALIFORNIA AMERICAN WATER
DRAWN BY R.OMALIA

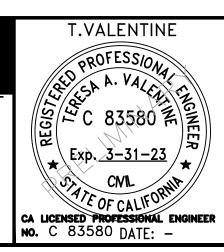RANCHO FIESTA STORAGE IMPROVEMENTS
GENERAL
ABBREVIATIONS AND LEGEND

DRAWN BY R.OMALIA PROJECT ENG'R T.VALENTINE

DATE OCTOBER 2023 CALIFORNIA AMERICAN WATER CO. CENTRAL COAST DIVISION USE DIMENSIONS ONLY SCALE AS NOTED


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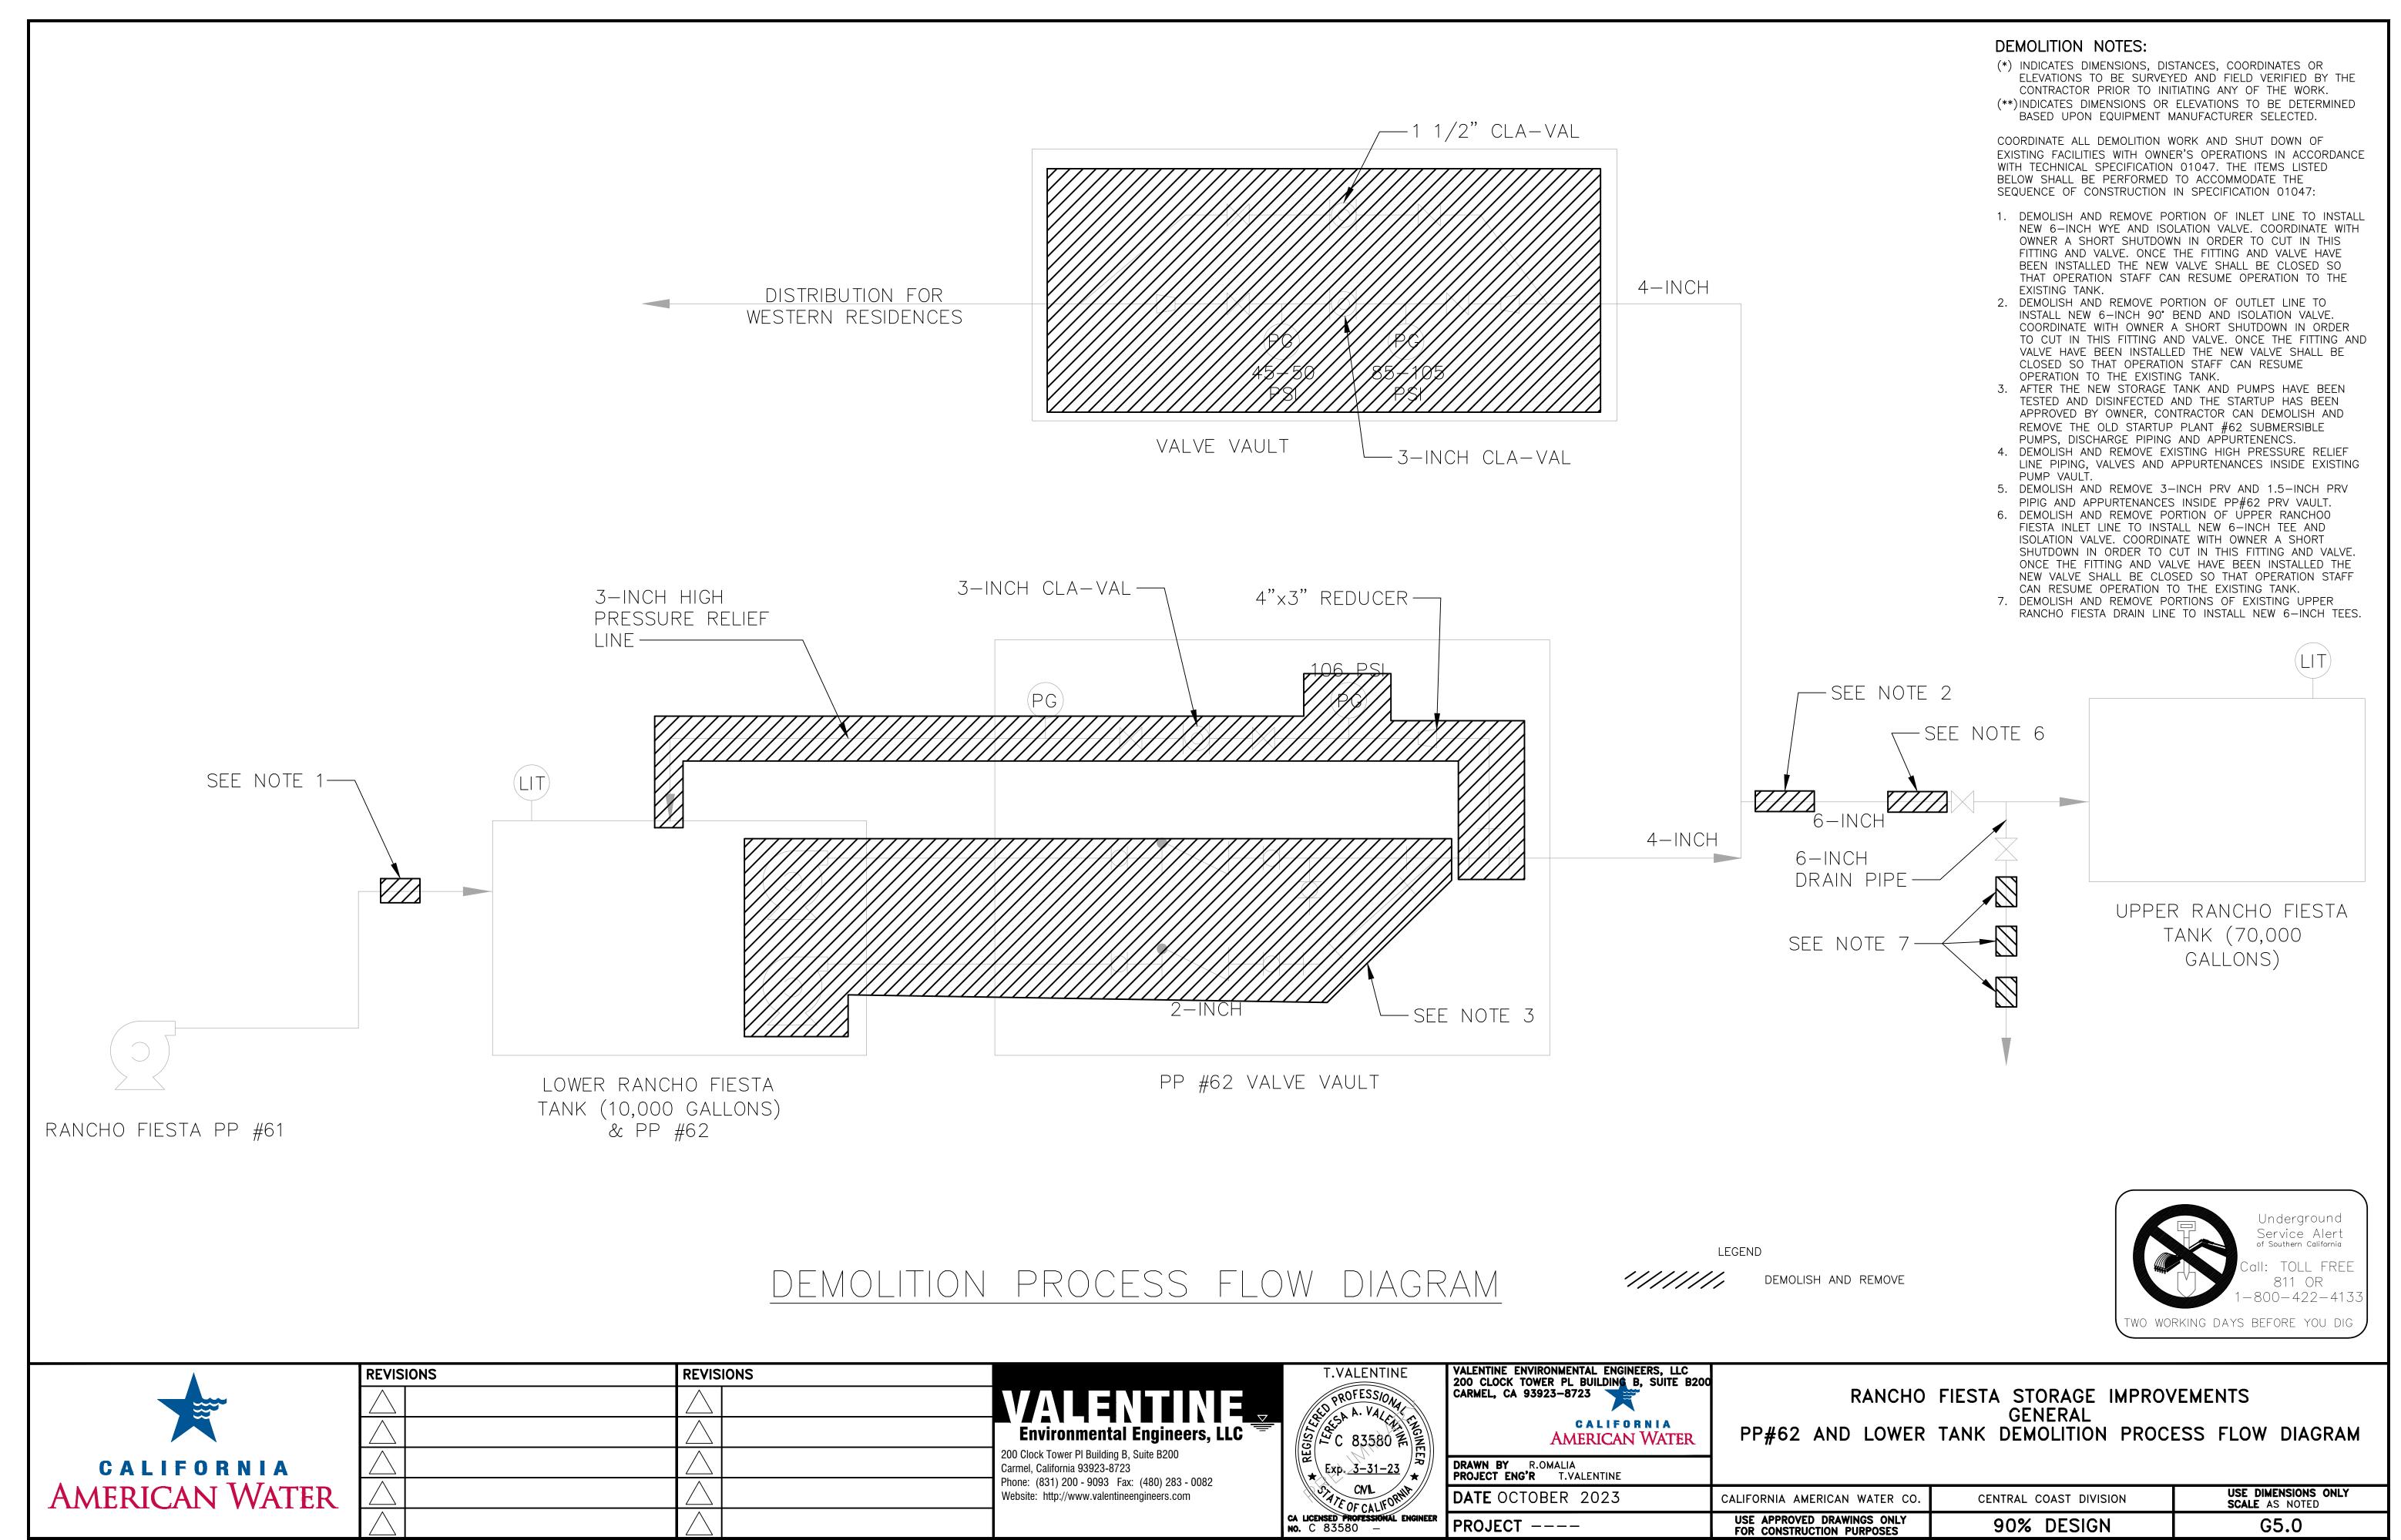
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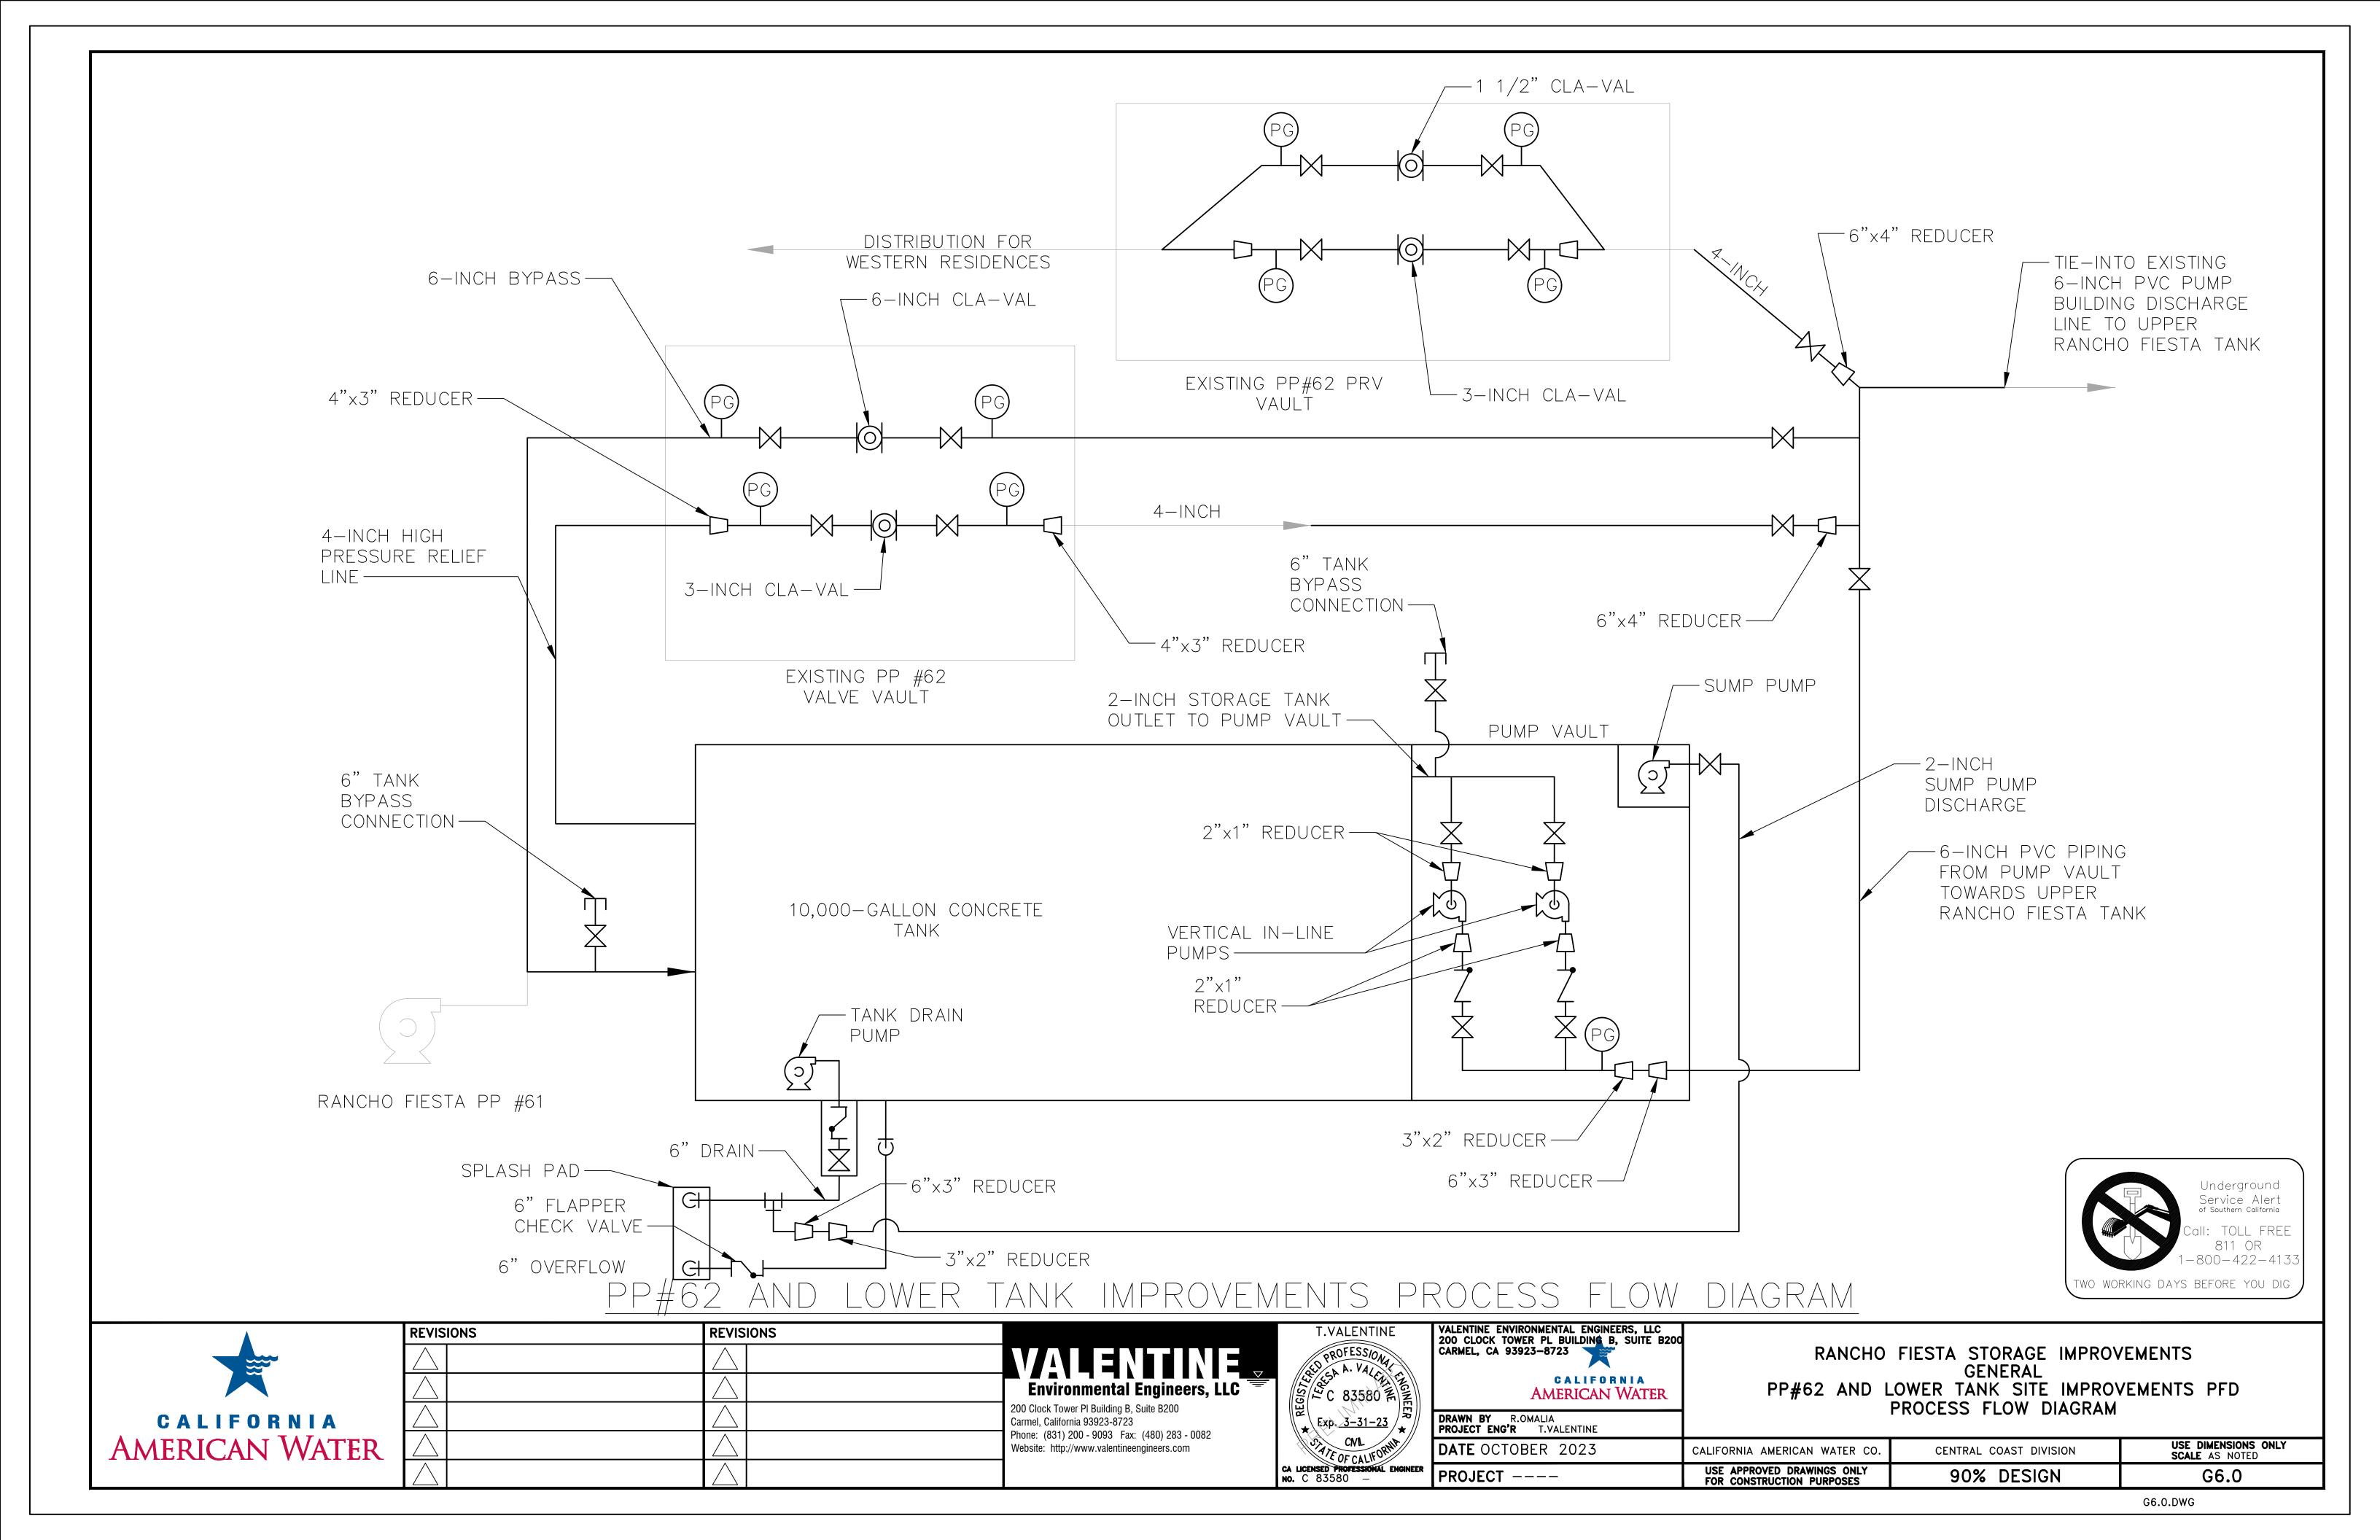



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CALIFORNIA AMERICAN WATER	
DRAWN BY R.OMALIA Project eng'r t.valentine	

RANCHO FIESTA STORAGE IMPROVEMENTS GENERAL RANCHO FIESTA EXISTING PROCESS FLOW DIAGRAM


			CA O DWC
PROJECT	USE APPROVED DRAWINGS ONLY FOR CONSTRUCTION PURPOSES	90% DESIGN	G4.0
DATE OCTOBER 2023	CALIFORNIA AMERICAN WATER CO.	CENTRAL COAST DIVISION	USE DIMENSIONS ONLY SCALE AS NOTED
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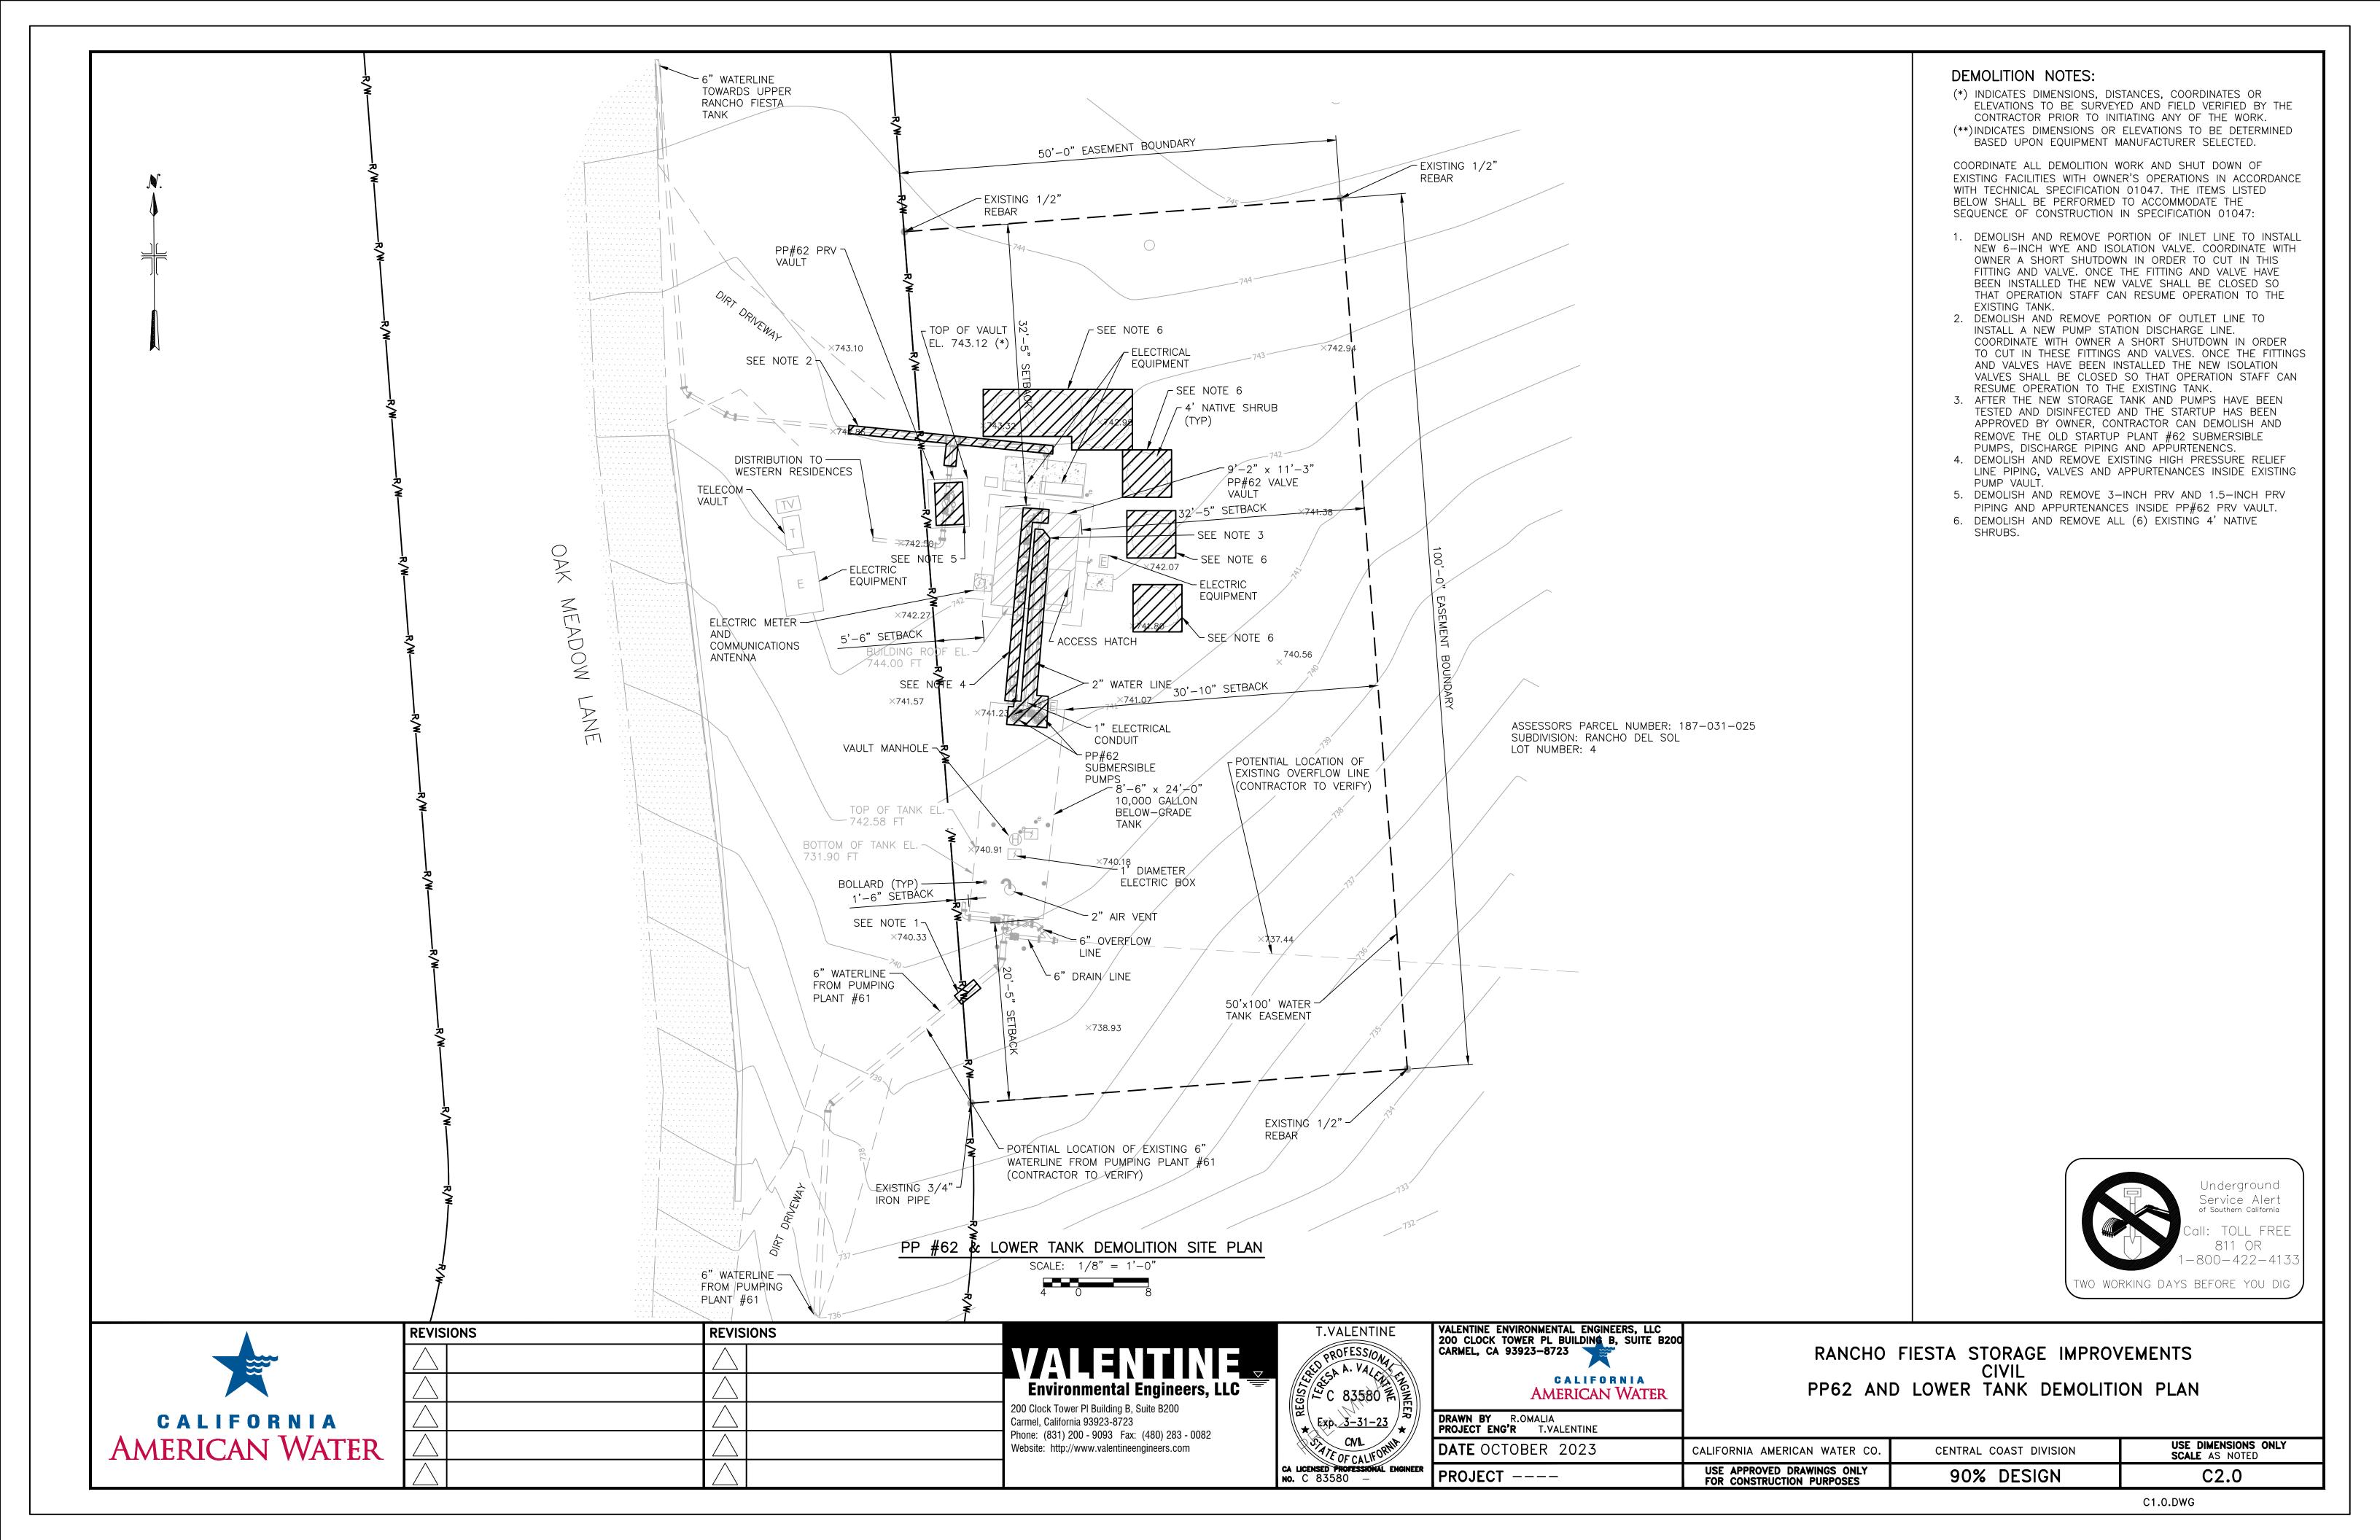





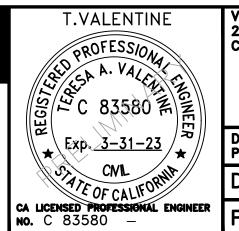


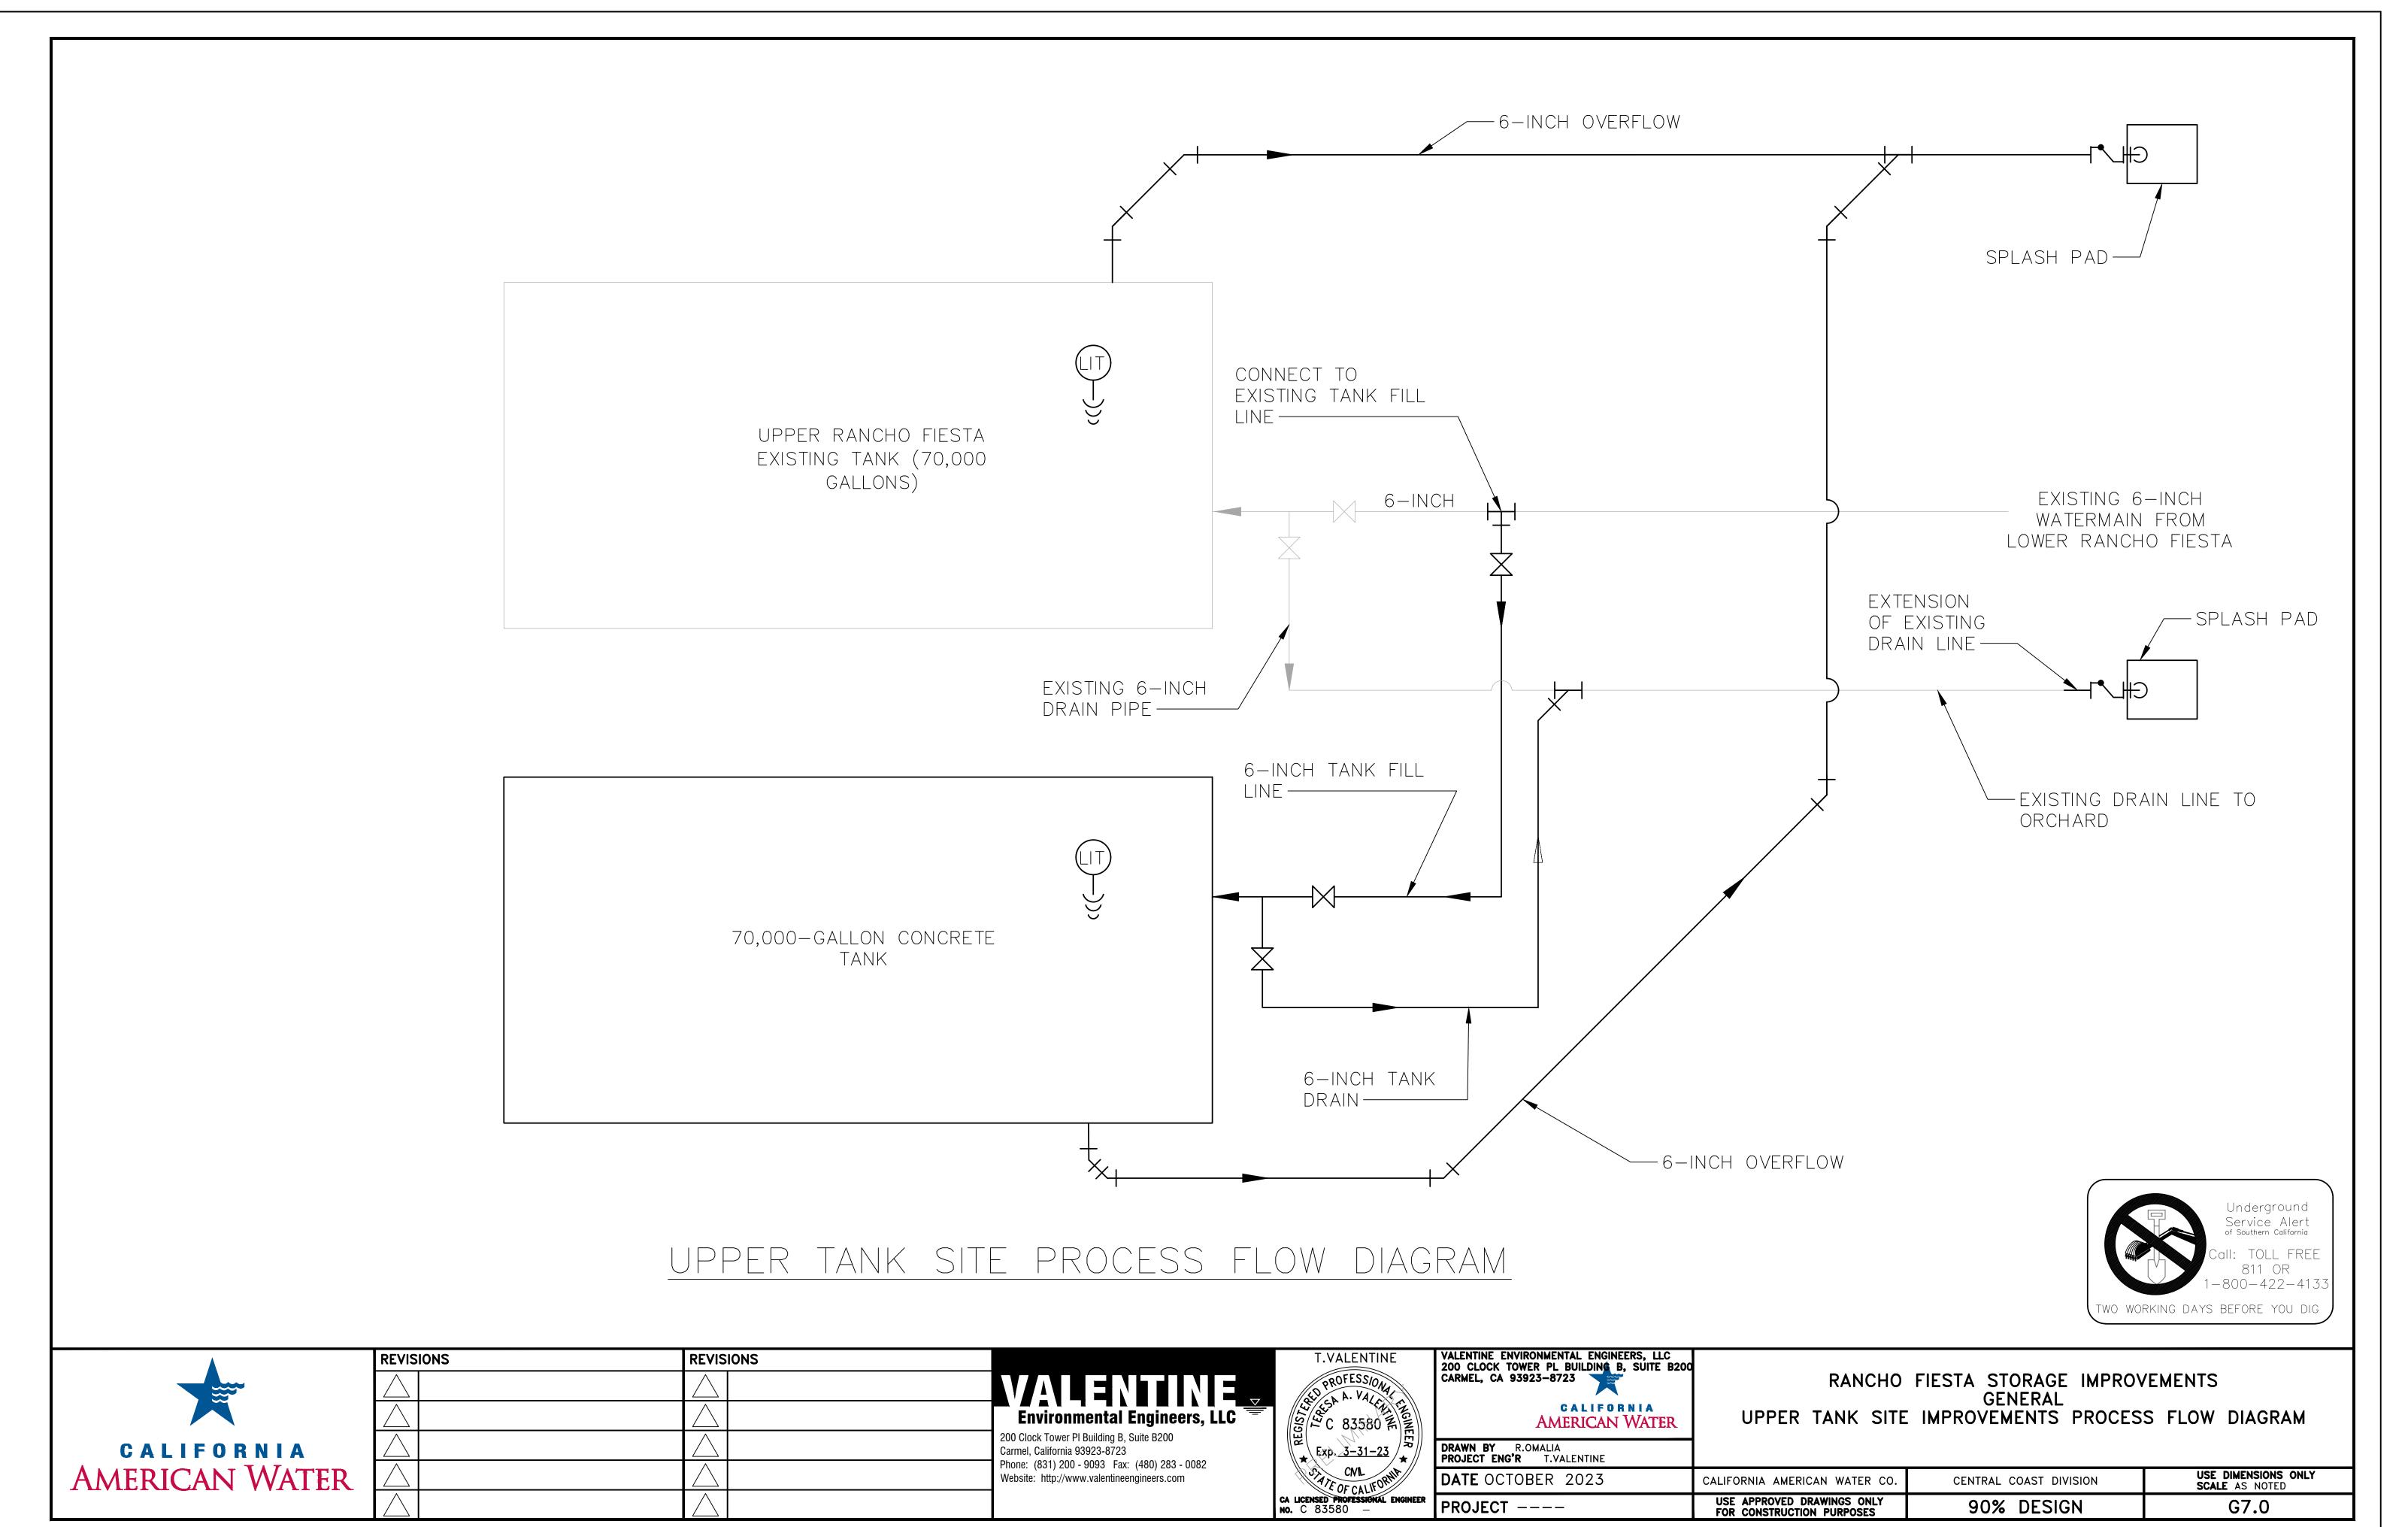
G7.0.DWG




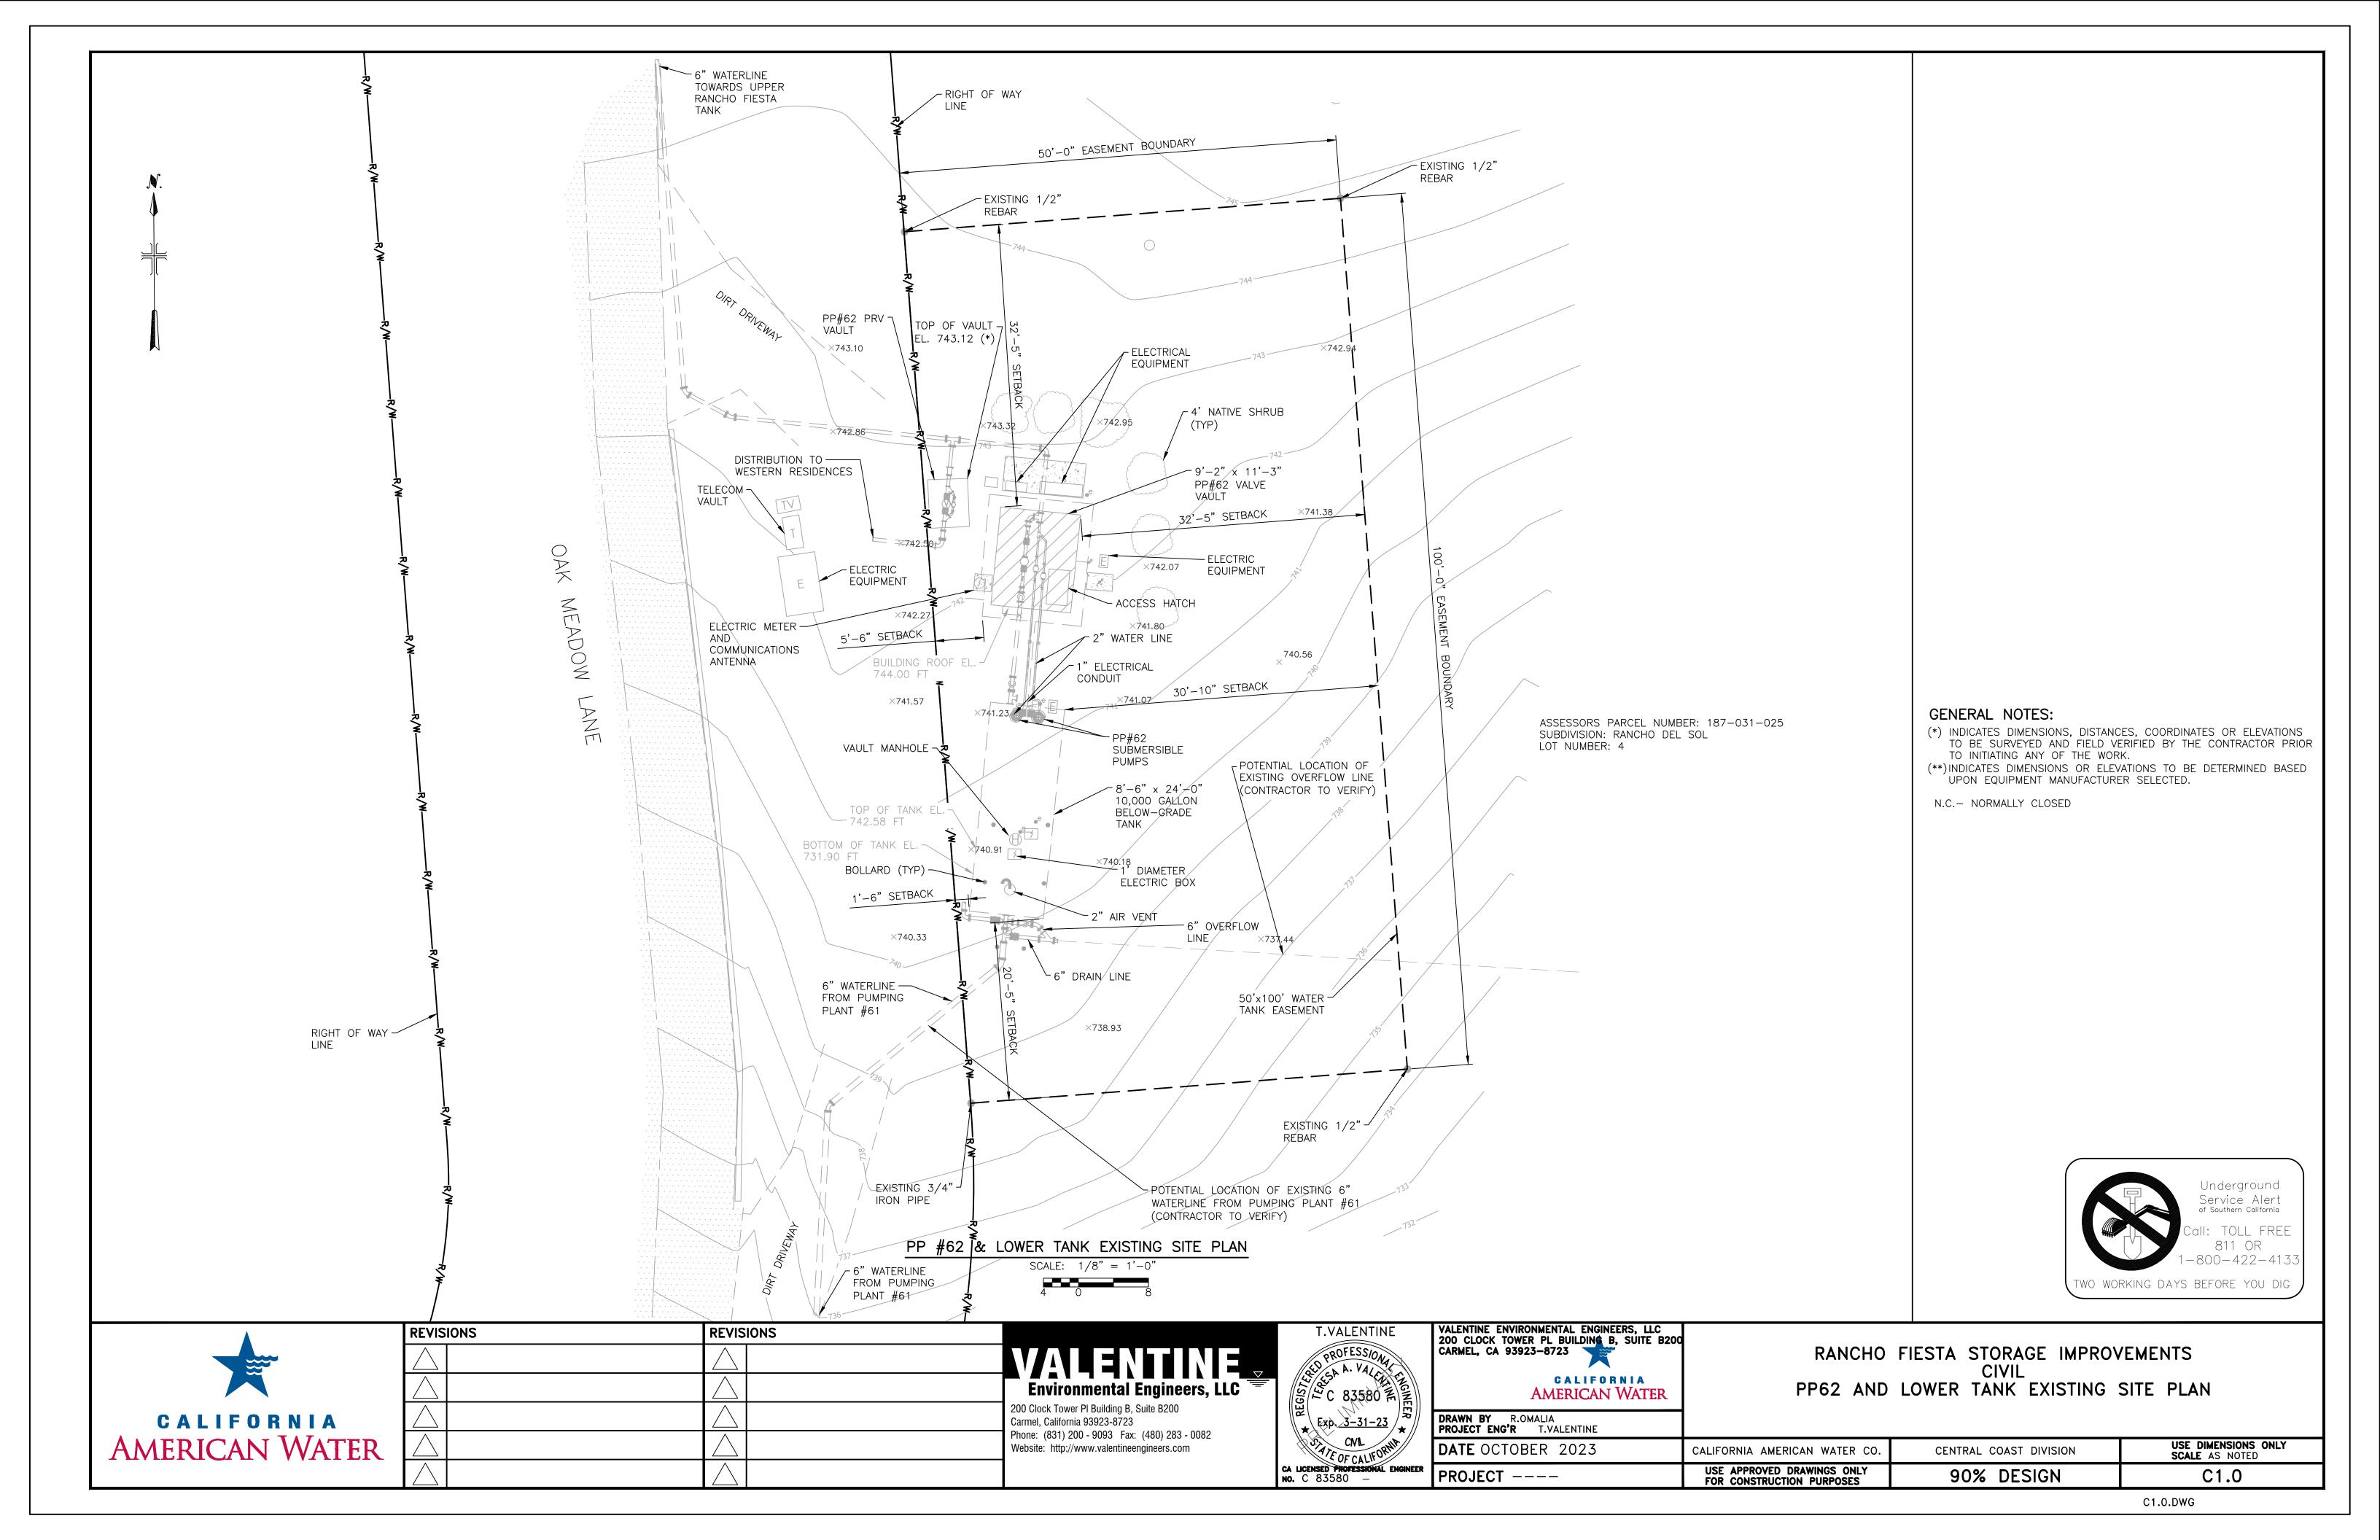


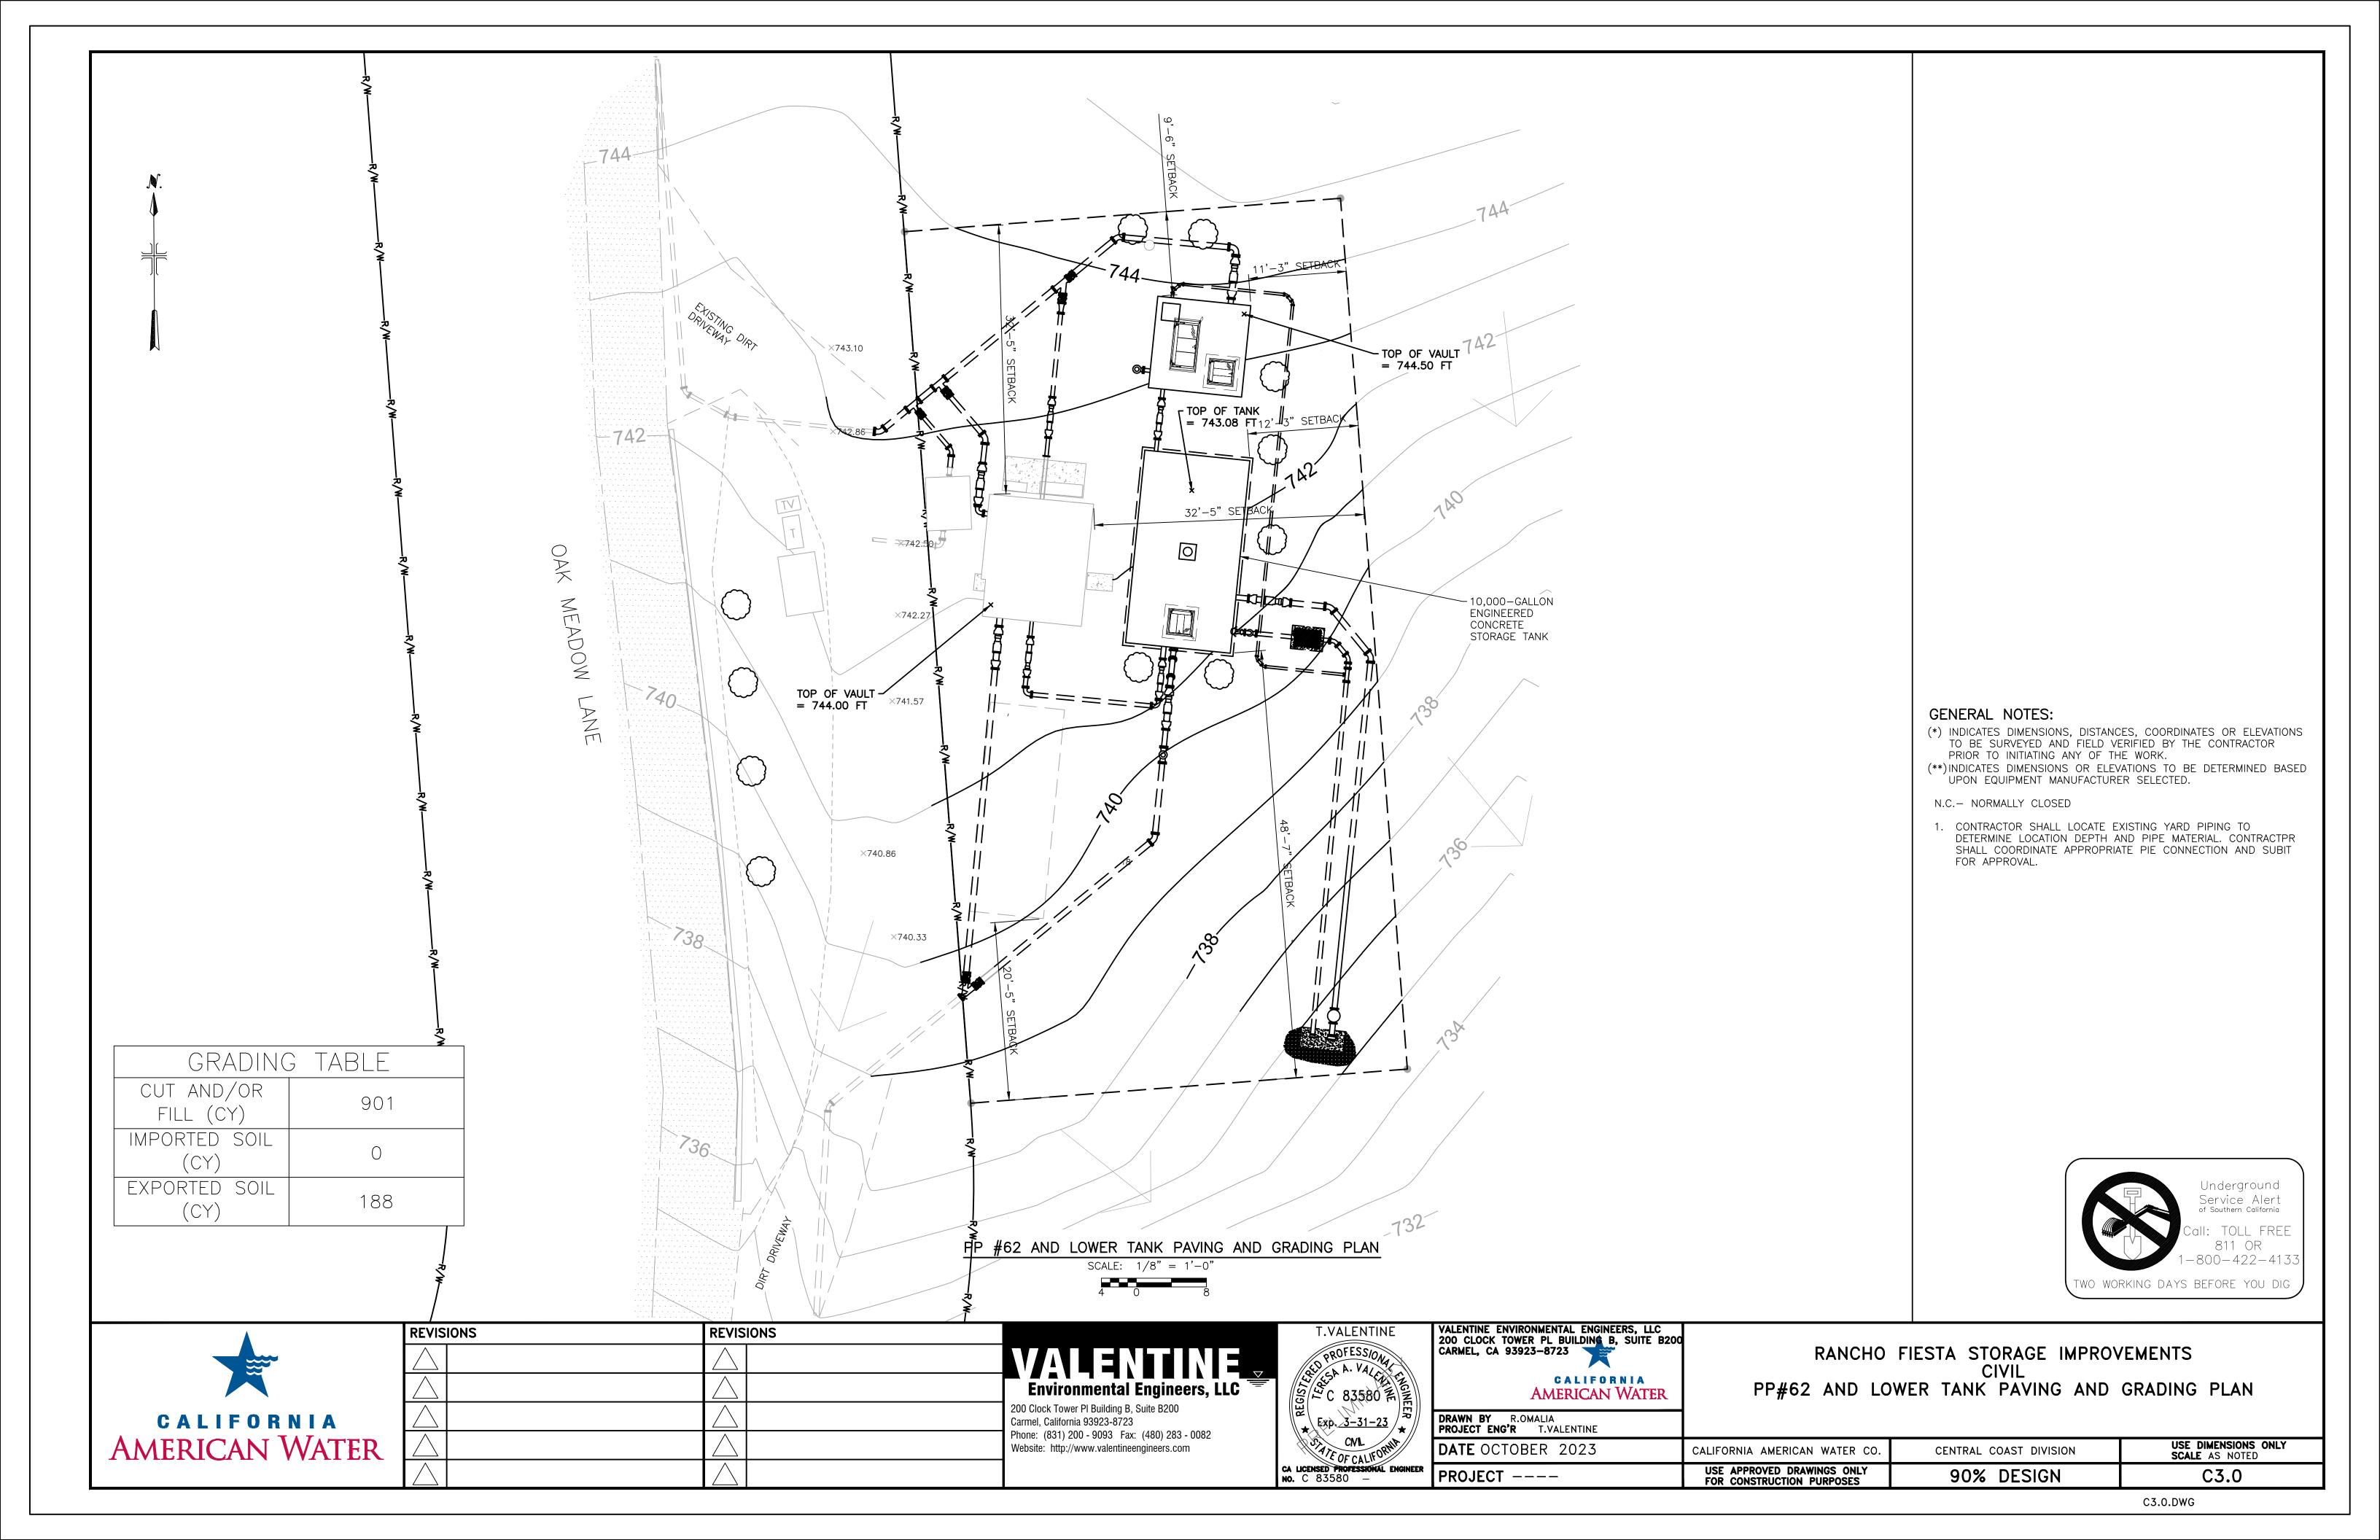


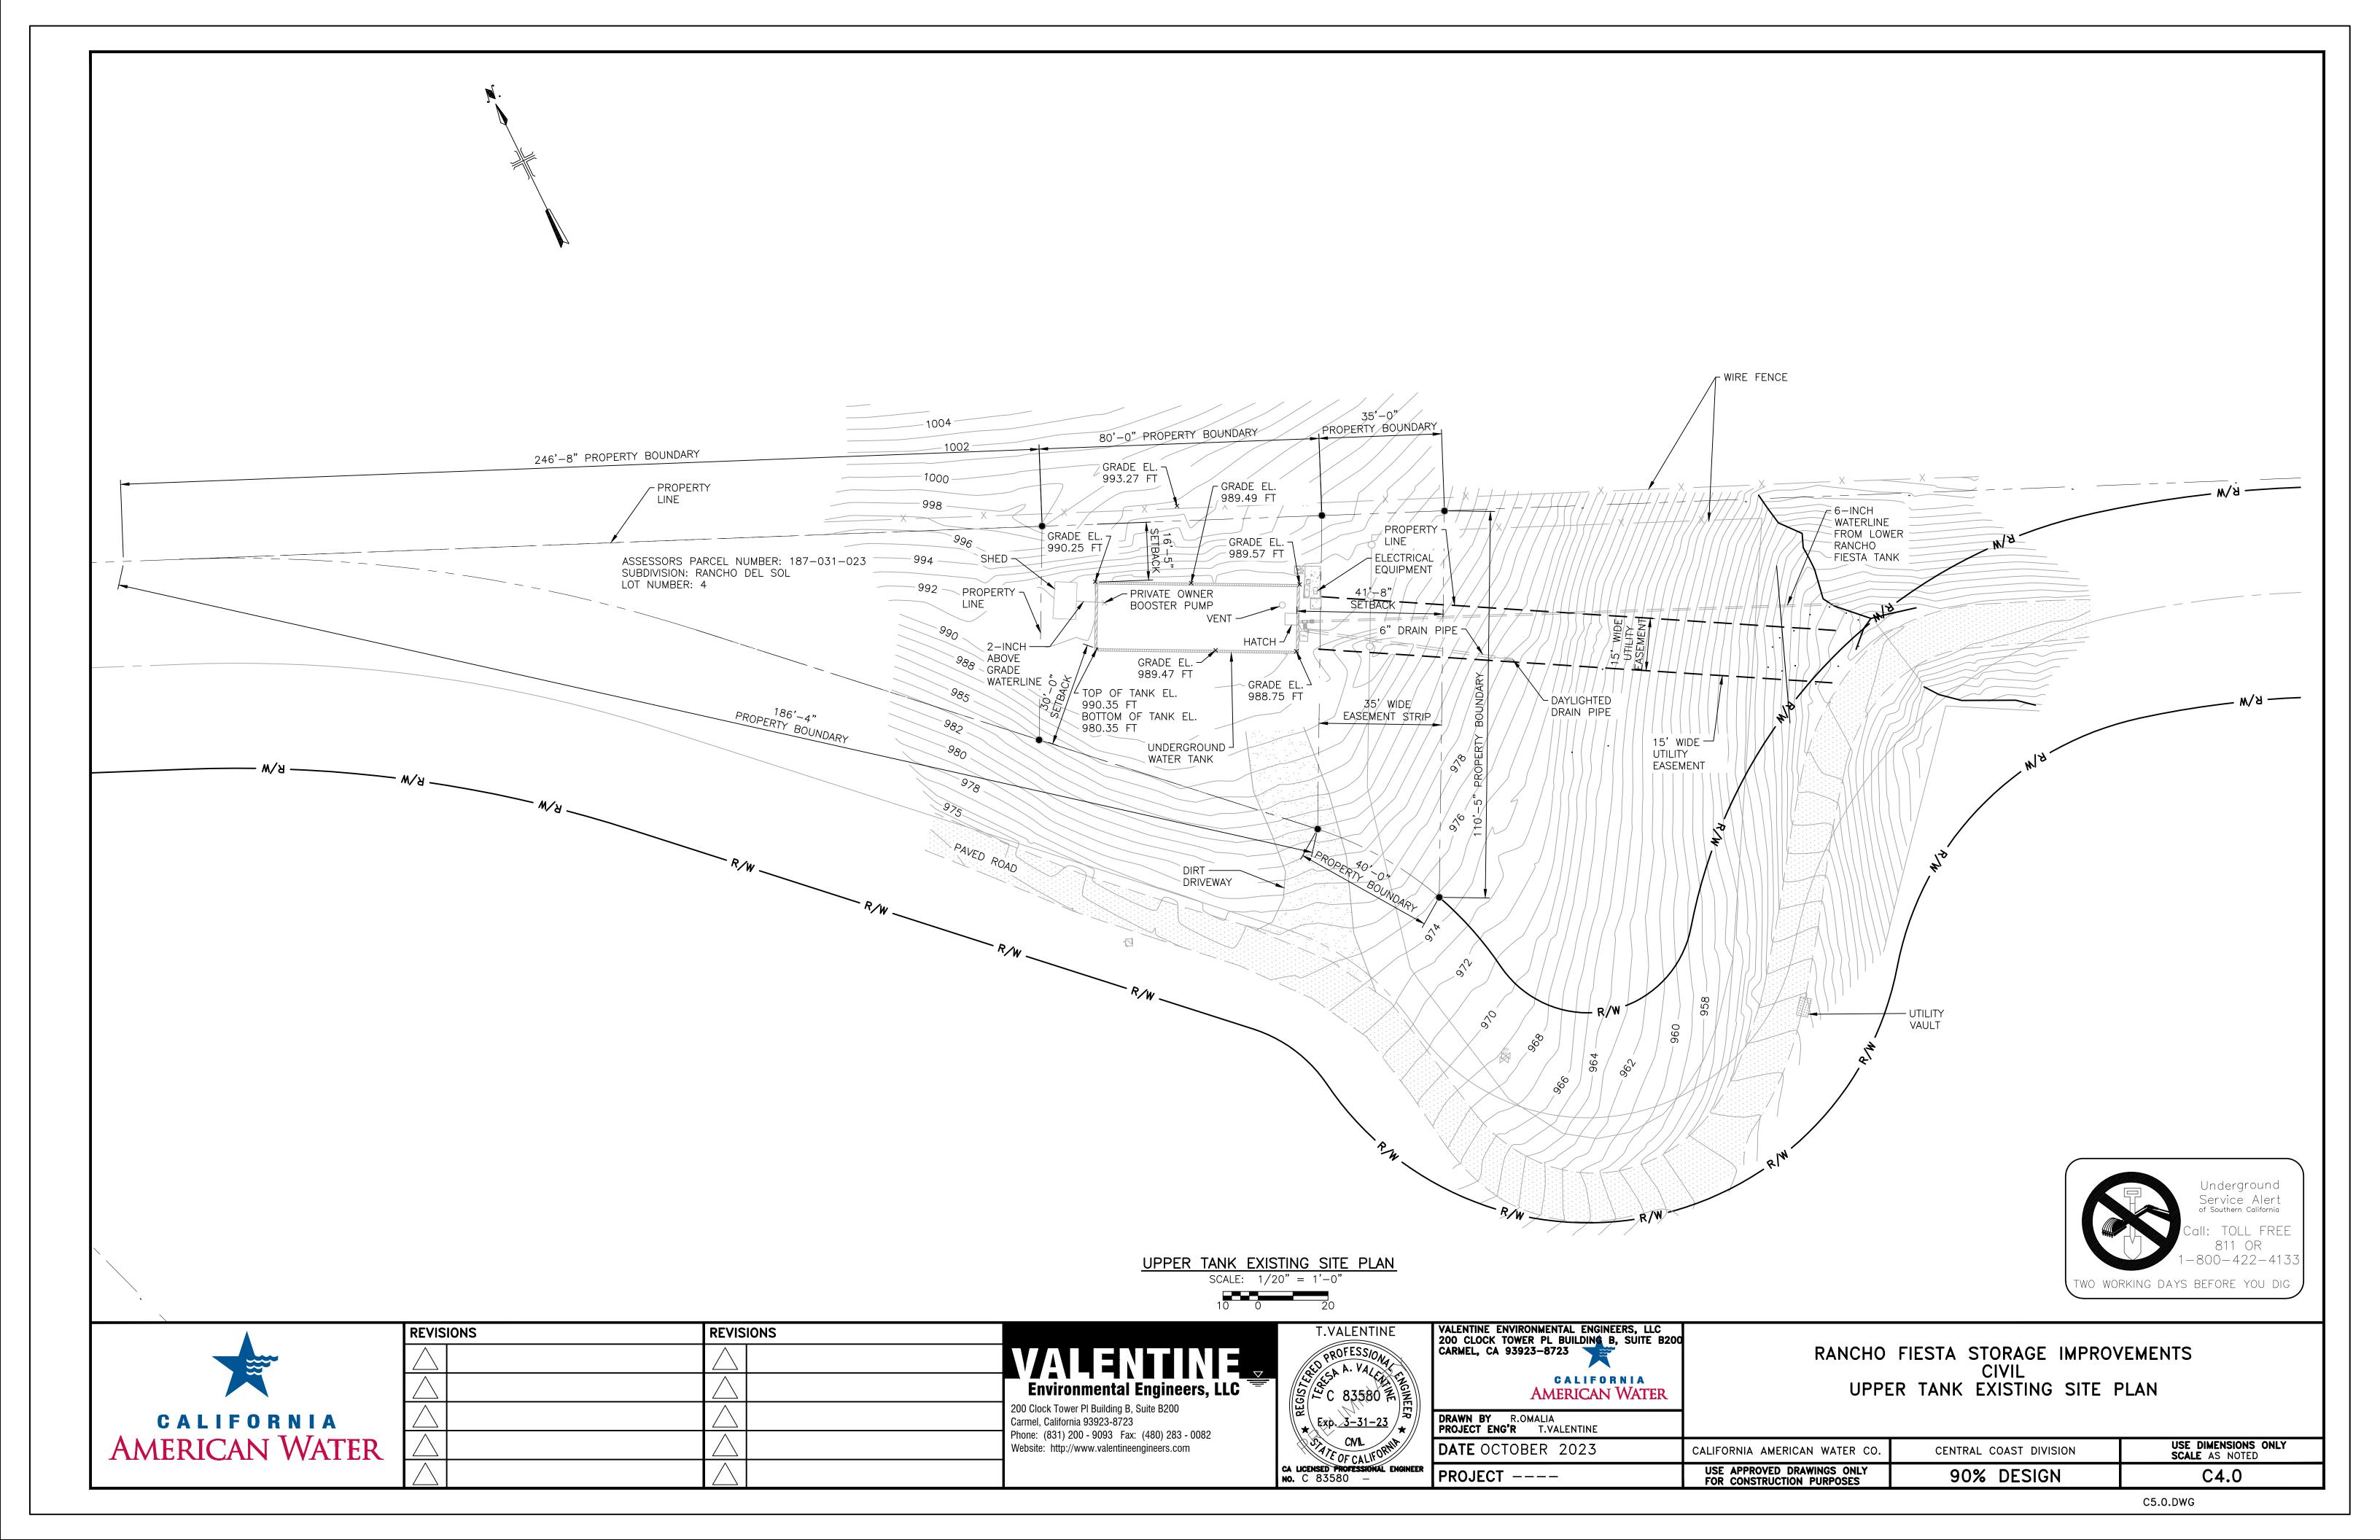


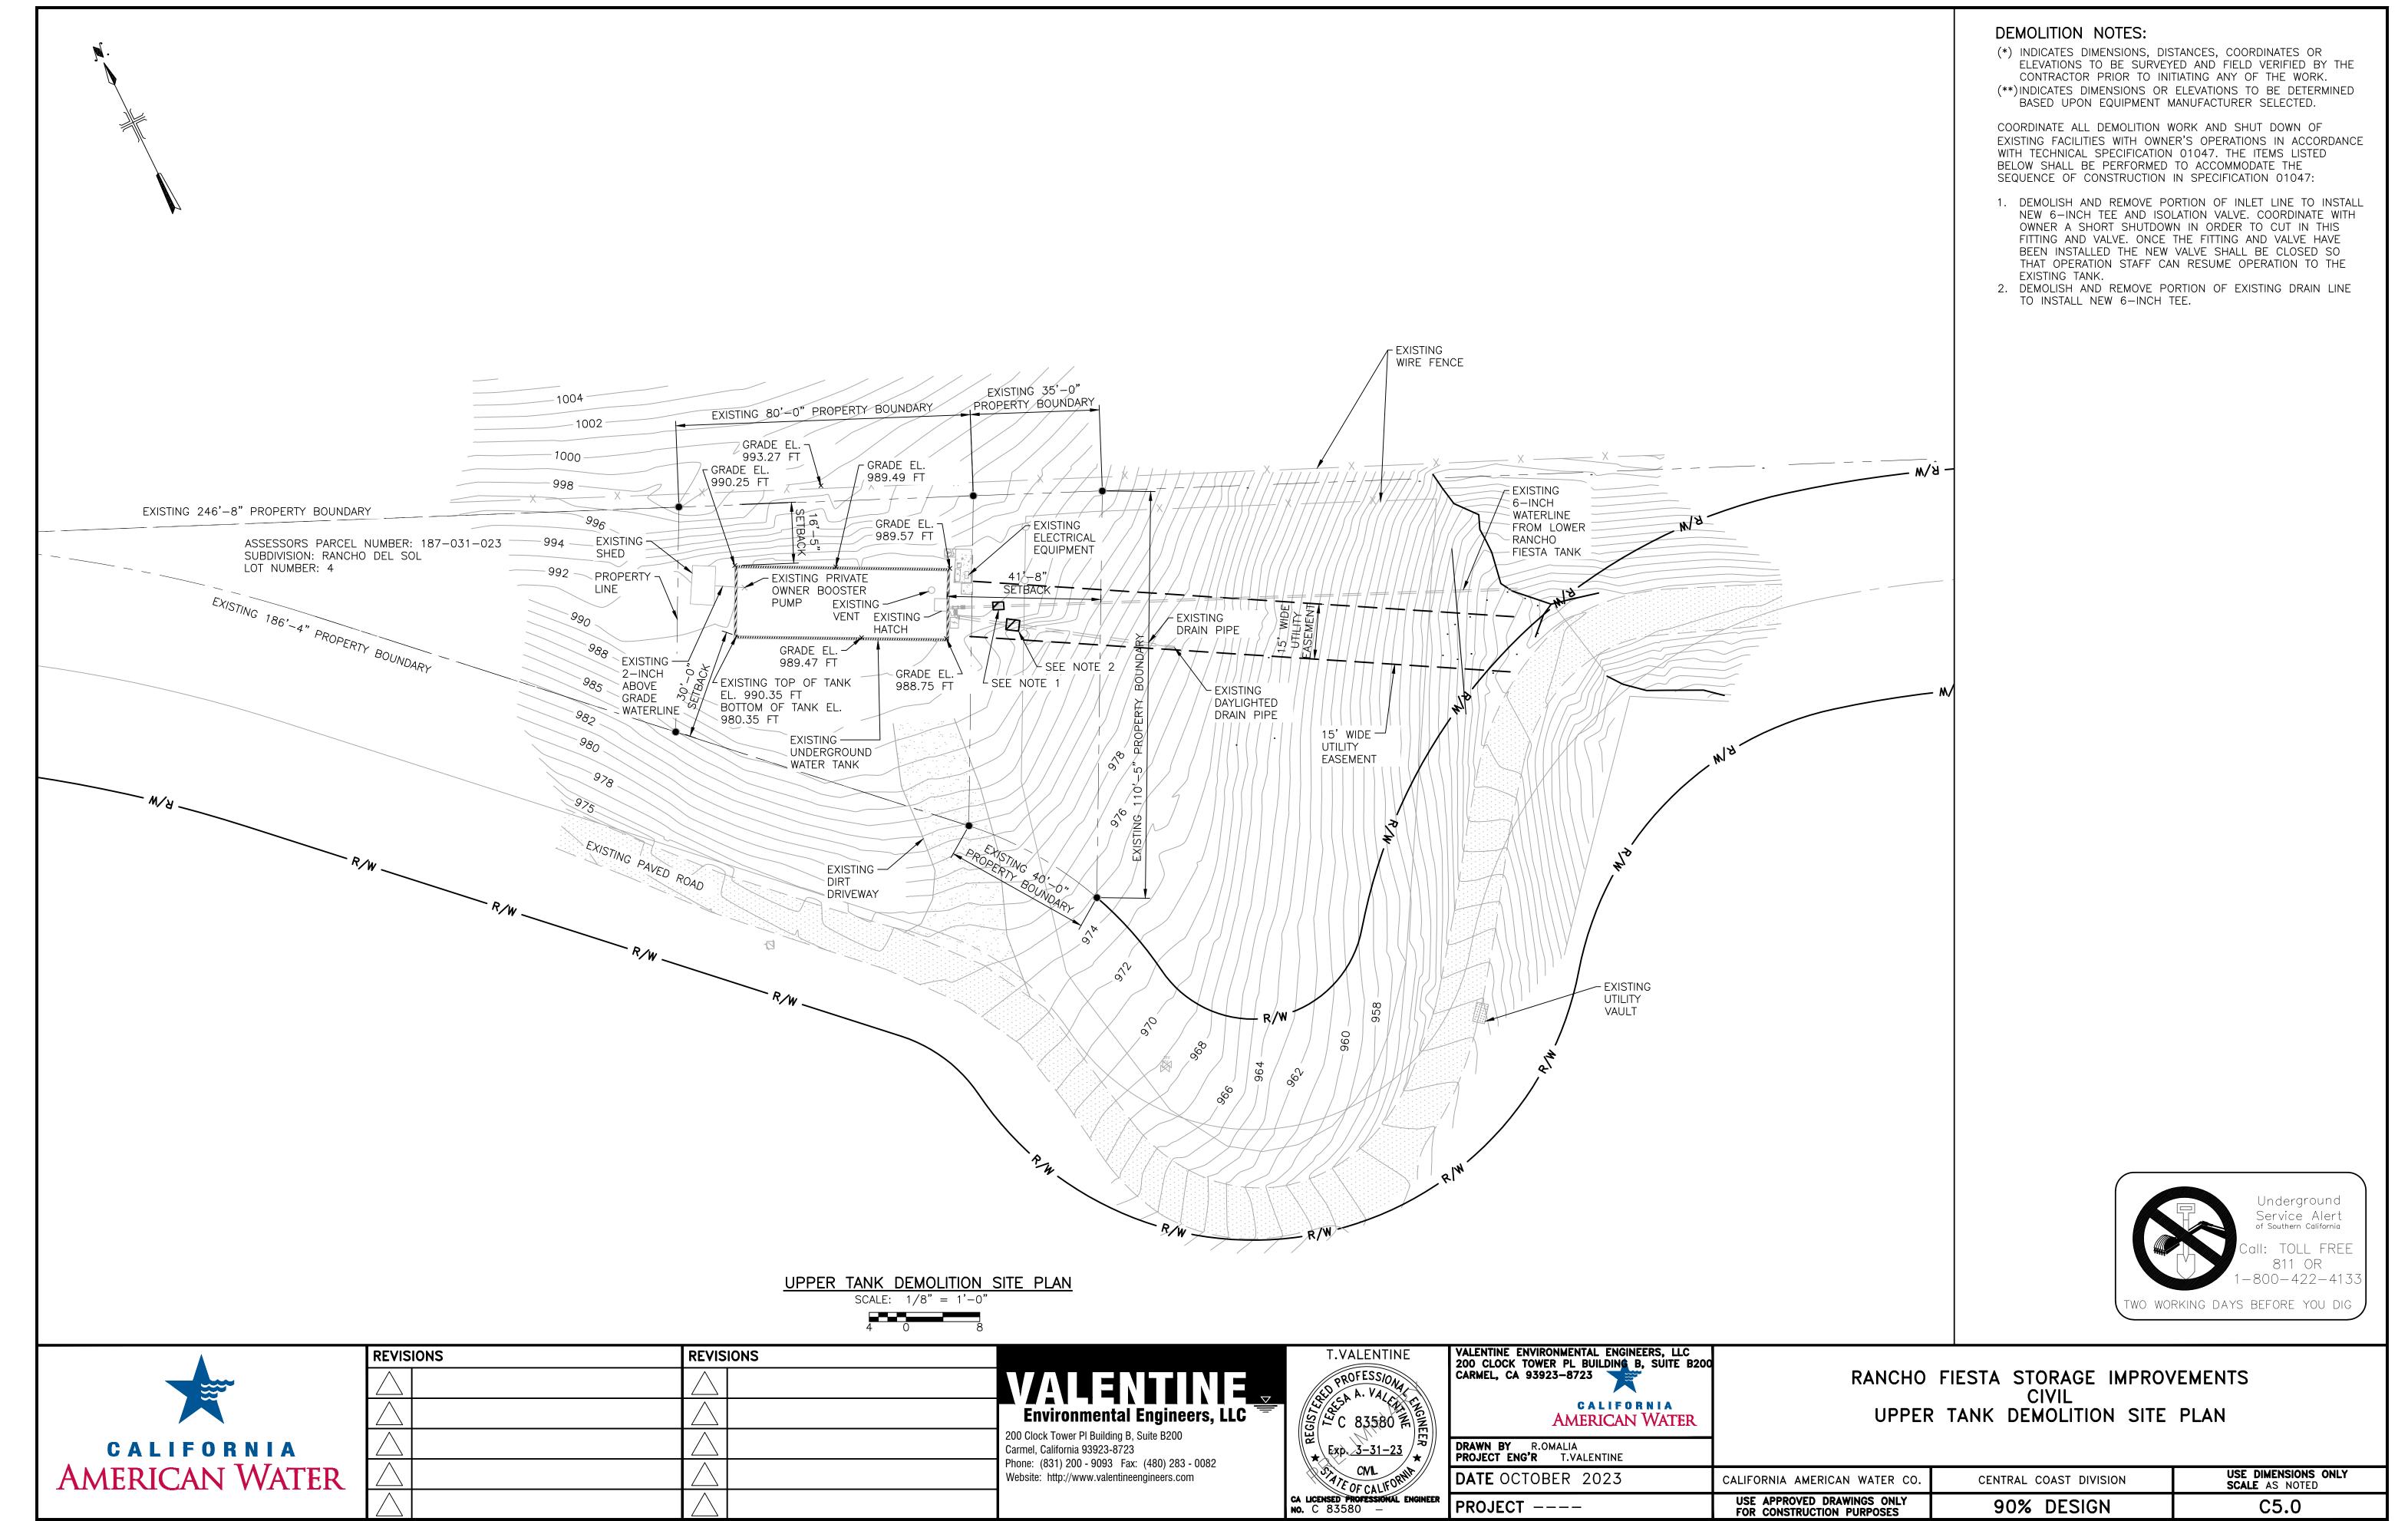

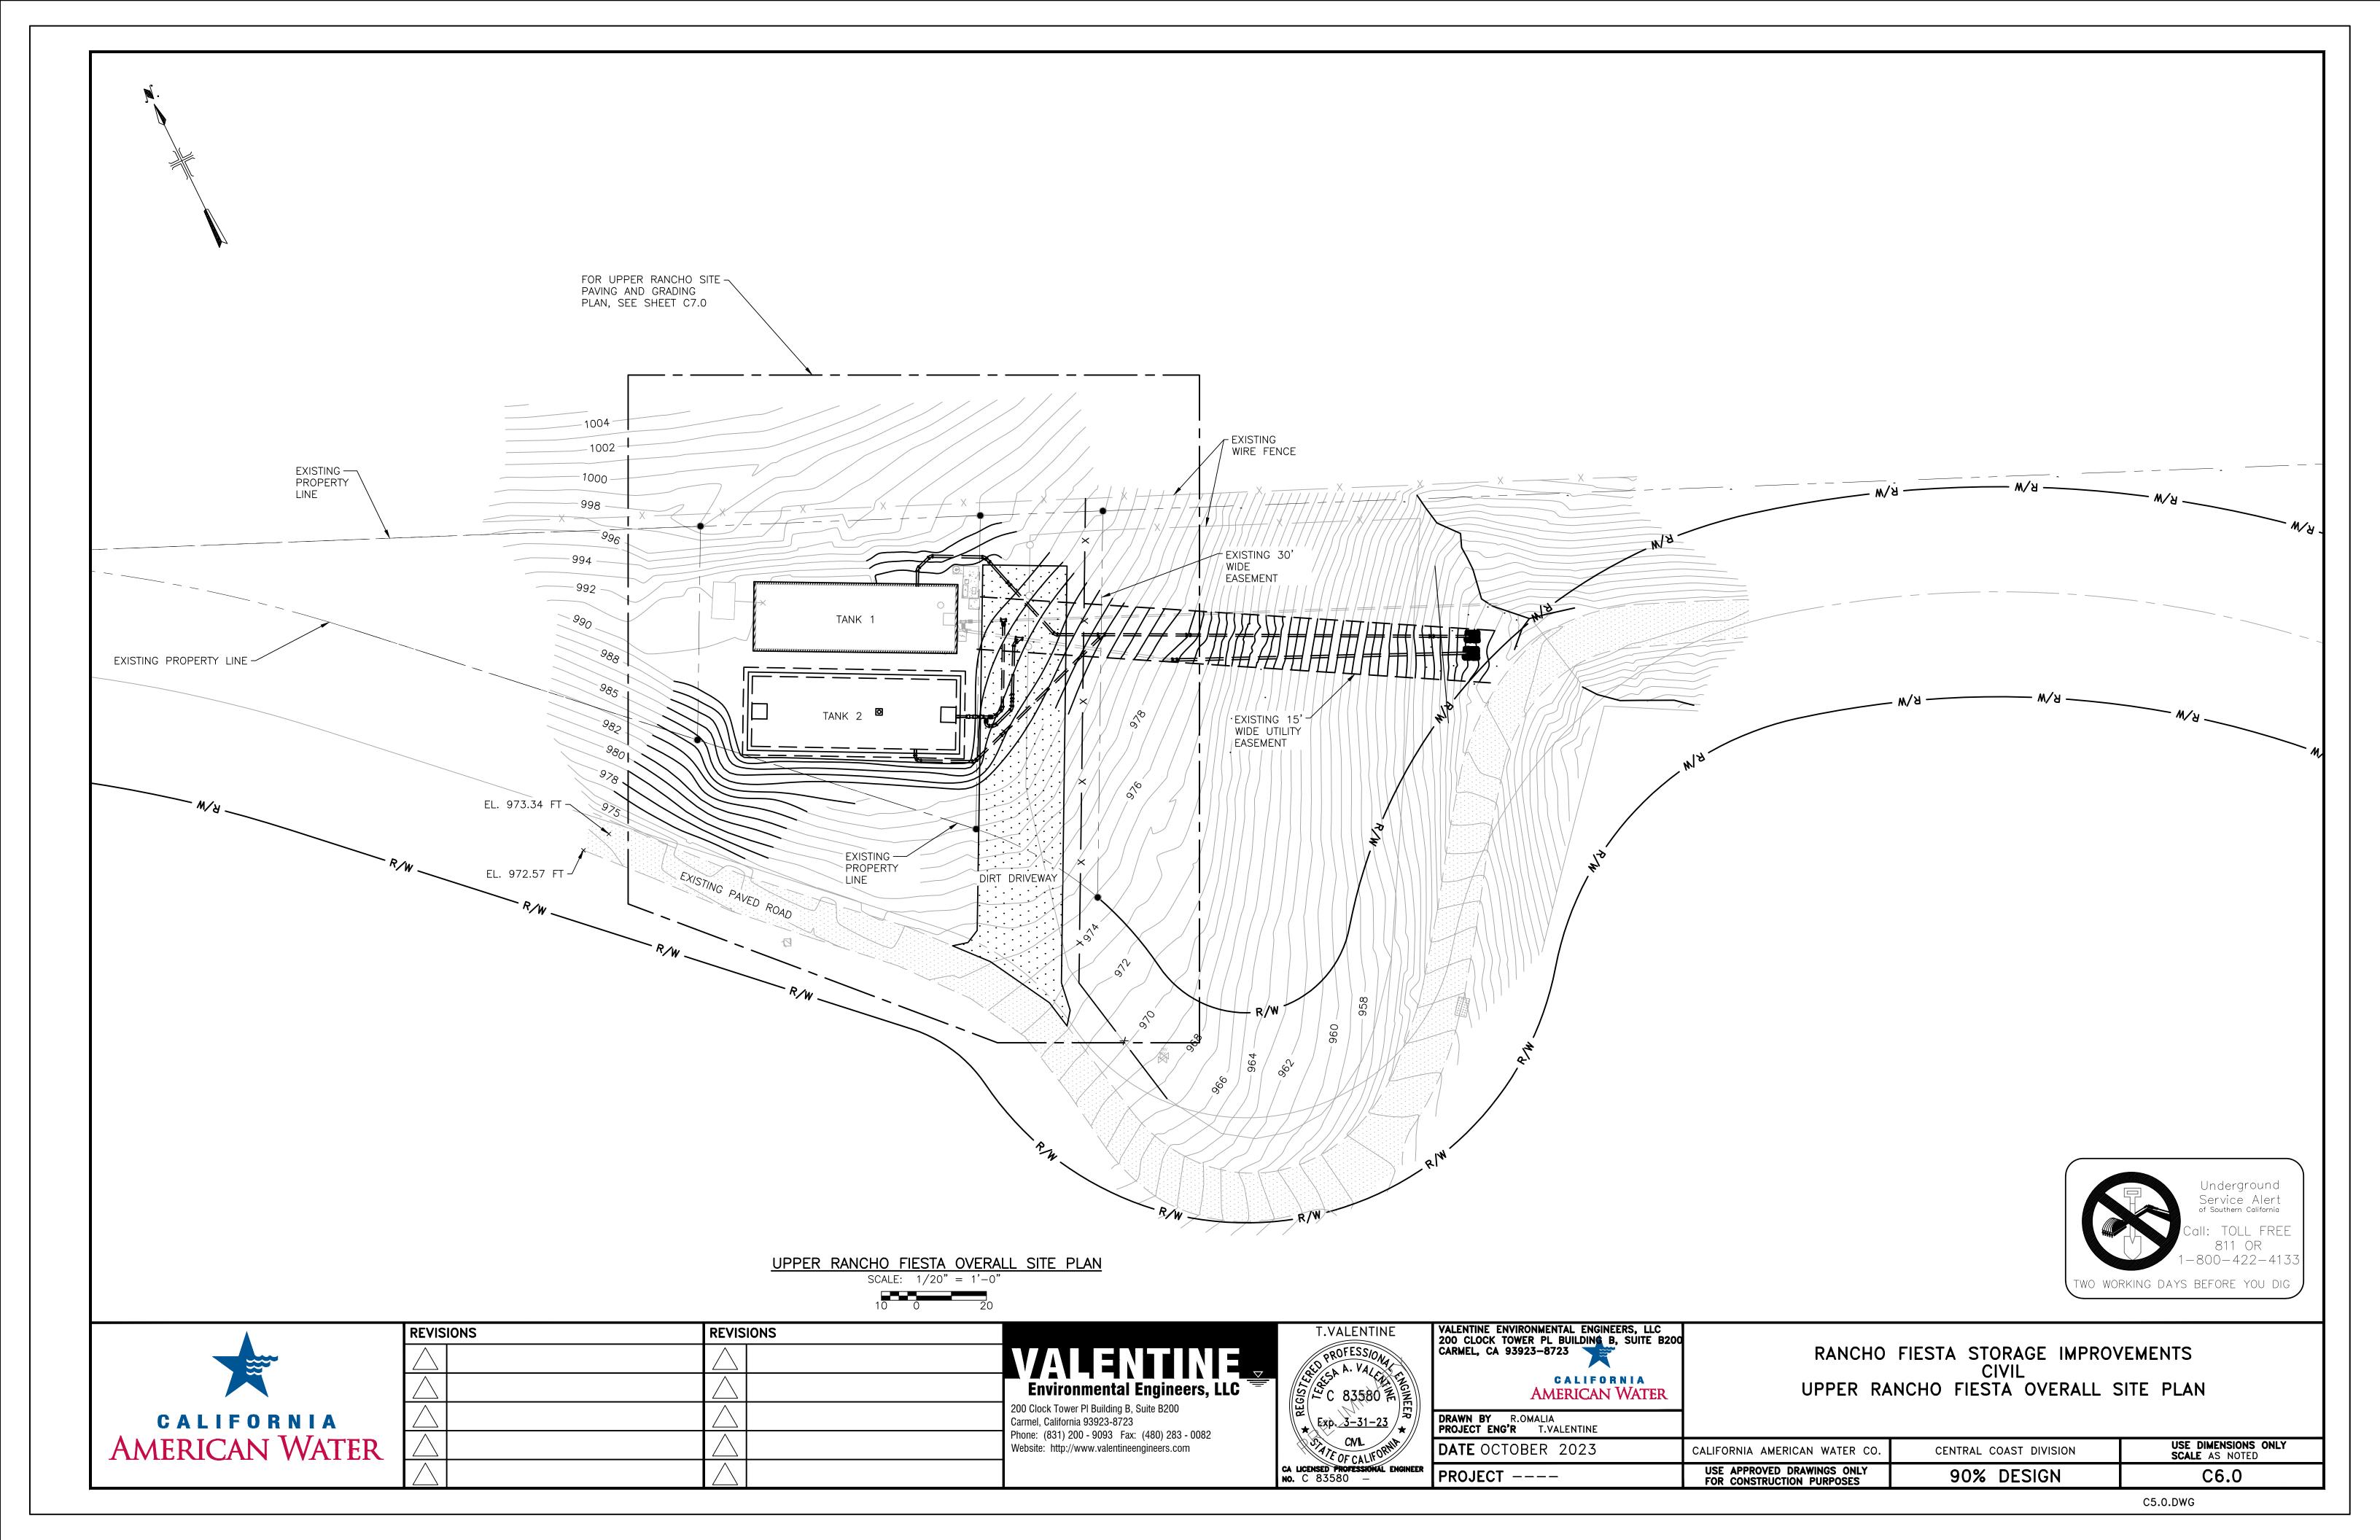

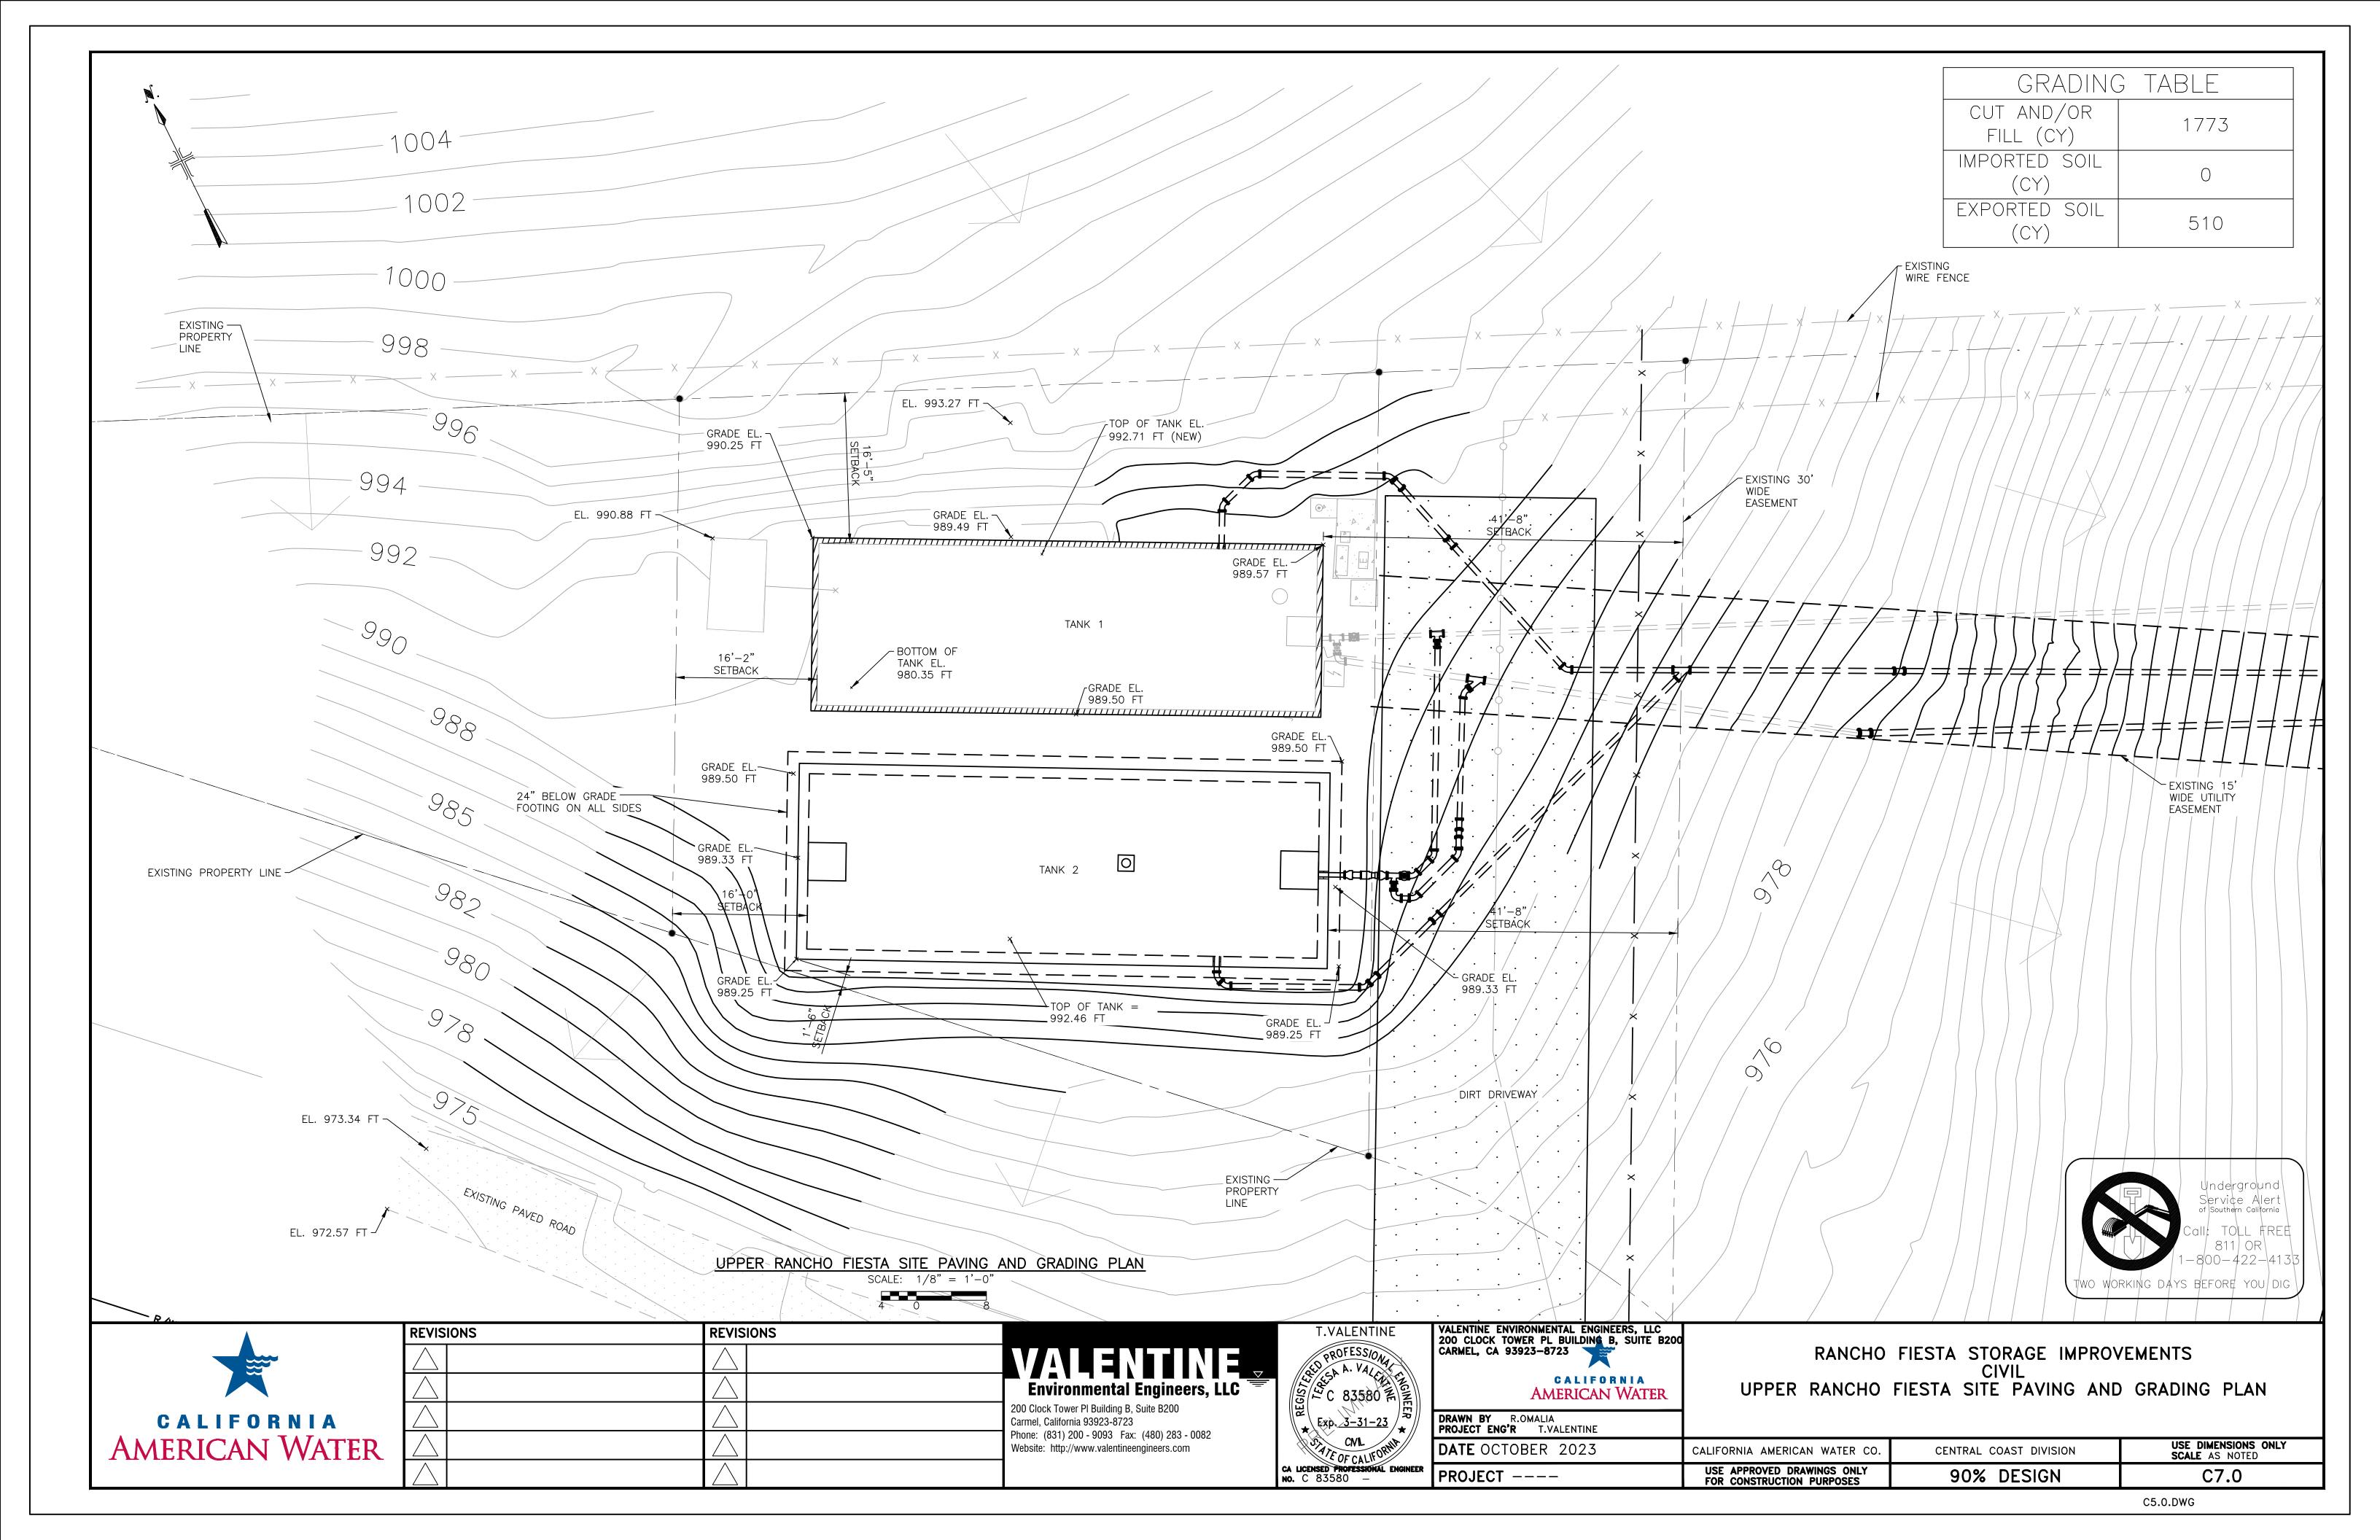


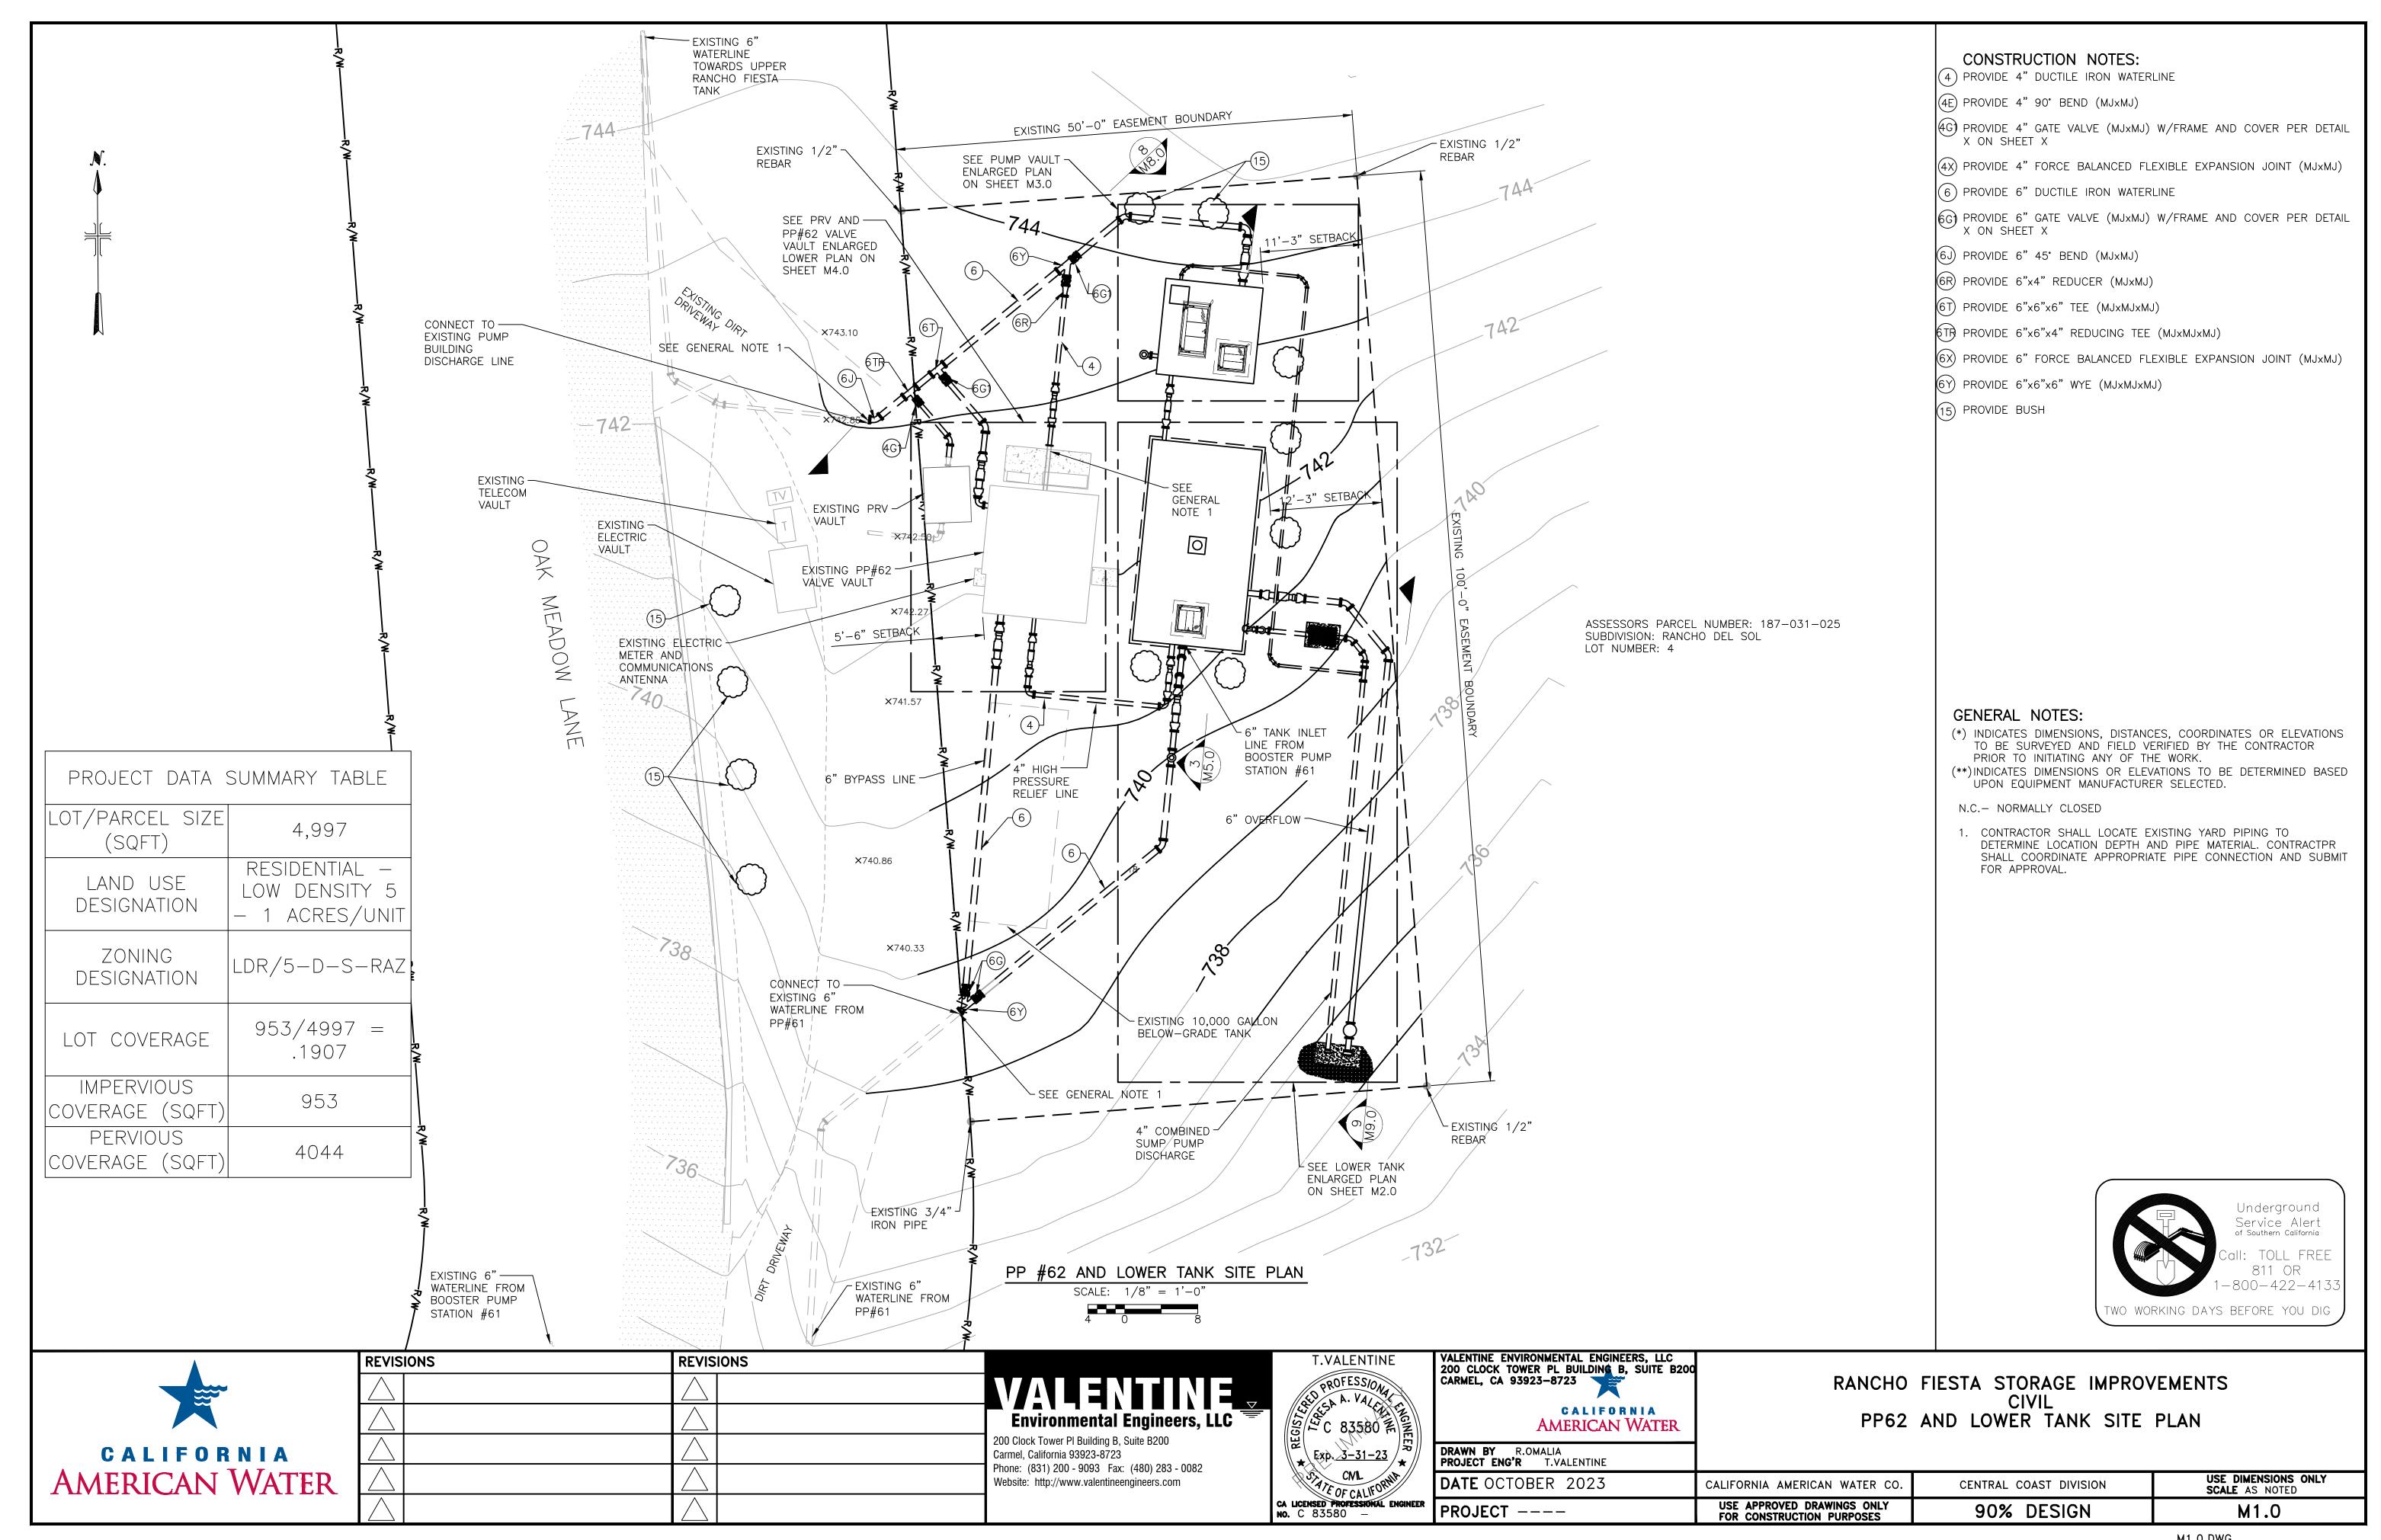


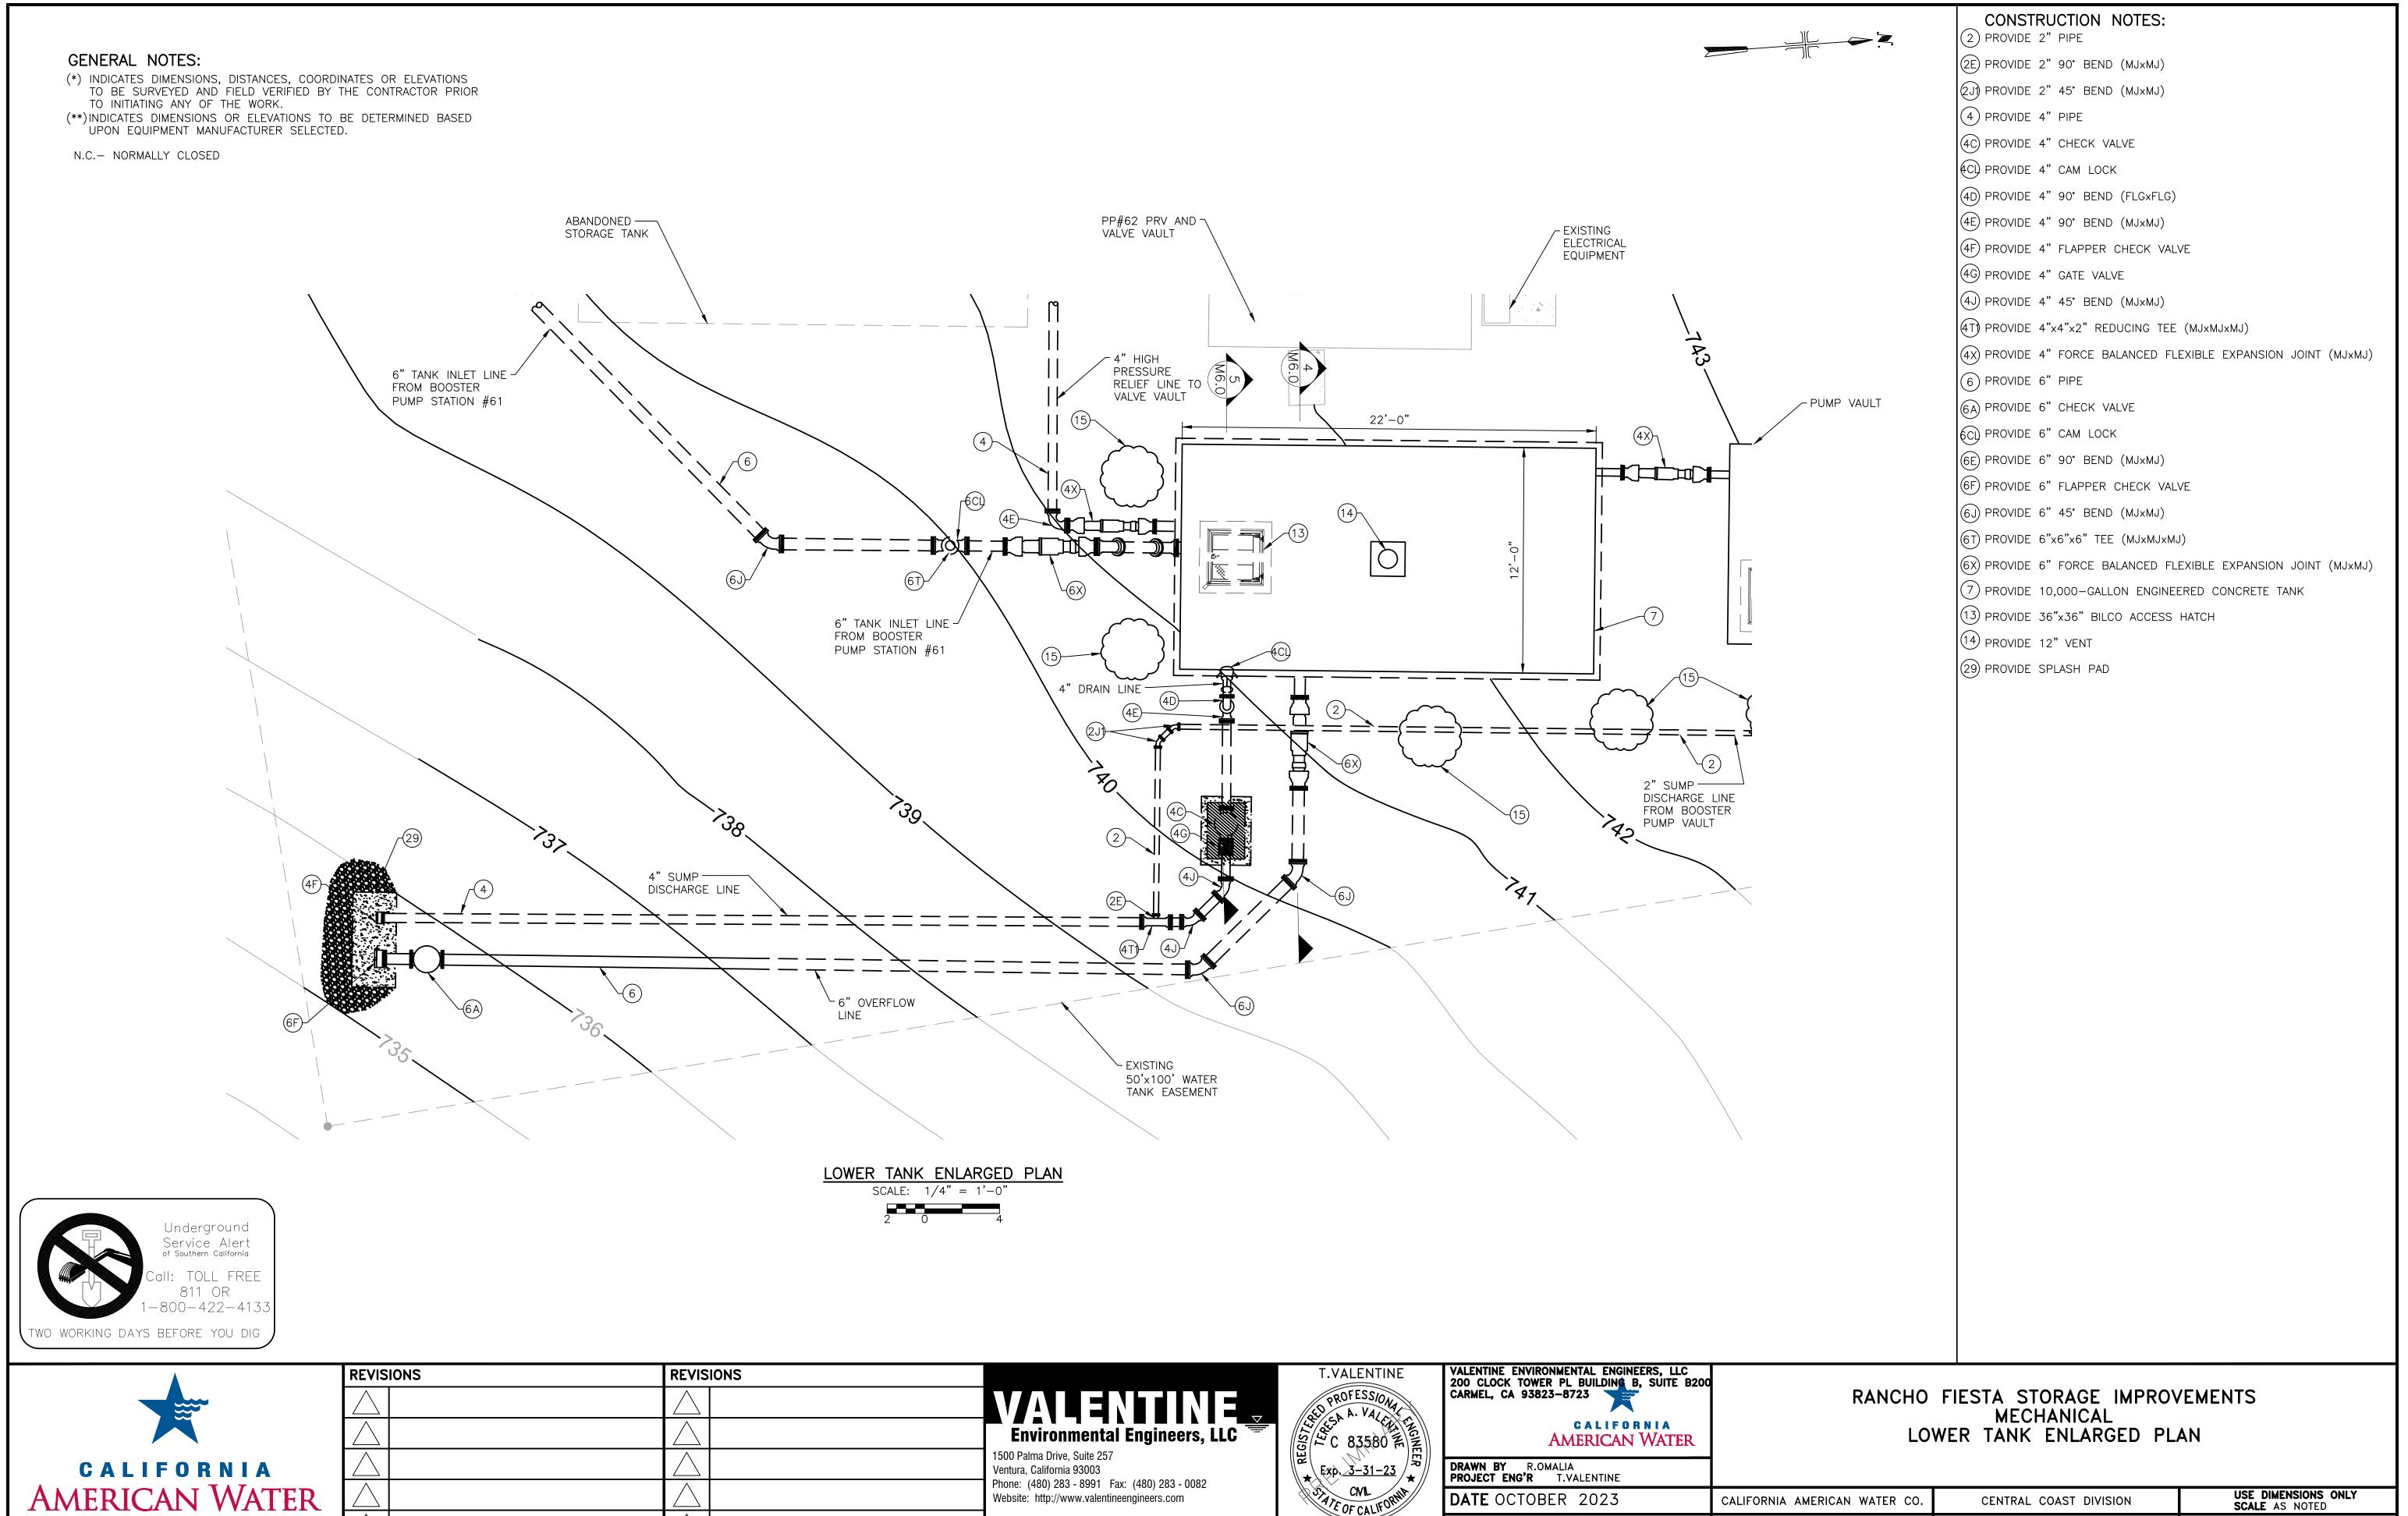


Website: http://www.valentineengineers.com

USE DIMENSIONS ONLY SCALE AS NOTED DATE OCTOBER 2023 CALIFORNIA AMERICAN WATER CO. CENTRAL COAST DIVISION ca licensed professional engineer no. C 83580 — USE APPROVED DRAWINGS ONLY FOR CONSTRUCTION PURPOSES 90% DESIGN M2.0PROJECT ----

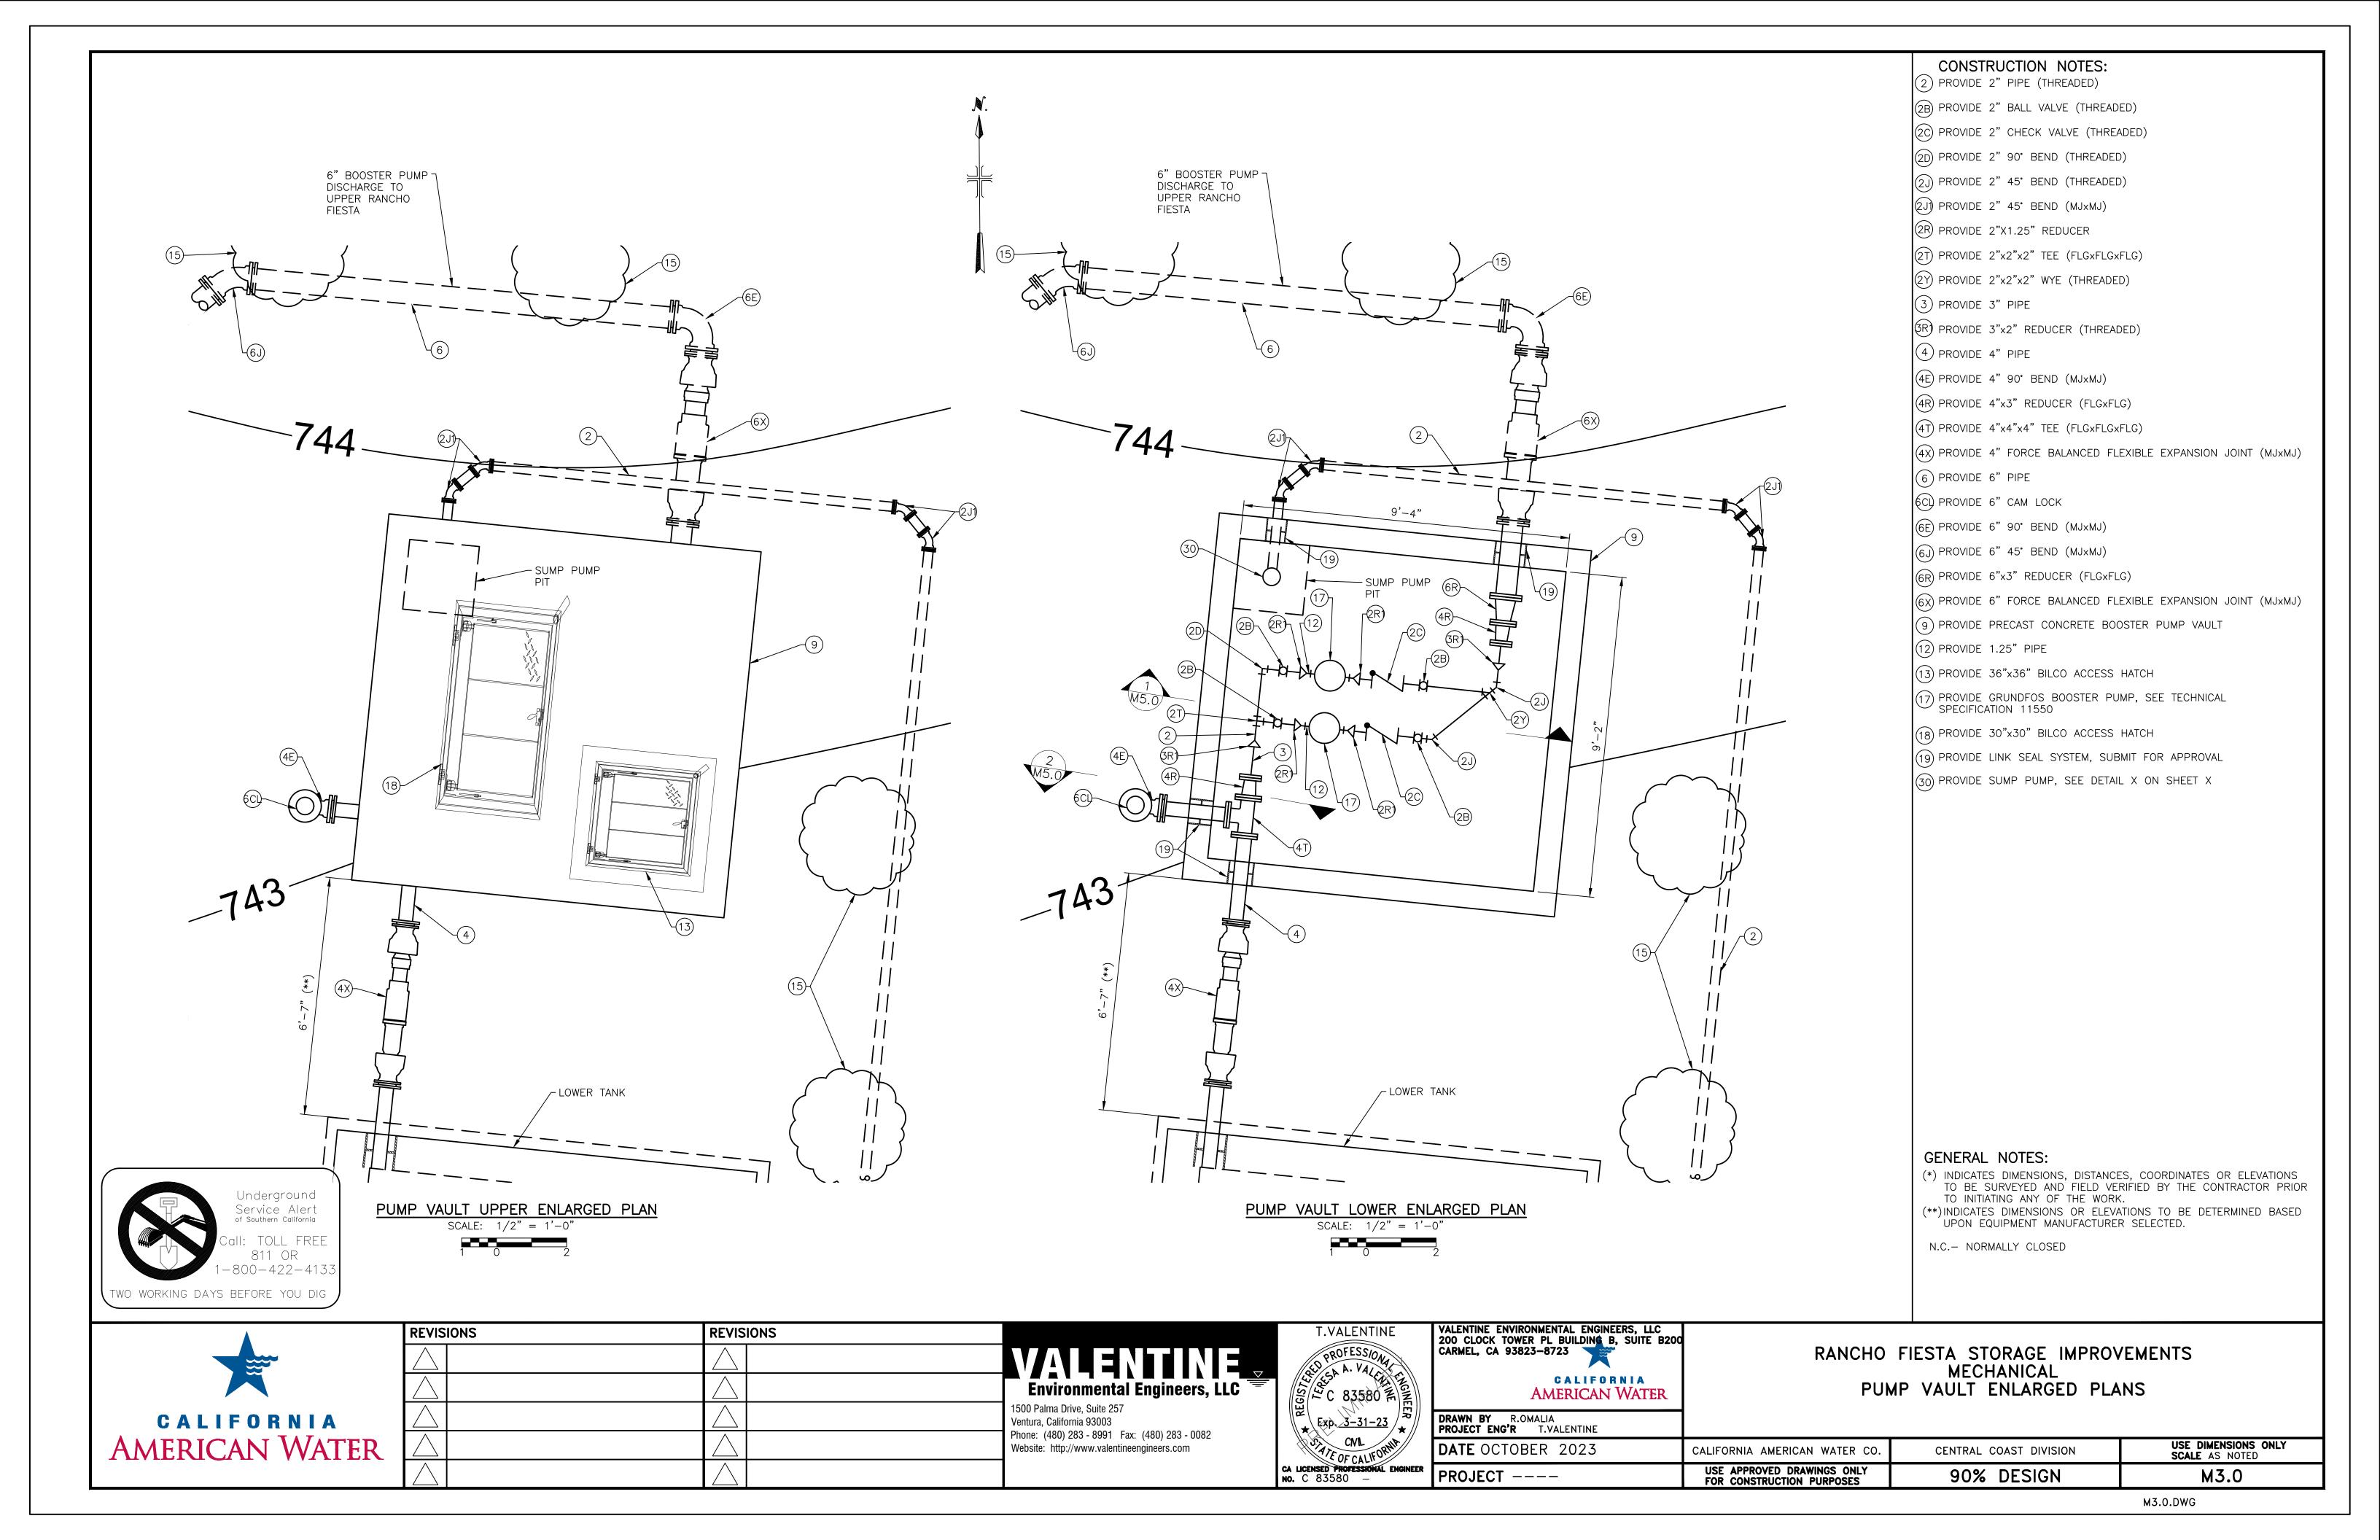


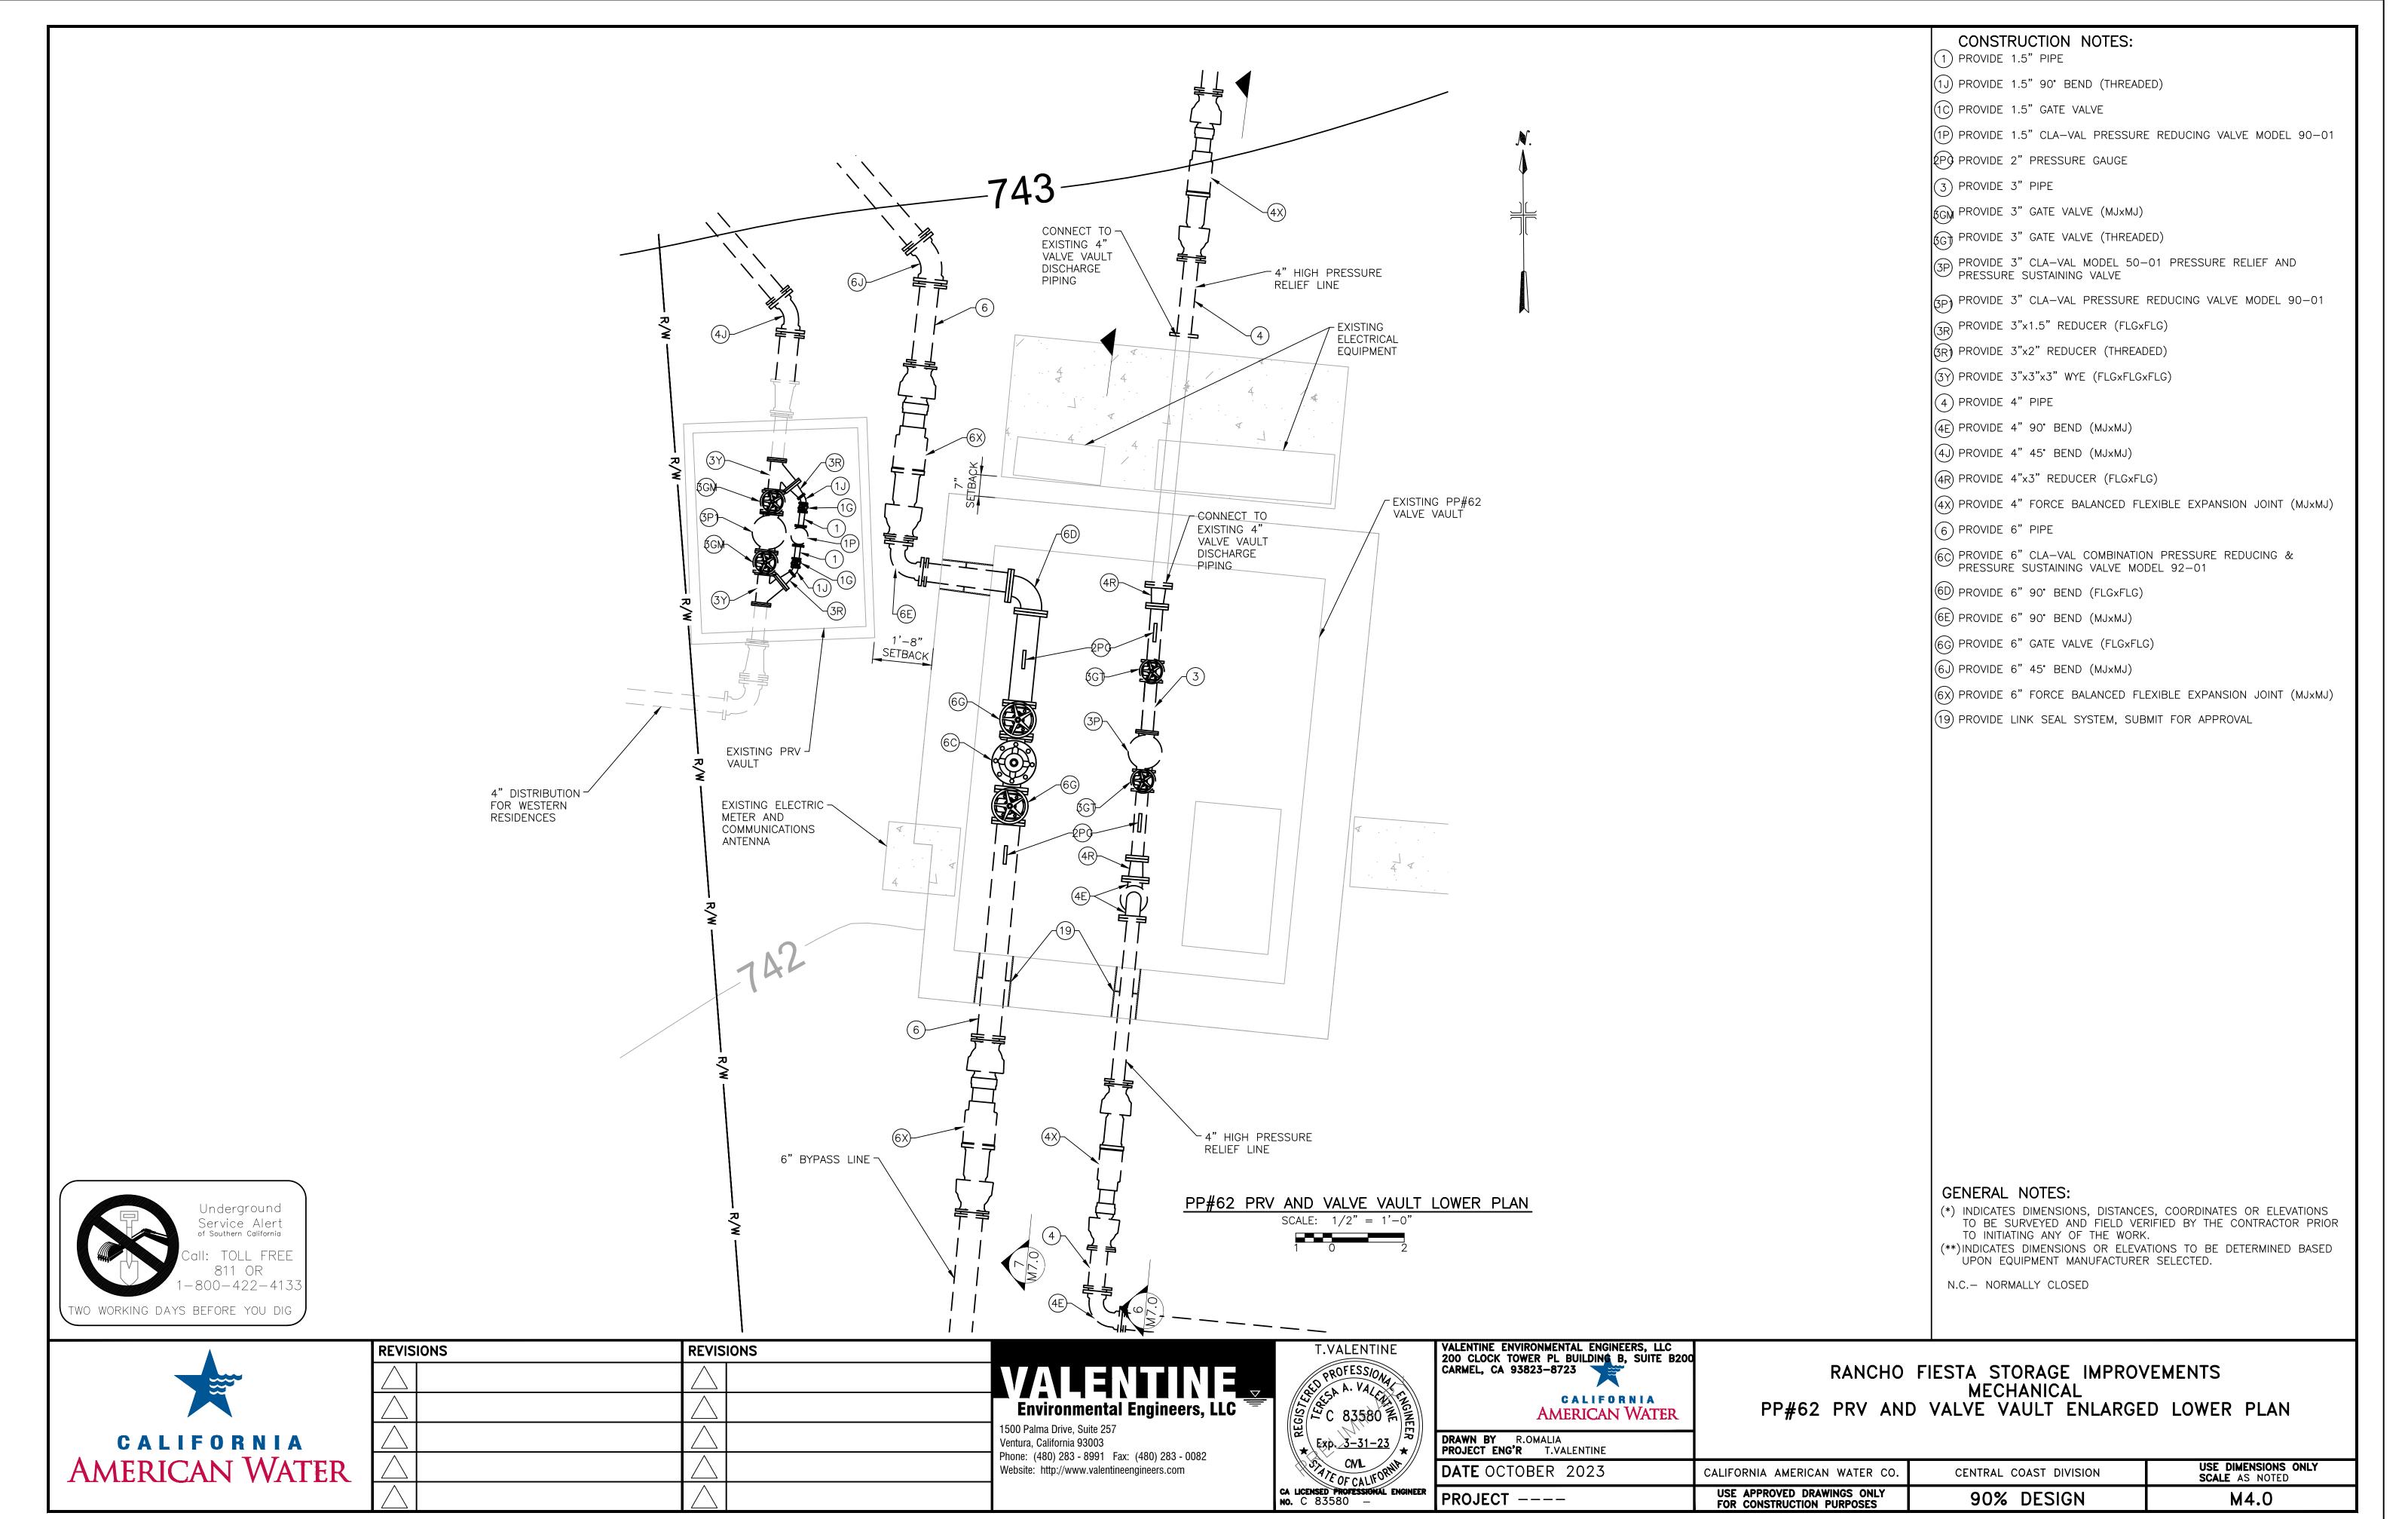


M4.0.DWG

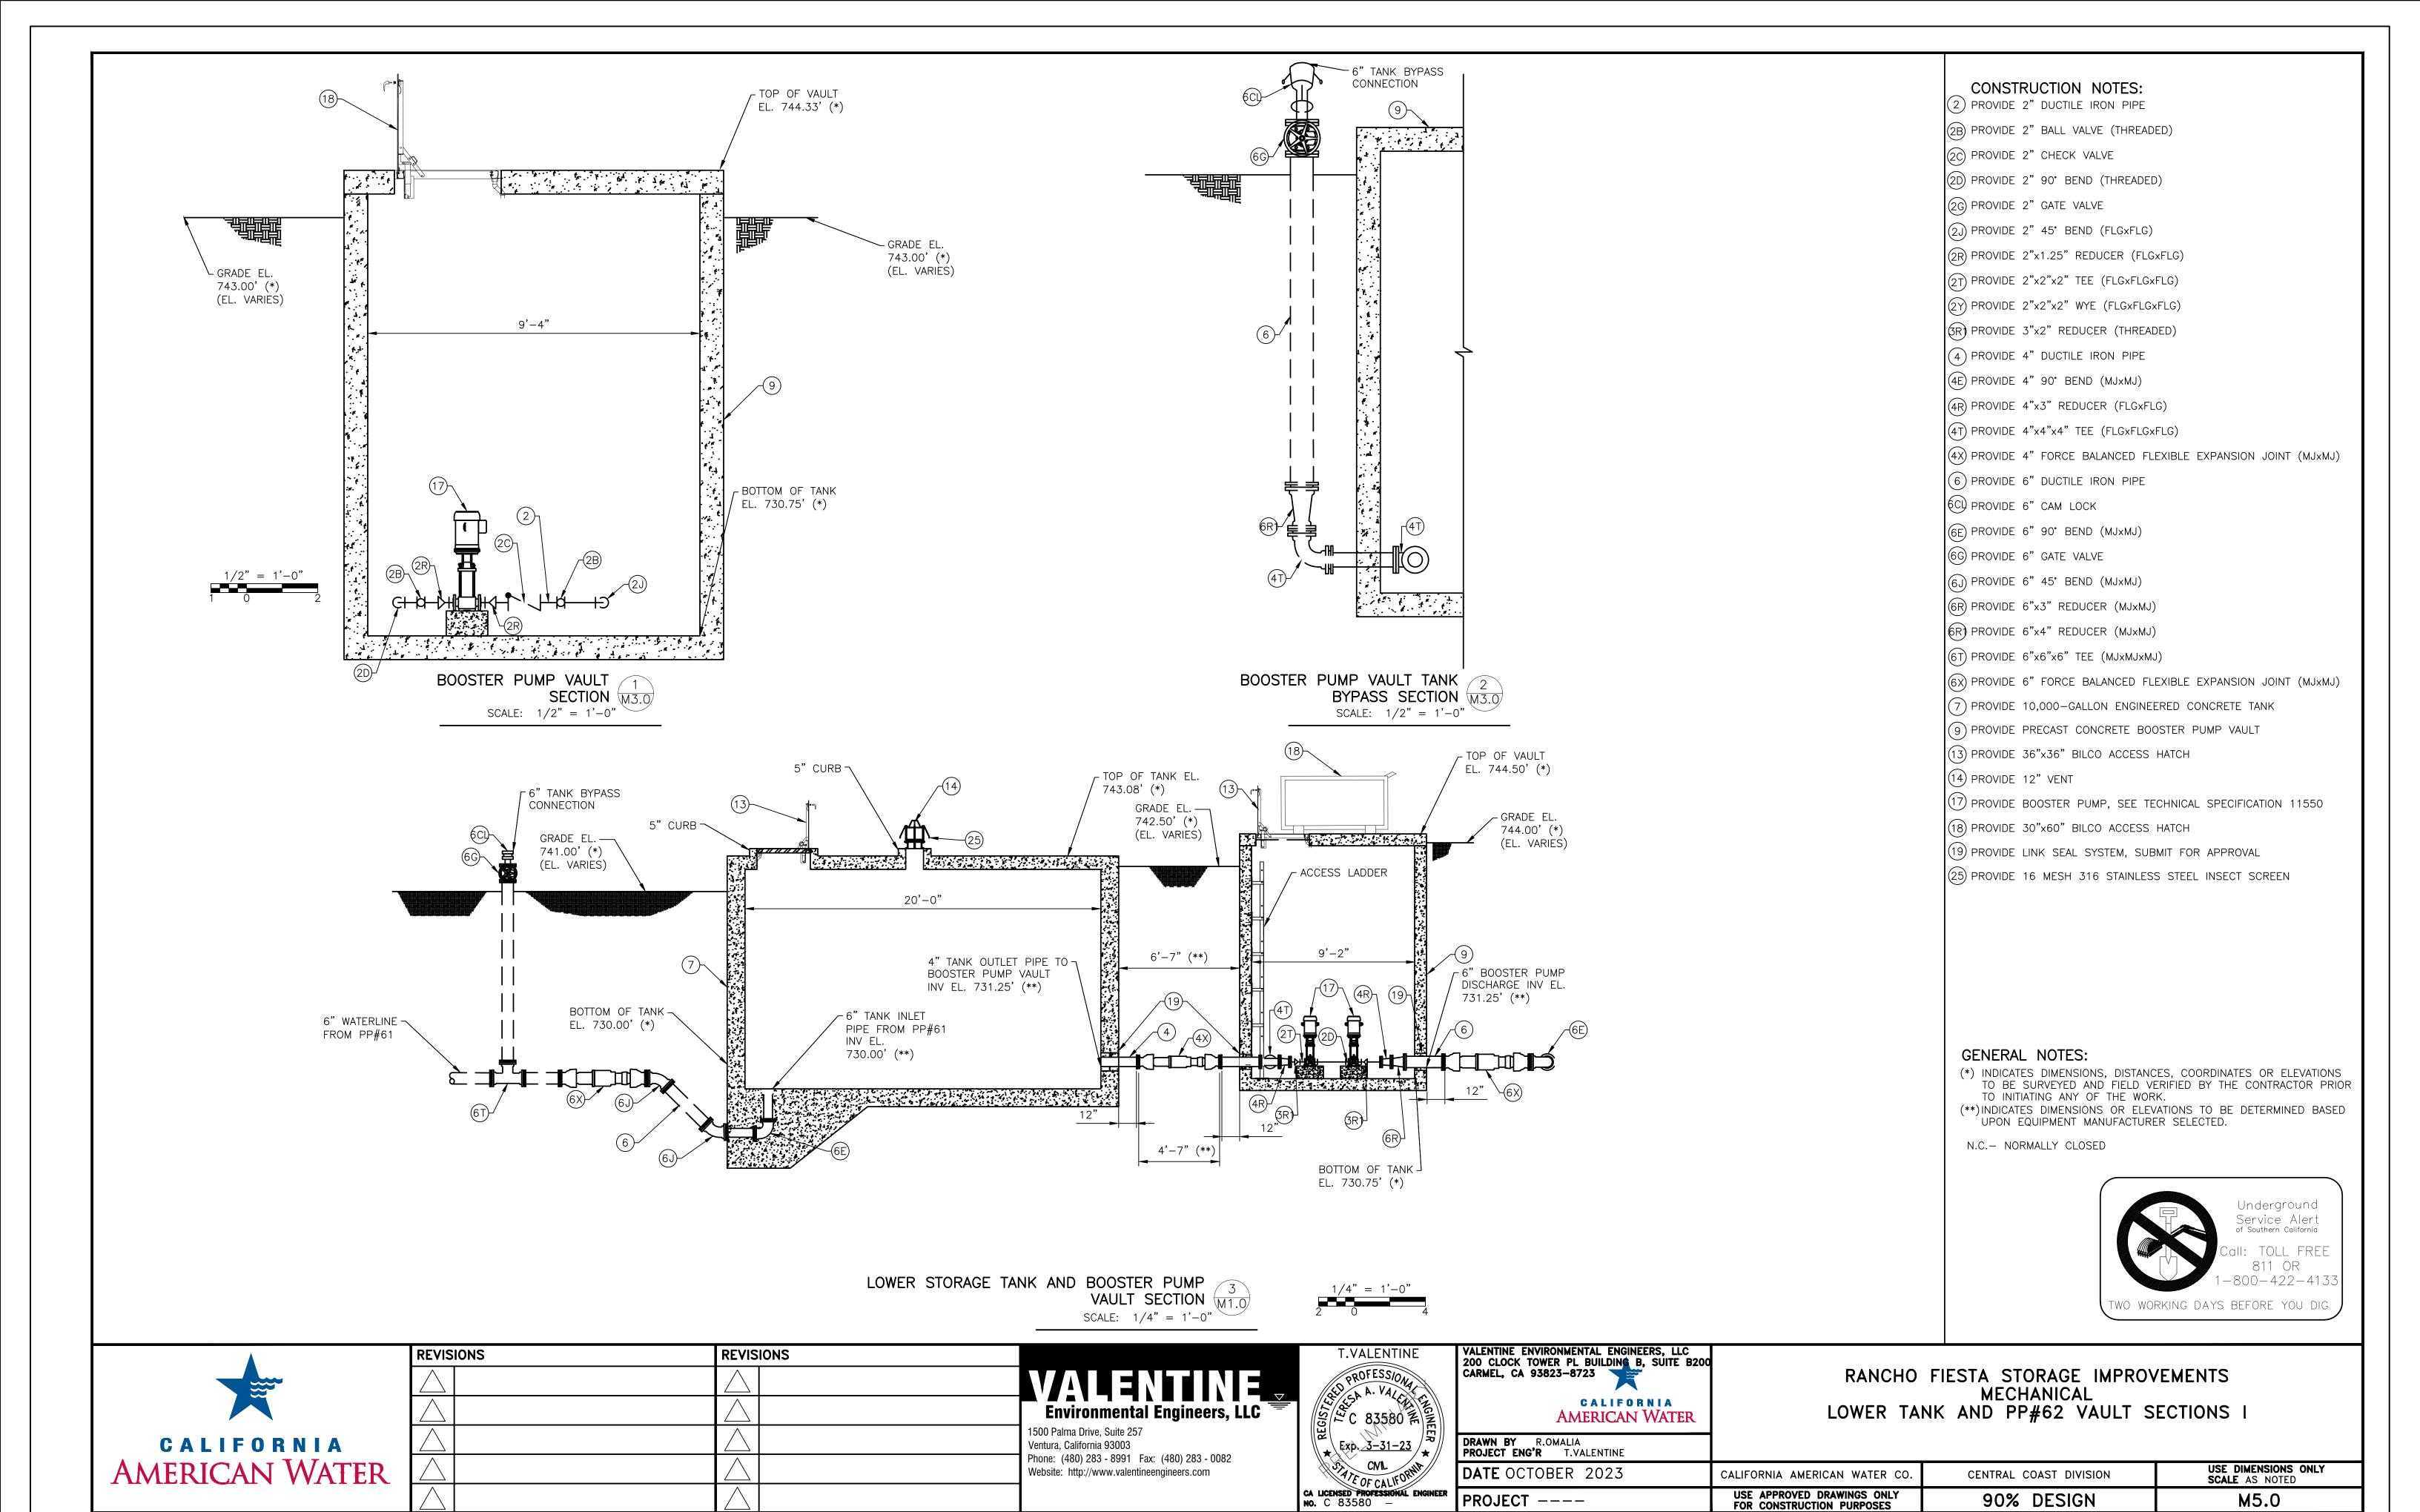

M5.0.DWG

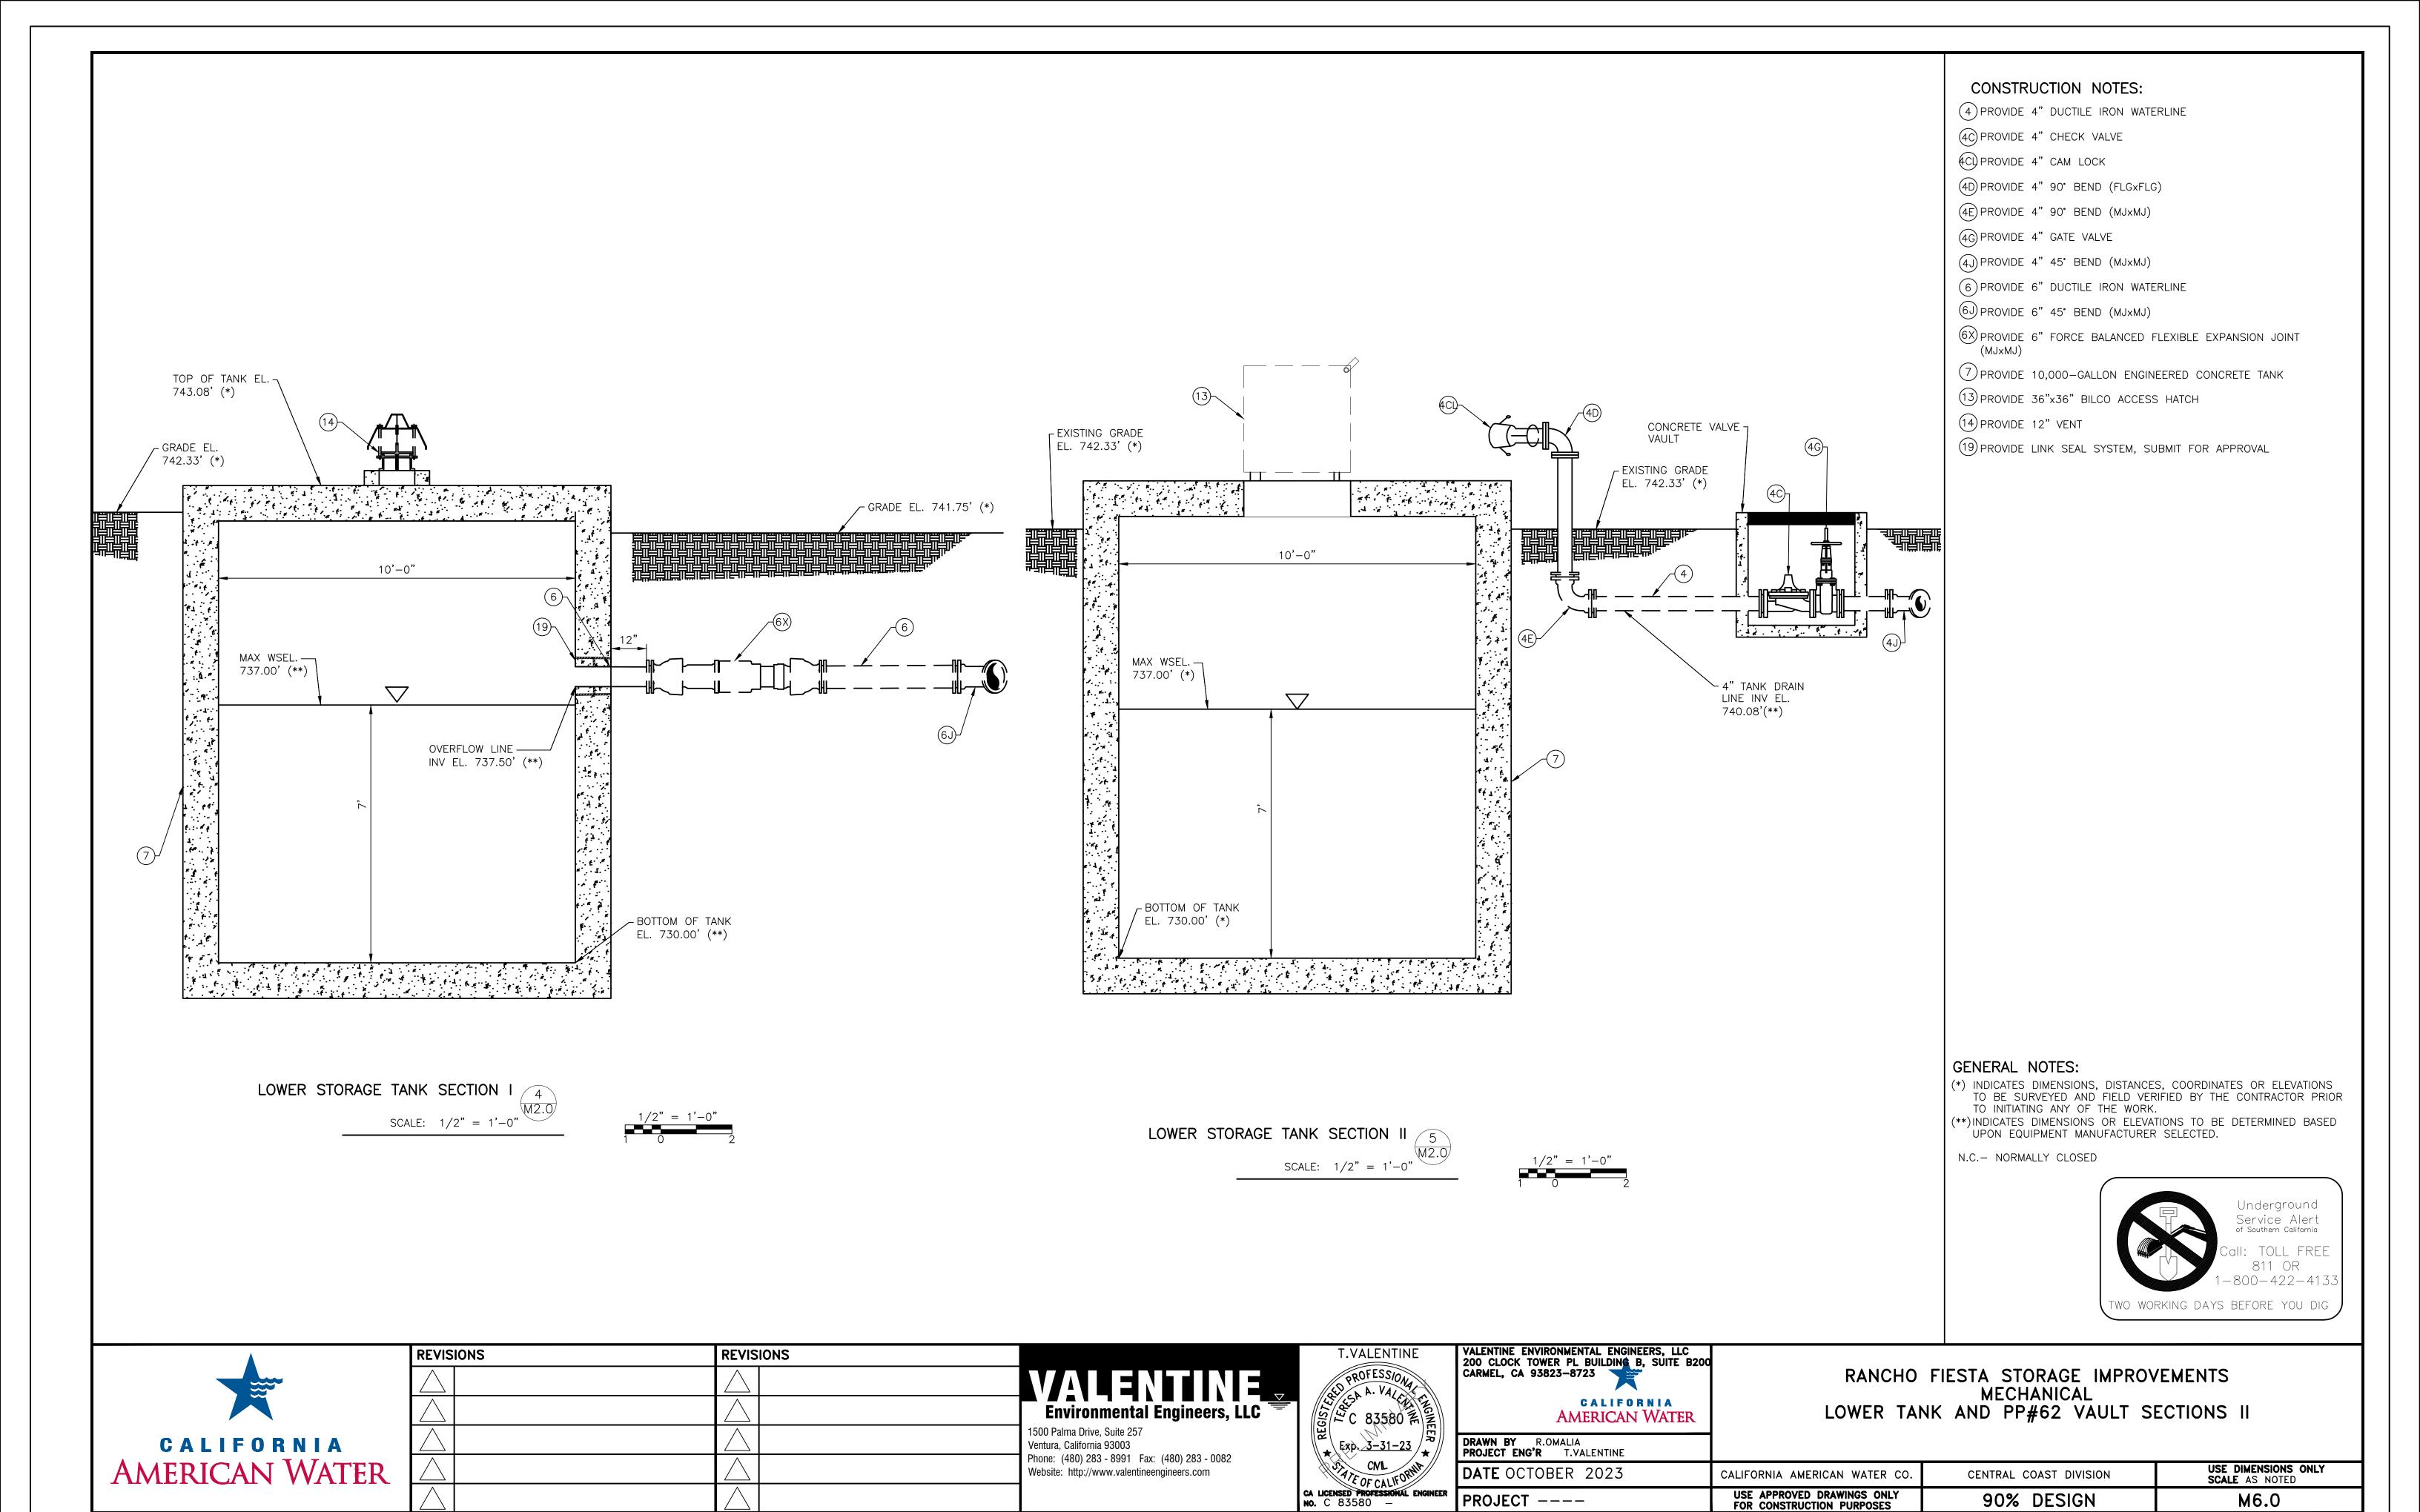

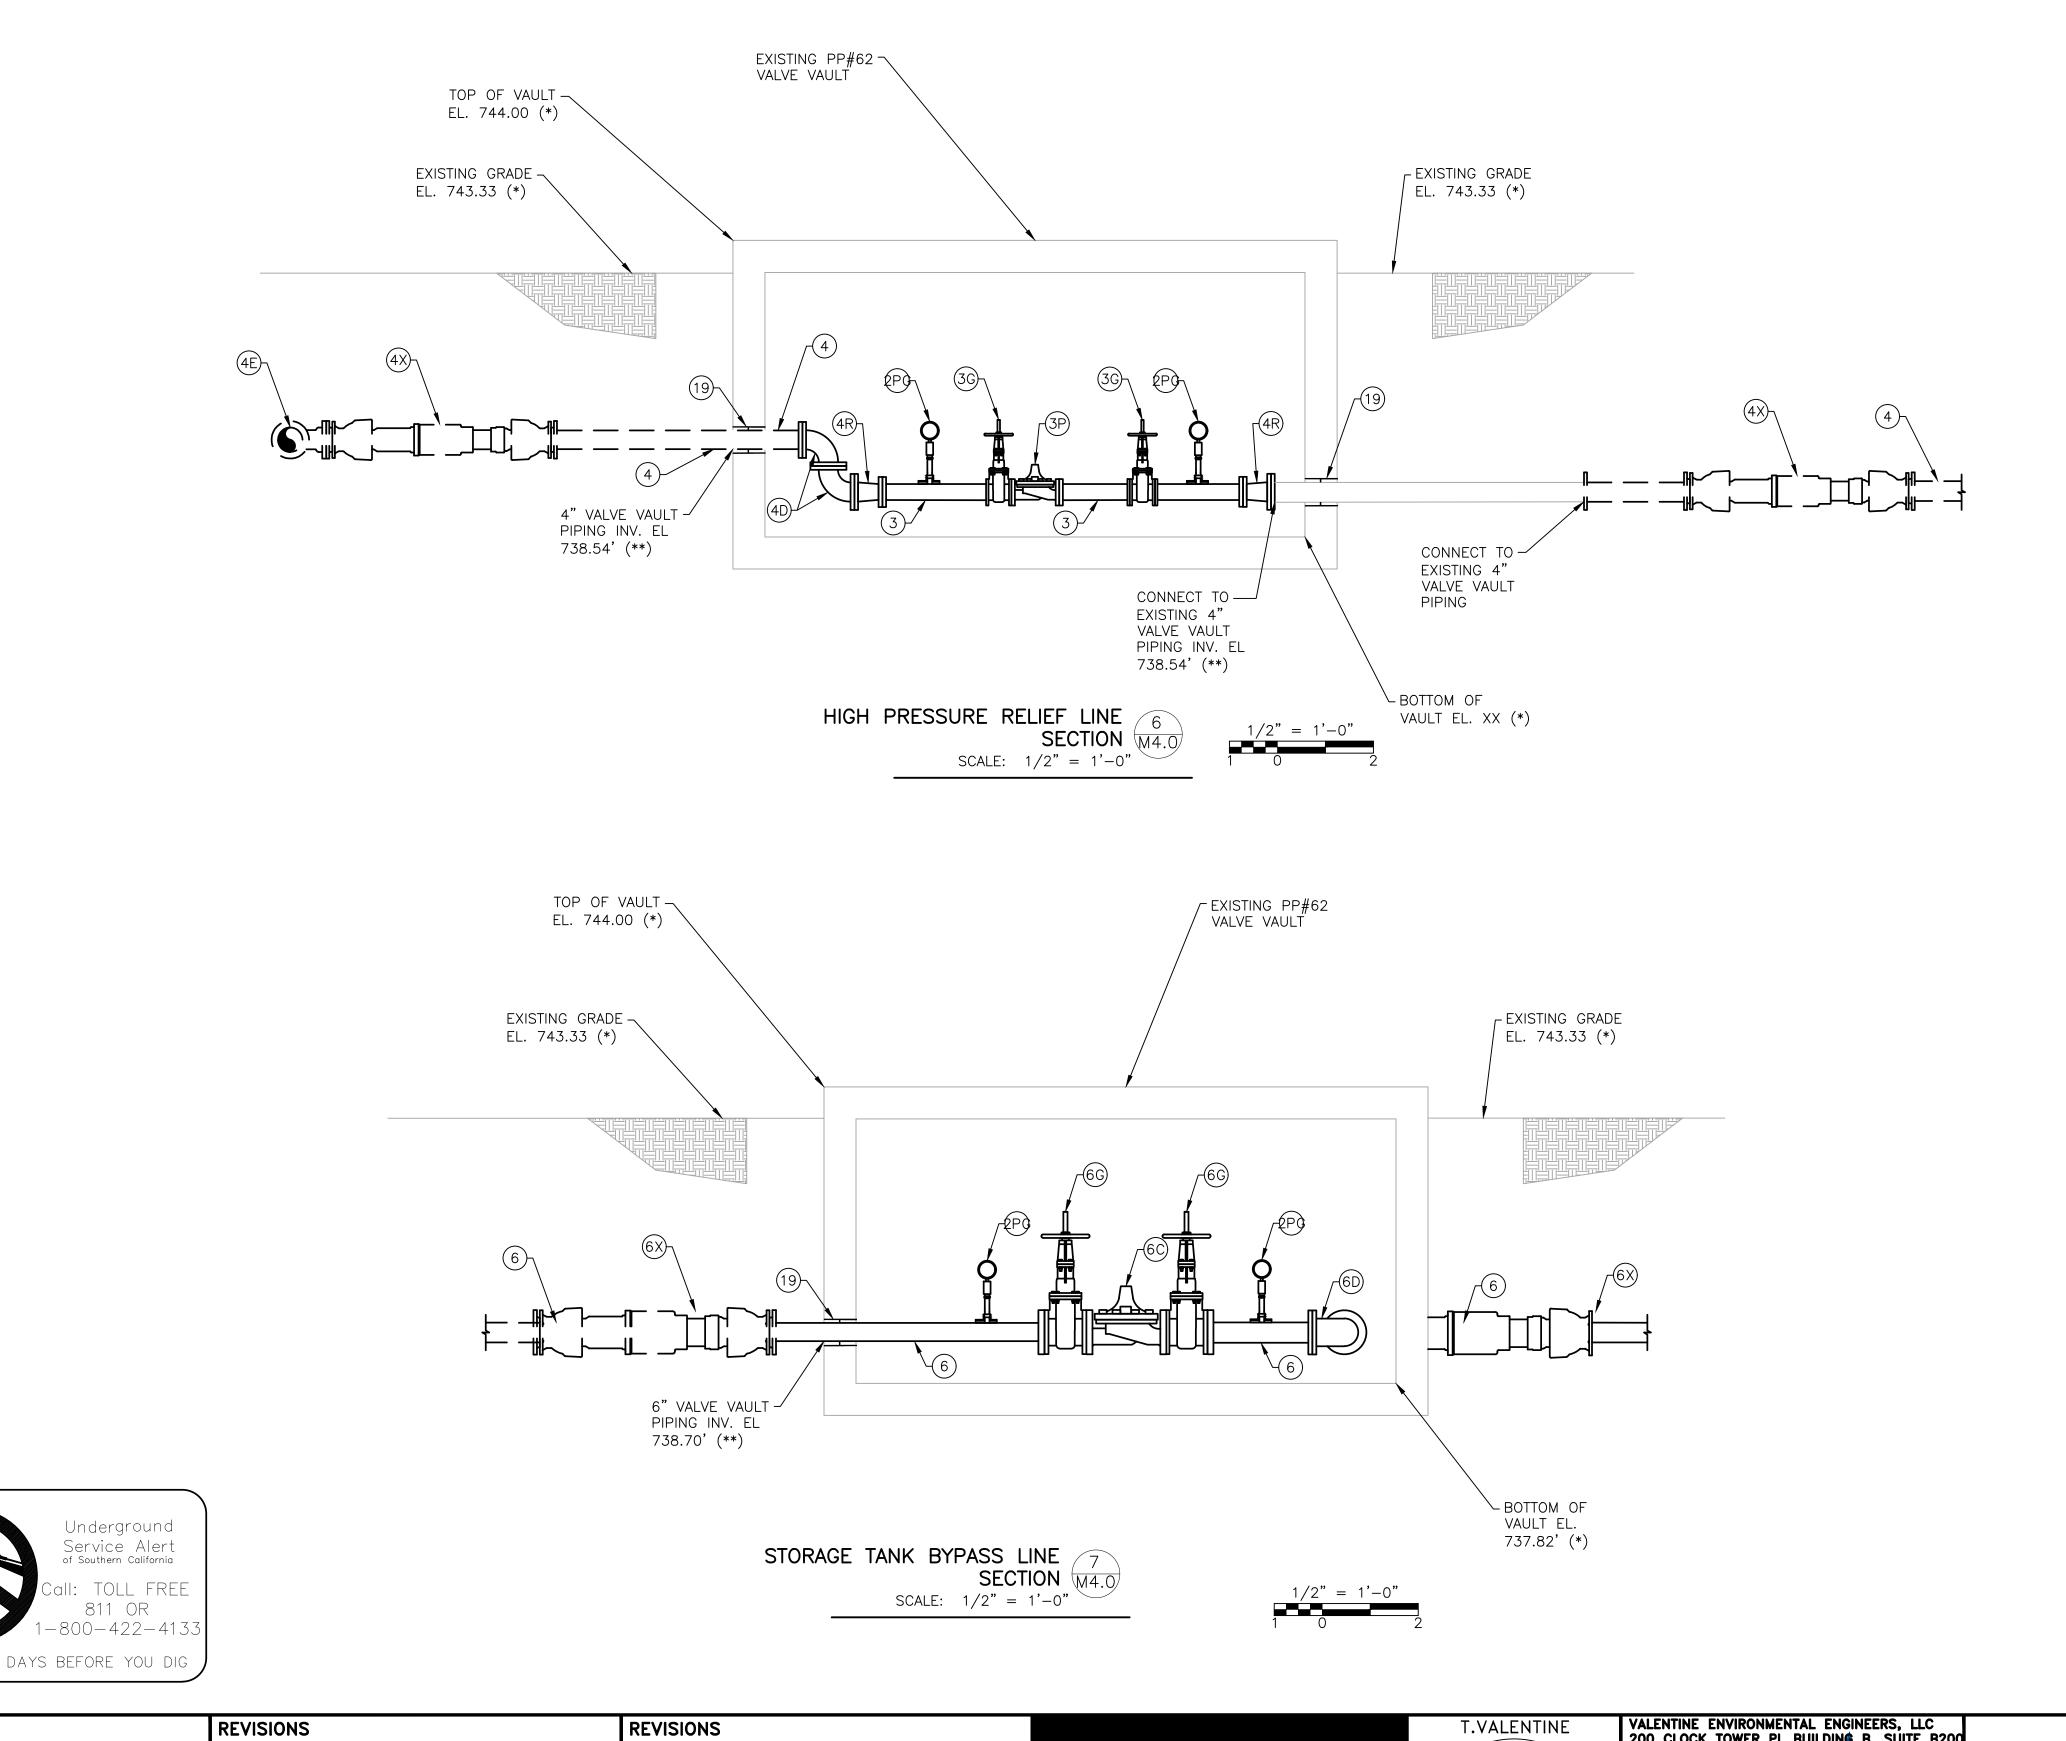

CONSTRUCTION NOTES:

- PROVIDE 2" PRESSURE GAUGE
- 3 PROVIDE 3" DUCTILE IRON WATERLINE
- 3G PROVIDE 3" GATE VALVE
- PROVIDE 3" CLA-VAL MODEL 50-01 PRESSURE RELIEF AND PRESSURE SUSTAINING VALVE
- (4) PROVIDE 4" DUCTILE IRON WATERLINE
- (4D) PROVIDE 4" 90° BEND (FLGxFLG)
- (4E) PROVIDE 4" 90° BEND (MJ×MJ)
- (4R) PROVIDE 4"x3" REDUCER (MJxMJ)
- (4X) PROVIDE 4" FORCE BALANCED FLEXIBLE EXPANSION JOINT (MJxMJ)
- (6) PROVIDE 6" DUCTILE IRON WATERLINE
- 6C PROVIDE 6" CLA-VAL COMBINATION PRESSURE REDUCING & PRESSURE SUSTAINING VALVE MODEL 92-01
- 6D PROVIDE 6" 90° BEND (FLGxFLG)
- 6G PROVIDE 6" GATE VALVE
- (6X) PROVIDE 6" FORCE BALANCED FLEXIBLE EXPANSION JOINT (MJxMJ)
- (19) PROVIDE LINK SEAL SYSTEM, SUBMIT FOR APPROVAL

GENERAL NOTES:


- (*) INDICATES DIMENSIONS, DISTANCES, COORDINATES OR ELEVATIONS TO BE SURVEYED AND FIELD VERIFIED BY THE CONTRACTOR PRIOR TO INITIATING ANY OF THE WORK.
- (**) INDICATES DIMENSIONS OR ELEVATIONS TO BE DETERMINED BASED UPON EQUIPMENT MANUFACTURER SELECTED.

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VALENTINE ENVIRONMENTAL ENGINEERS, LLC
200 CLOCK TOWER PL BUILDING B, SUITE B200
CARMEL, CA 93823-8723


C A L I F O R N I A
AMERICAN WATER

RANCHO FIESTA STORAGE IMPROVEMENTS

MECHANICAL

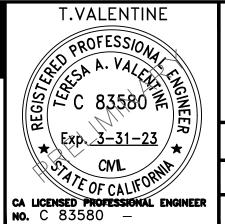LOWER TANK AND PP#62 VAULT SECTIONS III

	USE APPROVED DRAWINGS ONLY FOR CONSTRUCTION PURPOSES	90% DESIGN	M7.0
DATE OCTOBER 2023 CAL	ALIFORNIA AMERICAN WATER CO.	CENTRAL COAST DIVISION	USE DIMENSIONS ONLY SCALE AS NOTED
DRAWN BY R.OMALIA PROJECT ENG'R T.VALENTINE			

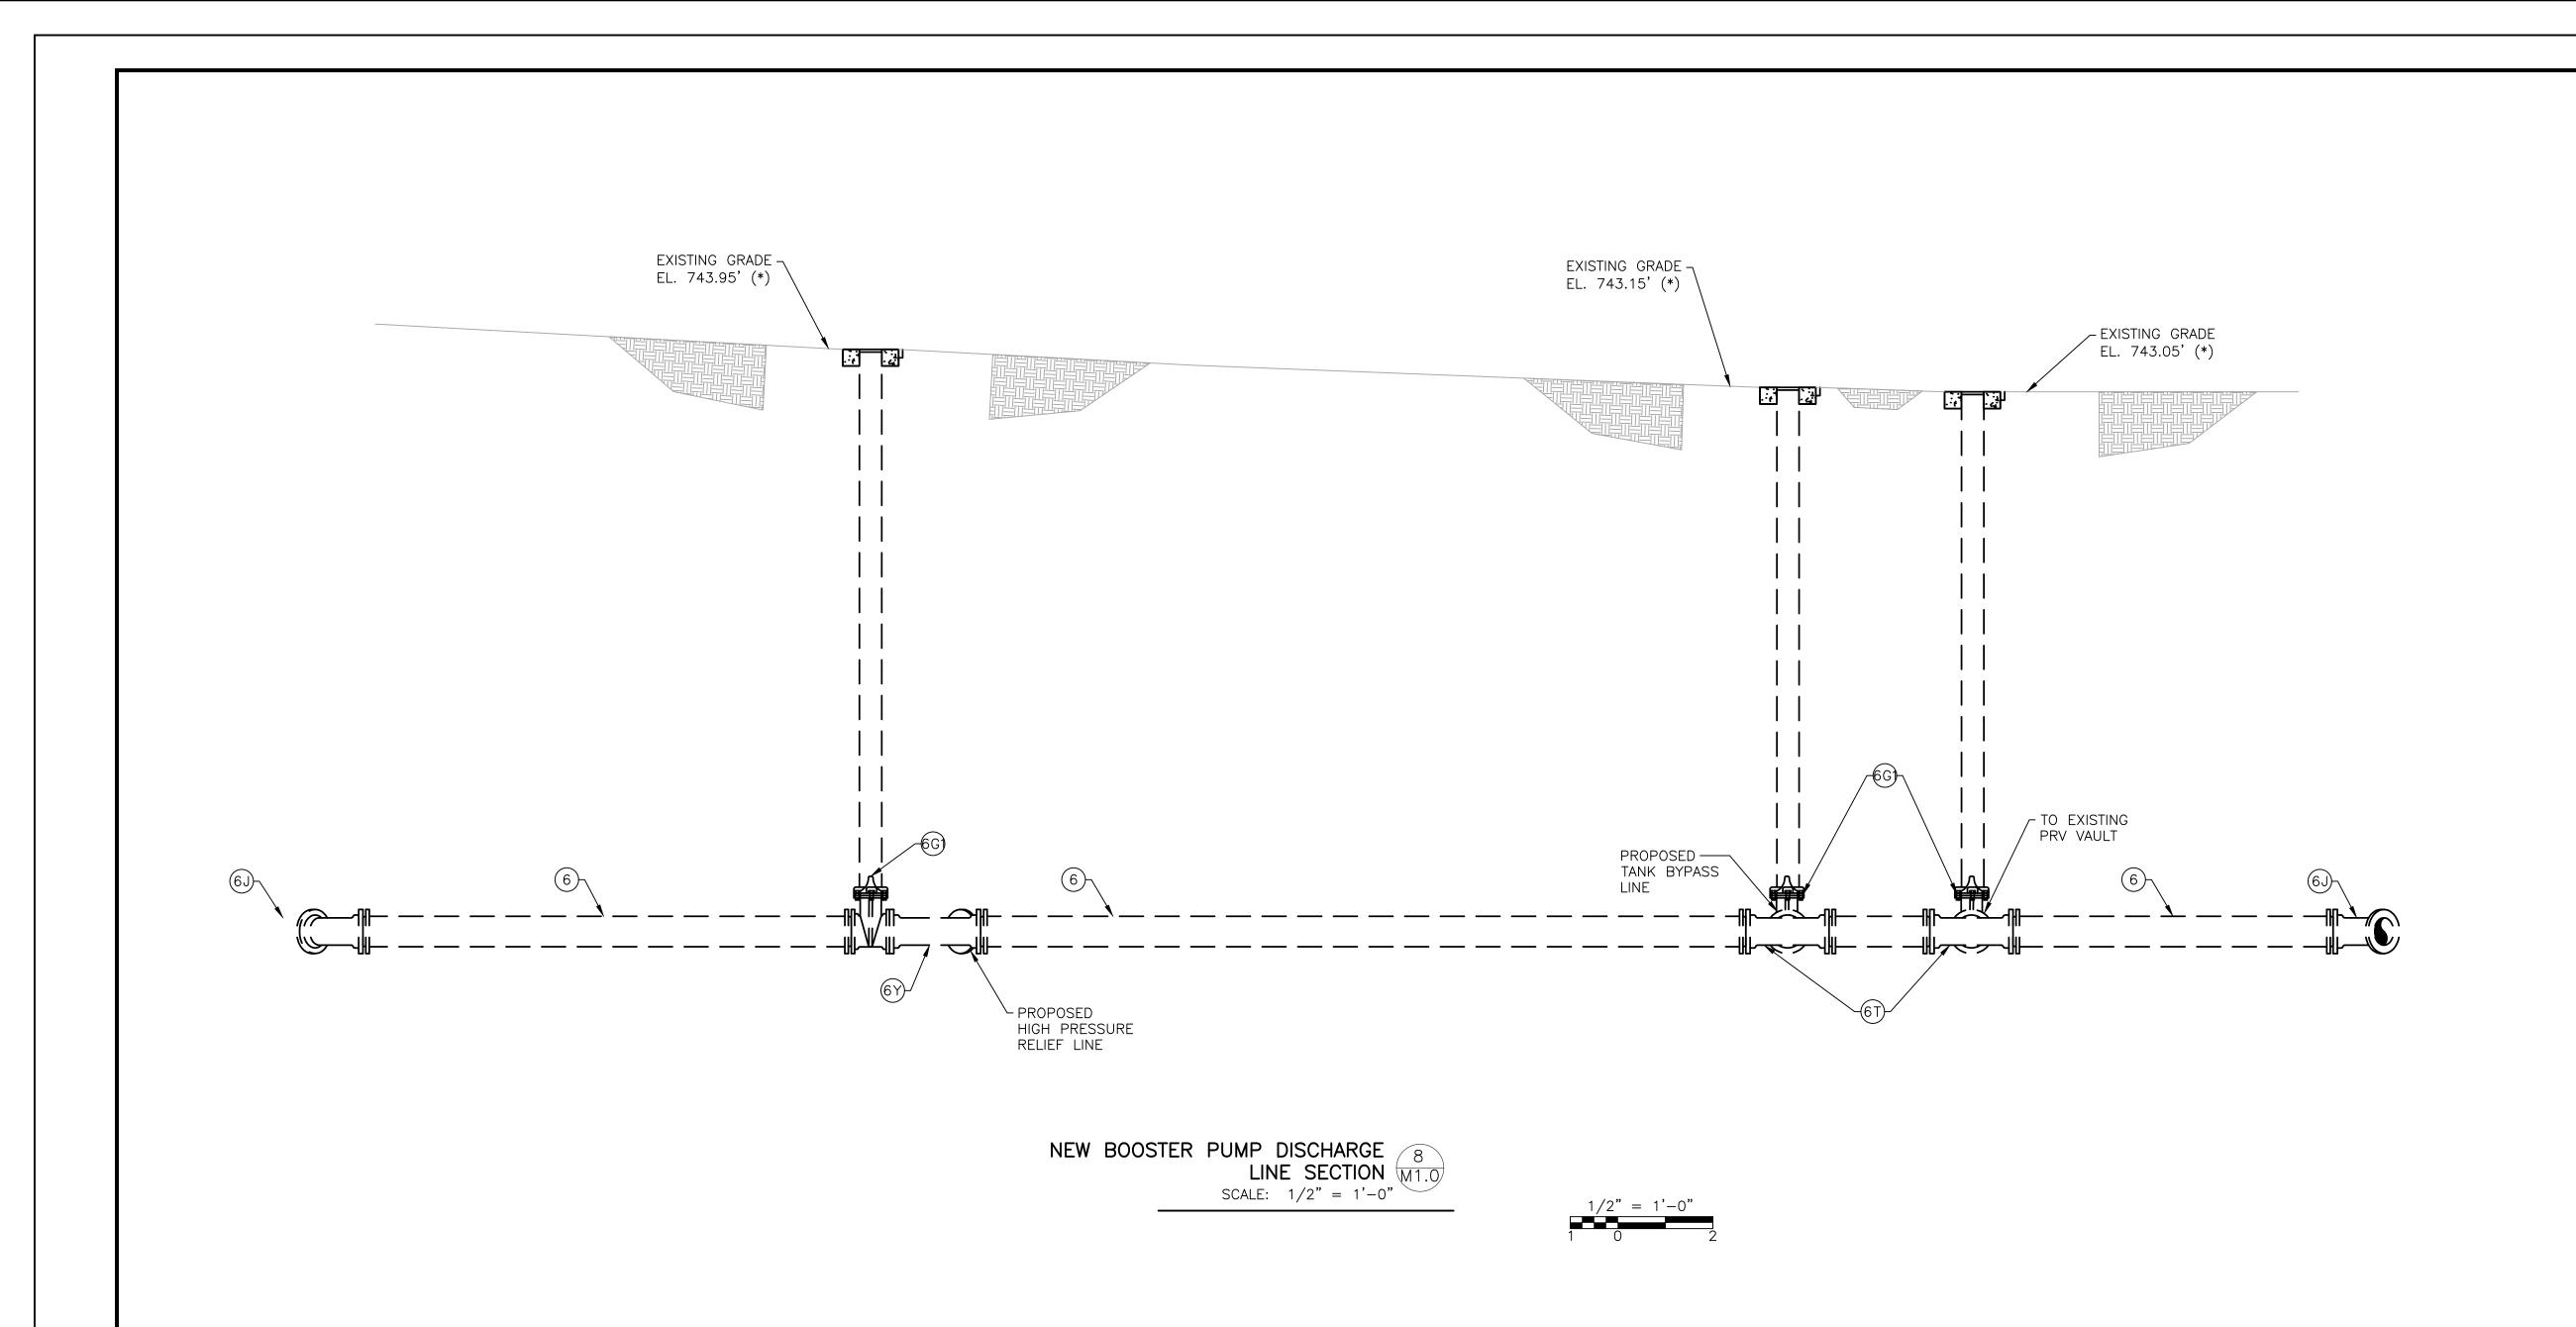

CONSTRUCTION NOTES:

- (6) PROVIDE 6" DUCTILE IRON WATERLINE
- PROVIDE 6" GATE VALVE (MJxMJ) W/FRAME AND COVER PER DETAIL X ON SHEET X
- (6J) PROVIDE 6" 45° BEND (MJxMJ)
- 6T) PROVIDE 6" x 6" x 6" TEE (MJxMJxMJ)
- 6Y) PROVIDE 6"x6"x6" WYE (MJxMJxMJ)


GENERAL NOTES:

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	REVISIONS	REVISIONS	
			VALENTINE
			Environmental Engineers, LL
CALIFORNIA			1500 Palma Drive, Suite 257 Ventura, California 93003
AMERICAN WATER			Phone: (480) 283 - 8991 Fax: (480) 283 - 0082 Website: http://www.valentineengineers.com



Environmental Engineers, LLC


VALENTINE ENVIRONMENTAL ENGINEERS, LLC 200 CLOCK TOWER PL BUILDING B, SUITE B200
CARMEL, CA 93823-8723
CALIFORNIA
AMERICAN WATER
DRAWN BY R.OMALIA

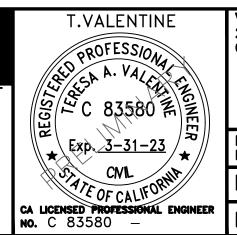RANCHO FIESTA STORAGE IMPROVEMENTS

MECHANICAL

LOWER TANK AND PP#62 VAULT SECTIONS IV

PROJECT	USE APPROVED DRAWINGS ONLY FOR CONSTRUCTION PURPOSES	90% DESIGN	M8.0
DATE OCTOBER 2023	CALIFORNIA AMERICAN WATER CO.	CENTRAL COAST DIVISION	USE DIMENSIONS ONLY SCALE AS NOTED
PROJECT ENG'R T.VALENTINE			

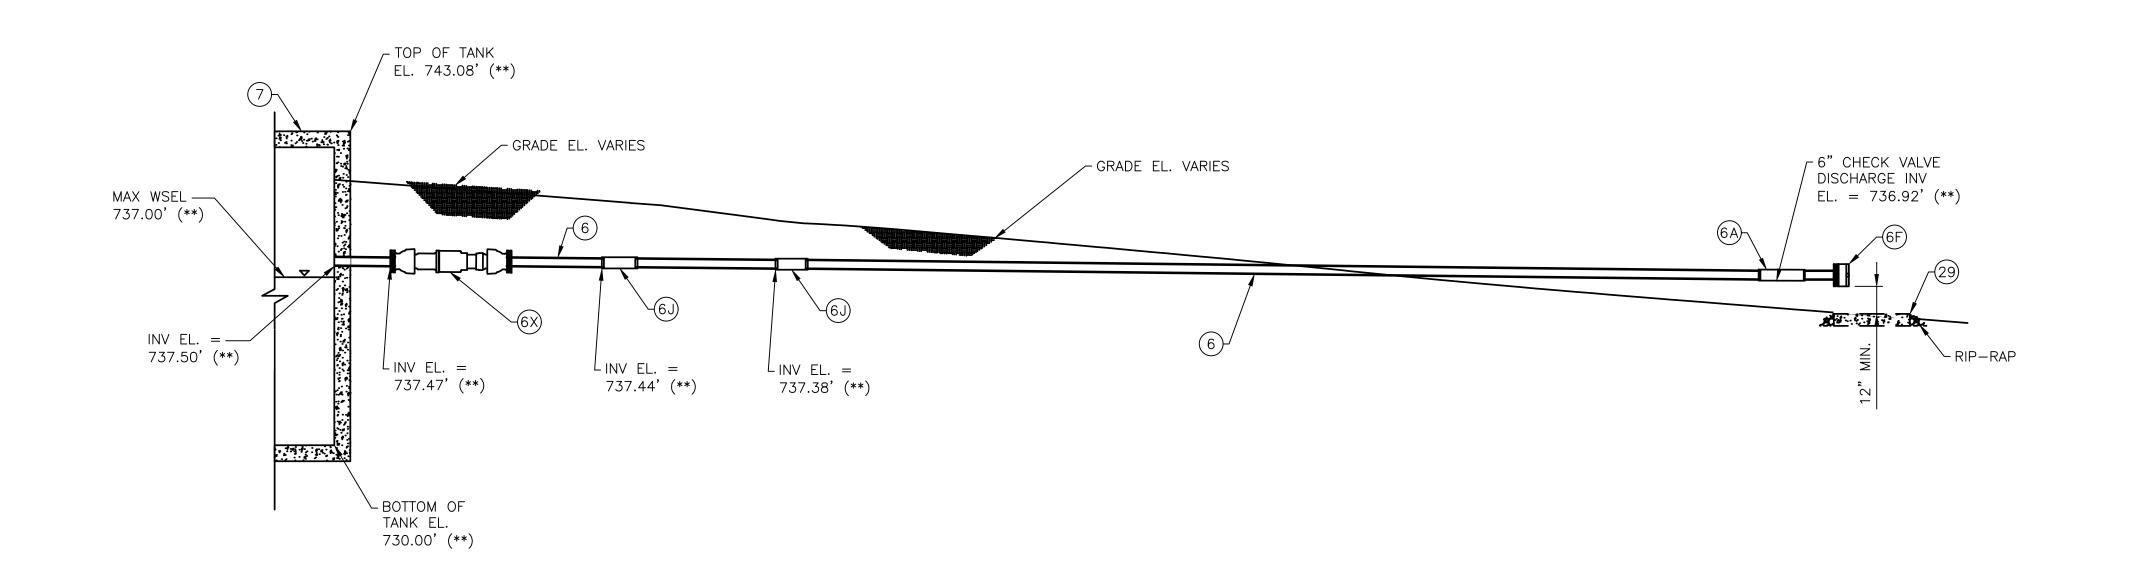

LOWER TANK OVERFLOW 9

SECTION M1.0

SCALE: 1/2" = 1'-0"

CONSTRUCTION NOTES:

(6) PROVIDE 6" DUCTILE IRON WATERLINE

6A) PROVIDE 6" CHECK VALVE

6D PROVIDE 6" 90° BEND (FLGxFLG)

6F) PROVIDE 6" FLAPPER CHECK VALVE

(6J) PROVIDE 6" 45° BEND (MJ×MJ)

(MJxMJ) PROVIDE 6" FORCE BALANCED FLEXIBLE EXPANSION JOINT

7 PROVIDE 10,000-GALLON ENGINEERED CONCRETE TANK

29 PROVIDE 18"x30" SPLASH PAD




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CALIFORNIA
AMERICAN WATER


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		Environmental Engineers, LLC
		1500 Palma Drive, Suite 257 Ventura, California 93003
		Phone: (480) 283 - 8991 Fax: (480) 283 - 0082 Website: http://www.valentineengineers.com
		CA





VALENTINE ENV 200 CLOCK TOV CARMEL, CA 93	IRONMENTAL ENGINEERS, LLC WER PL BUILDING B, SUITE B200 8823-8723
	CALIFORNIA AMERICAN WATER
DRAWN BY R	.OMALIA


RANCHO FIESTA STORAGE IMPROVEMENTS MECHANICAL LOWER TANK OVERFLOW SECTION

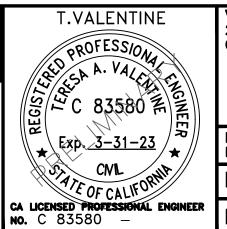
DRAWN BY R.OMALIA PROJECT ENG'R T.VALENTINE			
DATE OCTOBER 2023	CALIFORNIA AMERICAN WATER CO.	CENTRAL COAST DIVISION	USE DIMENSIONS ONLY SCALE AS NOTED
PROJECT	USE APPROVED DRAWINGS ONLY FOR CONSTRUCTION PURPOSES	90% DESIGN	M9.0

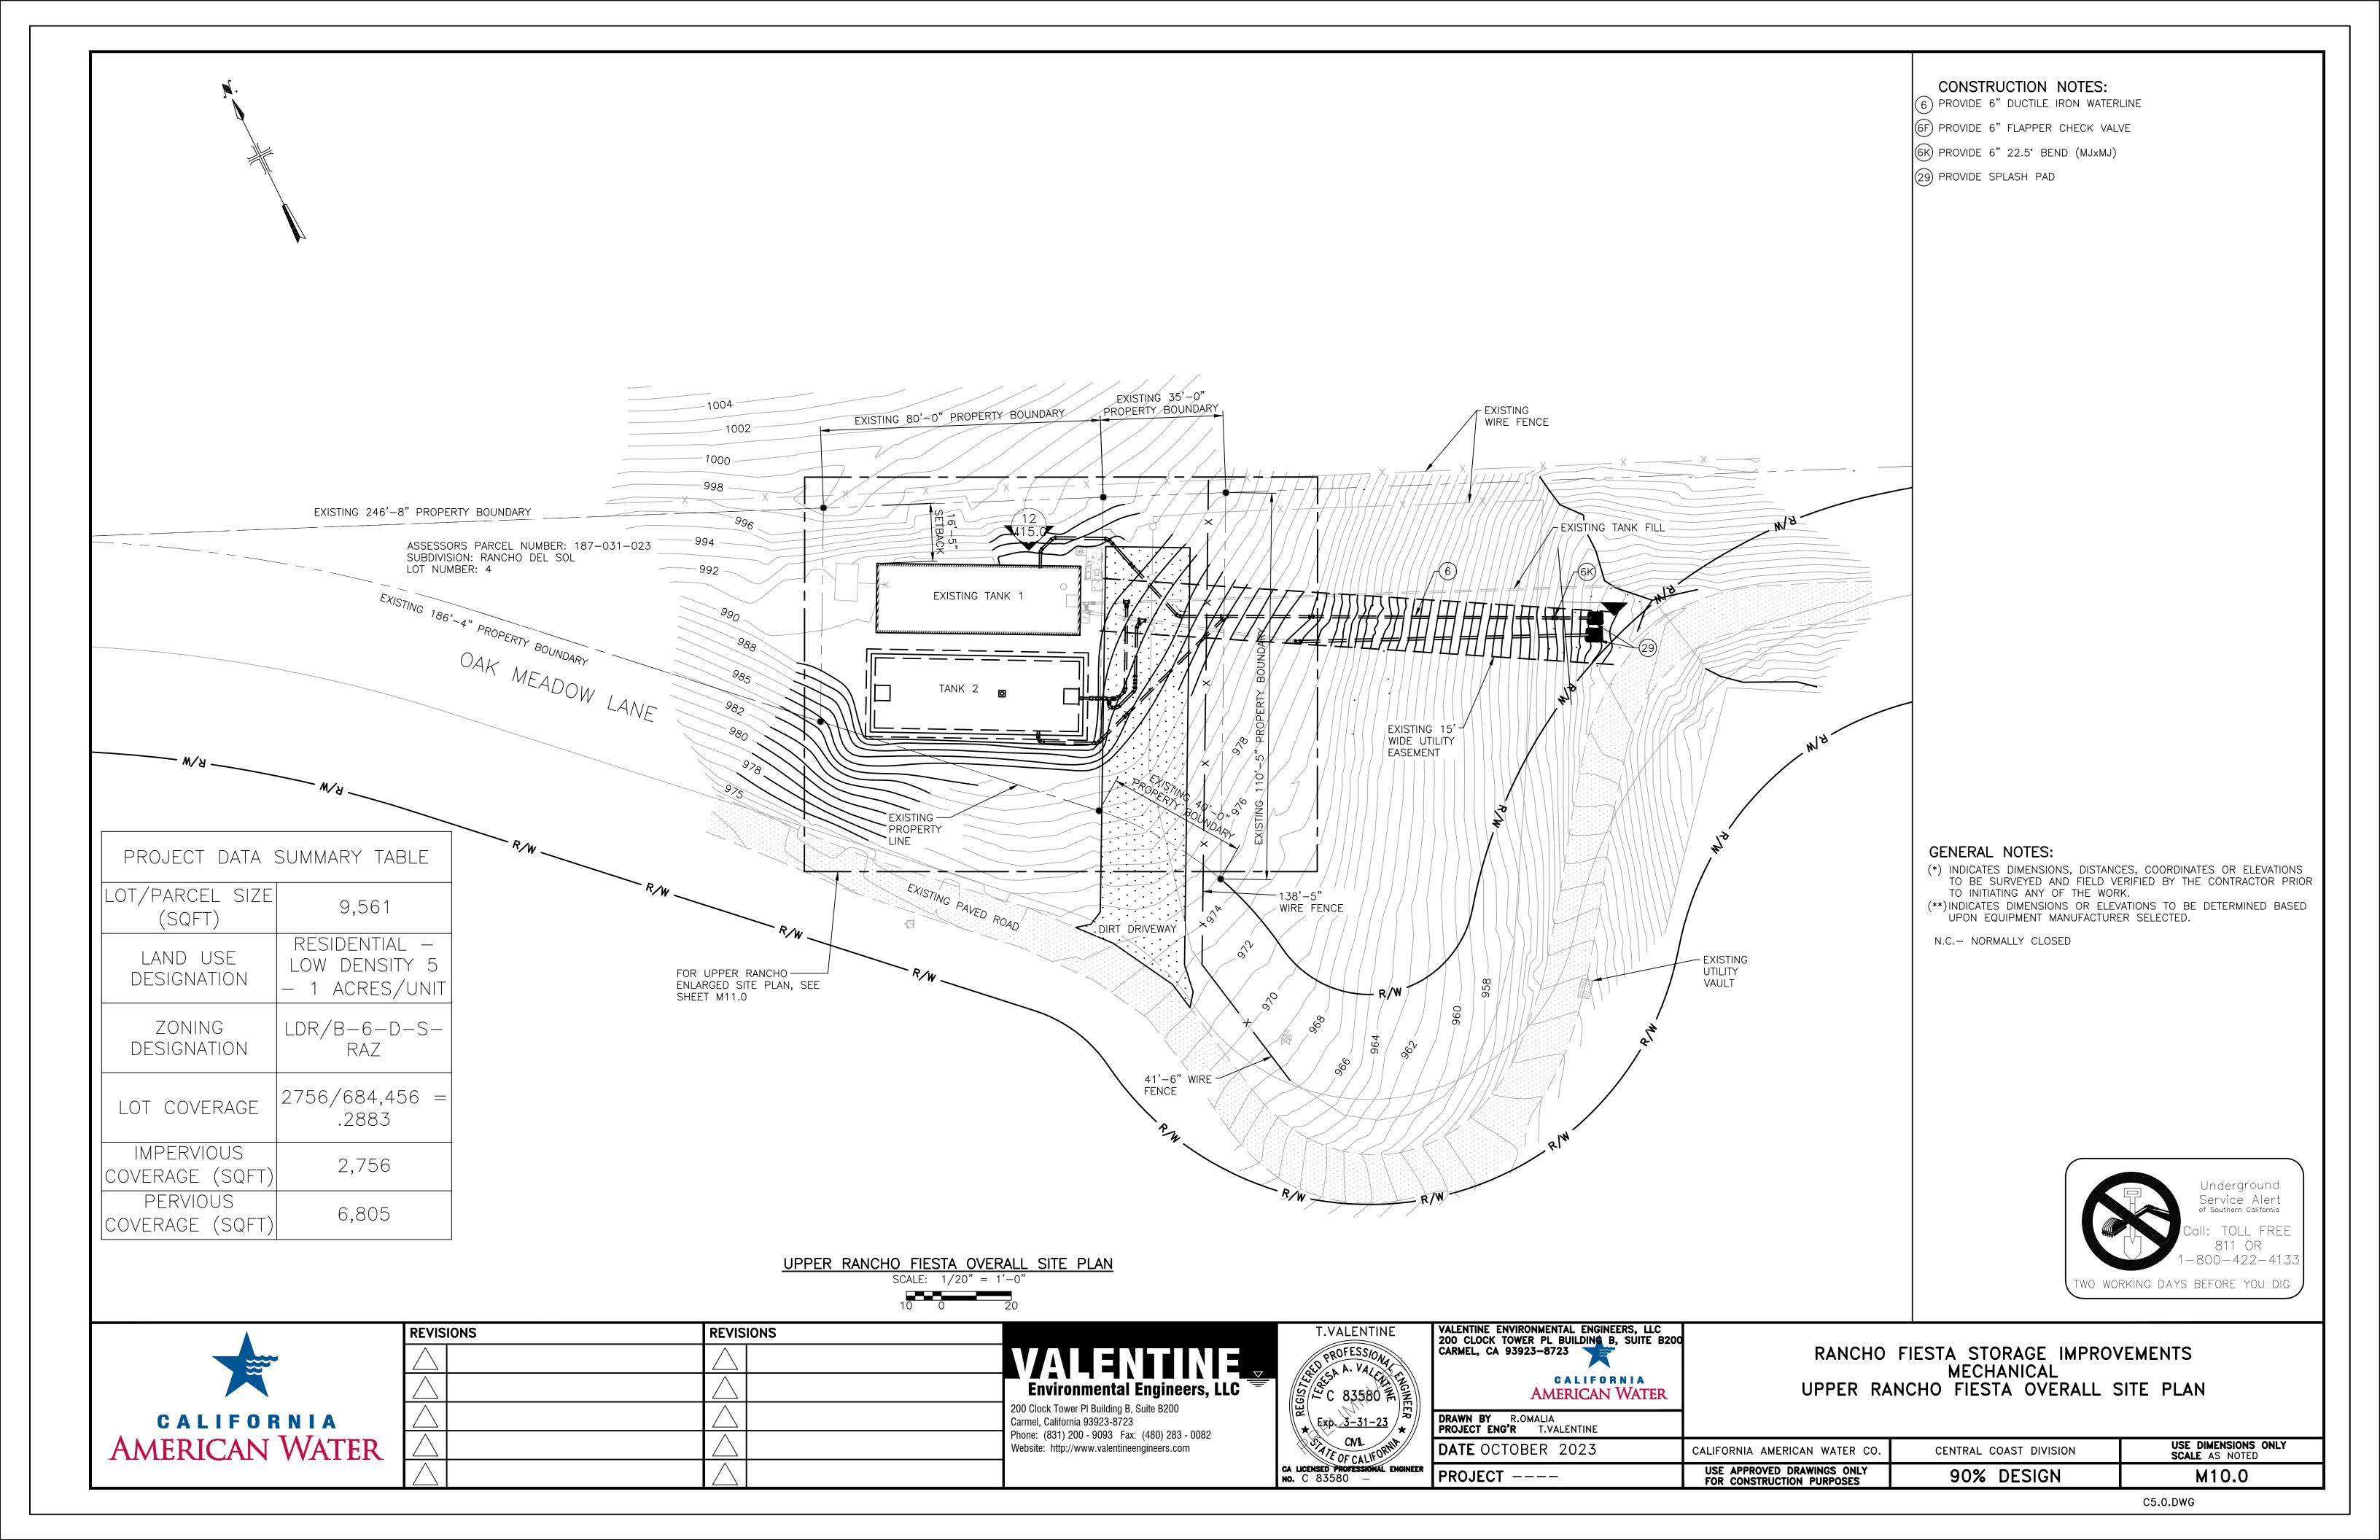


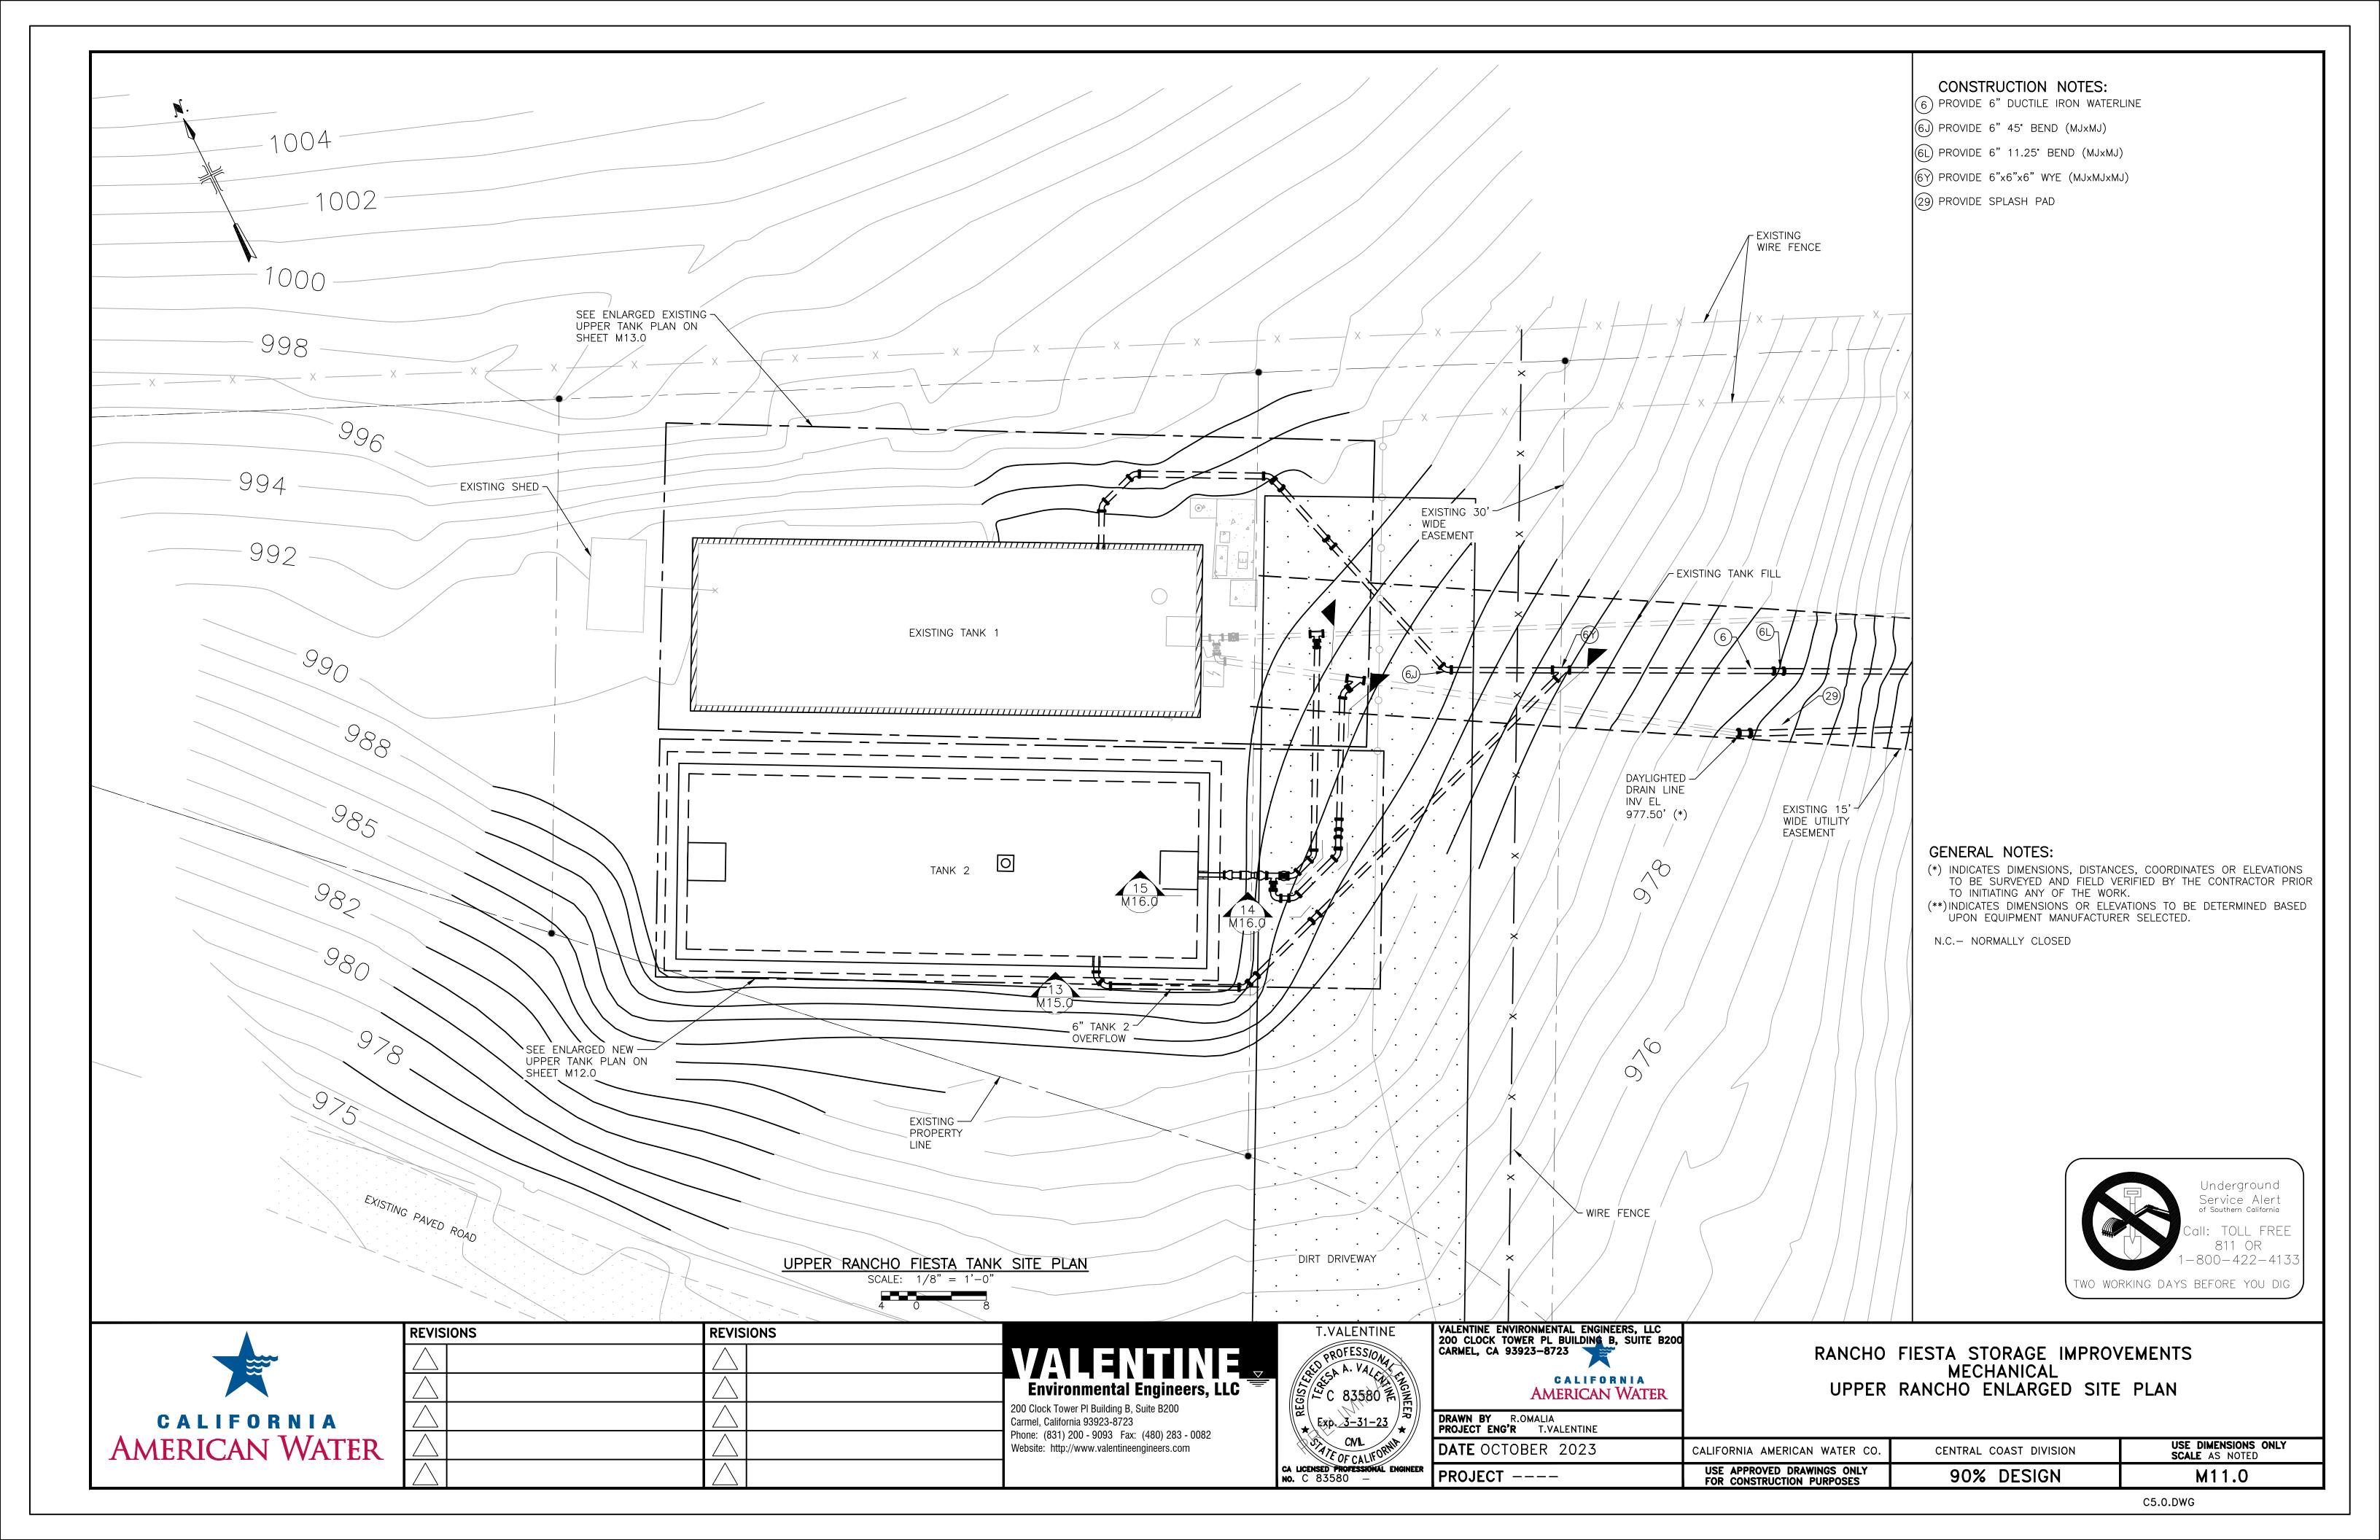

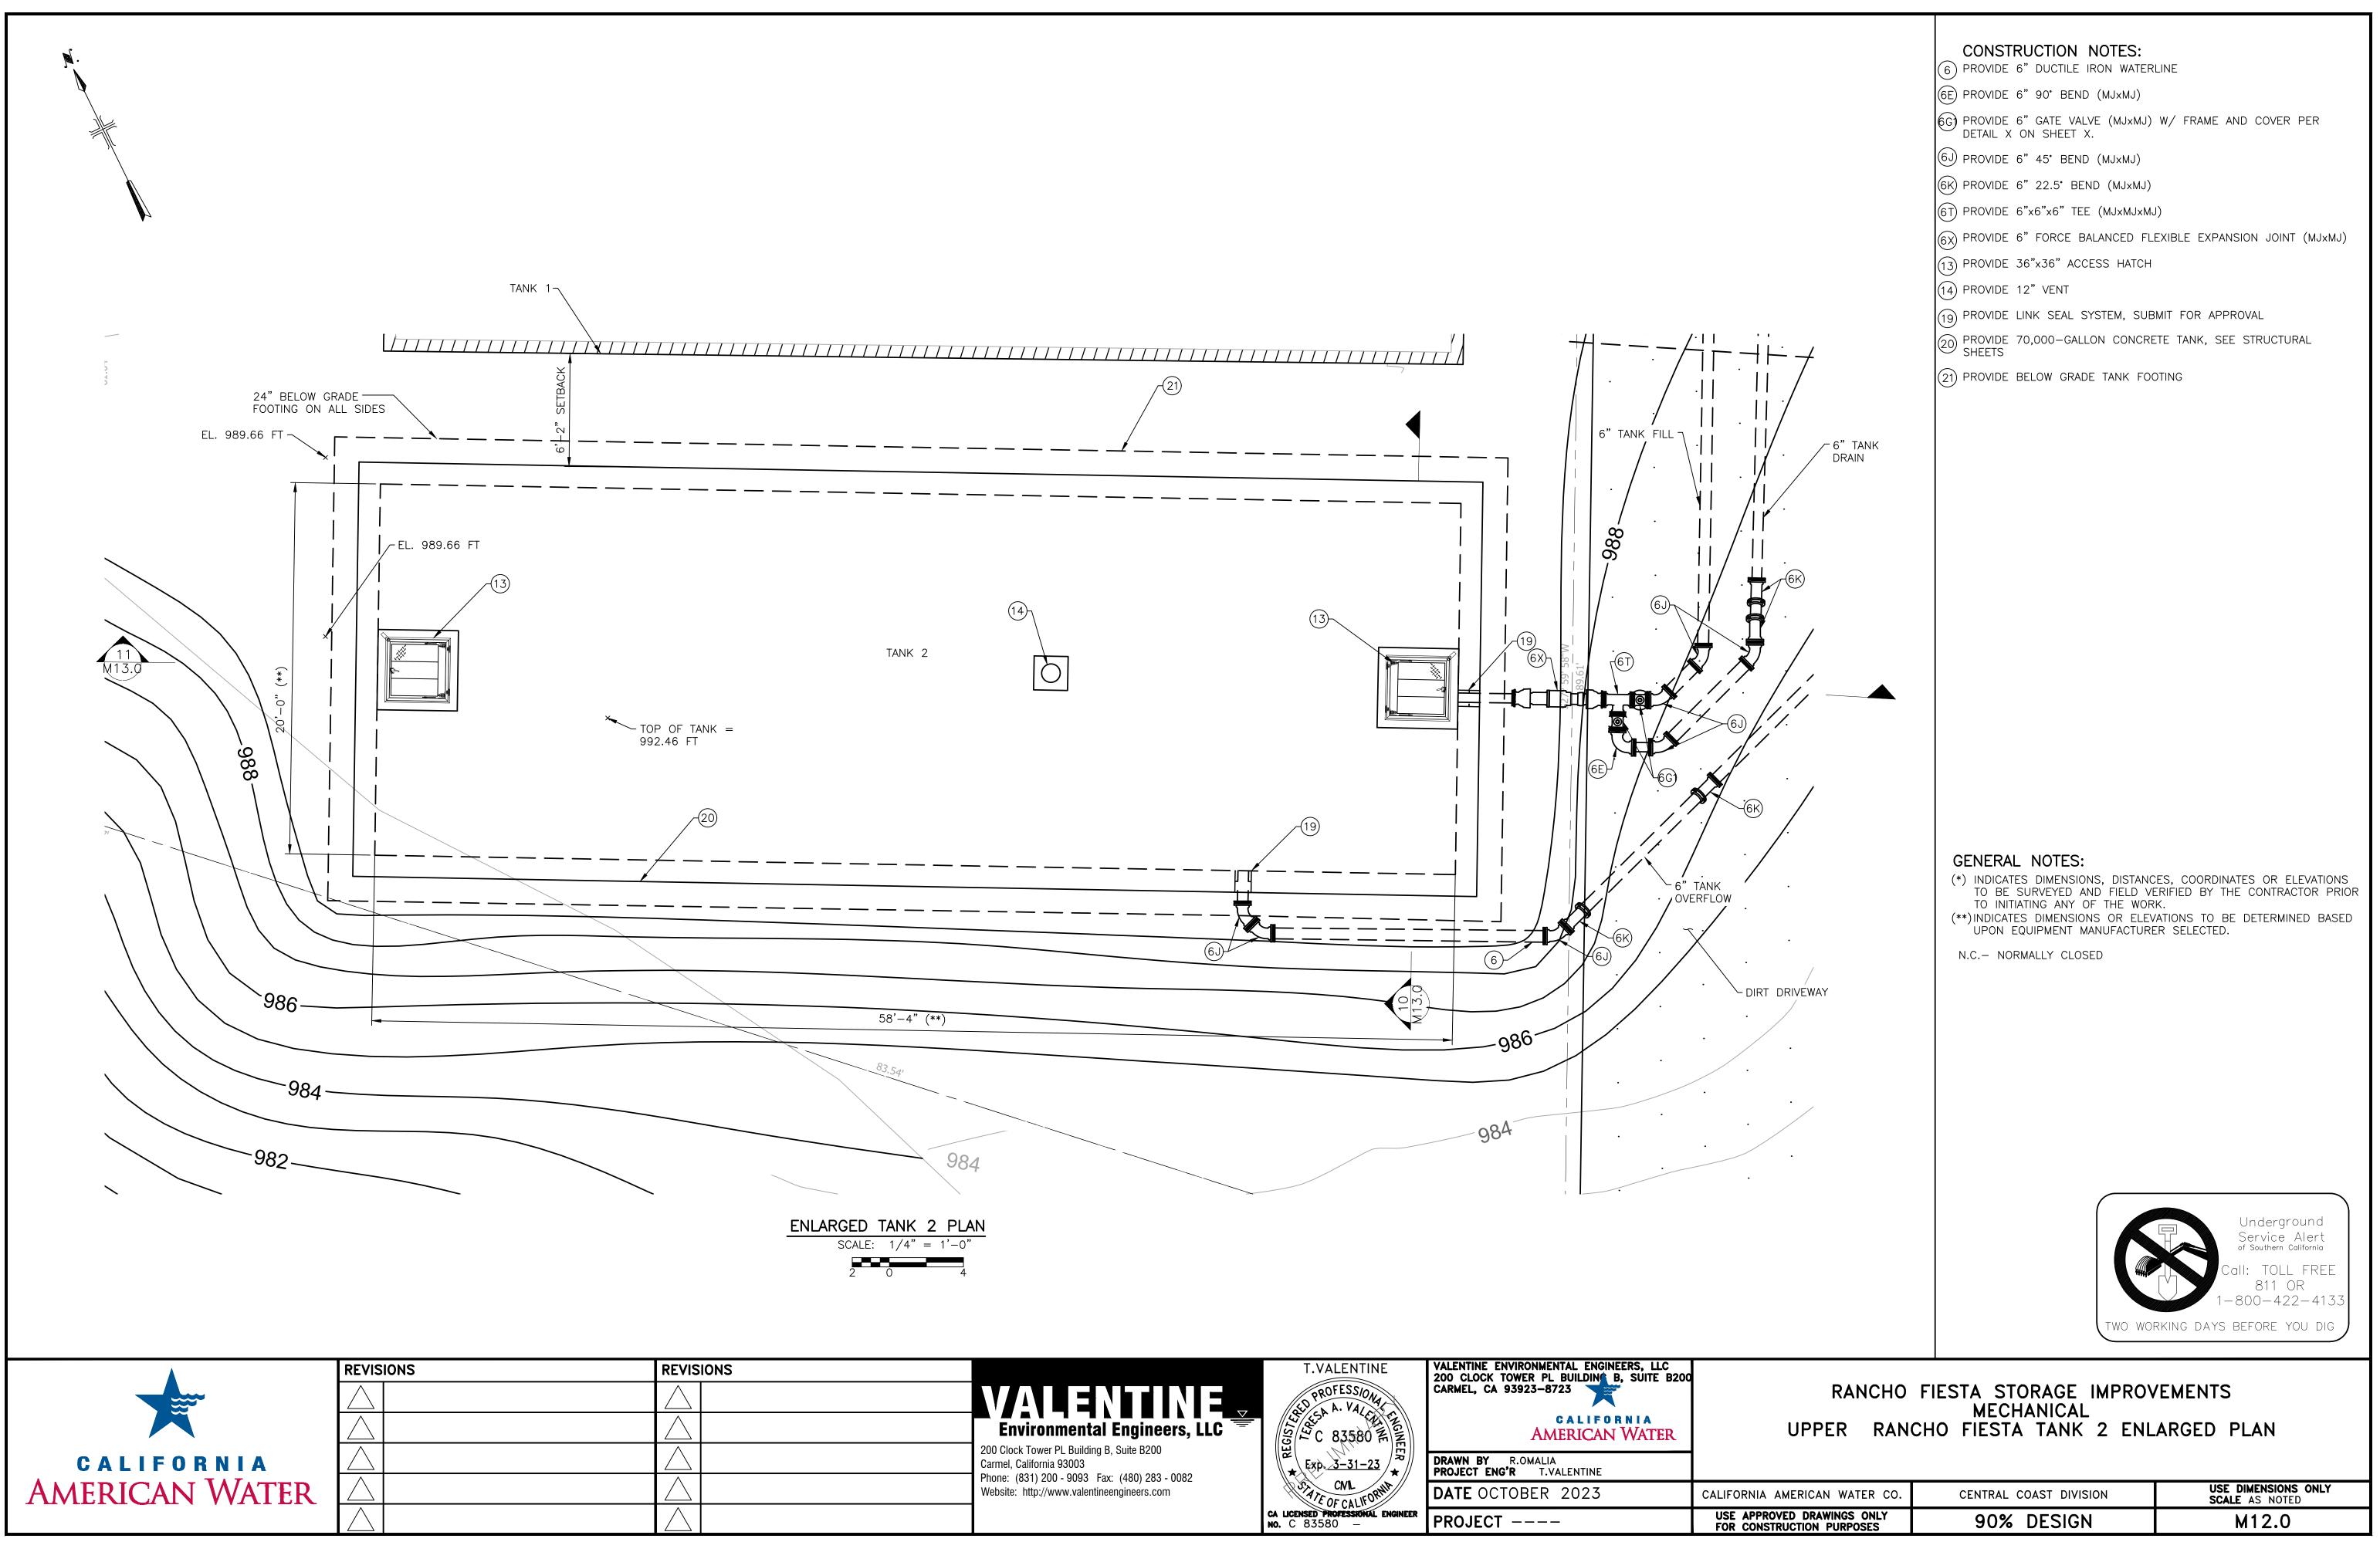

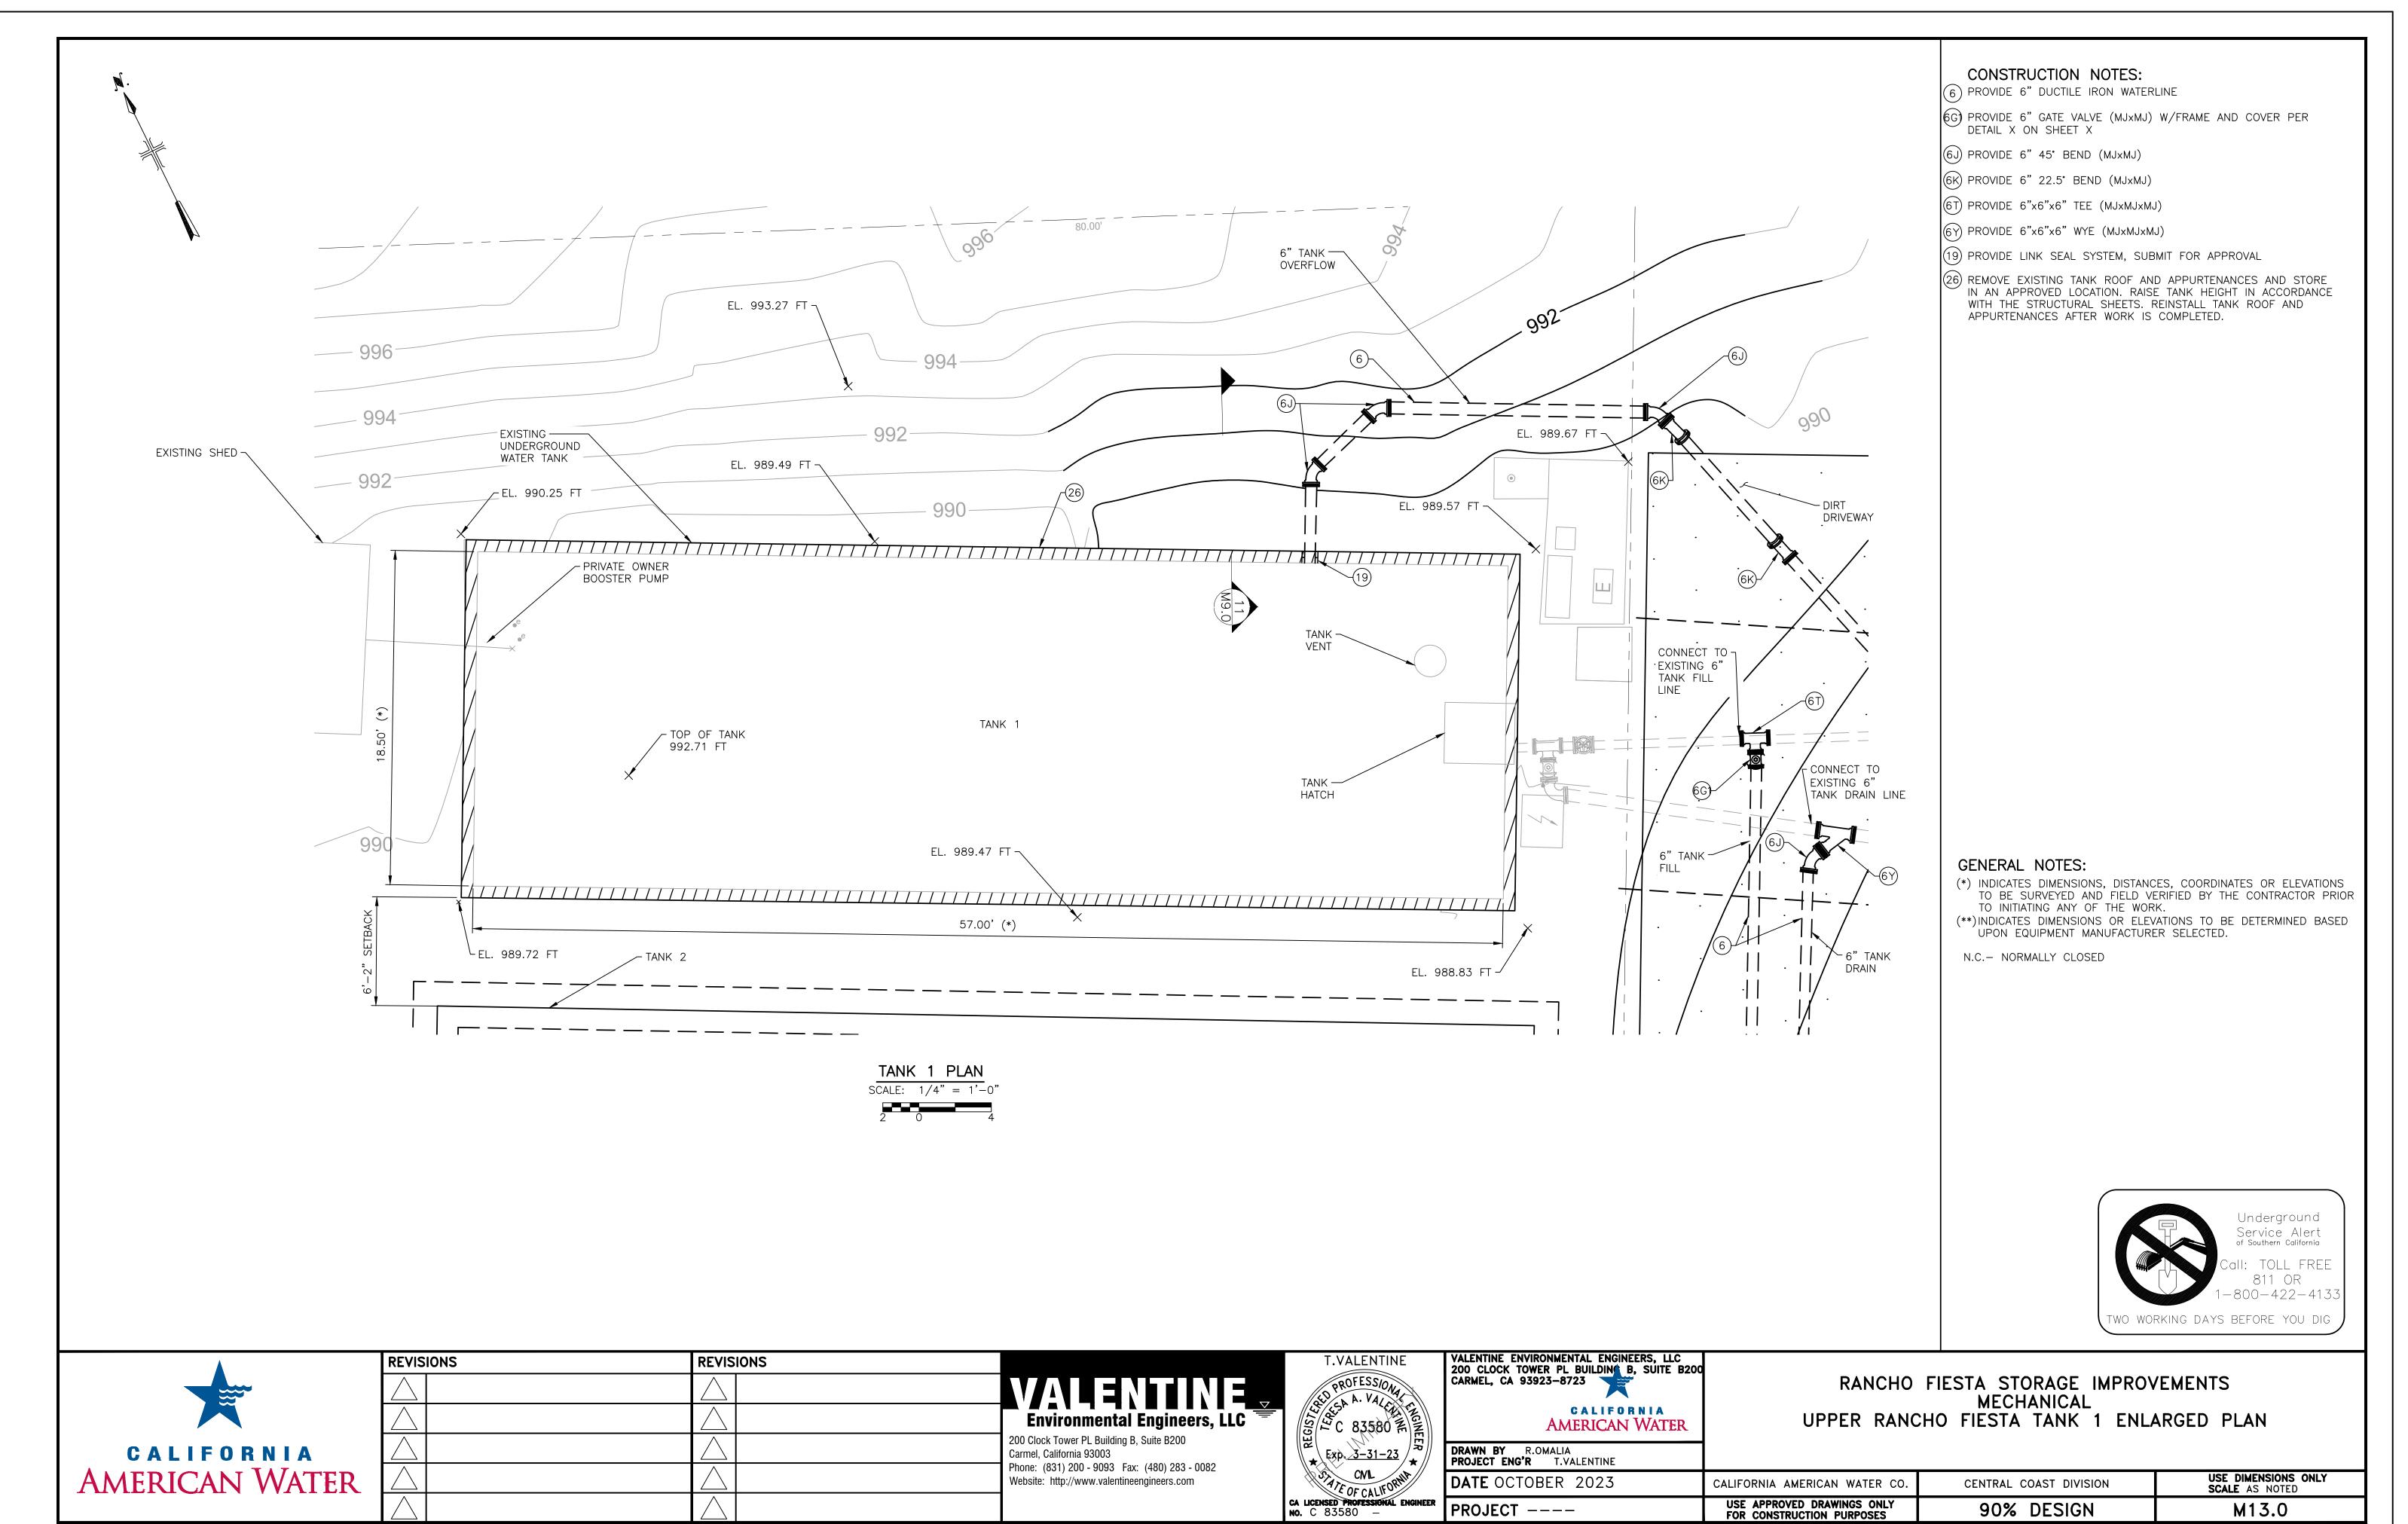

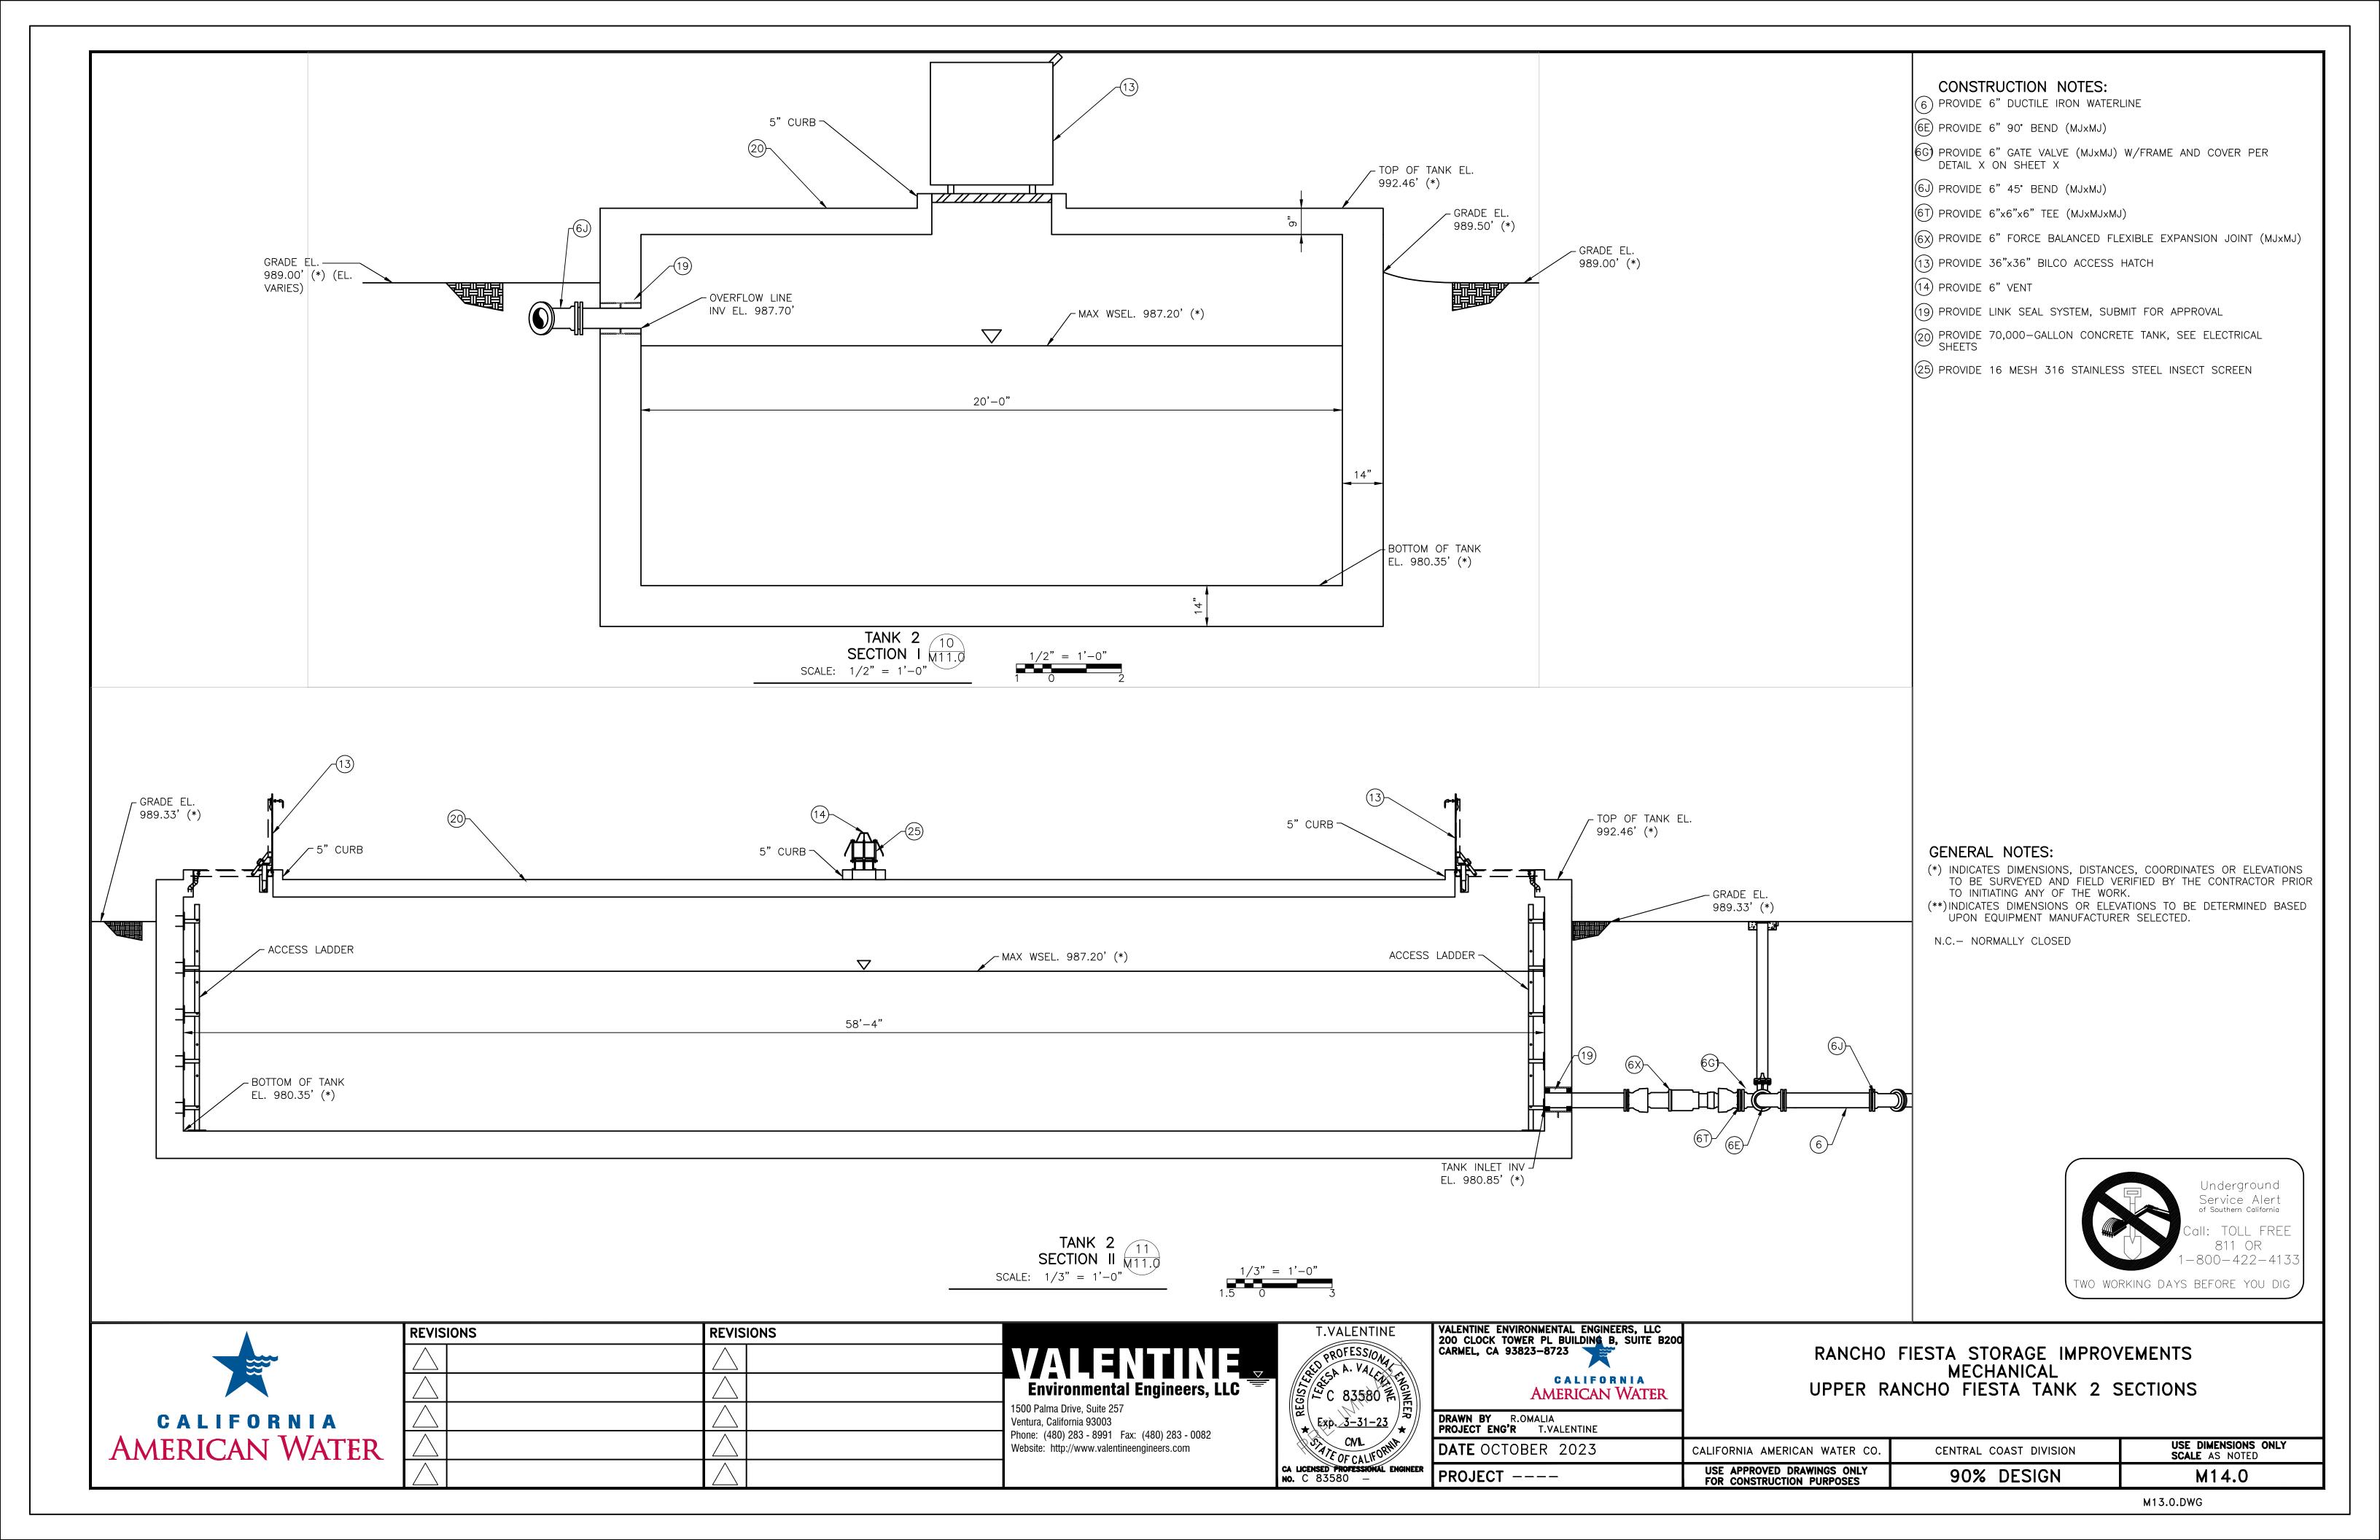

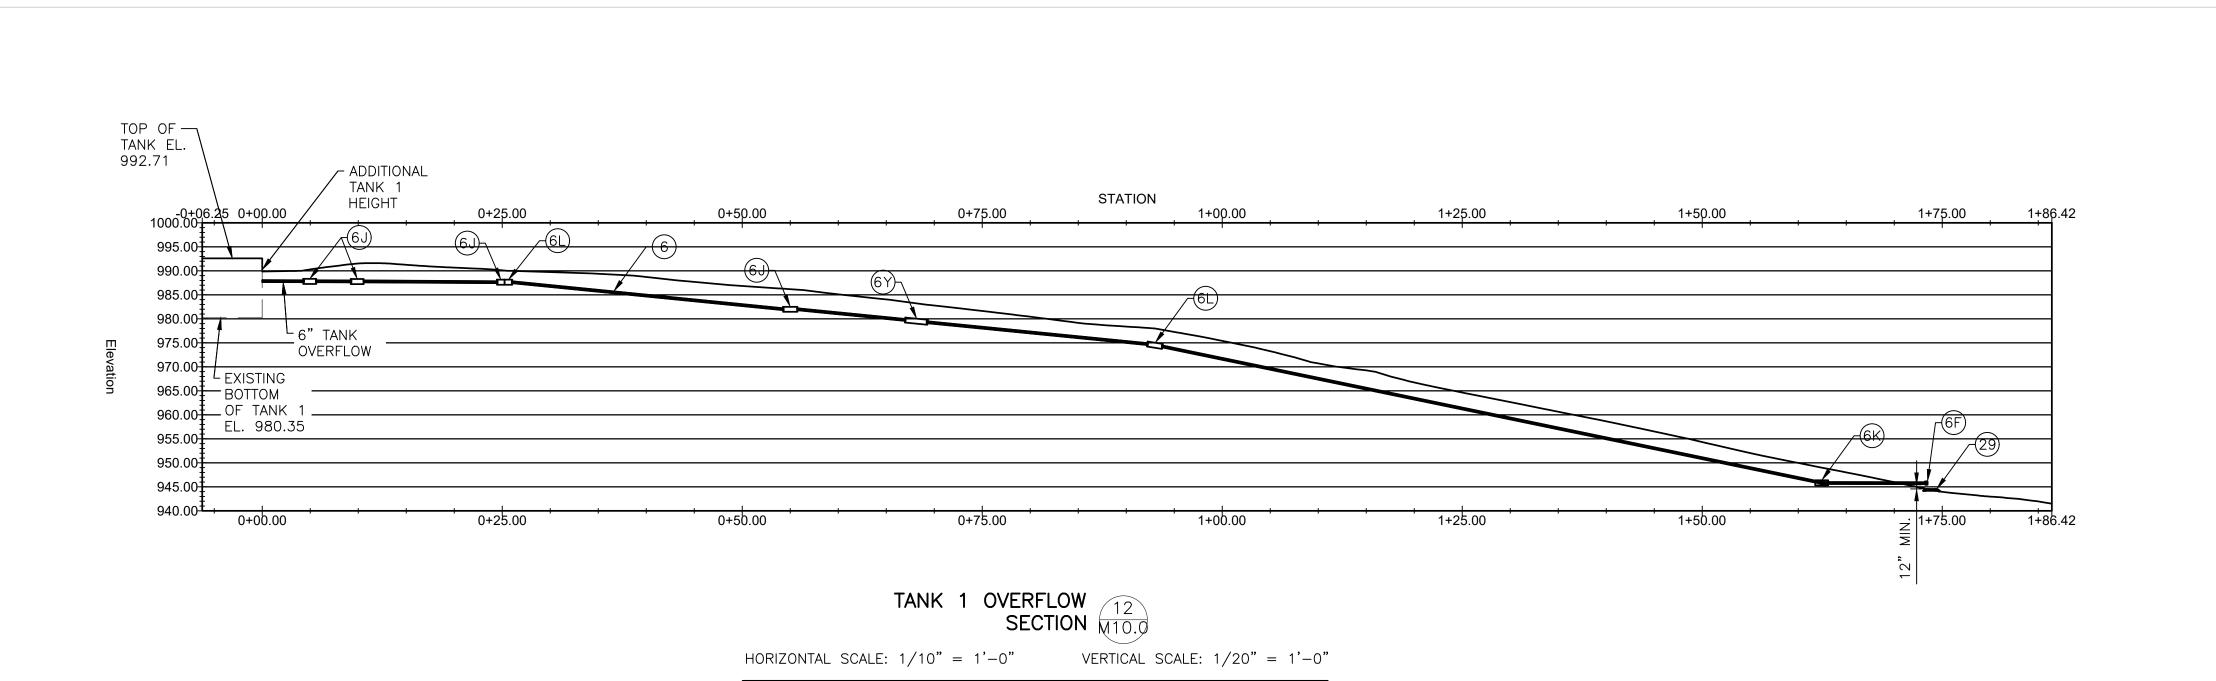

GENERAL NOTES:

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N.C.- NORMALLY CLOSED

CONSTRUCTION NOTES: (6) PROVIDE 6" DUCTILE IRON WATERLINE

(6E) PROVIDE 6" 90° BEND (MJ×MJ)


(6J) PROVIDE 6" 45° BEND (MJxMJ)

(6K) PROVIDE 6" 22.5° BEND (MJ×MJ)

(6L) PROVIDE 6" 11.25° BEND (MJxMJ)

(6Y) PROVIDE 6"x6"x6" WYE (MJxMJxMJ)

(29) PROVIDE SPLASH PAD

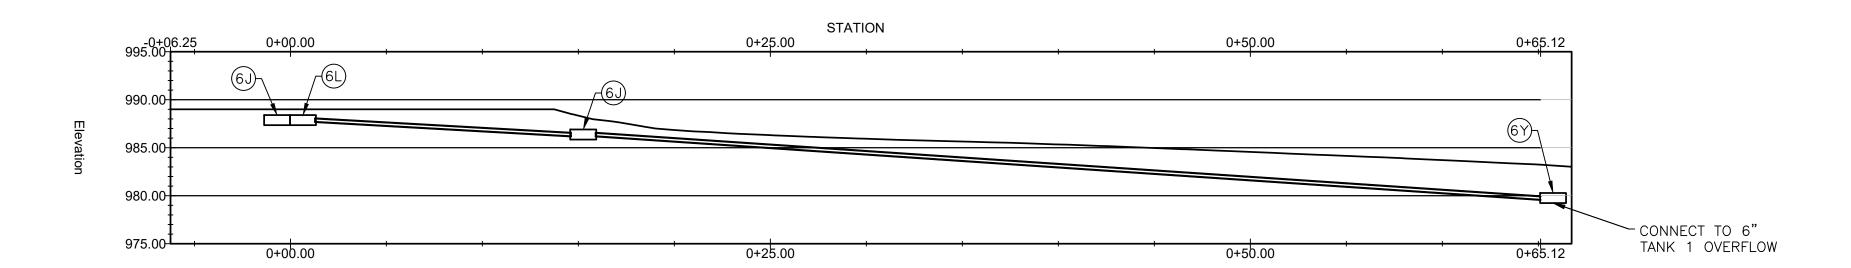


TANK 2 OVERFLOW 13 SECTION M10.0

HORIZONTAL SCALE: 1/5" = 1'-0" VERTICAL SCALE: 1/10" = 1'-0"






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		Environmental Engineers, LLC
		1500 Palma Drive, Suite 257 Ventura, California 93003
		Phone: (480) 283 - 8991 Fax: (480) 283 - 0082 Website: http://www.valentineengineers.com

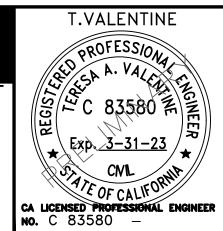


VALENTINE ENVIRONMENTAL ENGINEERS, LLC 200 CLOCK TOWER PL BUILDING B, SUITE B200 CARMEL, CA 93823-8723
CALIFORNIA AMERICAN WATER
DRAWN BY R.OMALIA PROJECT ENG'R T.VALENTINE

RANCHO FIESTA STORAGE IMPROVEMENTS MECHANICAL UPPER TANKS PIPING SECTIONS I

ER	PROJECT	USE APPROVED DRAWINGS ONLY FOR CONSTRUCTION PURPOSES	90% DESIGN	M15.0
	DATE OCTOBER 2023	CALIFORNIA AMERICAN WATER CO.	CENTRAL COAST DIVISION	USE DIMENSIONS ONLY SCALE AS NOTED
	DRAWN BY R.OMALIA PROJECT ENG'R T.VALENTINE			

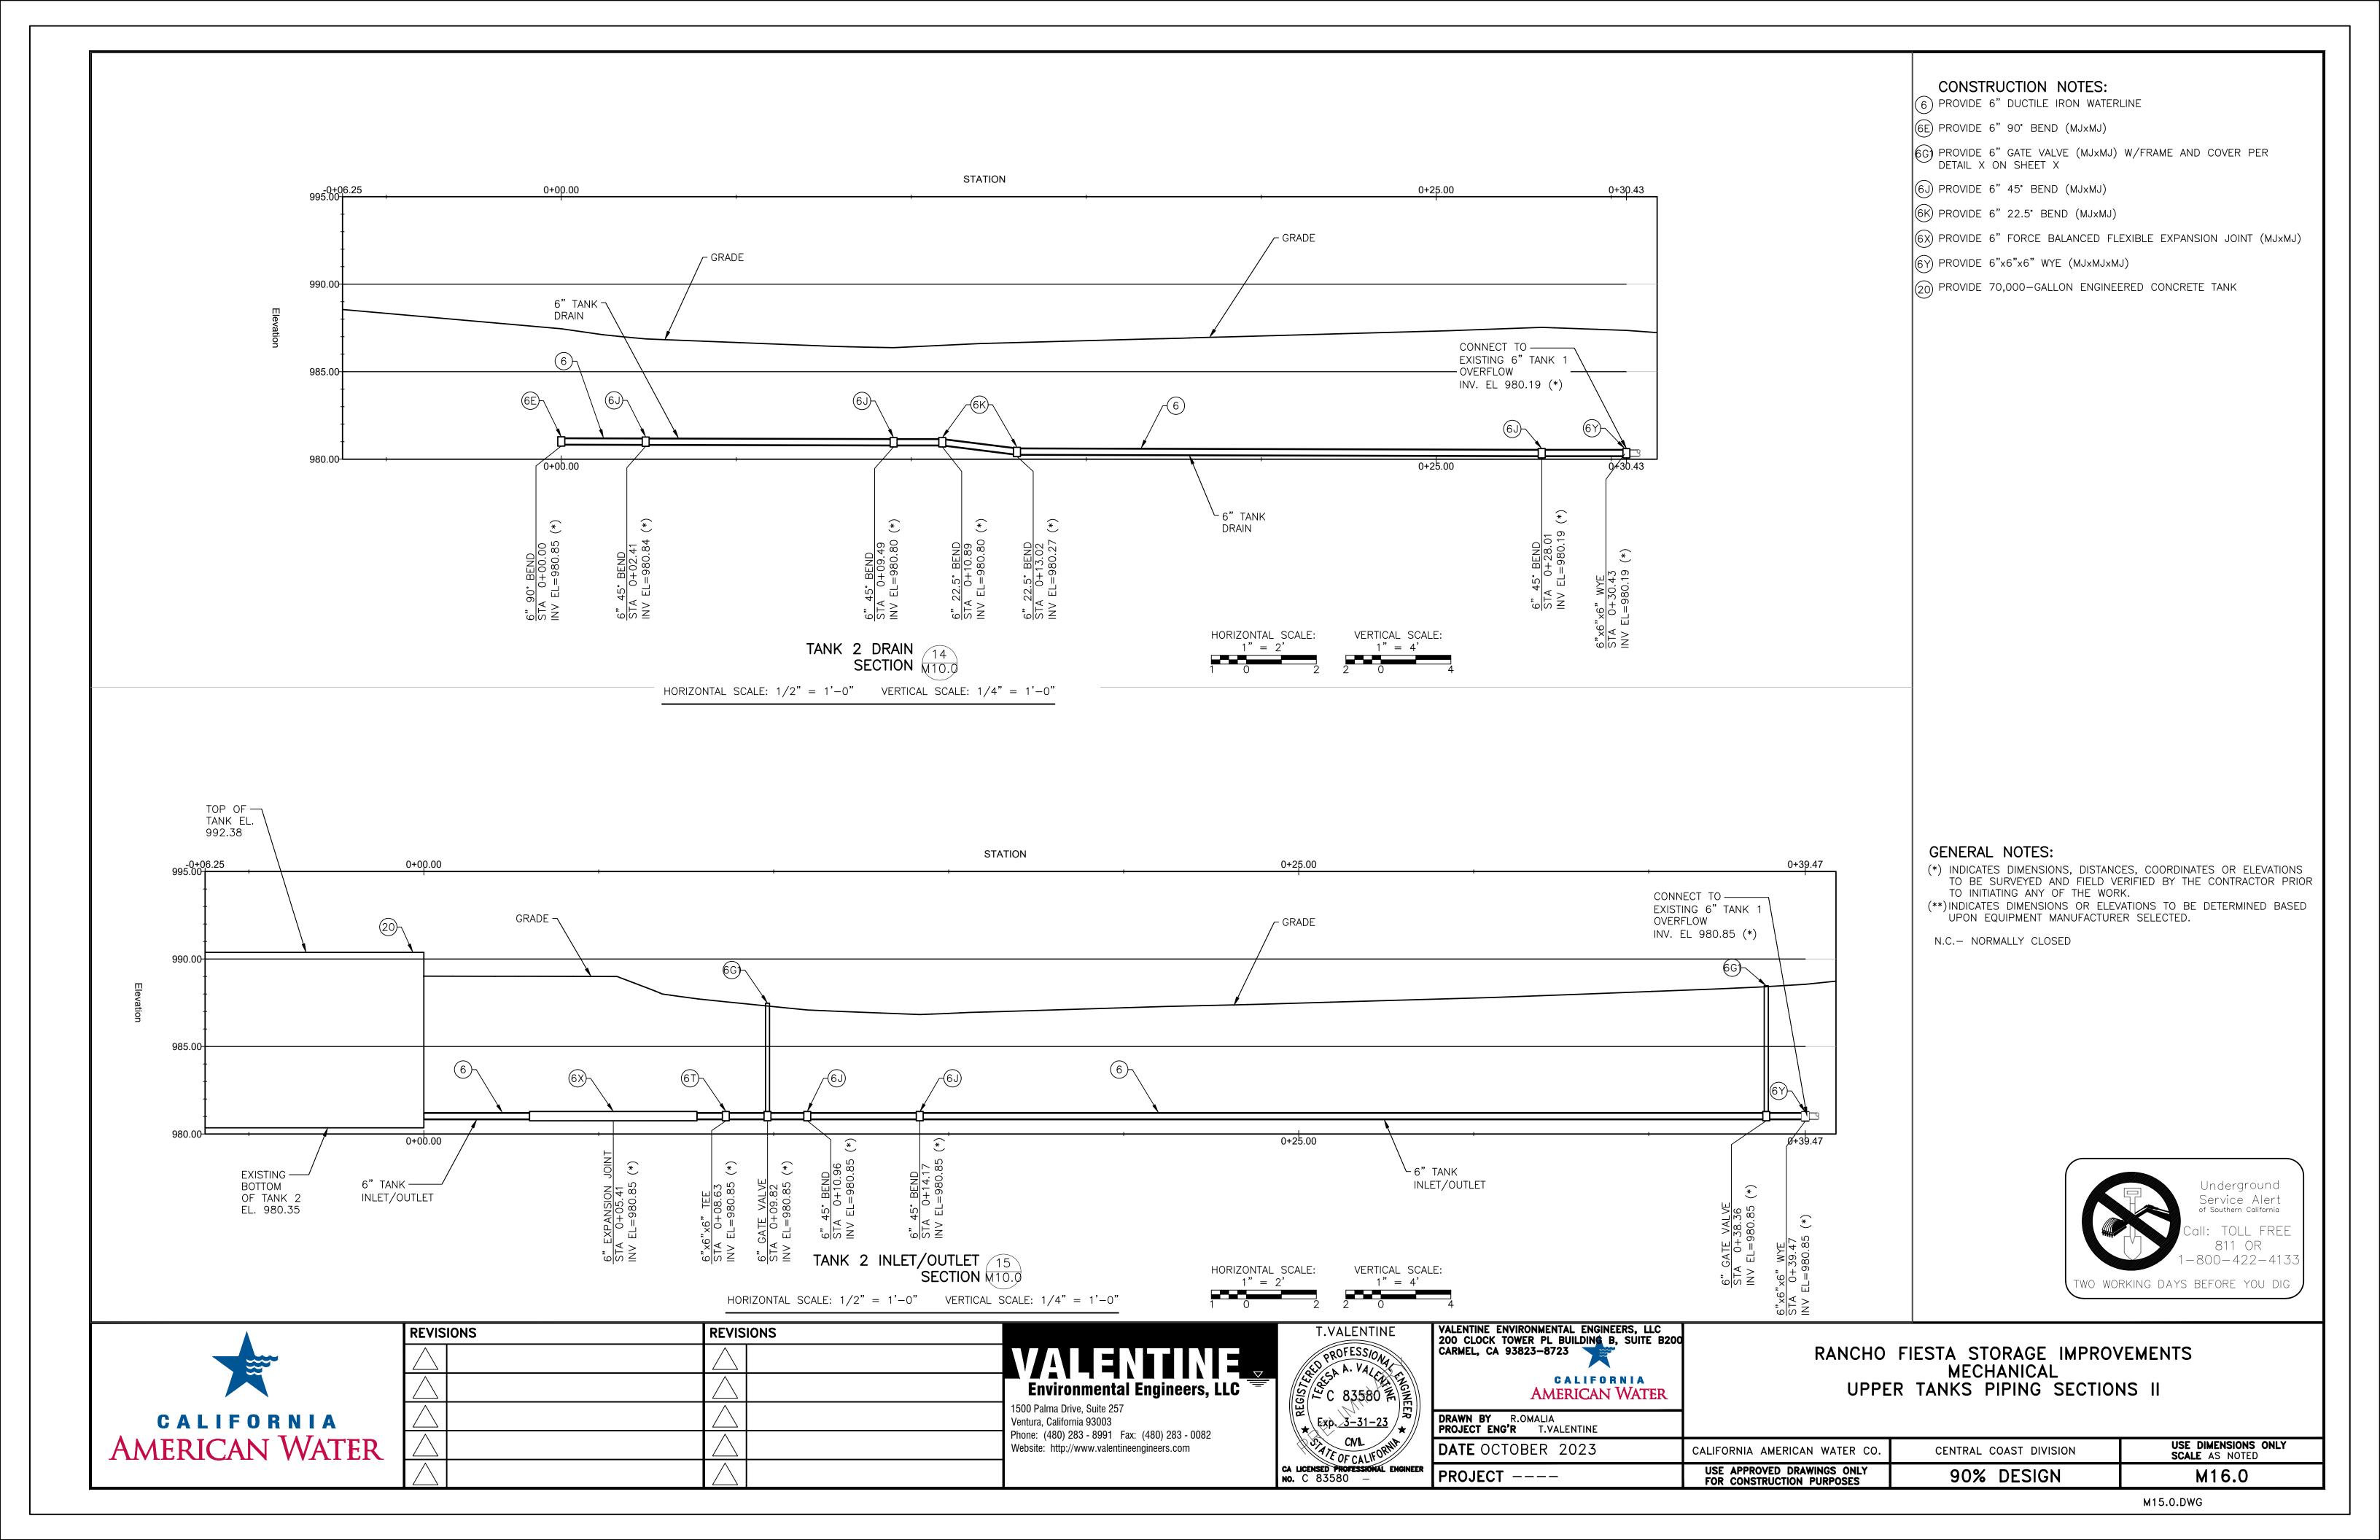

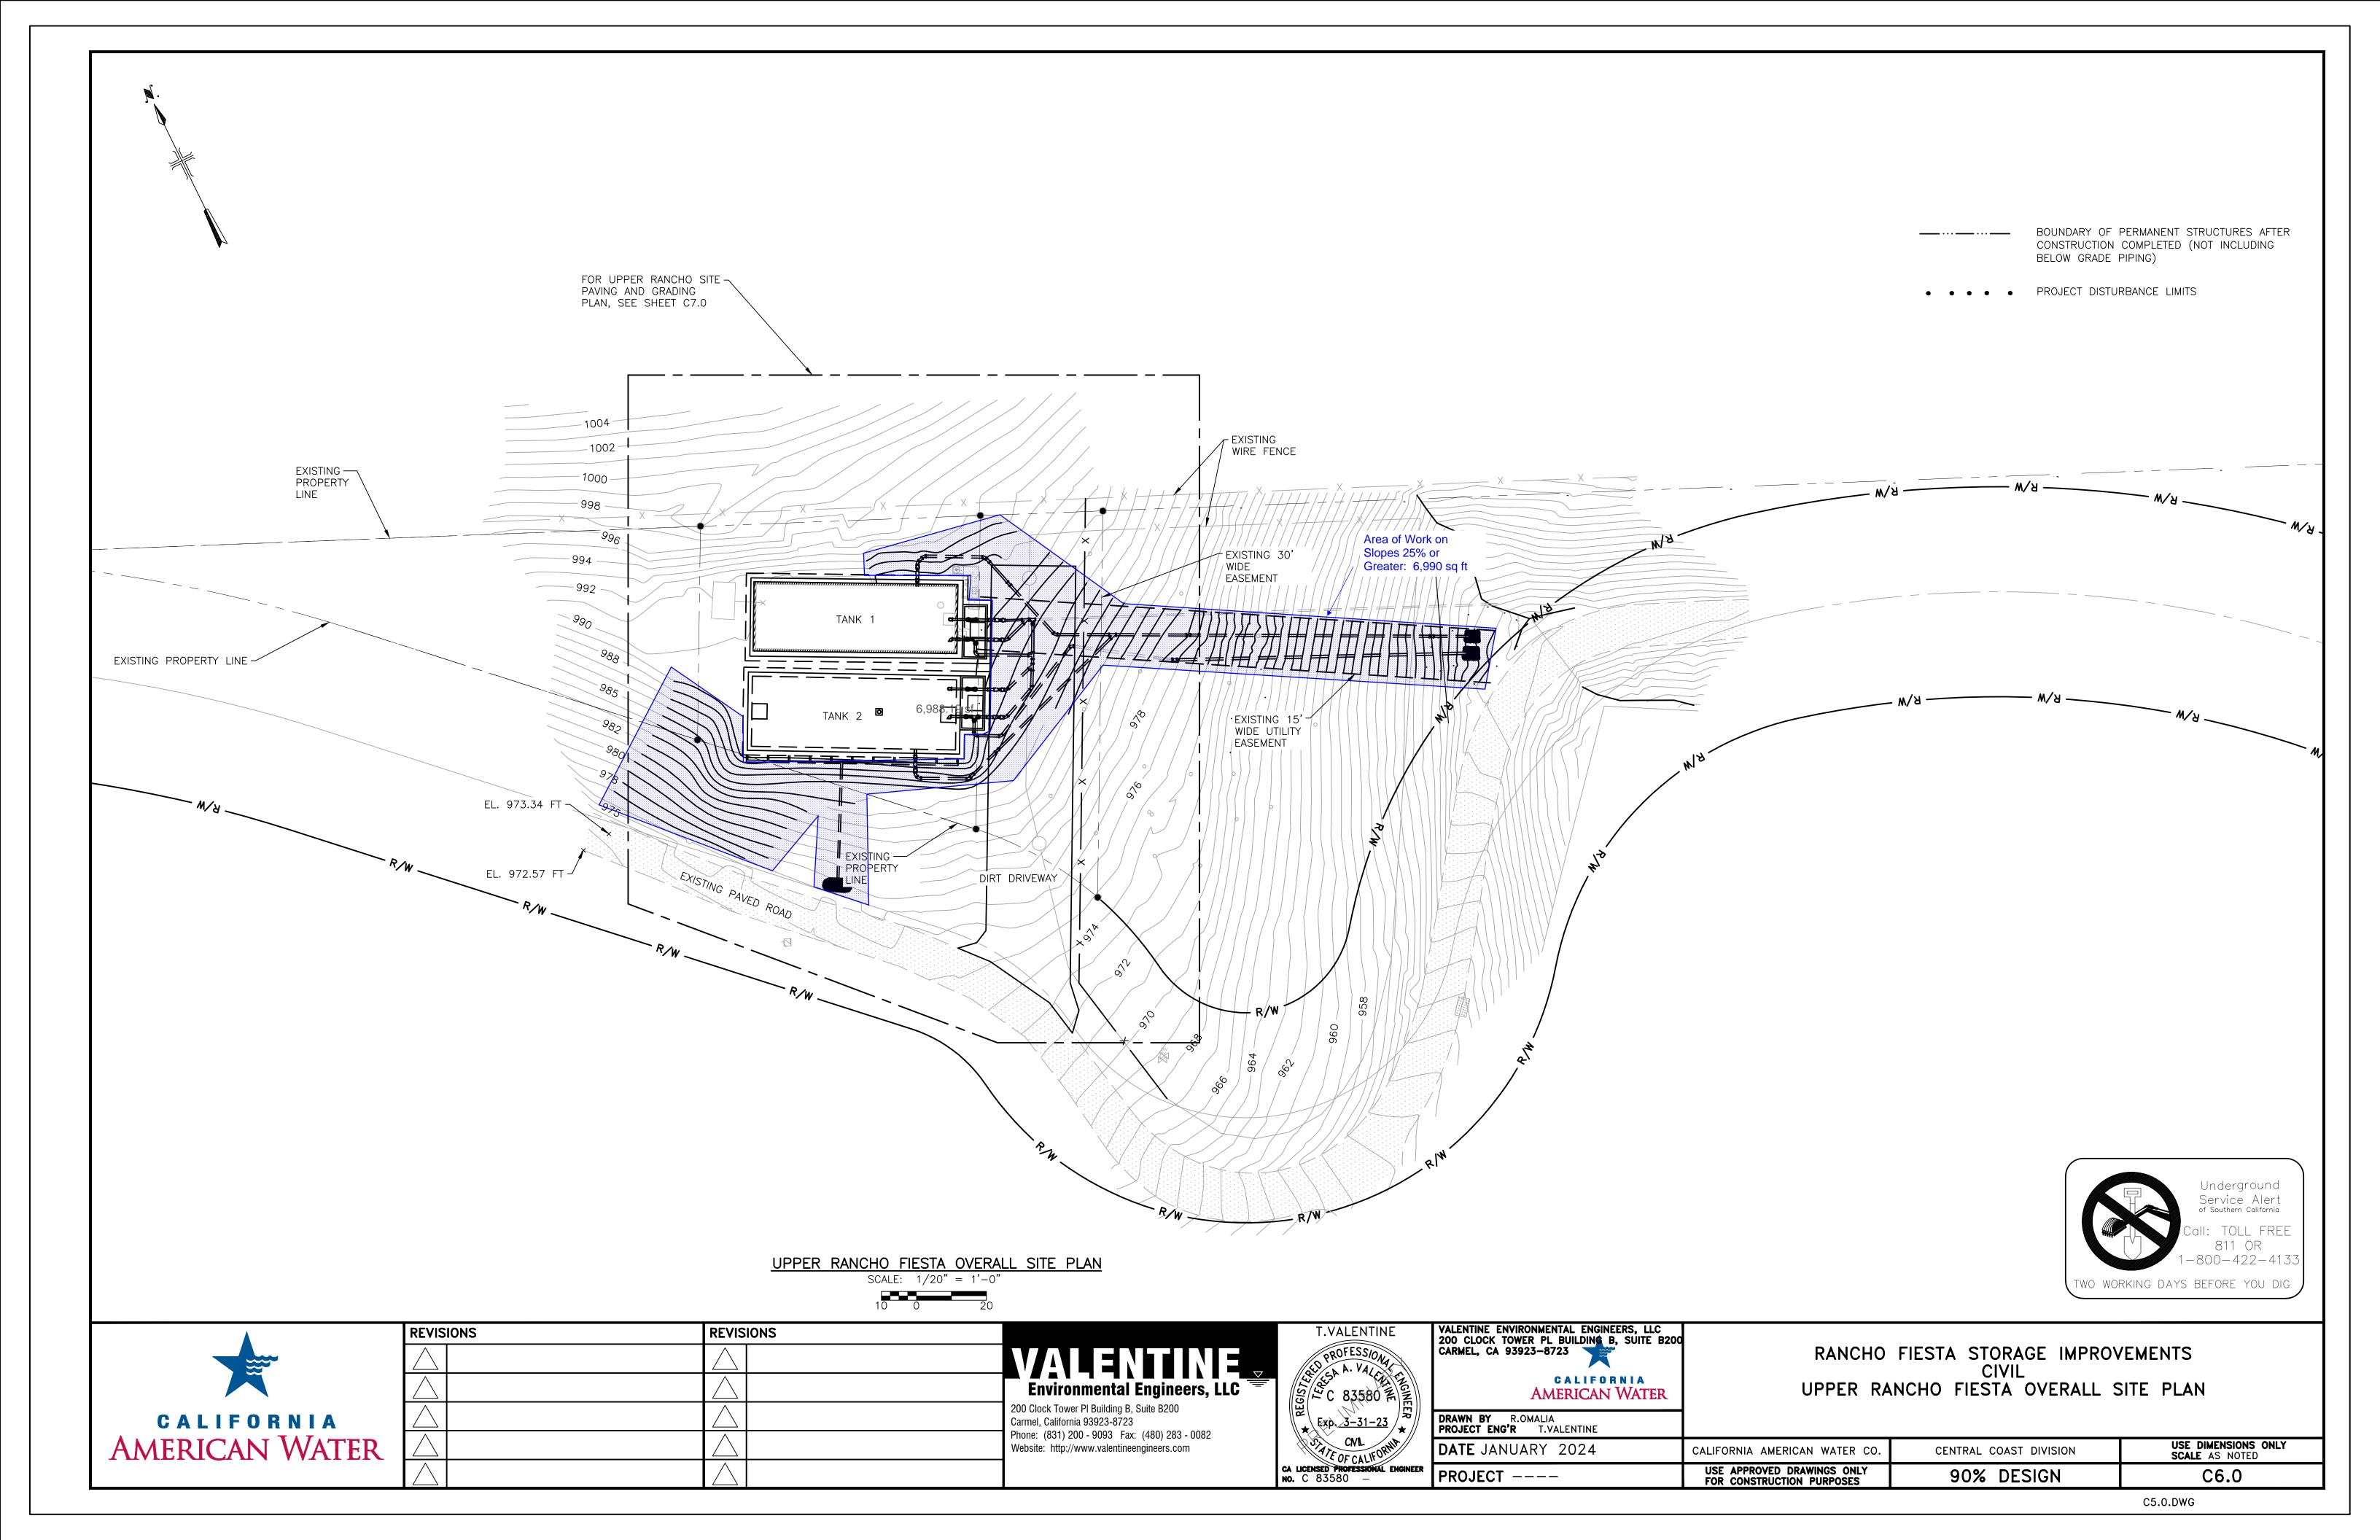

CONSTRUCTION MANAGEMENT PLAN

CONSTRUCTION ACTIVITY:

8 MONTHS, BEGINNING UPON PERMIT ISSUANCE

CONSTRUCTION HOURS

MONDAY - FRIDAY, 8 AM - 5 PM

CONSTRUCTION WORKERS

CONSTRUCTION DURATION

REGULAR CONSTRUCTION TRAFFIC 4 CONTRACTOR PICK-UP TRUCKS, 1 THIRD PARTY INSPECTOR TRUCK

FILL = 1,976 CY

ESTIMATED NUMBER OF REGULAR CONSTRUCTION

TRUCK TRIPS THAT WILL BE GENERATED 800 TRUCK TRIPS

ESTIMATED CONCRETE TRAFFIC 1 REGULAR CONCRETE TRUCK

ESTIMATED NUMBER OF CONCRETE TRUCK

TRIPS THAT WILL BE GENERATED 24 TRUCK TRIPS

MATERIALS STAGING AREA 1,920 SQ. FT.

PARKING AREA FOR TRUCKS AND WORKERS 4,110 SQ. FT.

CONSTRUCTION GRADING CUT = 2,674 CY

CONSTRUCTION SITE PLAN:

PROPOSED BELOW GRADE POTABLE WATER BOOSTER PUMP STATION

2. PROPOSED PARTIALLY BURIED CONCRETE STORAGE TANK 3. SITE YARD PIPING IMPROVEMENTS

4. TEMPORARY VEHICULAR PARKING AND/OR MATERIALS STAGING

5. TEMPORARY PORTA POTTY 6. TEMPORARY STABILIZED CONSTRUCTION ENTRANCE

7. TEMPORARY CONSTRUCTION MATERIALS STAGING AND STOCKPILE AREA

CONSTRUCTION COORDINATION:

CONTRACTOR SHALL PROVIDE A CONSTRUCTION COORDINATOR THAT CAN BE CONTACTED DURING CONSTRUCTION SHOULD QUESTIONS ARISE DURING CONSTRUCTION (IN CASE OF BOTH REGULAR INQUIRIES AND EMERGENCIES). THEIR CONTACT INFORMATION (INCLUDING THEIR ADDRESS AND 24-HOUR PHONE NUMBER) SHALL BE CONSPICUOUSLY POSTED AT THE JOB SITE IN A MANNER THAT THE CONTACT INFORMATION IS READILY VISIBLE FROM PUBLIC VIEWING AREAS. THE POSTING SHALL INDICATE THAT THE CONSTRUCTION COORDINATOR SHOULD BE CONTACTED TO ANSWER ANY QUESTIONS THAT ARISE DURING CONSTRUCTION (IN CASE OF BOTH REGULAR INQUIRIES AND EMERGENCIES). THE CONSTRUCTION COORDINATOR SHALL RECORD THE NAME, PHONE NUMBER, AND NATURE OF COMPLAINTS AND TAKE REMEDIAL ACTIONS IF NECESSARY, WITHIN 24 HOURS OF RECEIPT OF THE COMPLAINT OR INQUIRY.

PROJECT DATA:

PROJECT ADDRESS: 16-15 OAK MEADOW LN, CARMEL VALLEY, CA 93924

PRIMARY CONTRACTOR:

TO BE DETERMINED CALIFORNIA-AMERICAN WATER CO.

SCOPE OF WORK:

CONSTRUCTION OF A 10,000 GALLON CONCRETE STORAGE TANK AND BELOW GRADE BOOSTER PUMP STATION AT LOWER SITE, CONSTRUCTION OF 60,000 GALLON CONCRETE STORAGE TANK

AT THE UPPER SITE. ASSOCIATED YARD PIPING ADDITIONS AT


A.P.N.:


OWNER:

LOWER SITE: 187-031-025-000




VICINITY MAP SCALE: NTS

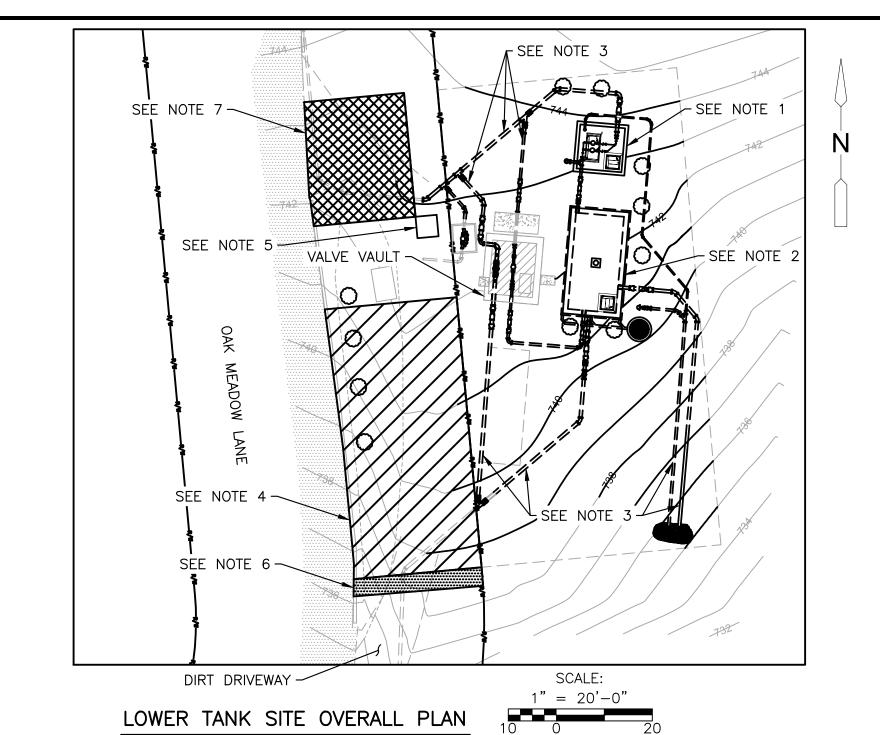

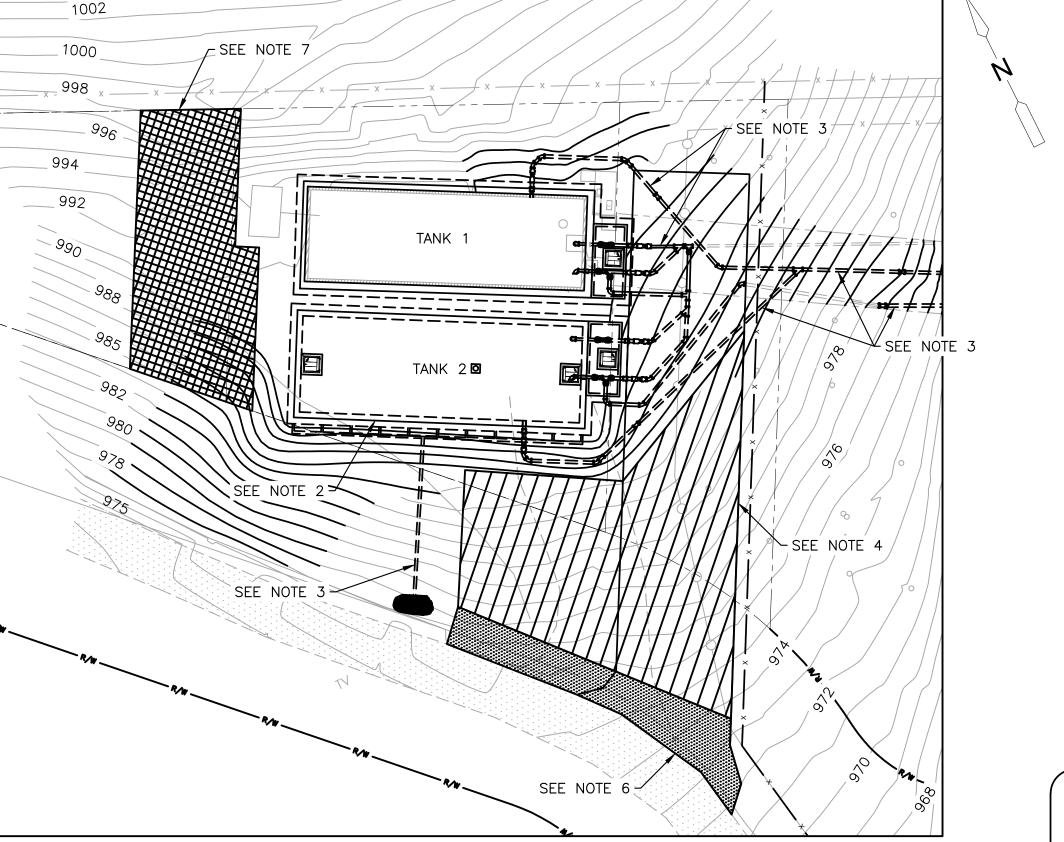

UPPER TANK SITE OVERALL PLAN

CONSTRUCTION WASTE HAULING ROUTE:

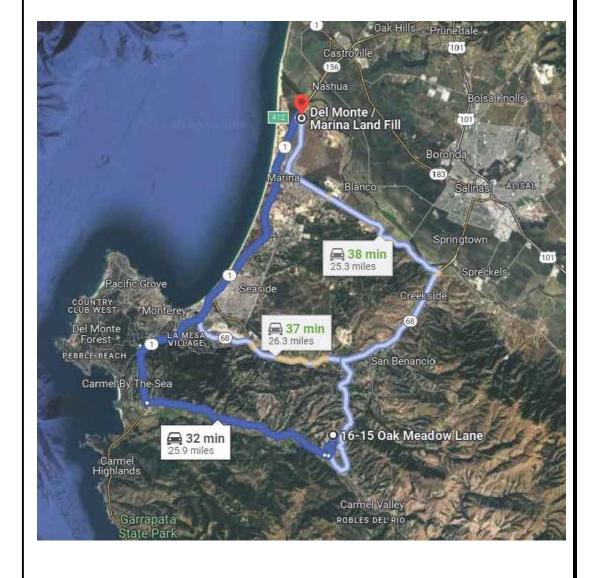

16-15 Oak Meadow Ln Carmel Valley, CA 93924

↑ 1. Head southeast on Oak Meadow Ln toward Bobcat Canyon Rd

144 ft

0.2 mi

8.4 mi

0.3 mi

0.2 mi

👆 2. Turn left onto Rancho Fiesta Rd → 3. Turn right onto Miramonte Rd

→ 4. Turn right onto W Carmel Valley Rd

→ 5. Use any lane to turn right onto CA-1 N

6. Take exit 412 for Del Monte Blvd

7. Turn right onto Del Monte Blvd


Del Monte / Marina Land Fill California







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		VALENTINE
		Environmental Engineers, LLC
		1500 Palma Drive, Suite 257 Ventura, CA 93003
		Phone: (480) 283 - 8991 Fax: (480) 283 - 0082 Website: http://www.valentineengineers.com

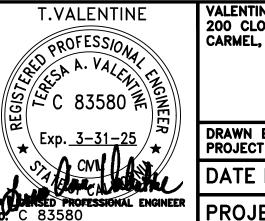

OWEED OF THE PROPERTY OF THE P	VALENTINE ENVIRONMENTAL ENGINEERS, LLC 200 CLOCK TOWER PL BUILDING B, SUITE B200 CARMEL, CA 93923-8723		
	CALIFORNIA AMERICAN WATER		
	DRAWN BY R.OMALIA PROJECT ENG'R T.VALENTINE		

RANCHO FIESTA STORAGE IMPROVEMENTS **GENERAL** CONSTRUCTION MANAGEMENT PLAN (CMP)

ER	PROJECT	USE APPROVED DRAWINGS ONLY FOR CONSTRUCTION PURPOSES		CM1.0
	DATE DECEMBER 2023	CALIFORNIA AMERICAN WATER CO.	CENTRAL COAST DIVISION	USE DIMENSIONS ONLY SCALE AS NOTED
//	DRAWN BY R.OMALIA PROJECT ENG'R T.VALENTINE			

