




# LA NOSTRA TOSCANA

1458 RIATA RD, PEBBLE BEACH, CA.

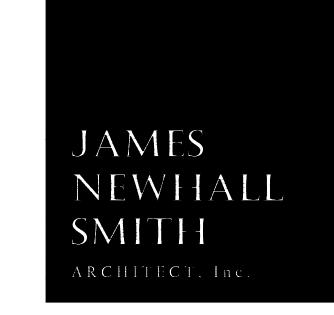

27880 DORRIS DR. #200 CARMEL VALLEY, CA. 93923

831-915-9518 JAMES@JNSARCH.COM

STAMP



PROJECT/CLIENT

SALADINO FAMILY INVESTMENTS, LLC

1458 RIATA RD. PEBBLE BEACH, CA. 93955

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## COVER SHEET

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# SALADINO FAMILY INVESTMENTS, LLC

1458 RIATA RD, PEBBLE BEACH, CA.

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#### GENERAL NOTES **ABBREVIATIONS** 1. EXAMINATION OF THE SITE AND PORTIONS THEREOF WHICH WILL AFFECT THIS WORK SHALL BE MADE NOMINAL IMMEDIATELY BY THE CONTRACTOR, WHO SHALL COMPARE IT WITH THE DRAWINGS AND SATISFY HIMSELF TO NOT TO SCALE CONDITIONS UNDER WHICH WORK IS TO BE PERFORMED. HE SHALL AT SUCH TIME ASCERTAIN AND CHECK LOCATIONS OF THE EXISTING STRUCTURES AND EQUIPMENT WHICH MAY AFFECT HIS WORK. ON CENTER OUTSIDE DIAMETER 2. CONTRACTOR SHALL PROVIDE THE ARCHITECT, JAMES N. SMITH, AND OWNERS, SALADINO FAMILY TRUST INVESTMENTS, LLC. WITH A COMPLETE COST BREAKDOWN AND SCHEDULE OF CONSTRUCTION FOR THIS EXIST'G OR (E) EXISTING PROJECT PRIOR TO COMMENCEMENT OF WORK. OPENING PLASTIC 3. CONTRACTOR SHALL BE RESPONSIBLE TO OBTAIN AND PAY FOR ALL NECESSARY PERMITS INSPECTIONS, **ACOUSTICAL** CERTIFICATES, AND FEES. HE SHALL ALSO BE RESPONSIBLE FOR FILING OF APPLICATION FOR PERMIT AND PLASTIC LAMINAT AREA DRAIN PLAN CHECK APPROVAL AS NECESSARY. (THIS SECTION SUBJECT TO OWNER'S REVIEW AND APPROVAL.) PLASTER ALUMINUM PLYWOOD 4. CONTRACTOR SHALL PROTECT OWNER'S AREA. NEW AND/OR EXISTING MATERIALS AND FINISHES FROM APPROXIMATE PAIR DAMAGE WHICH MAY OCCUR FROM CONSTRUCTION, DEMOLITION, DUST, WATER, ETC., AND SHALL PROVIDE AND **ARCHITECTURAL** MAINTAIN TEMPORARY BARRICADES, CLOSURE WALLS, ETC., AS REQUIRED TO PROTECT THE PUBLIC AND BOARD OWNER DURING THE PERIOD OF CONSTRUCTION. DAMAGE TO NEW AND EXISTING MATERIALS, FINISHES, STRUCTURES, AND EQUIPMENT SHALL BE REPAIRED OR REPLACED. CONTRACTOR SHALL COORDINATE BITUMINUOS REFRIGERATOR TEMPORARY BARRICADES WITH OWNER PRIOR TO COMMENCEMENT OF WORK AS NECESSARY. REINFORCED 5. MATERIALS THAT ARE SPECIFIED BY THEIR BRAND NAMES ESTABLISH STANDARDS OF QUALITY AND PERFORMANCE. ANY REQUEST FOR SUBSTITUTION SHALL BE SUBMITTED TO THE ARCHITECT AND OWNER FOR REQUIRED REVIEW FOR EQUAL QUALITY AND PERFORMANCE AND SHALL NOT BE PURCHASED OR INSTALLED WITHOUT RESILIENT THEIR WRITTEN APPROVAL. ALL NON-SPECIFIED PRODUCTS SHALL CONFORM TO REQUIREMENTS SET FORTH ROOM BY CODE COMPLIANCE OR INDUSTRY STANDARDS AND CONTRACTOR SHALL SUBMIT A LIST OF PRODUCTS ROUGH OPENING AND MANUFACTURERS BEING USED FOR REVIEW BY THE ARCHITECT PRIOR TO PURCHASE OR INSTALLATION. CEILING 6. ALL CONSTRUCTION WORK, ARCHITECTURAL, MECHANICAL, PLUMBING, ELECTRICAL, ETC., AS MAY BE REQUIRED. SHALL CONFORM TO THE LATEST EDITION OF THE UNIFORM BUILDING CODE AND THE LATEST CAULKING **SCHEDULE** EDITION OF ALL GOVERNING CODES AND REGULATIONS AS ADOPTED BY MONTEREY COUNTY. ALL WORK SECTION SHALL BE DONE IN A THOROUGH, WORKMANLIKE MANNER AND EQUAL TO THE BEST STANDARDS OF THE COLUMN PRACTICE. SHELF CONCRETE 7. DIMENSIONS ON CONSTRUCTIONS DRAWINGS ARE TO FACE OF PLY SHEATHING, TYP, OR AS OTHERWISE NOTED $^{ extstyle 1}$ CONTINUOUS BE FACE OF FINISH (F.O.F.), FACE OF COLUMN (F.O.C.), OR CENTER LINE OF OPENING, MULLION, PARTITION, OR SIMILAR DOUBLE COLUMN, ETC. SEE ALSO CORNER DETAIL ON A8 SHEETS **SPECIFICATION** DRINKING FOUNTAIN 8. ALL DIMENSIONS TAKE PRECEDENCE OVER SCALE. ANY DISCREPANCIES SHALL BE BROUGHT IMMEDIATELY DETAIL TO THE ATTENTION OF THE ARCHITECT. CONTRACTOR AND/OR SUBCONTRACTORS SHALL NOT SCALE STANDARD RAWINGS. QUESTIONS REGARDING DIMENSIONS SHALL BE BROUGHT TO THE ARCHITECT OR OWNER PRIOR TO STEEL 9. ALL CONSTRUCTION DOCUMENTS ARE COMPLEMENTARY, AND WHAT IS CALLED FOR BY ANY WILL BE BINDING AS IF CALLED FOR BY ALL. ANY WORK SHOWN OR REFERRED TO ON ANY CONSTRUCTION DOCUMENTS SHALL BE PROVIDED AS THOUGH ON ALL RELATED DOCUMENTS. DISCREPANCIES SHALL BE DRAWER TONGUE AND GRO BROUGHT IMMEDIATELY TO THE ATTENTION OF THE ARCHITECT FOR CLARIFICATION. WORK THAT IS DOWNSPOUT <u>CONTINUED, COVERED UP OR COMPLETED WITHOUT SAID CLARIFICATION SHALL BE AT GENERAL CONTRACTOR'S</u> DRAWING TEMPERED GLAZIN RISK OF REPAIR, REPLACEMENT OR REWORKING AT HIS OWN EXPENSE. EACH TOP OF PLATE 10. ALL WORK LISTED. SHOWN OR IMPLIED ON ANY CONSTRUCTION DOCUMENT SHALL BE SUPPLIED AND TELEVISION INSTALLED BY THE CONTRACTOR EXCEPT WHERE NOTED. THE CONTRACTOR SHALL CLOSELY COORDINATE HIS WORK WITH THAT OF OTHER CONTRACTORS OR VENDORS TO ASSURE THAT ALL SCHEDULES ARE MET AND ELEV. ELEVATOR TYPICAL THAT ALL WORK IS DONE IN CONFORMANCE WITH MANUFACTURER'S REQUIREMENTS. WORK REQUIRED UNDER FLASH FLASHING THIS CONTRACT SHALL INCLUDE ALL LABOR, MATERIALS, EQUIPMENT, ETC. NECESSARY TO COMPLETE THIS F.O.C. FACE OF CONCRETE PROJECT. ALL MATERIALS SHALL BE NEW AND UNUSED, UNLESS SPECIFICALLY NOTED AND BE A QUALITY UNLESS OTHERWI FACE OF STUDS 11. THE USE OF THE WORD "PROVIDE" IN CONNECTION WITH ANY ITEM SPECIFIED IS INTENDED TO MEAN THAT VINYL COMPOSITION SUCH SHALL BE FURNISHED, INSTALLED, AND CONNECTED WHERE SO REQUIRED, EXCEPT AS NOTED. **VERTICAL** 12. THE CONTRACTOR SHALL SUBMIT SHOP DRAWINGS FOR FABRICATED ITEMS, CUT SHEETS OF ALL FIXTURES GALVANIZED AND EQUIPMENT, AND SAMPLES OF ALL FINISHES CALLED FOR BY THE ARCHITECT AND OWNER FOR WATER CLOSET APPROVAL PRIOR TO CONSTRUCTION AND/OR INSTALLATION. GALVANIZED IRON WITHOUT 13. THE CONTRACTOR SHALL MAINTAIN A CURRENT AND COMPLETE SET OF CONSTRUCTION DOCUMENTS ON WATERPROOF THE JOB SITE DURING ALL PHASES OF CONSTRUCTION FOR USE OF ALL TRADES AND SHALL PROVIDE ALL GYPSUM SUBCONTRACTORS WITH CURRENT CONSTRUCTION DOCUMENTS AS REQUIRED. THE CONTRACTOR, IN GYPSUM WALLBOARD ASSUMING RESPONSIBILITY FOR THE WORK INDICATED, SHALL COMPLY WITH THE SPIRIT AS WELL AS WITH THE LETTER IN WHICH THEY WERE DRAWN. HOLLOW CORE HORIZONTAL 14. THE CONTRACTOR SHALL REMOVE ALL RUBBISH AND WASTE MATERIALS OF ALL SUBCONTRACTORS AND TRADES ON A REGULAR BASIS, AND SHALL EXERCISE STRICT CONTROL OVER JOB CLEANING TO PREVENT ANY HOUR DIRT, DEBRIS OR DUST FROM AFFECTING, IN ANY WAY, FINISHED AREAS IN OR OUTSIDE THE JOB SITE. INSIDE DIAMETER INSULATION 15. THE CONSTRUCTION DOCUMENTS ARE PROVIDED TO ILLUSTRATE THE DESIGN AND GENERAL TYPE OF INTERIOR CONSTRUCTION DESIRED AND IMPLY THE FINEST QUALITY OF CONSTRUCTION, MATERIAL AND WORKMANSHIP THROUGHOUT. KITCHEN 16. ALL ELECTRICAL, MECHANICAL, AND PLUMBING WORK AND MATERIALS SHALL BE IN FULL ACCORDANCE LAMINATE WITH THE LATEST RULES AND REGULATIONS OF THE NATIONAL BOARD OF FIRE UNDERWRITERS, THE STATE FIRE MARSHALL, THE SAFETY ORDERS OF THE DIVISION OF INDUSTRIAL SAFETY, AND ANY APPLICABLE STATE LIGHT OR LOCAL LAWS AND ORDINANCES. NOTHING ON THESE DRAWINGS IS TO BE CONSTRUED TO PERMIT WORK MAXIMUM NOT CONFORMING TO THESE CODES. MEDICINE CABINE 17. WORK WHICH IS OBVIOUSLY REQUIRED TO BE PERFORMED IN ORDER TO PROVIDE A COMPLETELY MEMBRANE OPERABLE INSTALLATION WITHIN THE LIMITS AND SCOPE OF WORK, BUT WHICH MAY NOT BE SPECIFICALLY MINIMUM INCLUDED IN THE PLANS, SHALL BE PERFORMED BY CONTRACTOR AND INCLUDED IN HIS BID. MISCELLANEOUS MASONRY OPENING 18. ALL WORK SHALL BE GUARANTEED AGAINST DEFECTS IN DESIGN, INSTALLATION AND MATERIAL FOR A MINIMUM PERIOD OF ONE YEAR FROM DATE OF COMPLETION. MATERIAL 19. CONTRACTOR SHALL PERSONALLY SUPERVISE AND DIRECT THE WORK OR SHALL KEEP A COMPETENT NOT IN CONTRACT EMPLOYEE, AUTHORIZED TO RECEIVE INSTRUCTIONS AND ACT ON THE CONTRACTOR'S BEHALF, NO. OR # CONTINUOUSLY ON SITE DURING WORKING HOURS. 20. TREES ADJACENT TO STRUCTURES AND OVER DRIVEWAYS SHALL BE TRIMMED TO CLEAR STRUCTURES AND PROVIDE 15' CLEARANCE OVER DRIVES. PROTECT OTHER TREES DURING CONSTRUCTION (SEE ARBORIST REPORT). TREES TO BE REMOVED SHALL INCLUDE REMOVAL OF ALL ROOT STRUCTURES AND CONTRACTOR SHALL COORDINATE WITH OWNER FOR POSSIBLE STACKING OF CUT WOOD FOR FUTURE FIREPLACE WOOD. **BUILDING DEPT. NOTES** MATERIALS LEGEND 1. NO PERSON MAY TAP INTO ANY FIRE HYDRANT OTHER THAN FIRE SUPPRESSION OR EMERGENCY AID. WITHOUT FIRST OBTAINING WRITTEN APPROVAL FROM THE WATER PURVEYOR SUPPLYING WATER TO THE HYDRANT AND FROM THE MOUNTEREY COUNTY HEALTH DEPARTMENT. WOOD, FINISH 2. ALL HOSES USED IN CONNECTION WITH ANY CONSTRUCTION ACTIVITIES SHALL BE EQUIPPED WITH A NOZZLE SHUT-OFF. WHEN AN AUTOMATIC SHUT-OFF NOZZLE CAN BE PURCHASED OR OTHERWISE OBTAINED FOR SAND, MORTAR, PLASTER WOOD, FRAMING THE SIZE OR TYPE OF HOSE IN USE, THE NOZZLE SHALL BE AN AUTOMATIC SHUT-OFF NOZZLE. (THRU MEMBER) ROCK FILL NO POTABLE WATER MAY BE USED FOR COMPACTION ORDUST CONTROL PURPOSES IN CONSTRUCTION WOOD FRAMING ACTIVITIES WHERE THERE IS A REASONBLY AVAILABLE SOURCE OF RECLAIMED OR OTHER SUB-POTABLE (INTERRUPTED MEMBER) CONCRETE WATER APPROVED BY THE MONTEREY COUNTY HEALTH DEPARTMENT AND APPROPRIATE FOR SUCH USE. PLYWOOD\*

7. GRADING PERMIT, IF REQUIRED, IS BY SEPARATE PERMIT.


8. SPRINKLER SYSTEM, IF REQUIRED, TO BE PER SEPARATE PERMIT.

9. RETAINING WALLS UNCONNECTED TO THE STRUCTURE(S), IF REQUIRED, ARE PER SEPARATE PERMIT.

	PROJECT DIRECTORY	
	■ PROPERTY OWNERS:  SALADINO FAMILY INVESTMENTS, LLC  7058 N. WEST AVE. #139  FRESNO, CA. 93711	
ER	CONTACT: CRAIG SALADINO TEL: (559) 903-5600 EMAIL: CSALADINO78@OUTLOOK.COM	
.TE	■ ARCHITECT:  JAMES N. SMITH, ARCHITECT, INC.  27880 DORRIS DR. #200  CARMEL, CA. 93923  CONTACT PERSON: JAMES SMITH  TEL. (831) 915-9518  EMAIL: JAMES@JNSARCH.COM	
S	□ CONTRACTOR:  MARK CRISTOFALO & COMPANY 1714 CONTRA COSTA ST. SAND CITY, CA. 93955 CONTACT PERSON: MARK CRISTOFALO TEL: (831) 241-4214 MARK@MARKCRISTOFALO.COM	
	□ INTERIOR DESIGNER:  J. BANKS DESIGN  35 N. MAIN ST.  HILTON HEAD ISLAND, SC. 29926  CONTACT PERSON: DORIS GILCH  TEL: (843) 681-5122 EXT. 1741  DORIS.GILCH@JBANKS.COM	
TE SLAB	■ STRUCTURAL ENGINEER:  ZFA STRUCTURAL ENGINEERS 1303 JEFFERSON ST., SUITE 400A NAPA, CA. 94559 CONTACT PERSON: AARON LUCAS TEL. (707) 492-3452 X501 EMAIL: AARONL@ZFA.COM	
ROOVE	□ CIVIL ENGINEER / SURVEYOR:	
ING	WHITSON ENGINEERS 6 HARRIS COURT MONTEREY, CA. 93940 CONTACT PERSON: RICH WEBER TEL. (831) 649-5225 RWEBER@WHITSONENGINEERS.COM	
	■ SOILS ENGINEER	
ISE	GRICE ENGINEERING 561A BRUNKEN AVE. SALINAS, CA. 93901 CONTACT PERSON: SAM GRICE TEL. (831) 422-9619 FAX (831) 422-1896 SAM'S CELL (831) 594-7699 SAM'S EMAIL: SAMGE@SBCGLOBAL.NET JEFF OLMS (831) 594-4664 (FIELD TECH)	
	■ TITLE 24 / MECHANICAL ENGINEER  MONTEREY ENERGY GROUP  227 FOREST AVENUE, SUITE #5  PACIFIC GROVE, CA. 93950  CONTACT PERSON: DAVID KNIGHT  TEL. (831) 372-8328	
	FAX (831)372-4613 EMAIL: DAVE@MEG4.COM	
	■ LANDSCAPE DESIGN	
	FLORAVISTA 982 PHEONIX AVE. VENTURA, CA. 93004 CONTACT PESON: DINAH IRINO CELL (831) 261-4840 EMAIL: FLORA.VISTA@SBCGLOBAL.NET	
	■ ARBORIST	
	ALBERT WEISFUSS MONTEREY BAY TREEWORKS P.O. BOX 223374	
	CARMEL, CA. 93922 TEL. (831) 869-2767 EMAIL: ALBERTWEISFUSS@GMAIL.COM	

# ARCHAEOLOGICAL NOTE PROPER MITIGATION MEASURES REQUIRED FOR THE DISCOVERY, SPECIAL INSPECTIONS OF FOOTING. SYSTEM INSTALLATION TO THE BUILDING INSPECTOR. BUILDING DEPARTMENT.

# LOWER LEVEL LOWER LEVEL-ADU LOWER LEVEL-SUB GRADE TOTAL (E) LIVABLE AREA GARAGE-3 CAR MAX. ALLOW FLOOR AREA RATIO = 5,516 S.F. (17.5%) PERMEABLE/PERVIOUS SITE COVERAGE LOWER DRIVEWAY ENTRY TERRACE

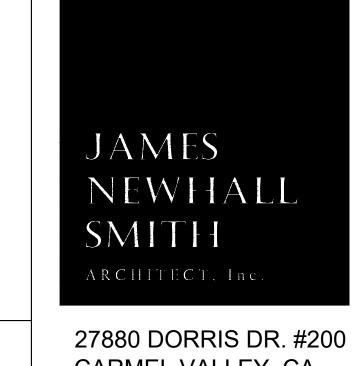

CARMEL VALLEY, CA

831-915-9518 JAMES@JNSARCH.COM



PROJECT/CLIENT

SALADINO FAMILY INVESTMENTS. LLC

1458 RIATA RD. PEBBLE BEACH, CA. 93955

SHEET TITLE

) ISSUE

/\ REVISIONS

(1)02-12-25 ´ PLANNING SUBMITTAL 2 06-12-25 DRIVEWAY REVISIONS


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IF, DURING THE COURSE OF CONSTRUCTION, CULTURAL, ARCHAEOLOGICAL, HISTORICAL OR PALEONTOLOGICAL RESOURCES ARE UNCOVERED AT THE SITE (SURFACE OR SUBSURFACE RESOURCES) WORK SHALL BE HALTED IMMEDIATELY WITHIN 50 METERS (165 FEET) OF THE FIND UNTIL A QUALIFIED PROFESSIONAL ARCHAEOLOGIST CAN EVALUATE IT. THE MONTEREY COUNTY RMA - PLANNING DEPARTMENT AND A QUALIFIED ARCHAEOLOGIST (I.E., AN ARCHAEOLOGIST REGISTERED WITH THE REGISTER OF PROFESSIONAL ARCHAEOLOGISTS) SHALL BE IMMEDIATELY CONTACTED BY THE RESPONSIBL INDIVIDUAL PRESENT ON-SITE. WHEN CONTACTED, THE PROJECT PLANNER AND THE ARCHAEOLOGIST SHALL IMMEDIATELY VISIT THE SITE TO DETERMINE THE EXTENT OF THE RESOURCES AND TO DEVELOP

1. THE GEOTECHNICAL ENGINEER SHALL INSPECT THE BUILDING PADS AND FOUNDATION EXCAVATIONS PRIOR TO THE PLACEMENT OF REINFORCING BARS, AND SHALL SUBMIT WRITTEN APPROVAL TO THE BUILDING INSPECTOR BEFORE REQUESTING FOUNDATION INSPECTION AND POURING

ENGINEER SHALL BE SENT TO THE BUILDING DEPARTMENT STATING THIS APPROVAL. 3. THE TRUSSES SHALL NOT BE INSTALLED UNTIL AN APPROVED JOB COPY OF THE TRUSS SUBMITTALS IS ISSUED BY THE BUILDING DEPARTMENT. 4. GLU-LAM CERTIFICATES SHALL BE COPIED TO THE BUILDING DEPARTMENT.



PROJECT INFORMATION

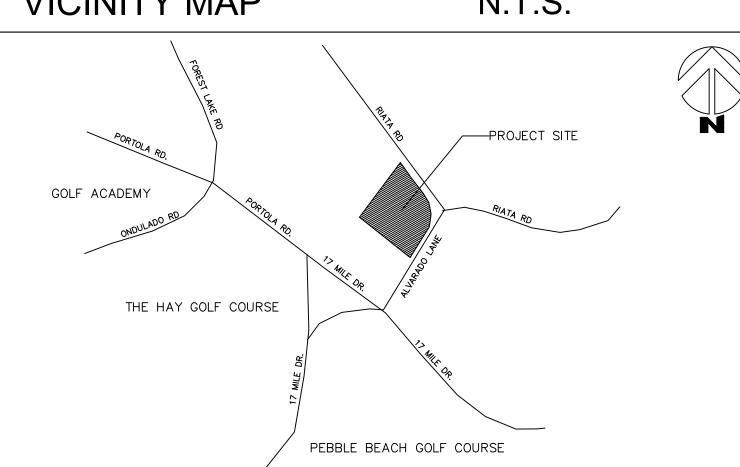■ COUNTY OF MONTEREY ZONING: LDR/1.5-D(CZ)

■ MAX. ALLOWABLE MAIN BUILDING HEIGHT: 30'

■ TREE REMOVAL: YES-SEE ARBORIST REPORT

■ 30% SLOPES: YES 119 S.F. ON 30% SLOPES

■ PROJECT CODE COMPLIANCE-CODE EDITIONS USED:

2022 CAL. BUILDING CODE-CBC

2022 CAL. PLUMB. CODE-CPC

2022 CAL. GREEN BLDG STNDS-CGBCS

AUTOMATIC SPRINKLERS EXISTING:

AUTOMATIC SPRINKLERS REQUIRED:

P.B.C.S.D

PROJECT SQUARE FOOTAGE INFORMATION

(N) BUILDING FOOTPRINT

(N) FRONT COVERED TERRACE = 158 S.F.

(N) MSTR. BEDROOM TERRACE = 90 S.F.

(N) ROOF EAVES OVER 30" = 0 S.F.

MAX. ALLOWED BLDG. SITE COVER = 4,728 S.F. (15%)

PROPOSED SITE COVERAGE = 4,710 S.F. (14.9%)

PROPOSED FLOOR AREA TOTAL = 5,180 S.F. (16.4%)

(N) REAR TERRACE

WOOD FRAMED DECKS

(N) REAR STAIR

PROPOSED FLOOR AREA

UPPER ENTRY DRIVEWAY

REAR LOWER TERRACE

REAR LOWER WALK

MAIN LEVEL

WILDLAND URBAN INTERFACE CODES REQ'D: YES

ELEC / GAS: PG&E (UNDERGROUND SERVICE)

2022 CAL ELEC. CODE—CEC

2022 CAL. FIRE CODE—CFC

■ BUILDING OCCUPANCY: R-3 / U

FIRE DISTRICT: P.B.C.S.D.

□ CONSTRUCTION TYPE: VB

W.U.I. ZONE: S.R.A

■ FIRE DEPARTMENT:

UTILITY PROVIDERS

SEWER:

■ TOTAL SITE AREA:

■ BUILDING COVERAGE

■ FLOOR AREA RATIO

MAX. ALLOWABLE ACCESSORY BUILDING HEIGHT: 15'

ADU. PROJECT INCLUDES PERIMETER FENCE AND VEHICLE GATES.

TITLE 20 (COASTAL ZONE) FOR MONTEREY COUNTY FILE# PLN21-0096

30% SLOPES WERE MAN-MADE FROM PREVIOUS HOUSE PAD GRADING.

□ APPROX. GRADING: 225 CY CUT, 825 CY FILL (SEE CIVIL SHEETS)

■ PESCADERO WATERSHED: YES- 9,000 BLDG/SITE COVERAGE

PROPOSED AREAS TO BE BUILT ON 30% SLOPES ARE MINIMAL AND UNAVOIDABLE.

PARKING PROVIDED

UNCOVERED:

COVERED:

BUILD NEW TWO STORY RESIDENCE ON VACANT LOT WITH COVERED LIVING/DINING TERRACE AND LOWER

2022 CAL. RESIDENTIAL CODE-CRC

YES NFPA 13D PER 903.3.1.3

=31,519 S.F. (.73 Ac.)

= 0 S.F. (LESS THAN 24" ABOVE GRADE)

= 386 S.F. (NOT FULLY SUB-GRADE)

= 0 S.F. (1,458 FULLY SUB-GRADE)

= 3,664 S.F.

= 636 S.F.

= 162 S.F.

MAX. ALLOWED BLDG./SITE COVER = 9,000 S.F. (PESCADERO DOES NOT APPLY)

= 3,664 S.F.

= 4,050 S.F.

= 1,130 S.F.

= 0 S.F. (769 S.F.)

= 1,243 S.F. (E) WAS 2,200 S.F.

= 1,623 S.F. (E) WAS 745 S.F.

= 236 S.F. (E) DEMO'D IS 150 S.F.

= 312 S.F. (E) DEMO'D IS 350 S.F.

= 154 S.F. (E) DEMO'D IS 150 S.F.

8 LIN. FT.

60 LIN. FT.

2022 CAL. MECH. CODE-CMC

2022 CAL. ENERGY CODE-CEC

LEVEL THAT INCLUDES AN ATTACHED THREE CAR GARAGE. FULLY SUBGRADE LIVING AREA AND AN

■ PROJECT DESCRIPTION:

PLANNING INFORMATION

□ PARKING REQUIRED

UNCOVERED:

BUILDING INFORMATION

□ A.P.N. 008−332−019

= 1' HIGH (N) RETAINING WALL W-1 SYMBOLS = 6" HIGH 11 LIN. FT. = 2' HIGH 48 LIN. FT (N) RETAINING WALL W-2 THE STRUCTURAL ENGINEER OF RECORD SHALL INSPECT THE BUILDINGS = 5' HIGH 32 LIN. FT. FOUNDATIONS WITH ALL REINFORCING PER PLAN PRIOR TO POURING. (N) RETAINING WALL W-3 GRID LINE

A H NUMBERS VERTICAL THE ENGINEER SHALL SUBMIT WRITTEN APPROVAL OF THE FOUNDATION = 3' HIGH 44 LIN. FT. N) RETAINING WALL W-4 = AT GRADE 27 LIN. FT. (N) RETAINING WALL W-4A LETTERS HORIZONTAL = 5' HIGH 8 LIN. FT. (N) RETAINING WALL W-5 M DOOR SYMBOL-NUMBERS 3. THE STRUCTURAL ENGINEER OF RECORD SHALL PROVIDE PERIODIC = AT GRADE 12 LIN. FT. (N) RETAINING WALL W-6 INSPECTIONS OF THE FRAMING AND PROVIDE WRITTEN REPORTS TO THE (M) WINDOW SYMBOL-NUMBERS (N) RETAINING WALL W-7 = 8' HIGH (N) RETAINING WALL W-8 = 4' HIGH DETAIL DETAIL IDENTIFICATION 4. ALL WELDING SHALL BE CONTINUOUSLY INSPECTED BY AN INDEPENDANT SHEET WHERE DETAIL IS DRAWN INSPECTOR APPROVED BY THE BUILDING DEPARTMENT. VICINITY MAP SECTION IDENTIFICATION ✓── SHEET WHERE SECTION IS DRAWN ELEVATION IDENTIFICATION SHEET WHERE ELEVATION IS DRAWN DEFERRED SUBMITTALS OFFICE ROOM IDENTIFICATION ROOM NAME REVISIONS—NUMBERS
CLOUD AROUND REVISION OPTIONAL 1. TRUSS CALCS SHALL BE SUBMITTED FOR APPROVAL PRIOR TO ANY TRUSS INSPECTIONS. CALCS BY MANUFACTURER SHALL INCLUDE TRUSS PROFILES MATCH LINE
SHADED PORTION IS THE SIDE CONSIDERED AND LAYOUT PLANS. 4. THE USE OF SOLDERS CONTAINING MORE THAN 2/10ths OF 1% LEAD IN MAKING JOINTS ON PRIVATE OR 2. THE MANUFACTURED TRUSS SUBMITTALS SHALL BE REVIEWED (INDICATED GLASS ★ WORK POINT/CONTROL/DATUM CONCRETE BLOCK (C.M.U.) PUBLIC WATER SUPPLY SYSTEMS IS PROHIBITED (SB 164). BY LETTER OR STAMP. SIGNATURE AND DATE) BY THE ENGINEER OF ACOUSTIC TILE RECORD FOR DESIGN COMPATIBILITY. A CERTIFICATION LETTER FROM THE 5. PROVIDE NON-REMOVABLE BACKFLOW DEVICES AT ALL HOSEBIBS. GRADE NEW OR FINISHED GRADE AT EXTERIOR FINISH FLOOR ELEVATION AT INTERIOR 6. THE BUILDER/CONTRACTOR SHALL PROVIDE THE OWNER AND THE COUNTY BUILDING DIVISION WITH A COPY (EXISTING GRADE OF THE CF-6R INSTALLATION CERTIFICATE AT THE TIME OF FINAL INSPECTION. INSULATION. BATT --- PROPERTY LINE


——— <u>CENTER LINE</u>


FLOOR ELEVATION

INSULATION, RIGID

\* PLYWOOD IS SHOWN DIAGRAMMATICALLY. THE NUMBER OF DIVIDING LINES AND SLASHES DO

NOT INDICATE STRENGTH OR NUMBER OF PLIES. S.S.D. FOR THIS INFORMATION

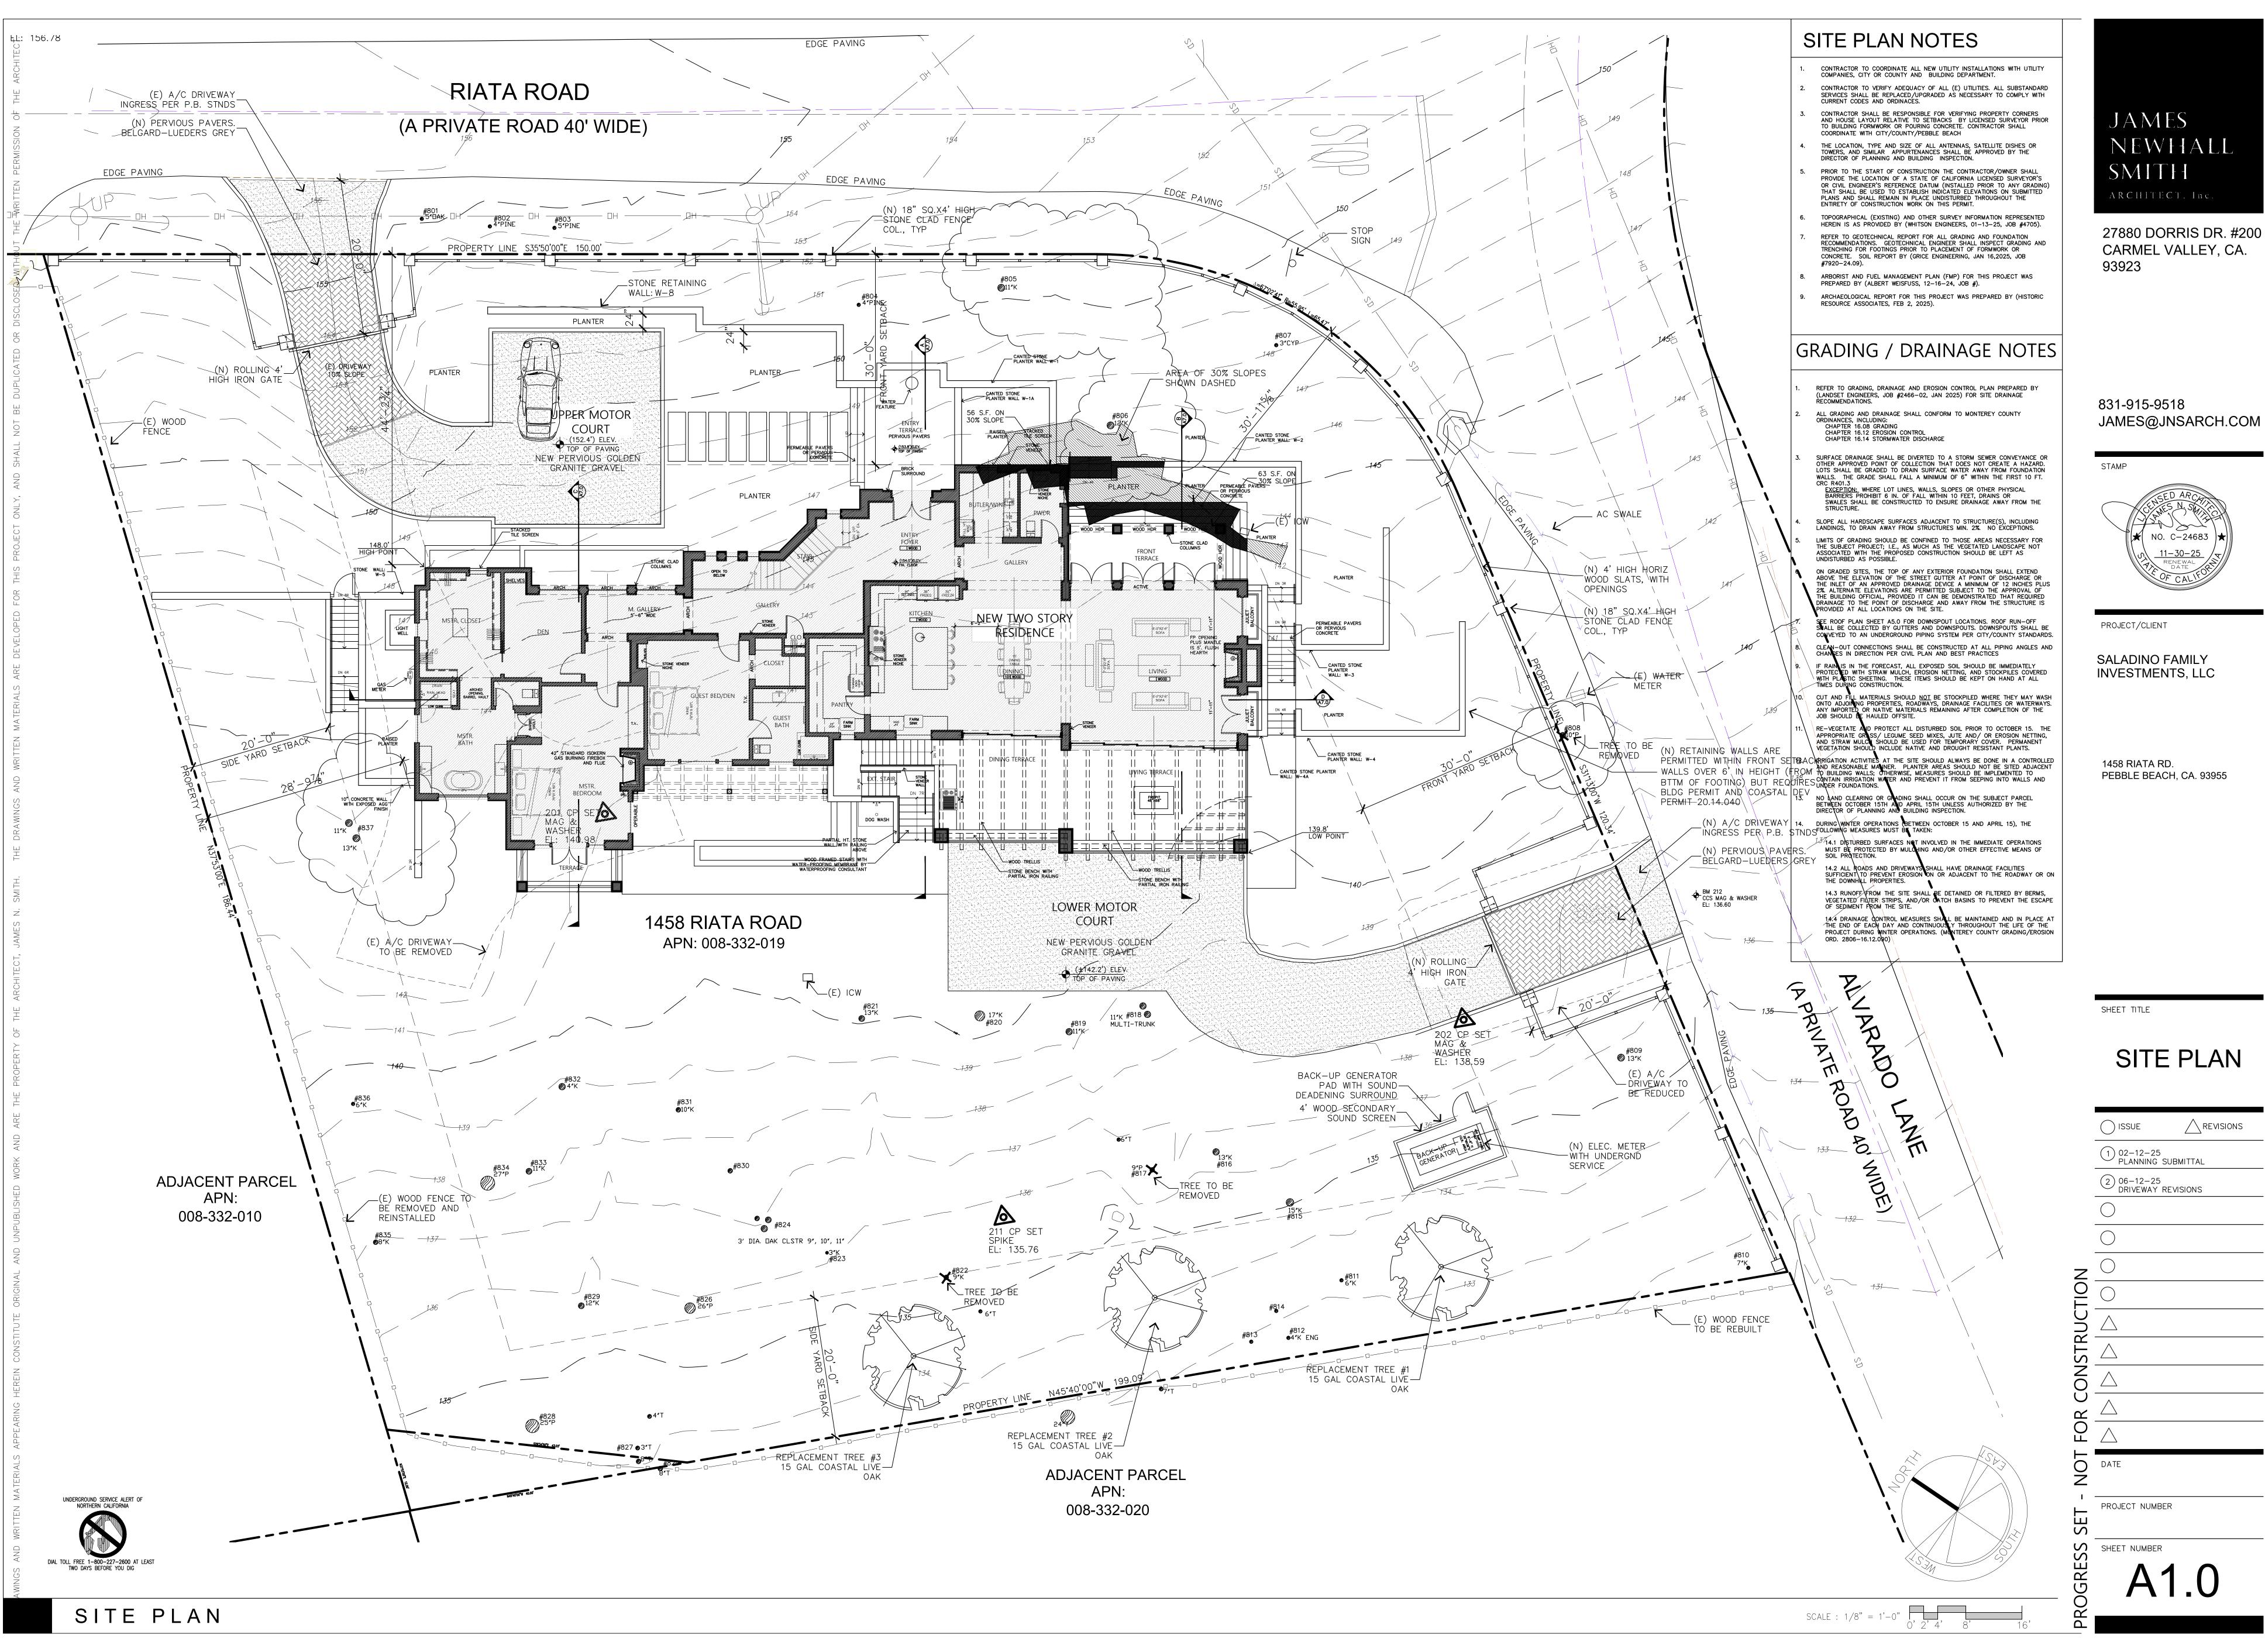

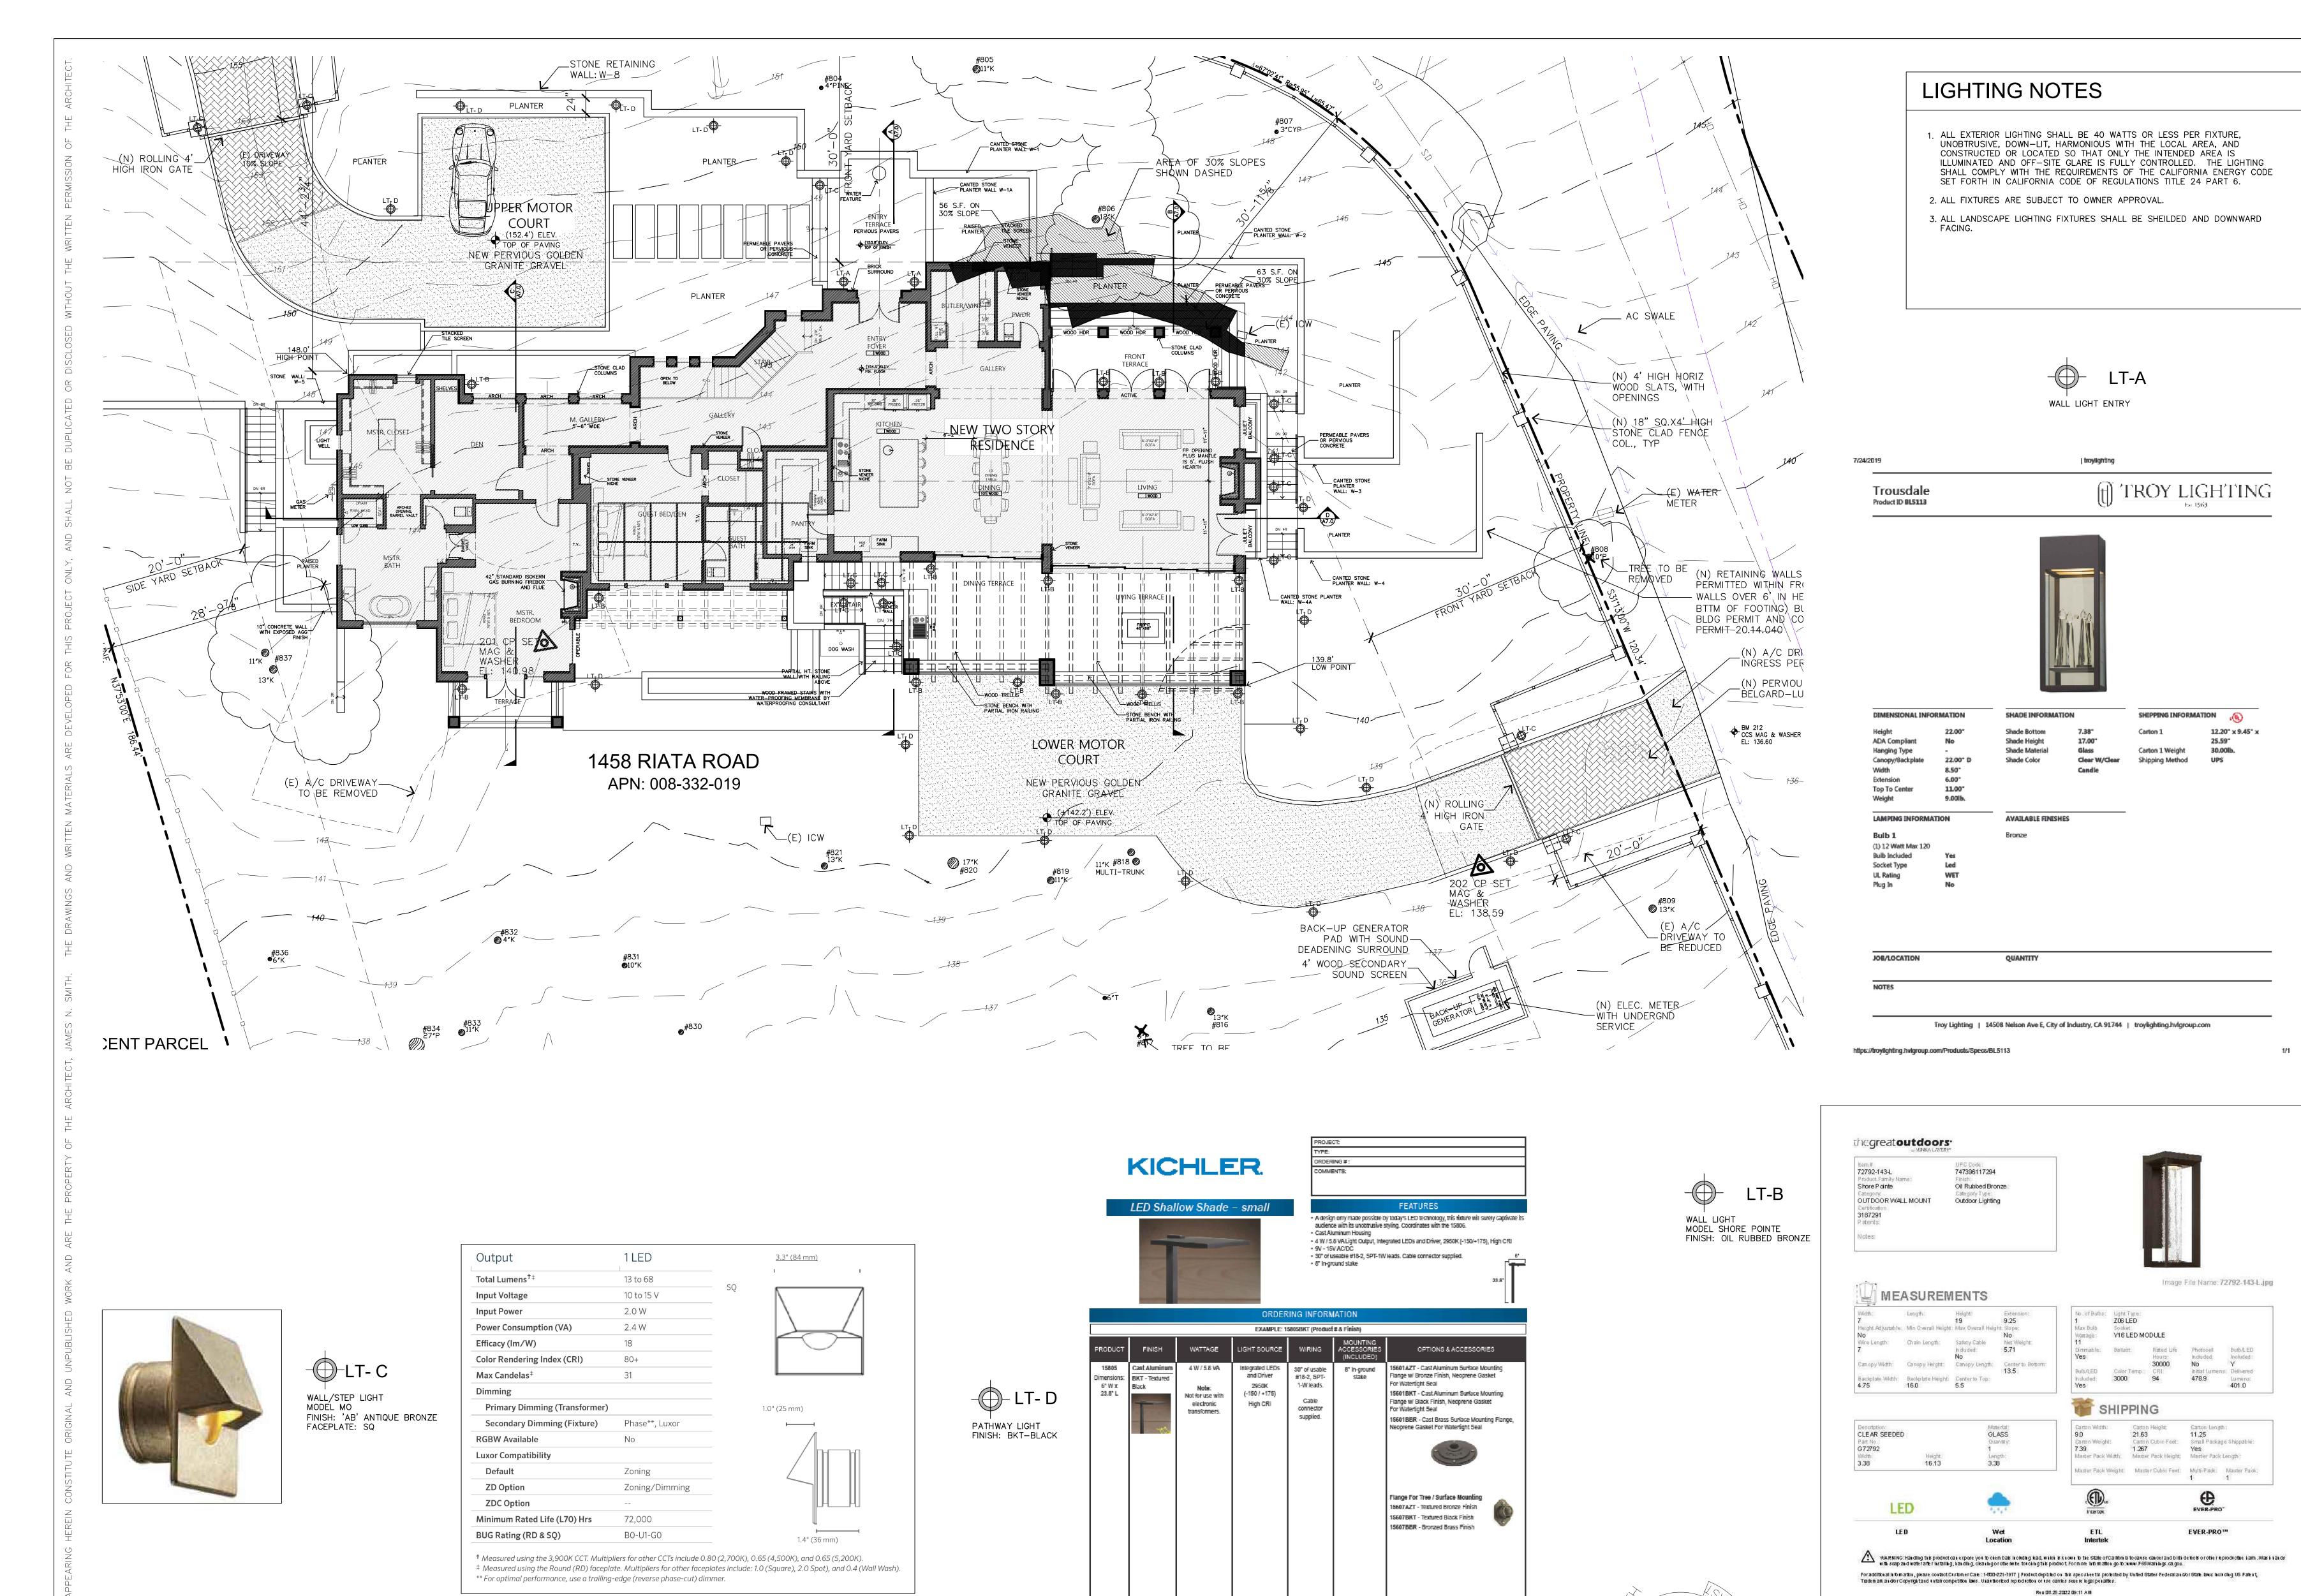

Optione Investigate 0' 1' 2' 3' 4' 5' 6' 7' 8'
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For Warranty Information,

please visit www.landscapelighting.com

We reserve the right to revise the design or components of any product due to

parts availability or change in UL standards, without assuming any obligation or

liability to modify any products previously manufactured, and without notice.

7711 E. Pieasant Valley Road, Cleveland, OH 44131 ph;(216) 573-1000 fax;(216) 573-2270 email:sales@kichier.com web:landscapelighting.com

JAMES
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27880 DORRIS DR. #200 CARMEL VALLEY, CA. 93923

831-915-9518 JAMES@JNSARCH.COM

STAMP

NO. C-24683

NO. C-24683

TI-30-25

RENEWAL
DATE
OF CALFOR

PROJECT/CLIENT

SALADINO FAMILY INVESTMENTS, LLC

1458 RIATA RD. PEBBLE BEACH, CA. 93955

SITE LIGHTING

LIGHTING PLAN

ISSUE REVISIONS

1) 02-12-25
PLANNING SUBMITTAL

2) 06-12-25
DRIVEWAY REVISIONS


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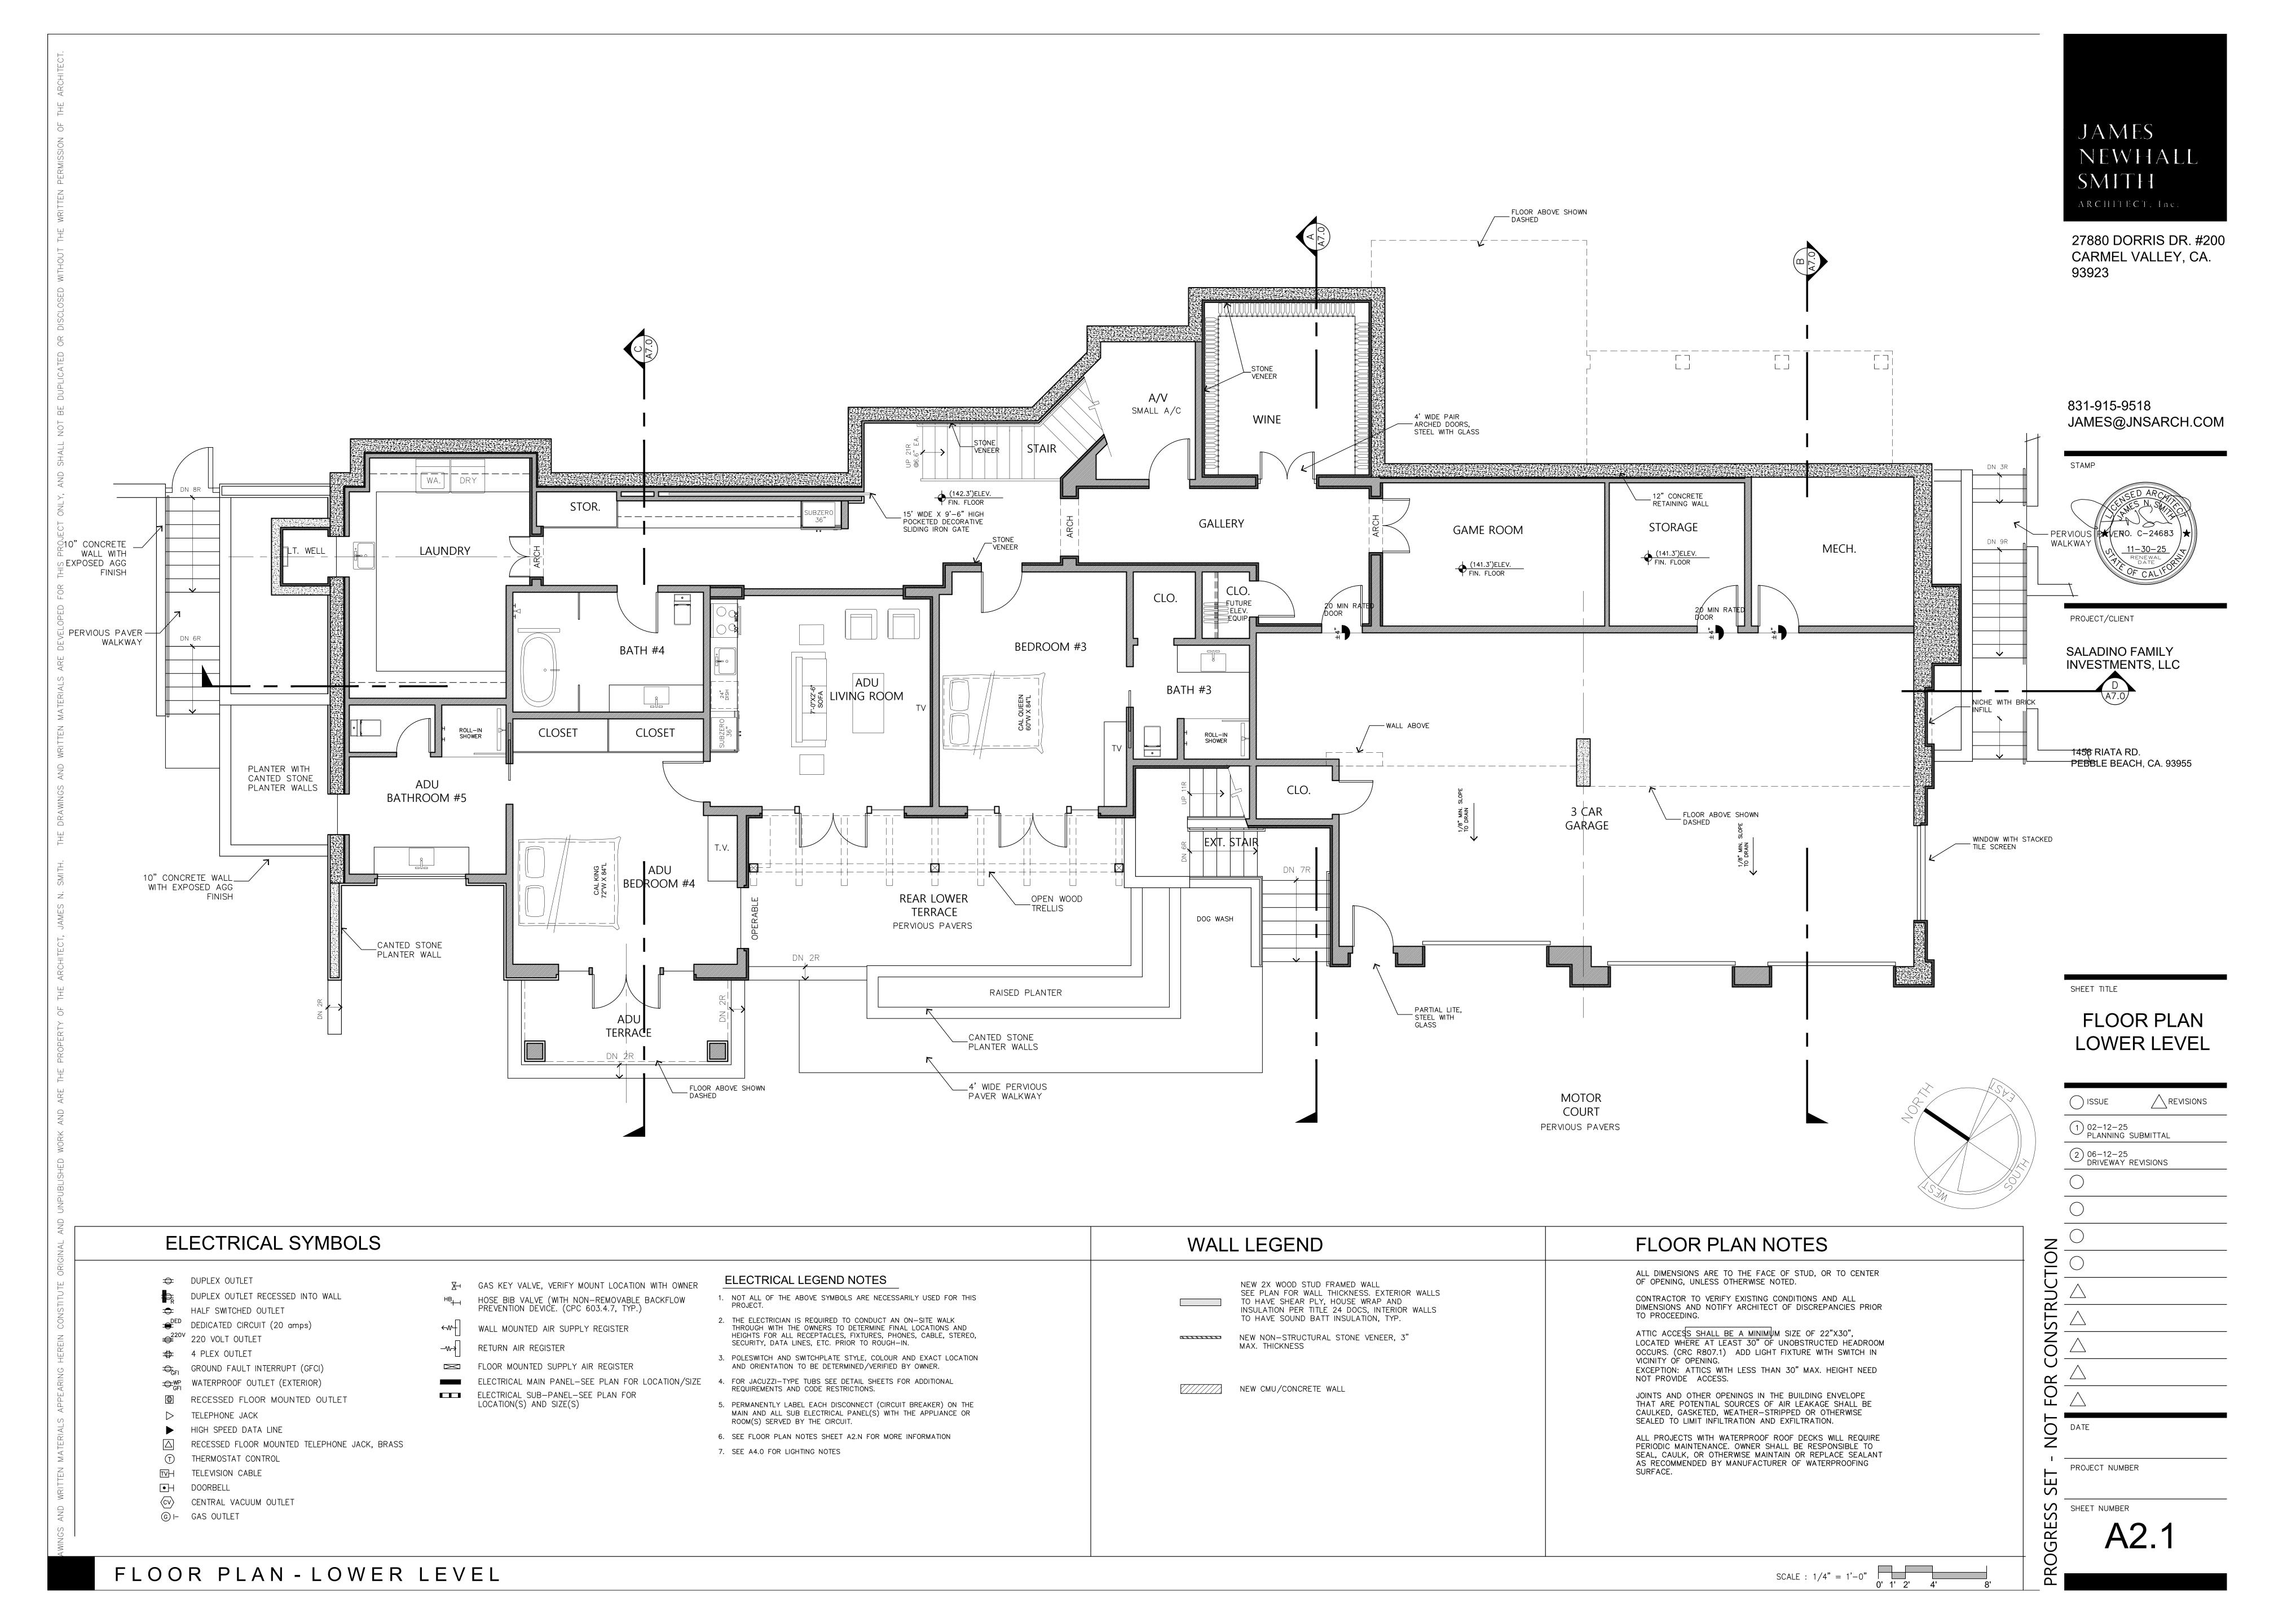
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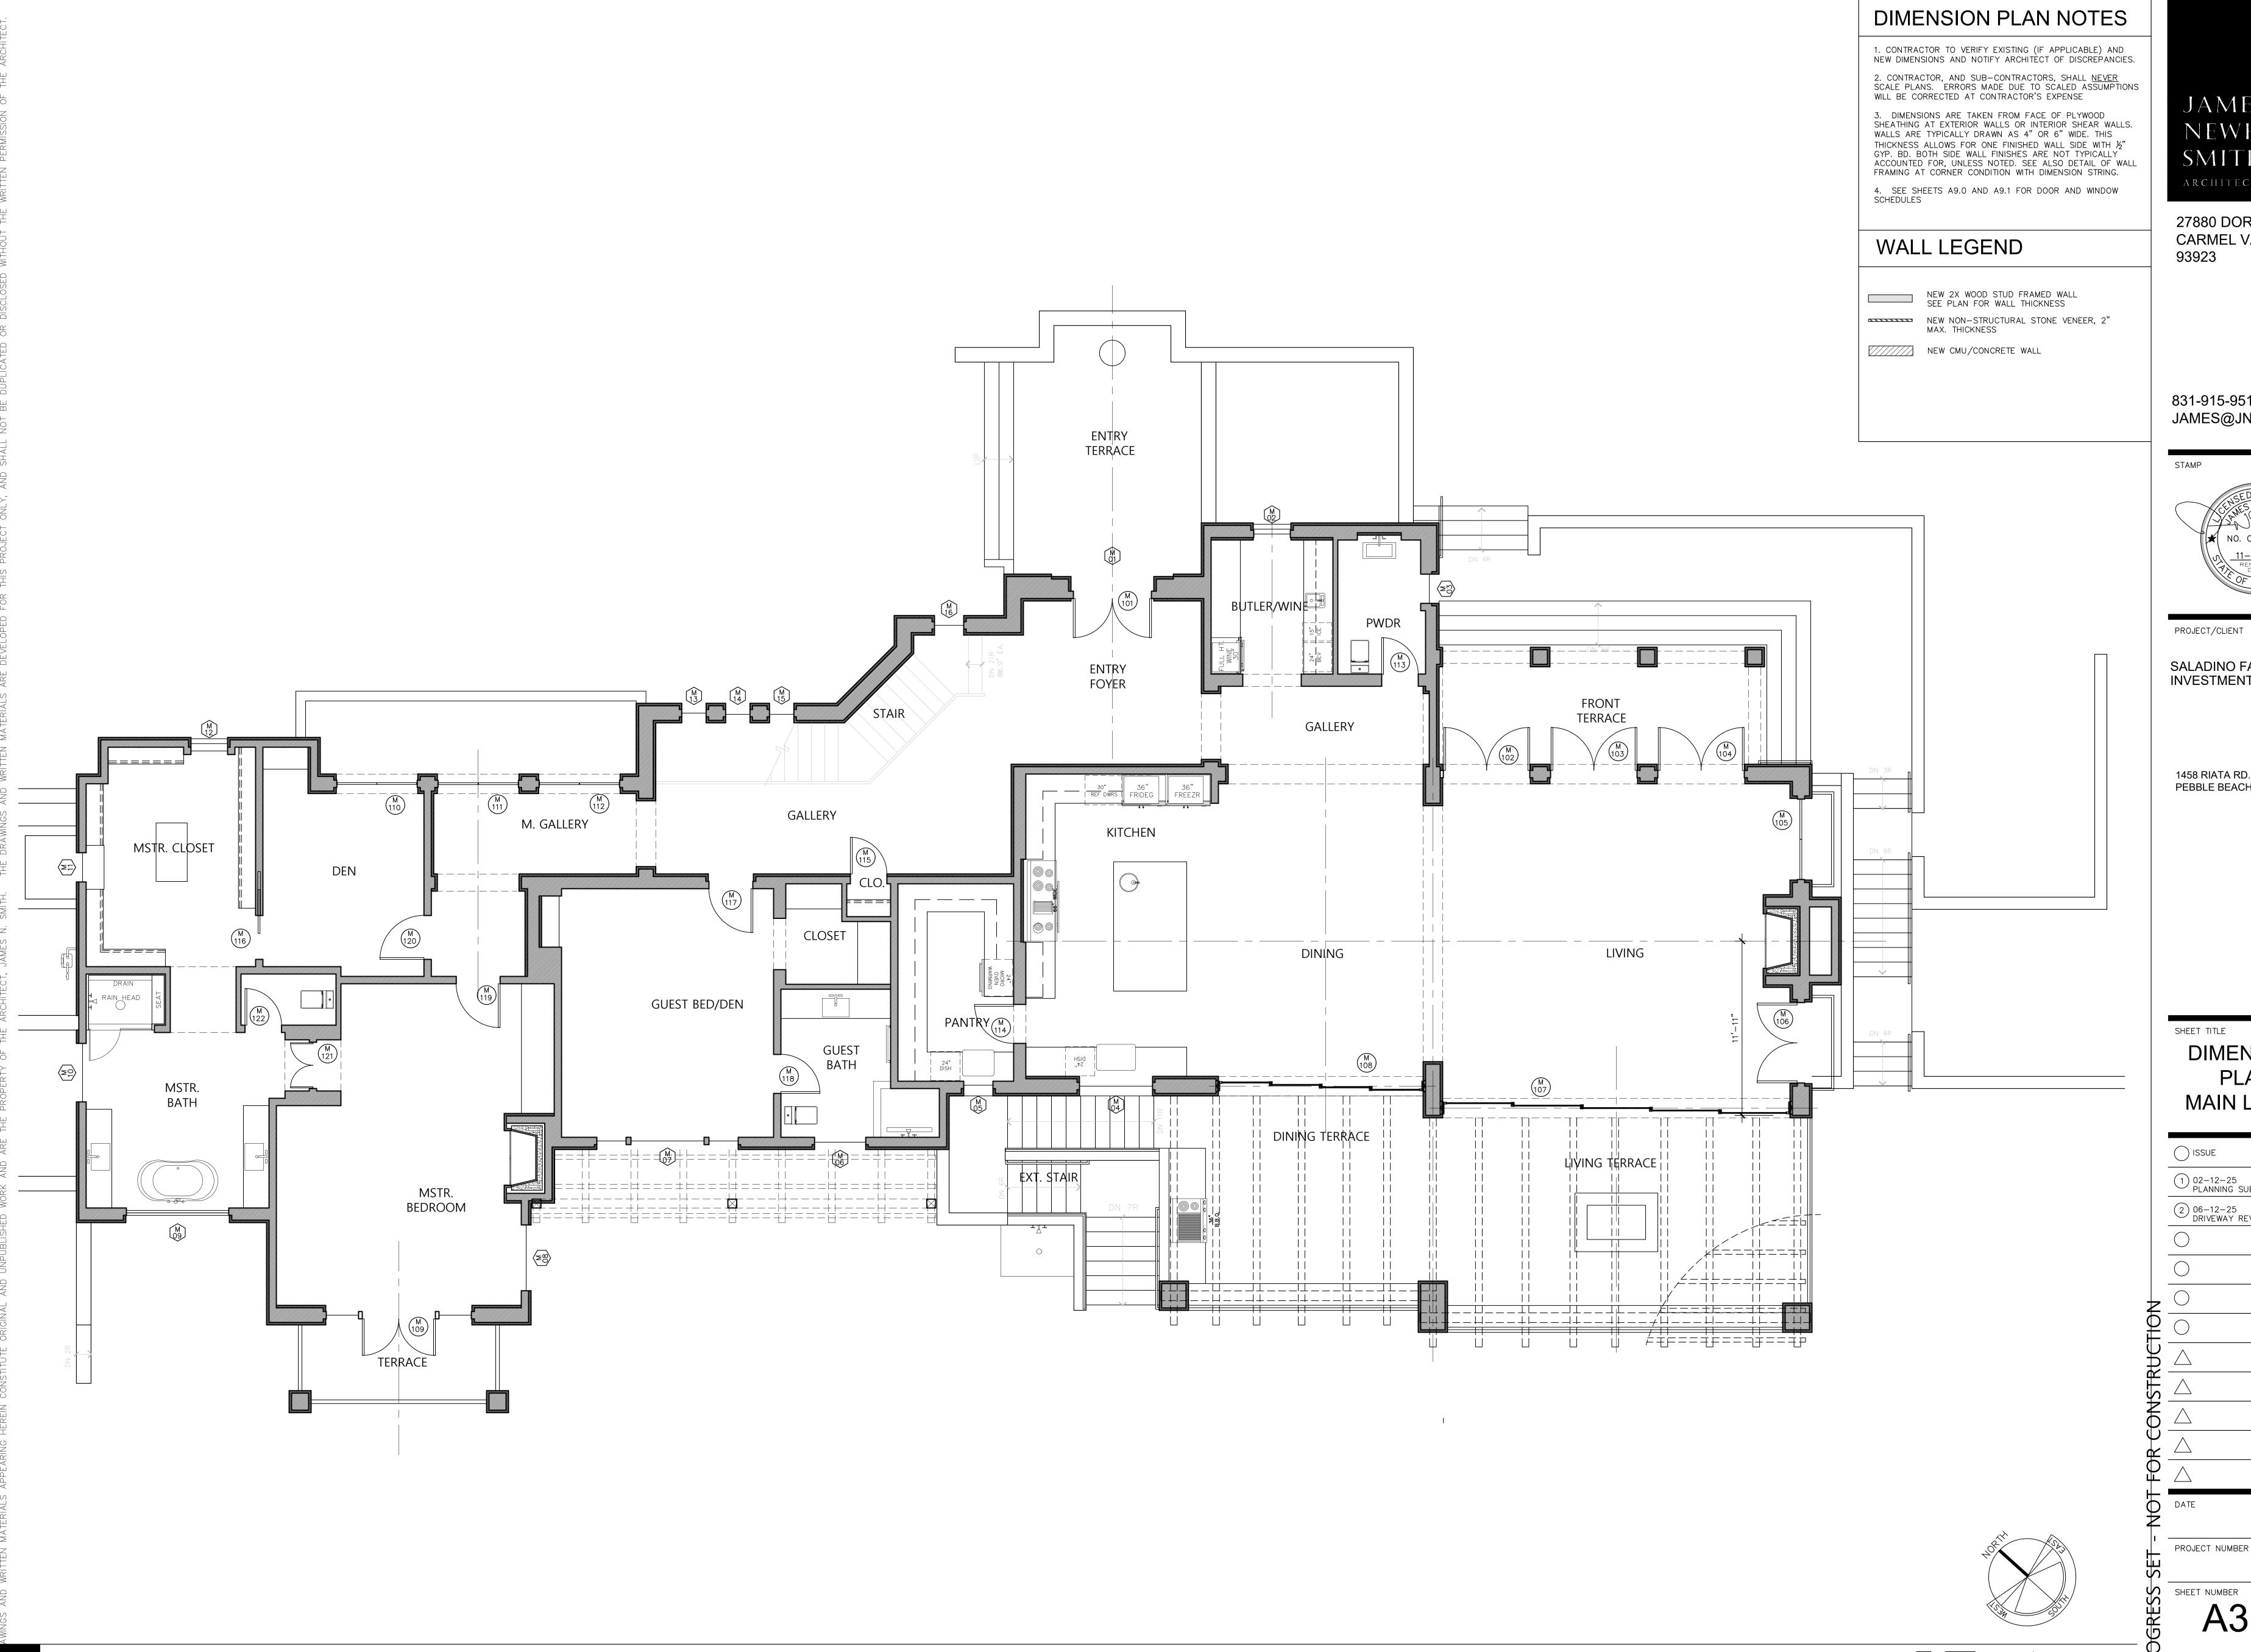
PROJECT NUMBER

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UNDERGROUND SERVICE ALERT OF NORTHERN CALIFORNIA





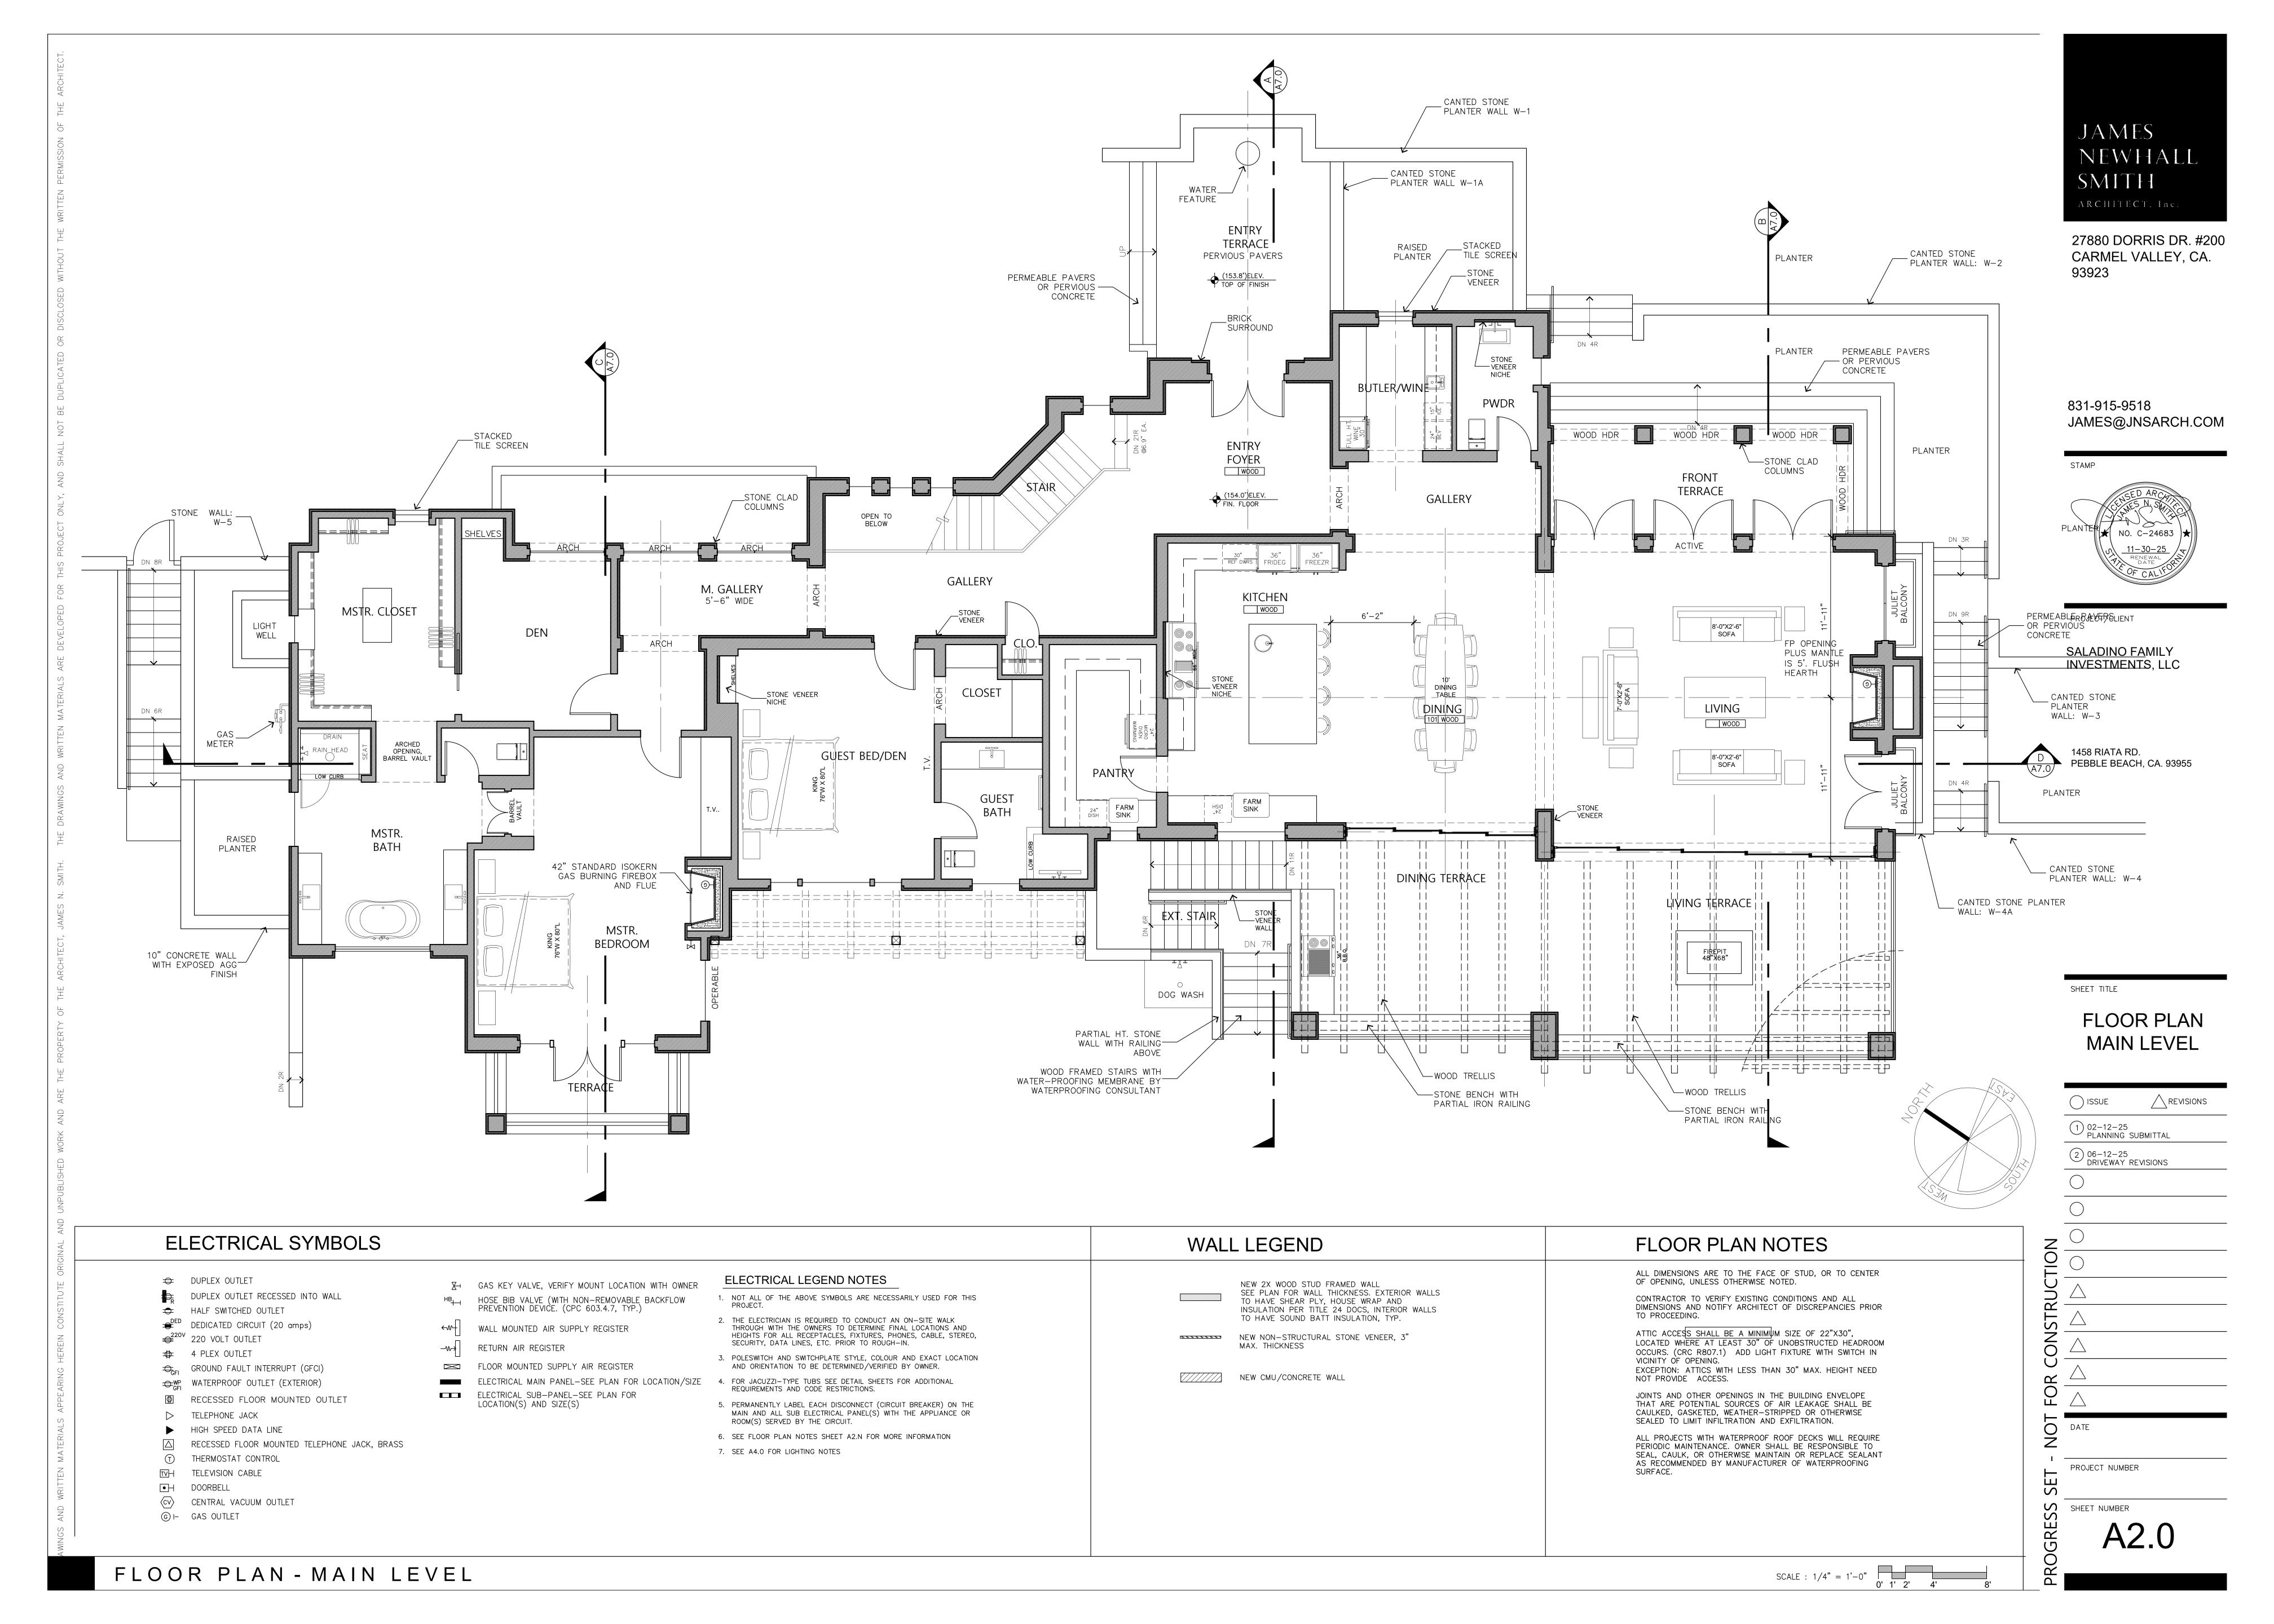

JAMES NEWHALL ARCHITECT, Inc.

> 27880 DORRIS DR. #200 CARMEL VALLEY, CA. 93923

831-915-9518 JAMES@JNSARCH.COM

PROJECT/CLIENT

SALADINO FAMILY INVESTMENTS, LLC


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SHEET TITLE DIMENSION


PLAN MAIN LEVEL

1) 02-12-25 PLANNING SUBMITTAL 2 06-12-25 DRIVEWAY REVISIONS

A3.0

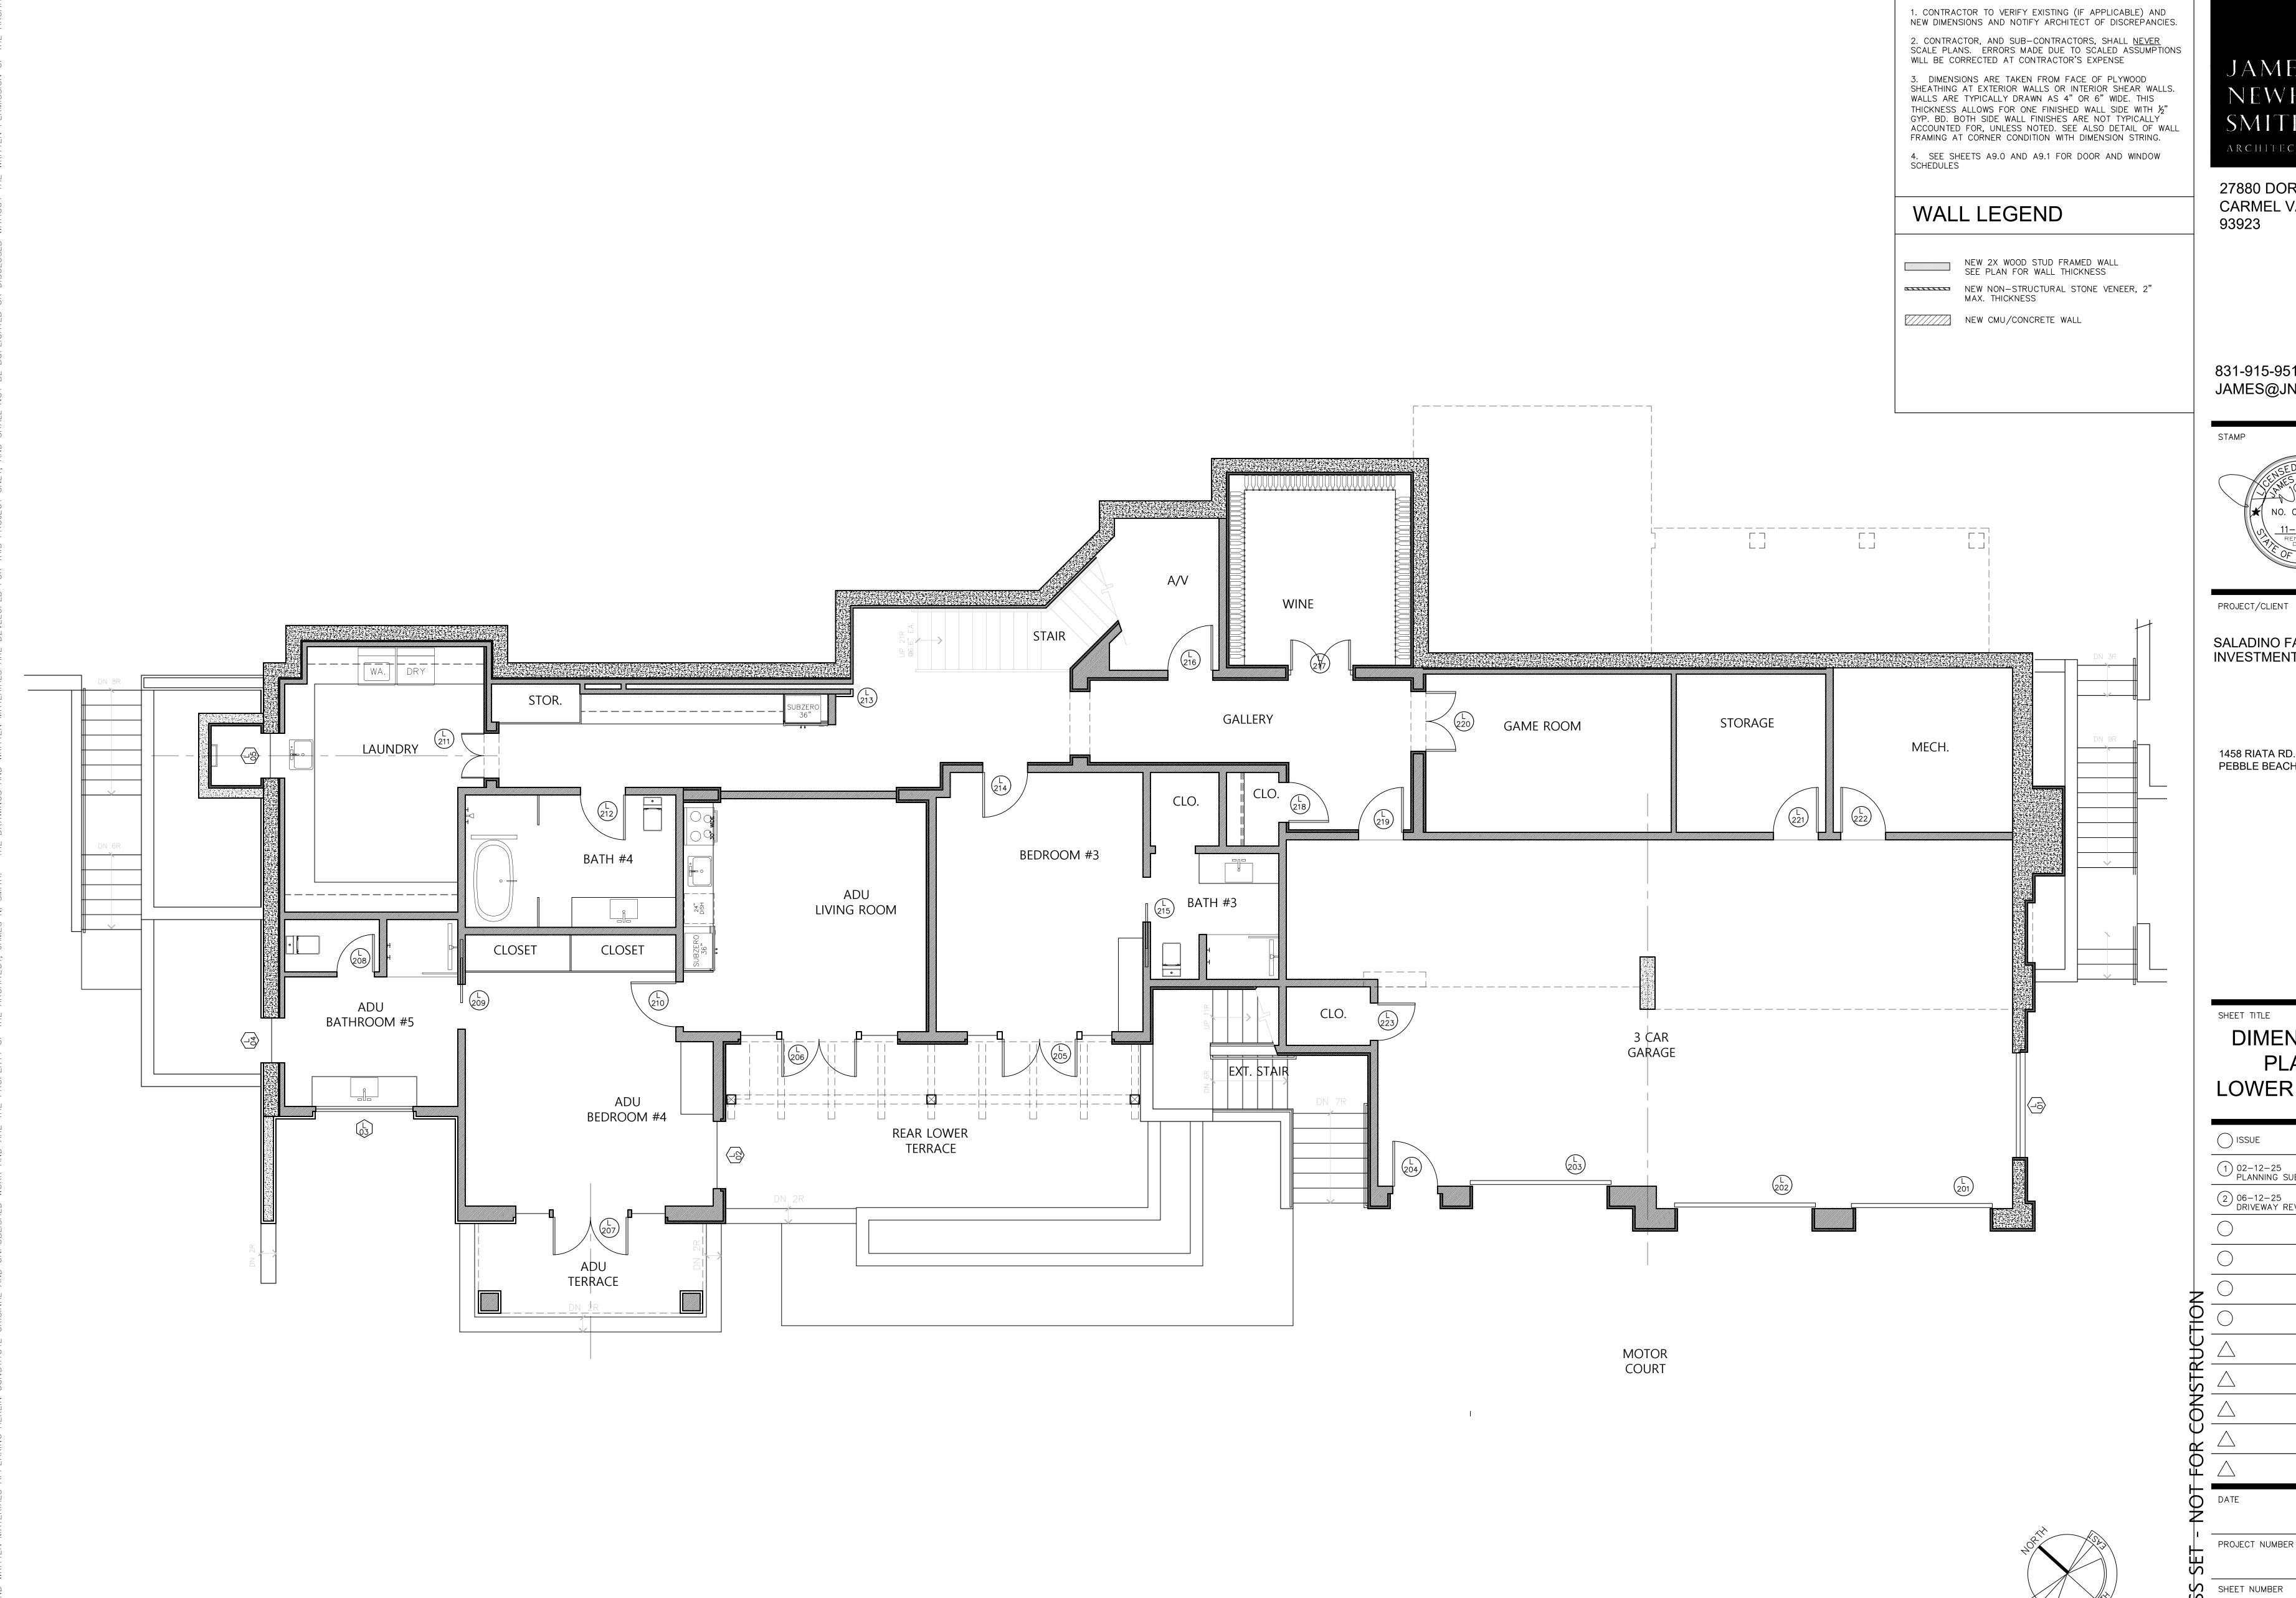

#### DIMENSION PLAN NOTES

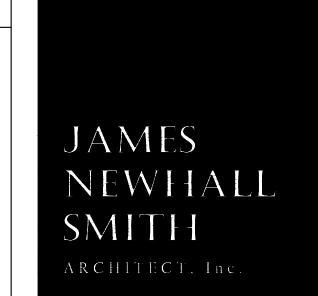

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SHEET TITLE DIMENSION

PLAN LOWER LEVEL

ISSUE A REVISIONS 1) 02-12-25 PLANNING SUBMITTAL

2 06-12-25 DRIVEWAY REVISIONS

SCALE: 1/4" = 1'-0" 0' 1' 2' 4' 8'

A3.1



#### REFLECTED CEILING NOTES

1. LIGHT LOCATIONS AS SHOWN, AND ASSOCIATED SWITCHING, SHALL BE REVIEWED, IN DETAIL, BY THE OWNER(S) IN THE FIELD, PRIOR TO FULL INSTALLATION.

2. VERIFY BEAMS SIZES, FINISHES AND EXACT LOCATIONS/SPACING IN THE 3. COORDINATE WITH FIRE SPRINKLER SUB-CONTRACTOR RE SPACING AND DEPTH OF BEAMS AND HOW THAT AFFECTS/DETERMINES SPRINKLER HEAD LOCATIONS. VERIFY BEAM DESIGN(S) WITH OWNERS BASED ON THIS REVIEW

4. LED FIXTURES RECOMMENDED TO BE 2,700 KELVIN COLOR TEMPERATURE TO MIMIC NATURAL LIGHT. 5. PLASTIC TRIM-OUT RINGS OR ASSEMBLIES ARE STRONGLY DISCOURAGED DUE TO YELLOWING AND BRITTLENESS OVER TIME

## LIGHTING LEGEND

- \$ SINGLE POLE SWITCH
- $\$_3$  THREE WAY SWITCH
- \$<sub>D</sub> DIMMER SWITCH
- 4" LED RECESSED IC RATED LIGHTING FIXTURE BY HALO, OR EQUAL. OWNER TO SELECT TRIM RING, BULB MOUNT, COLOUR AND DIRECTIONAL OPTIONS. SEE ALSO NOTE #4 BELOW.
- O 2" LED RECESSED IC RATED LIGHTING FIXTURE BY HALO, OR EQUAL. OWNER TO SELECT TRIM RING, BULB MOUNT, COLOUR AND DIRECTIONAL OPTIONS. SEE ALSO NOTE #4 BELOW.
- ←● GIMBAL MOUNTED 4" LED RECESSED IC RATED LIGHTING FIXTURE BY HALO, OR EQUAL. OWNER TO SELECT TRIM RING, BULB MOUNT, COLOUR AND DIRECTIONAL OPTIONS. SEE ALSO NOTE #4 BELOW.
- SURFACE MOUNTED LED FIXTURE - PENDANT FIXTURE
- H WALL MOUNTED FIXTURE
- FLOOD / SECURITY LIGHTING. MA=MOTION SENSOR. OWNER TO DETERMINE SWITCHING OF LIGHTING
- RECESSED EXHAUST FAN WITH QUIET MOTOR TECHNOLOGY BY PANASONIC, OR EQUAL. SEE NOTES BELOW
- COMBINATION FLUORESCENT LIGHT & EXHAUST FAN FIXTURE
- COMBINATION GARAGE OPENER & LIGHT WITH ADJACENT DUPLEX OUTLET AND DATA CONNECTION, AS REQUIRED
- CEILING FAN
- SMOKE DETECTOR: SHALL BE 110V. HARDWIRED W/ BATTERY BACK-UP (C.R.C SEC. 314), AND INTERCONNECTED WITH ALL OTHER SMOKE ALARMS PER R 314.5 (SEE ALSO NOTES BELOW)
- ⊙<sup>CMA</sup> CARBON MONOXIDE ALARM
- DA = DOOR ACTIVATED LIGHT FIXTURE
- MA = MOTION ACTIVATED LIGHT FIXTURE
- WP = WATER PROOF FIXTURE. UL LISTED AS SUITABLE FOR
- FL = FLUORESCENT FIXTURE (MIN 40 LUMENS PER WATT)
- LV = LOW-VOLTAGE LIGHTING DED = DEDICATED CIRCUIT
- 4' LED SURFACE MOUNTED FIXTURE W/ ACRYLIC DIFFUSER, BY HALO, OR EQUAL
- TRACK LIGHTING
- LED STRIP LIGHT FOR UNDER CABINET LIGHTING VERIFY W/ OWNER IF INDIVIDUALLY SWITCHED OR GANGED TOGETHER AT POLE SWITCH(ES)

LIGHTING LEGEND NOTES

NOT ALL OF THE ABOVE SYMBOLS ARE NECESSARILY USED FOR THIS THE ELECTRICIAN IS REQUIRED TO CONDUCT AN ON-SITE WALK THROUGH WITH THE OWNERS TO DETERMINE FINAL LOCATIONS AND HEIGHTS FOR

RECEPTACLES, FIXTURES, PHONES, CABLE, STEREO, SECURITY, DATA LINES, ALL HABITABLE SPACES SHALL BE HIGH EFFICACY LIGHTING, MANUAL—ON OCCUPANT SENSOR OR DIMMER SWITCHES.

ONE LUMINAIRE IN EACH OF THESE SPACES SHALL BE CONTROLLED BY A VACANCY SENSOR. LIGHT FIXTURES WITHIN 3' HORIZONTALLY AND 8' VERTICALLY OF TUB RIM OR IN SHOWER ENCLOSURE THRESHHOLD SHALL BE UL LISTED LABELED "SUITABLE FOR WET LOCATIONS" OR "SUITABLE FOR DAMP LOCATIONS" (CEC

ARTICLE 410-4(a)) (CEC 410.10) LIGHTING FIXTURES RECESSED INTO INSULATED CEILINGS SHALL BE I.C. RATED BY U.L. OR OTHER APPROVED AGENCY. (TITLE 24 ARTICLE 150(k)4) ALL FIXTURES SHALL HAVE AIR TIGHT (AT) RATING AND HAVE JA8

BATHROOMS CONTAINING BATHTUBS, SHOWERS, SPAS, AND SIMILAR BATHING FIXTURES SHALL BE MECHANICALLY VENTILATED IN ACCORDANCE WITH THE

EXTERIOR LIGHTING: HIGH EFFICACY OR MOTION SENSOR/PHOTO SENSOR. SMOKE DETECTORS PER CRC R314.3 , SHALL BE LOCATED:

ON THE CEILING OR WALL OUTSIDE OF EACH SEPARATE SLEEPING AREA IN THE IMMEDIATE VICINITY OF BEDROOMS. IN EACH ROOM USED FOR SLEEPING PURPOSES.

IN EACH ADDITIONAL STORY WITHIN A DWELLING UNIT, INCLUDING BASEMENTS BUT NOT INCLUDING CRAWL SPACES AND UNINHABITABLE ATTICS. IN DWELLINGS OR DWELLING UNITS WITH SPLIT LEVELS AND WITHOUT AN INTERVENING DOOR BETWEEN THE ADJACENT LOWER LEVEL, A SMOKE ALARM INSTALLED ON THE UPPER LEVEL SHALL SUFFICE FOR THE ADJACENT LOWER LEVEL PROVIDED THAT THE LOWER LEVEL IS LESS THAN ONE FULL STORY BELOW THE UPPER LEVEL. IN ENCLOSED COMMON STAIRWELLS OF APARTMENT COMPLEXES AND OTHER MULTIPLE—DWELLING COMPLEXES.


PER NFPA 72-29.8.3.4(4) SMOKE DETECTORS REQUIRED NEAR A FIXED COOKING APPLIANCE CAN BE PHOTO-ELECTRIC, TO WITHIN 6' OF COOKING

CARBON MONOXIDE ALARMS SHALL BE INSTALLED IN AREAS LEADING INTO ROOMS USED FOR SLEEPING PURPOSES AND ON EVERY LEVEL OF THE DWELLING, INCLUDING THE BASEMENTS. CRC R315.3. EVERY BATHROOM SHALL BE MECHANICALLY VENTILATED. EXHAUST FANS IN BATHROOMS SHALL HAVE BACKDRAFT PROTECTION AND SHALL BE ENERGY STAR COMPLIANT AND CONTROLLED BY A HUMIDISTAT PER CaIGREEN 2016 AND SHALL BE SWITCHED SEPARATELY FROM LIGHTS ALL UNDER—CABINET LIGHTING SHALL BE SWITCHED SEPARATELY FROM ALL OTHER LIGHTING

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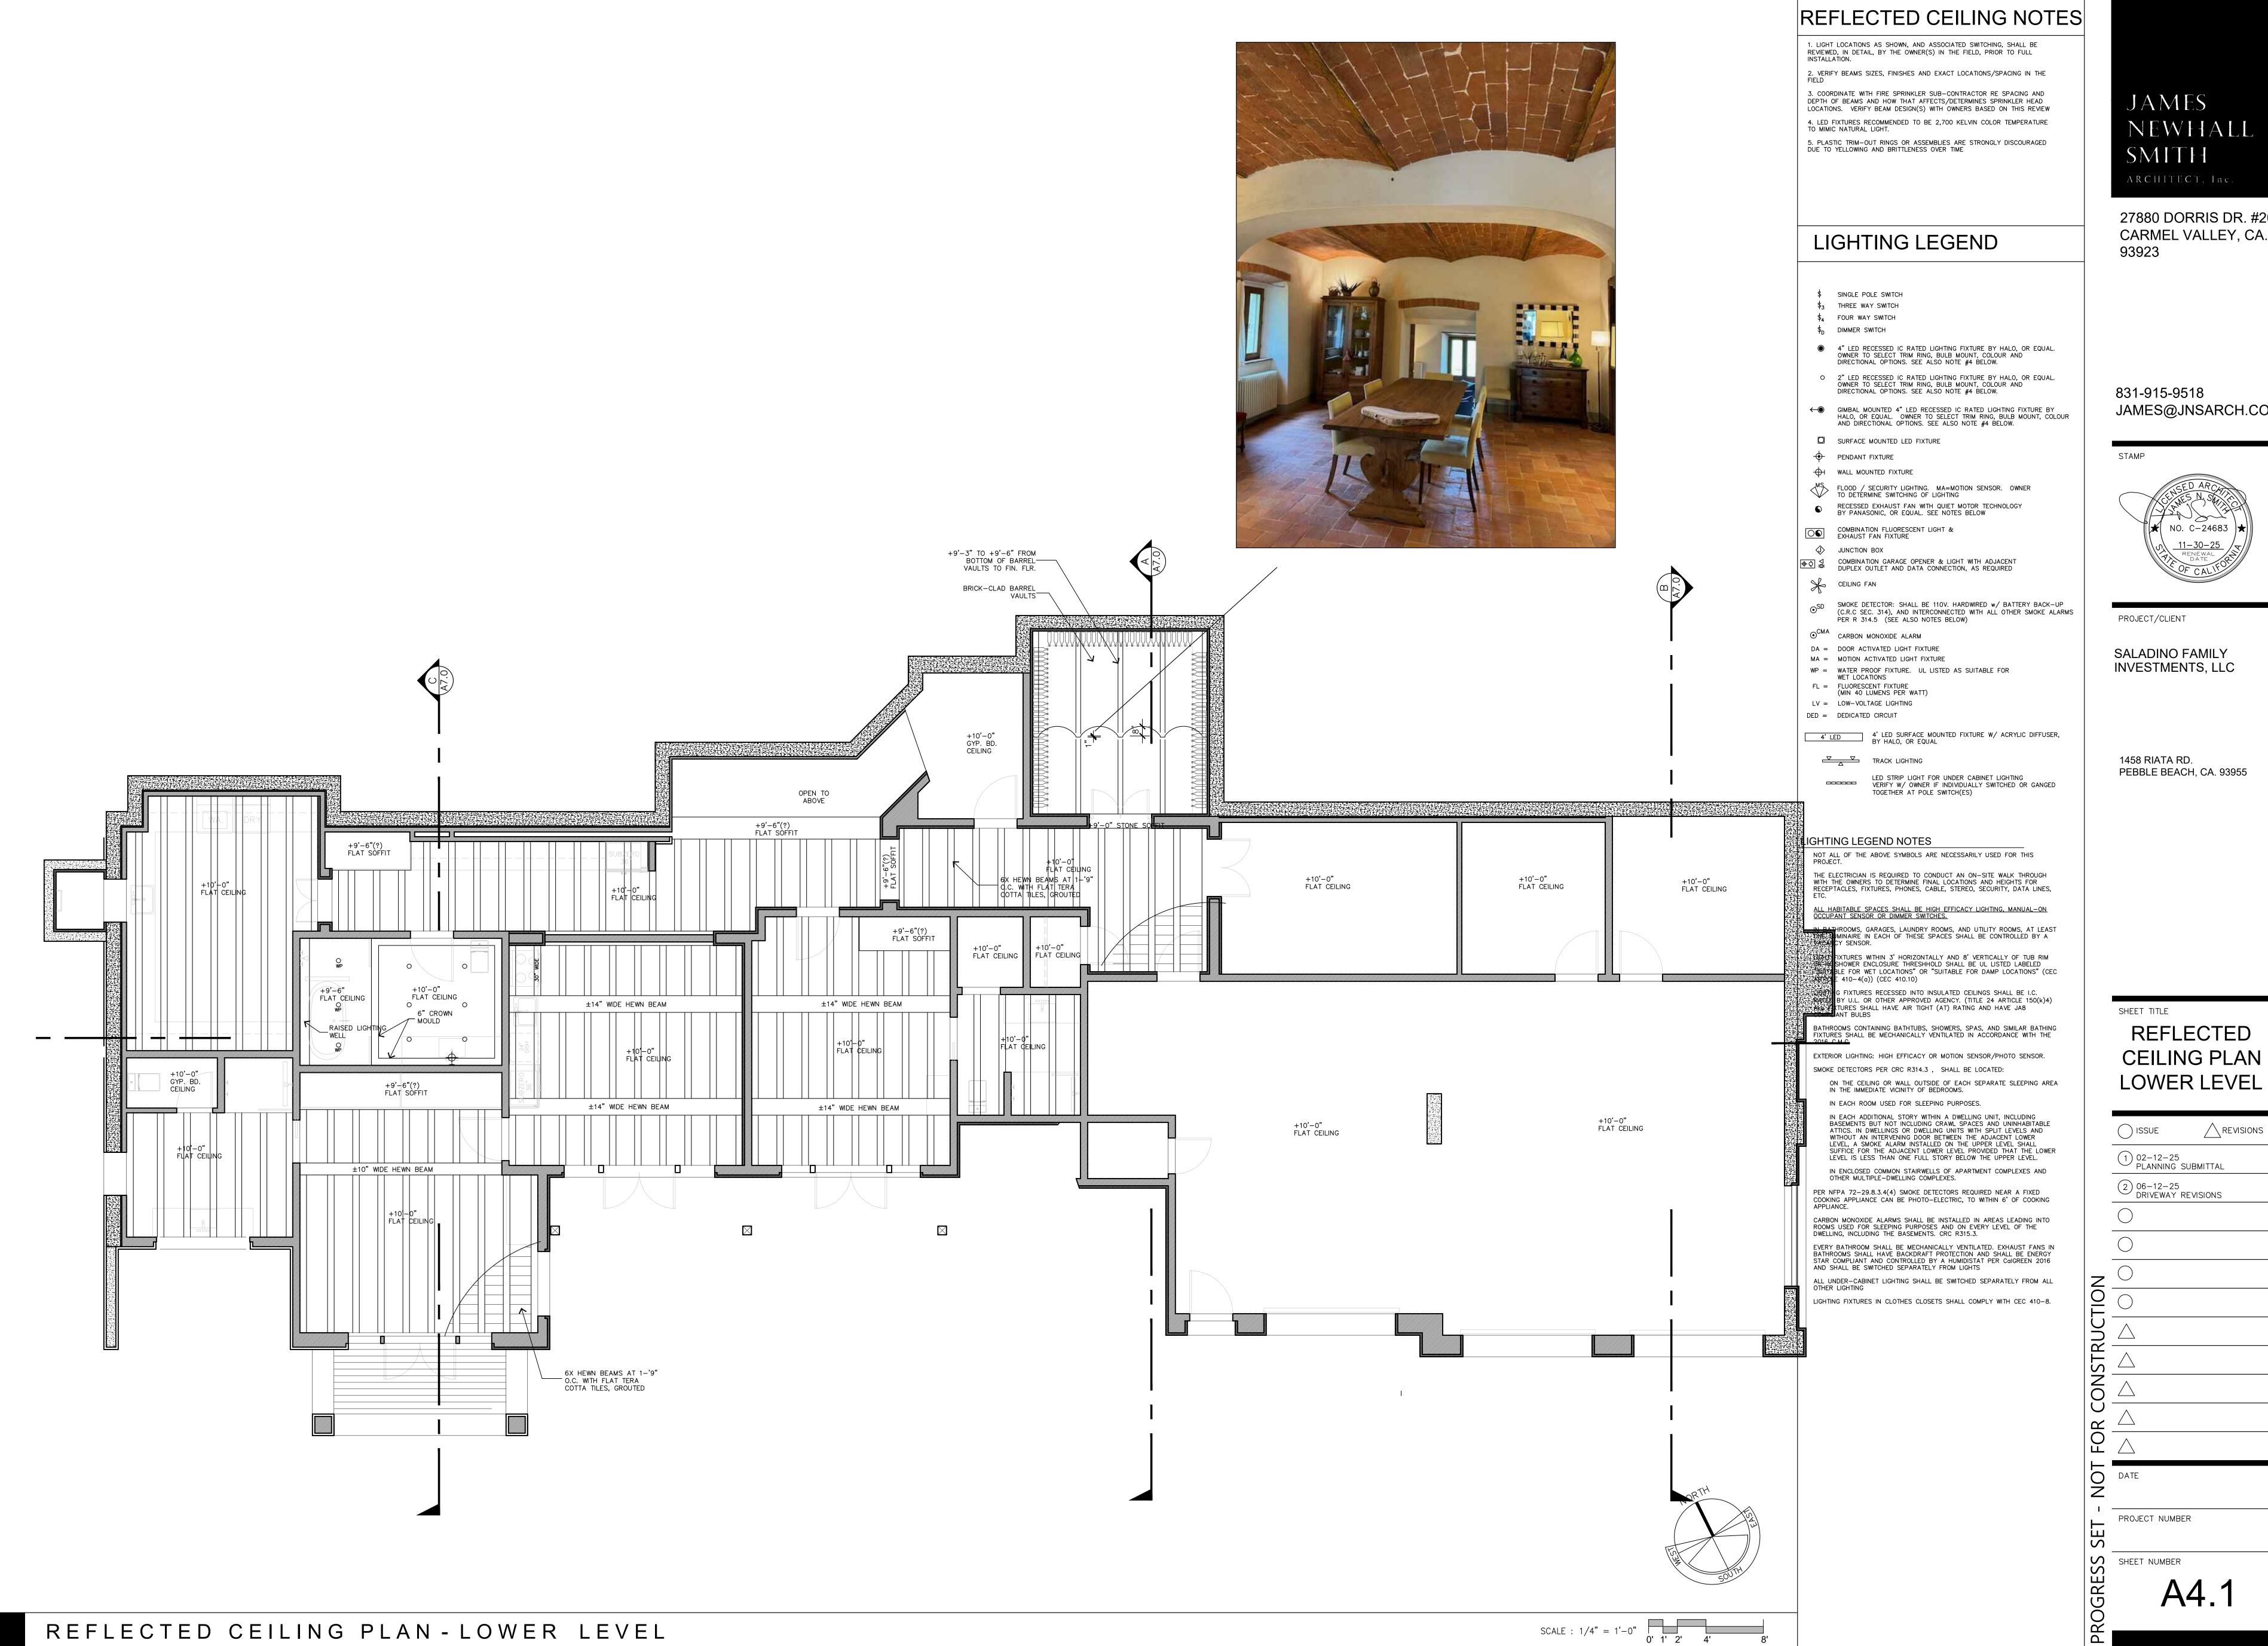
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SHEET TITLE

## REFLECTED **CEILING PLAN** MAIN LEVEL

REVISIONS ) ISSUE (1) 02-12-25 PLANNING SUBMITTAL

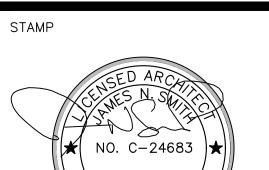2 06-12-25 DRIVEWAY REVISIONS



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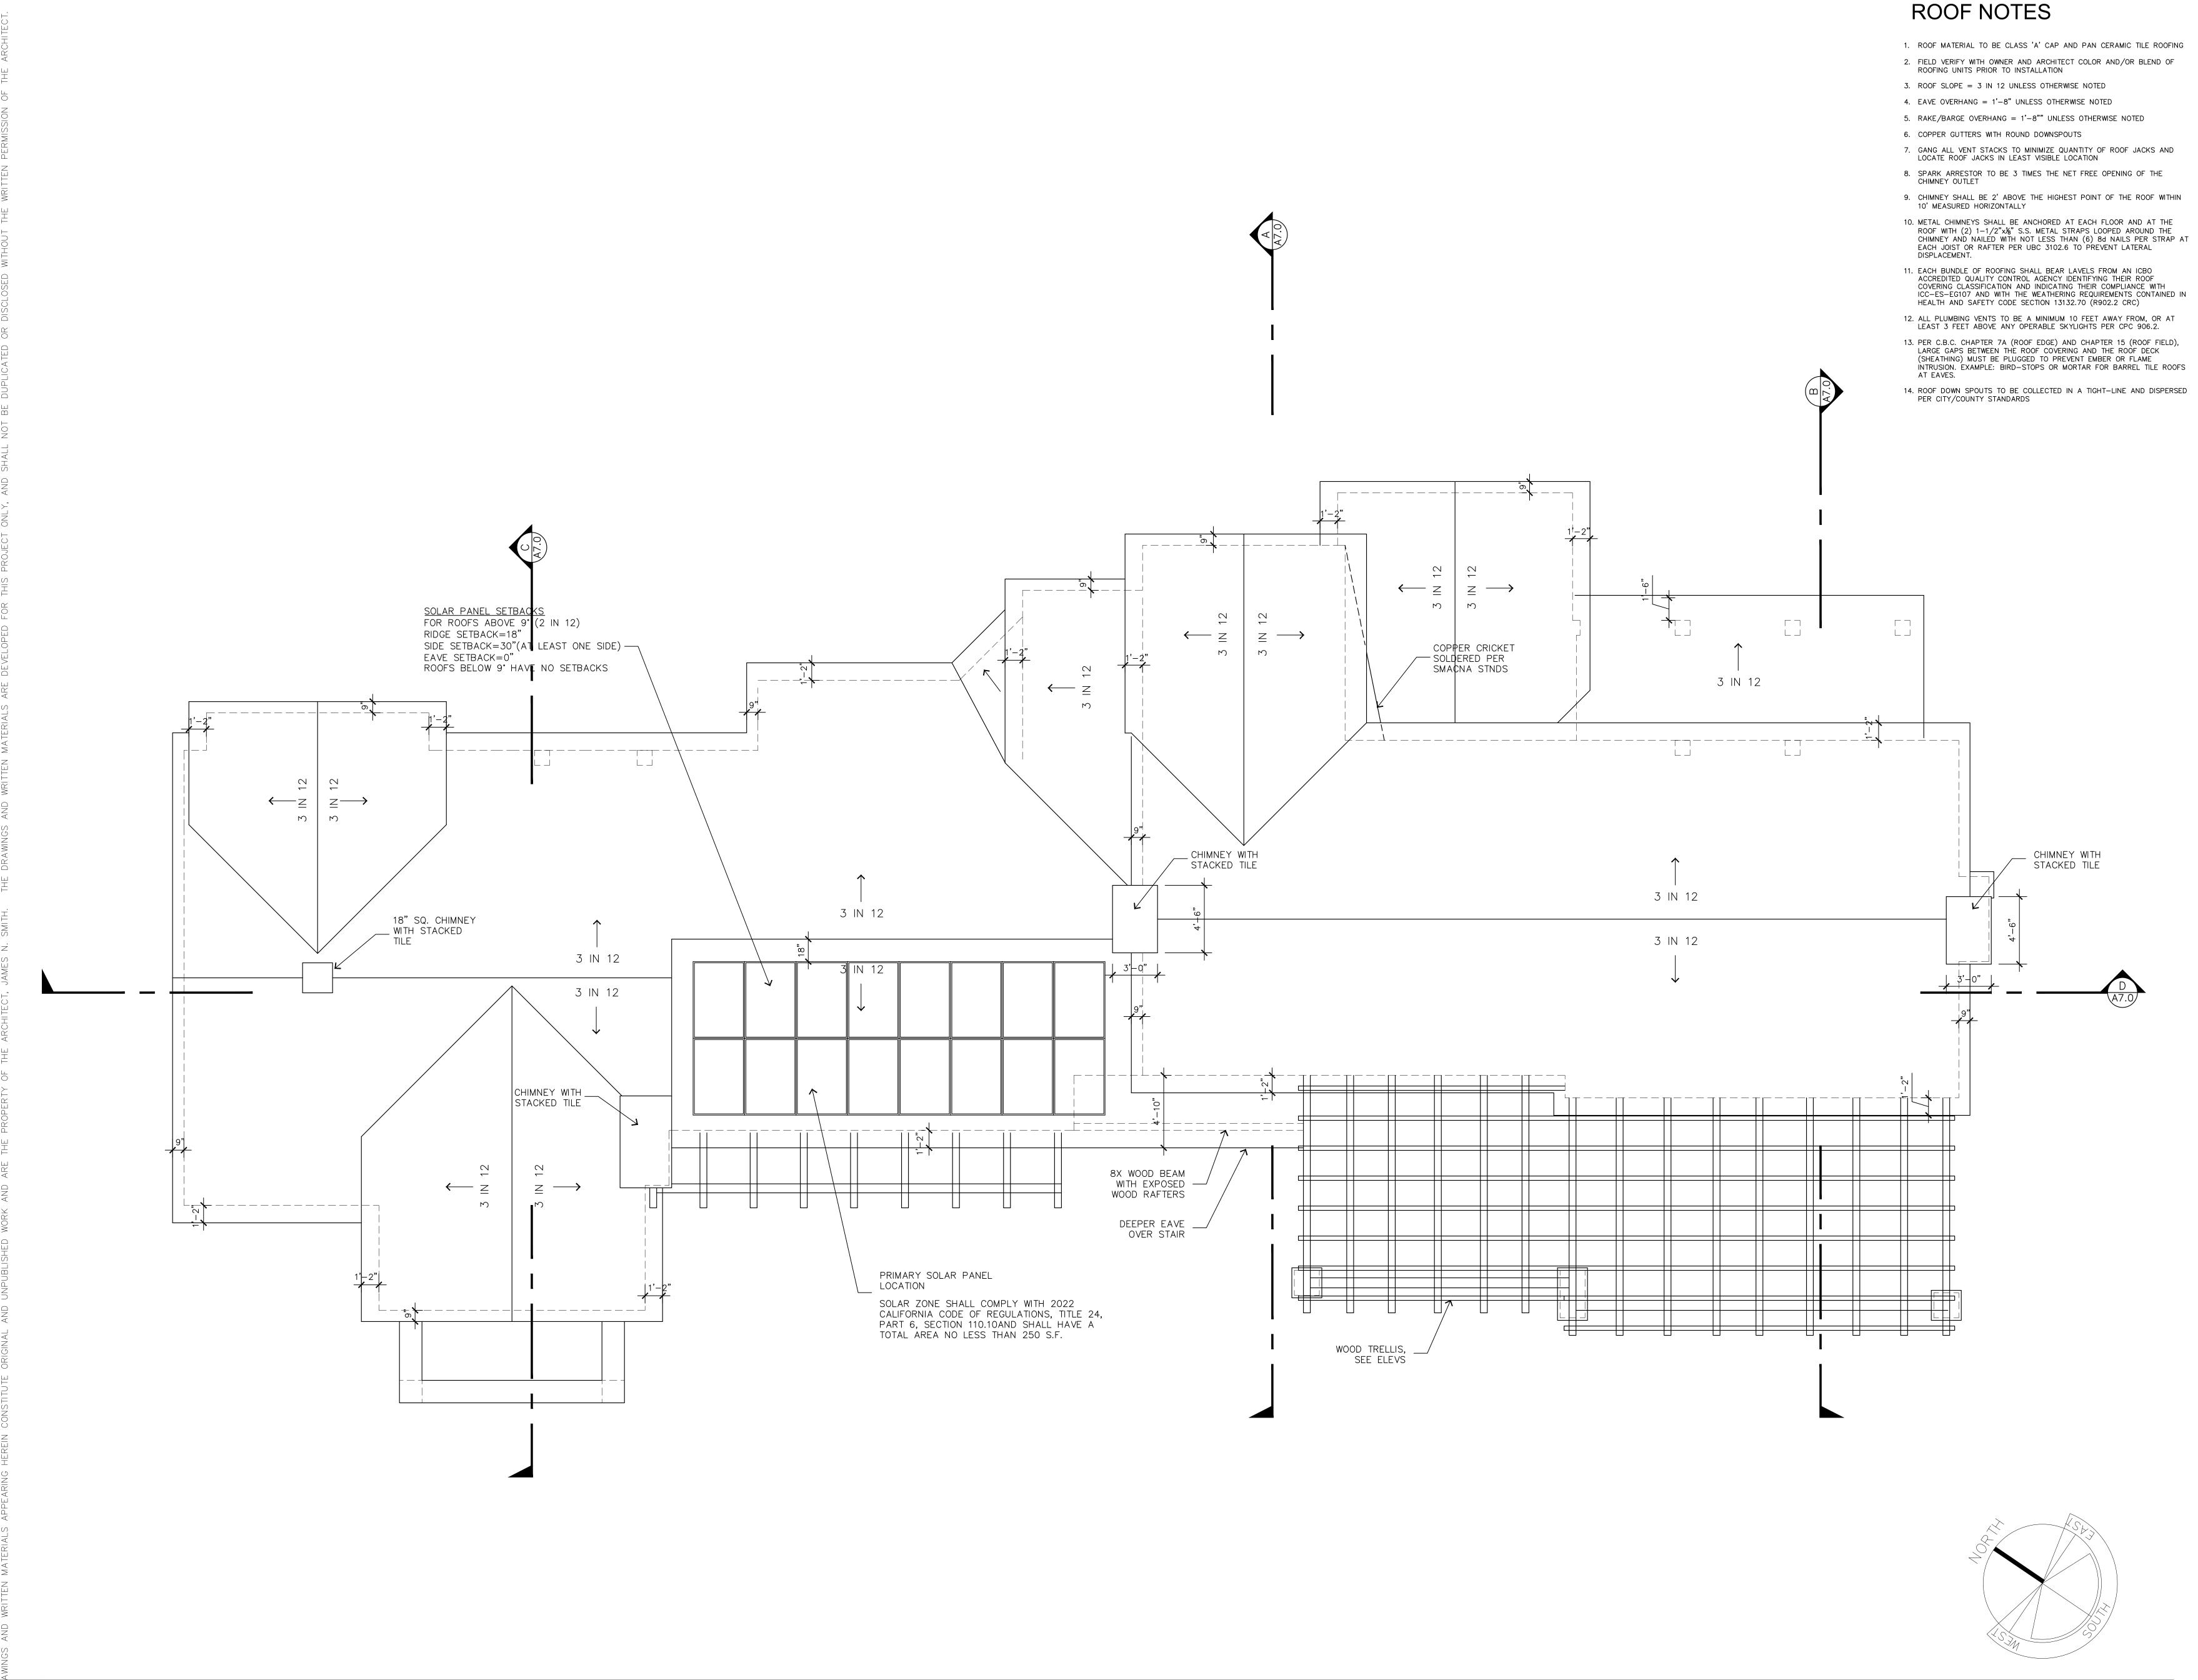
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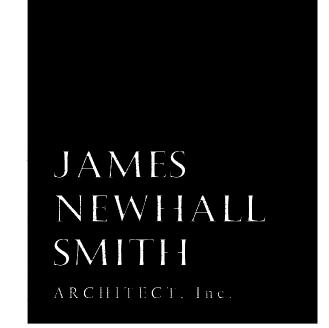
INVESTMENTS, LLC

PEBBLE BEACH, CA. 93955

### REFLECTED **CEILING PLAN** LOWER LEVEL

2 06-12-25 DRIVEWAY REVISIONS	
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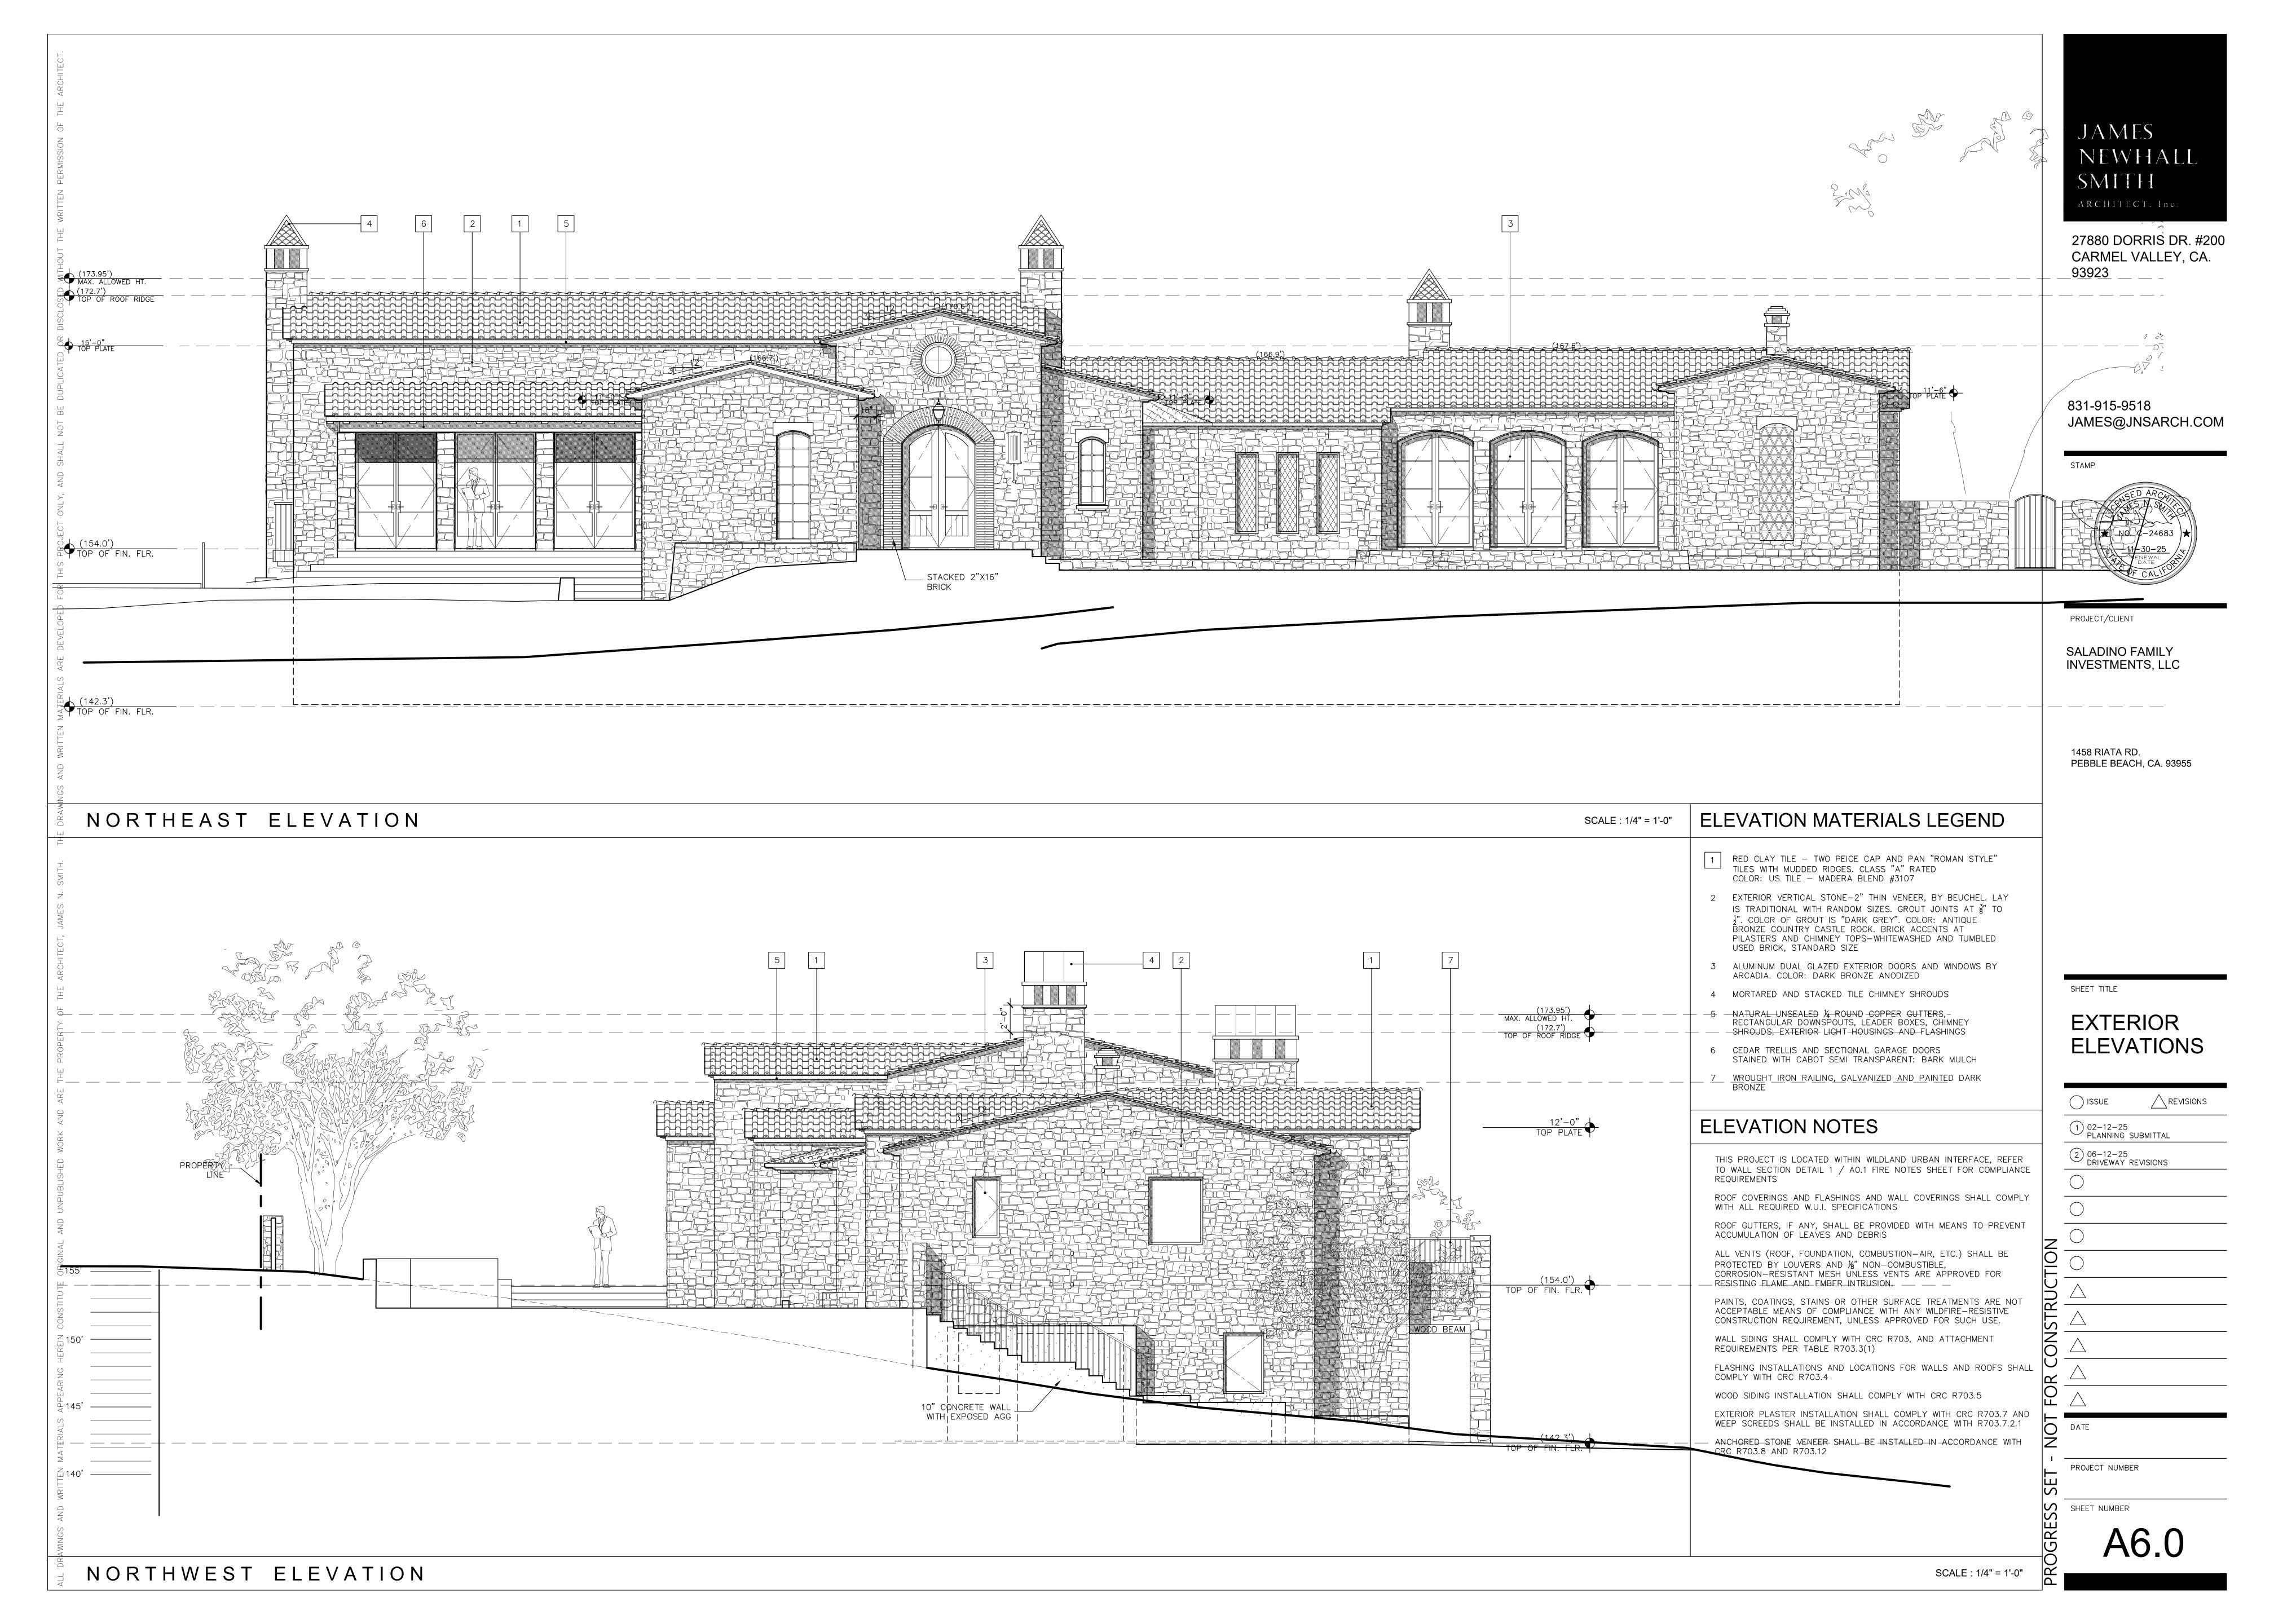
**ROOF PLAN** 


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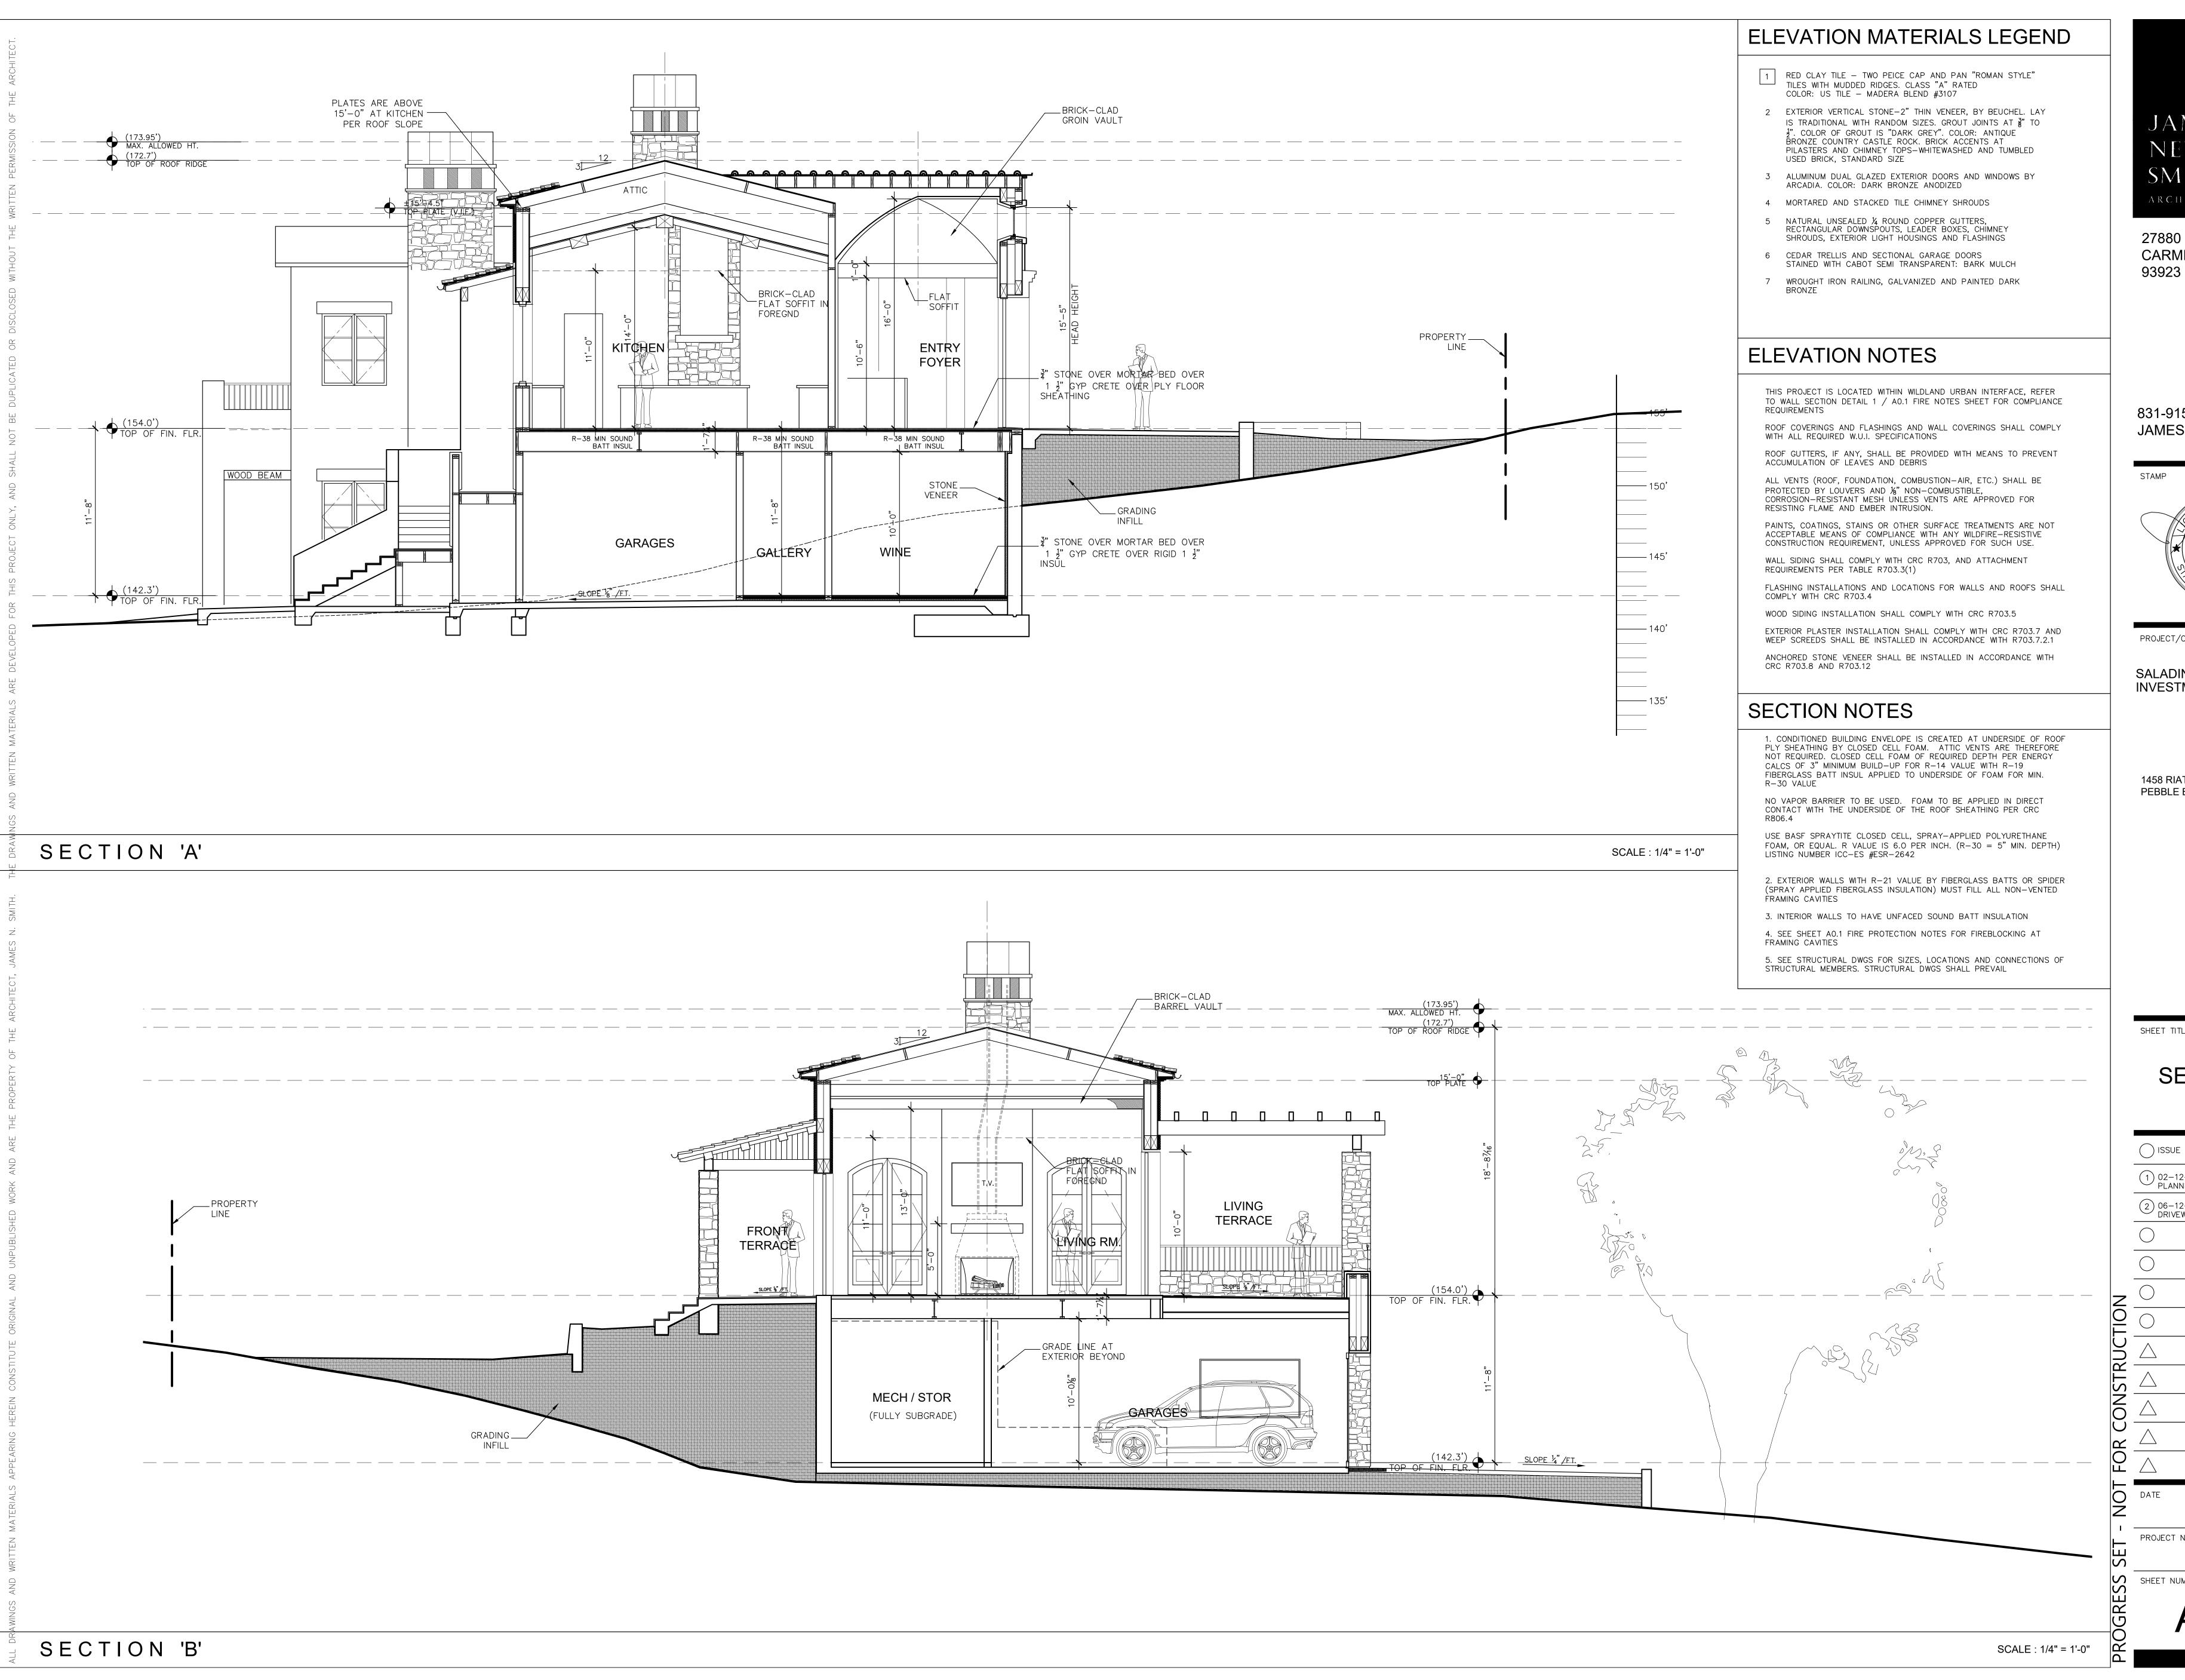
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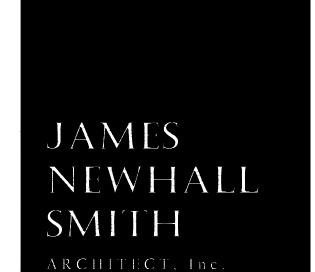
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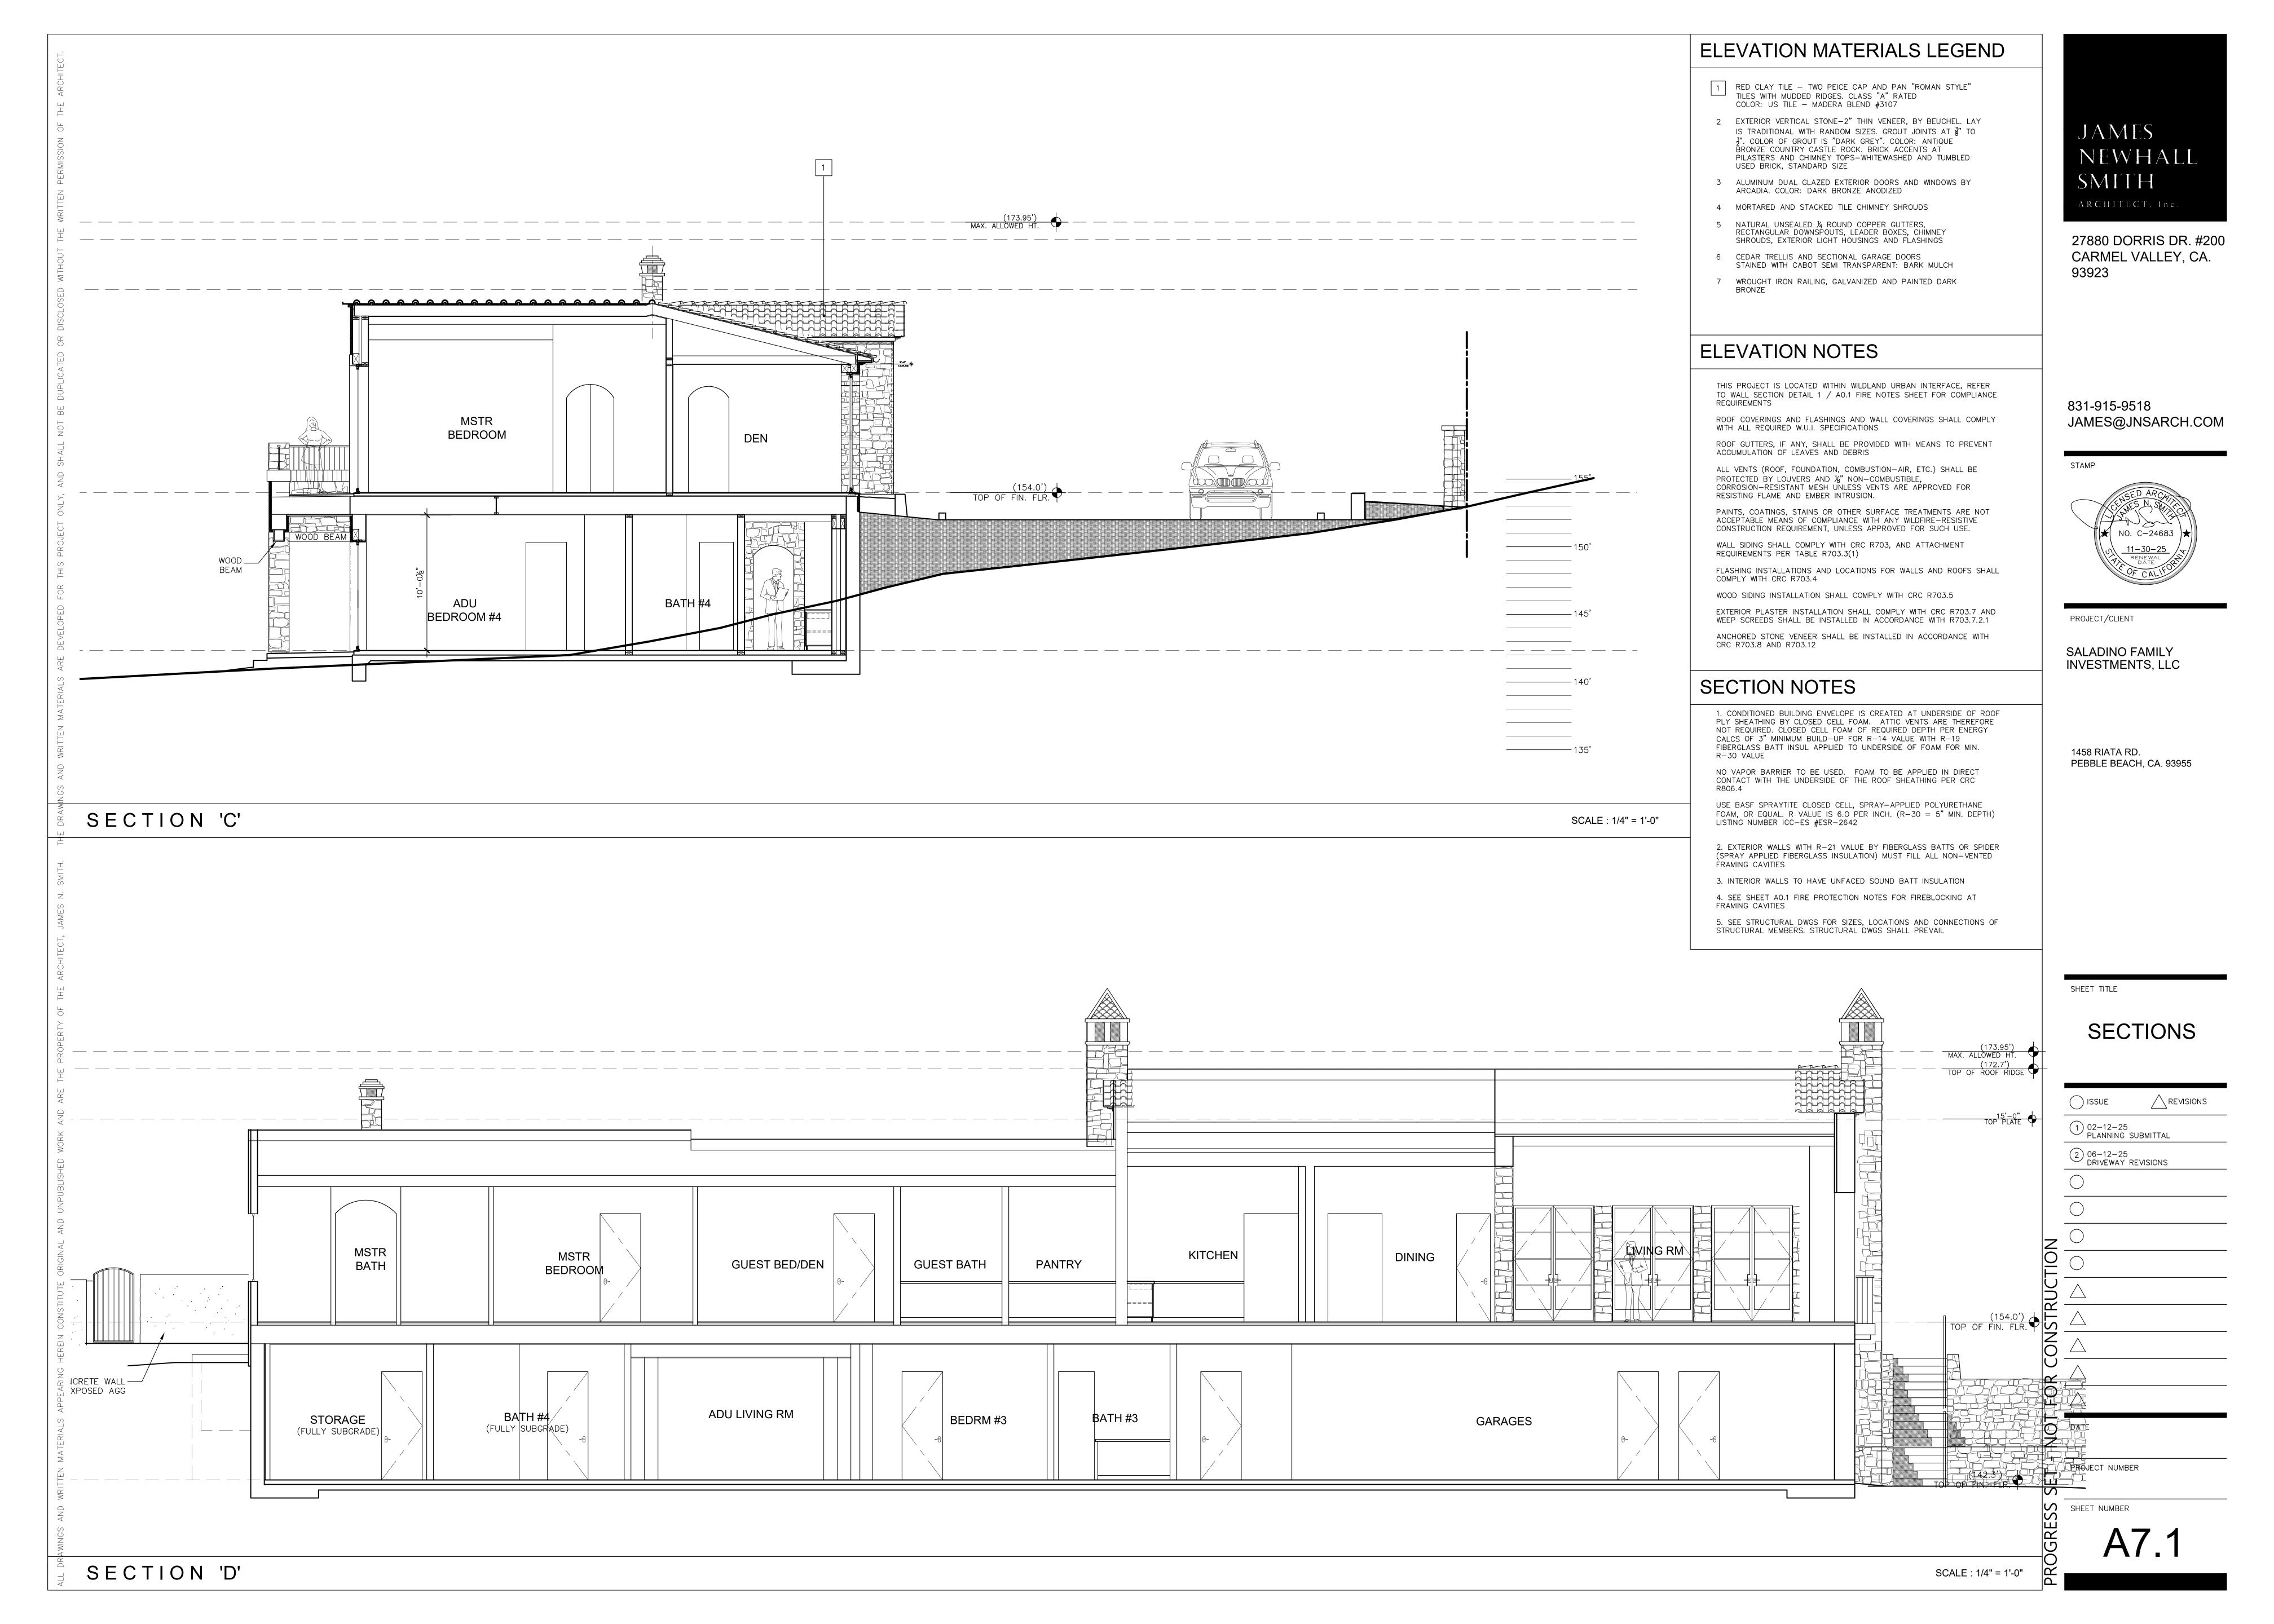
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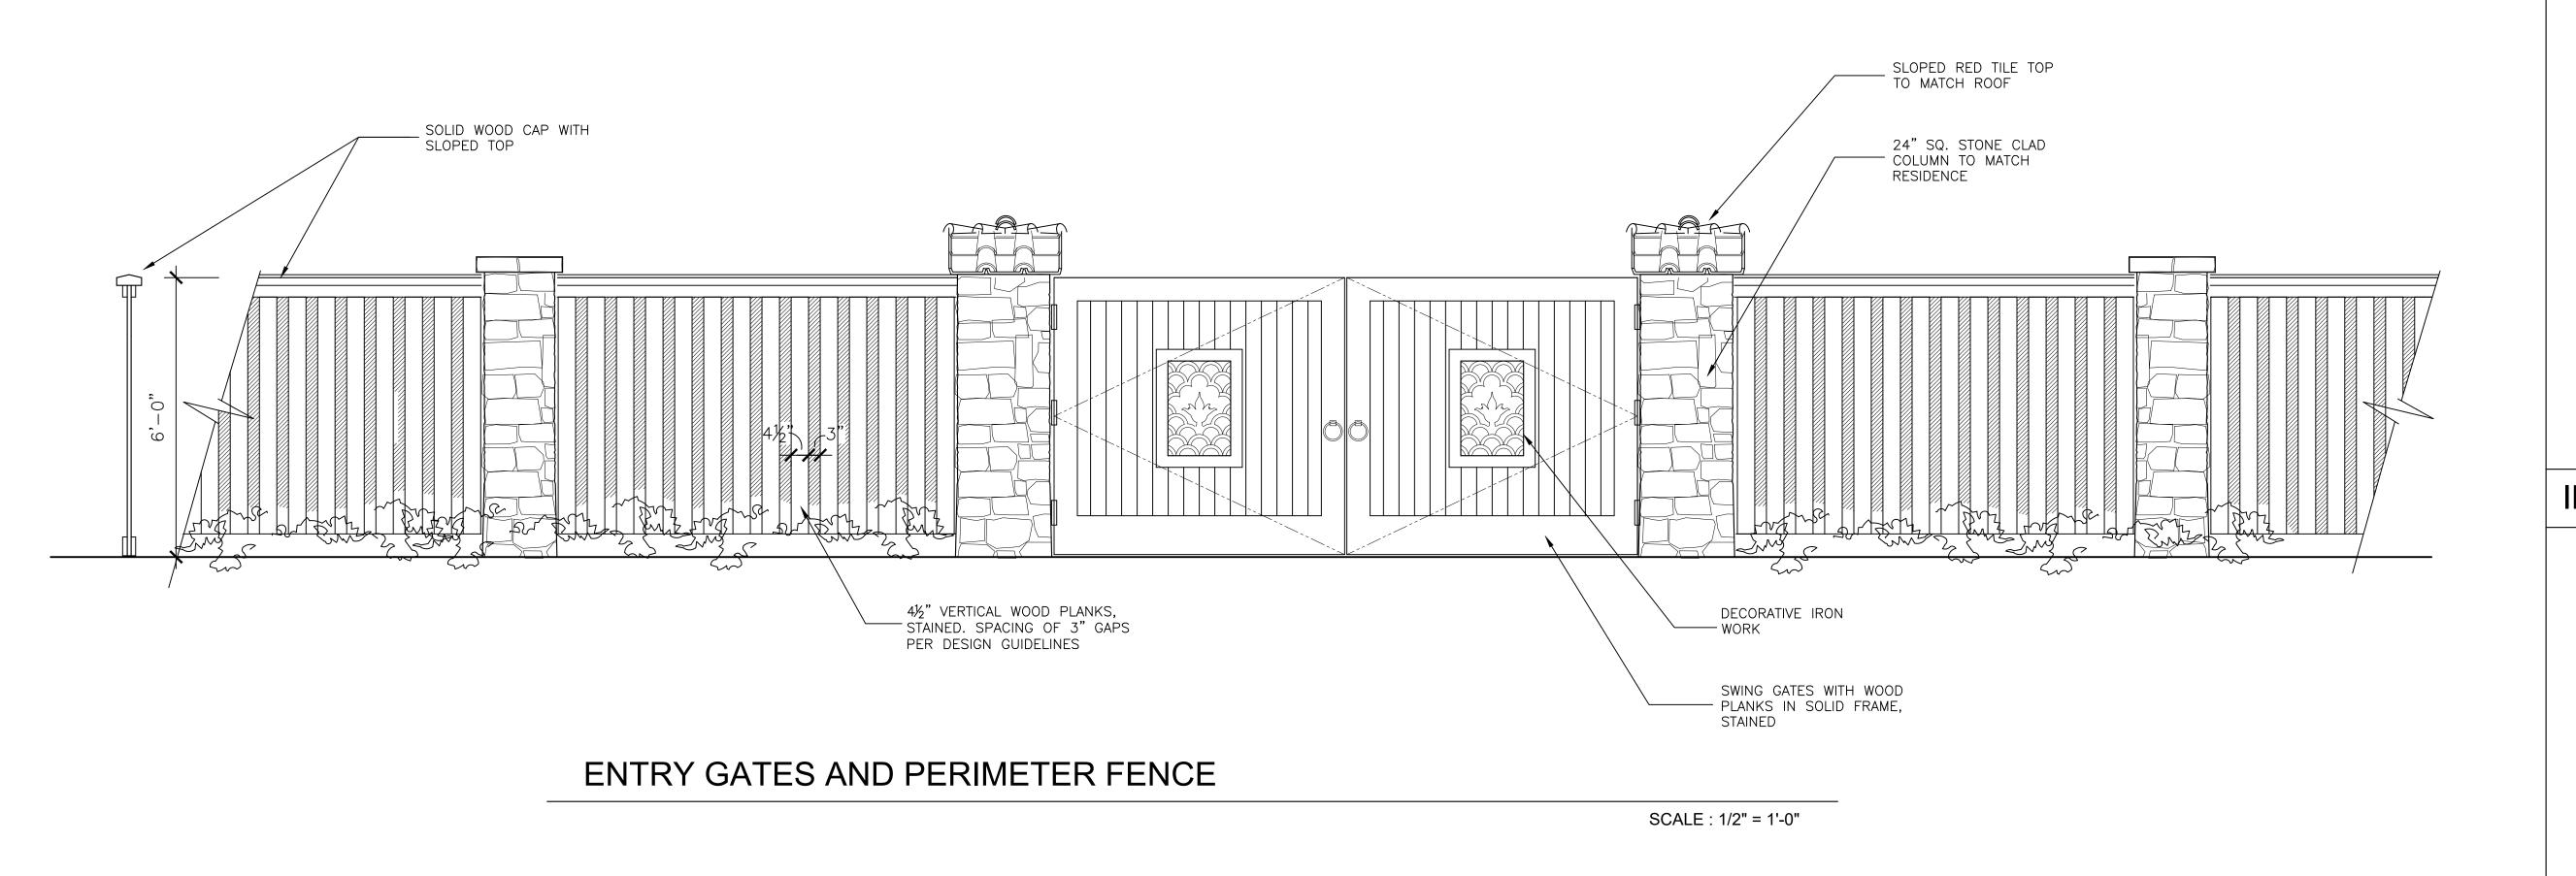
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SHEET TITLE

SECTIONS

( ) ISSUE /\ REVISIONS 1 02-12-25 PLANNING SUBMITTAL 2 06-12-25 DRIVEWAY REVISIONS PROJECT NUMBER



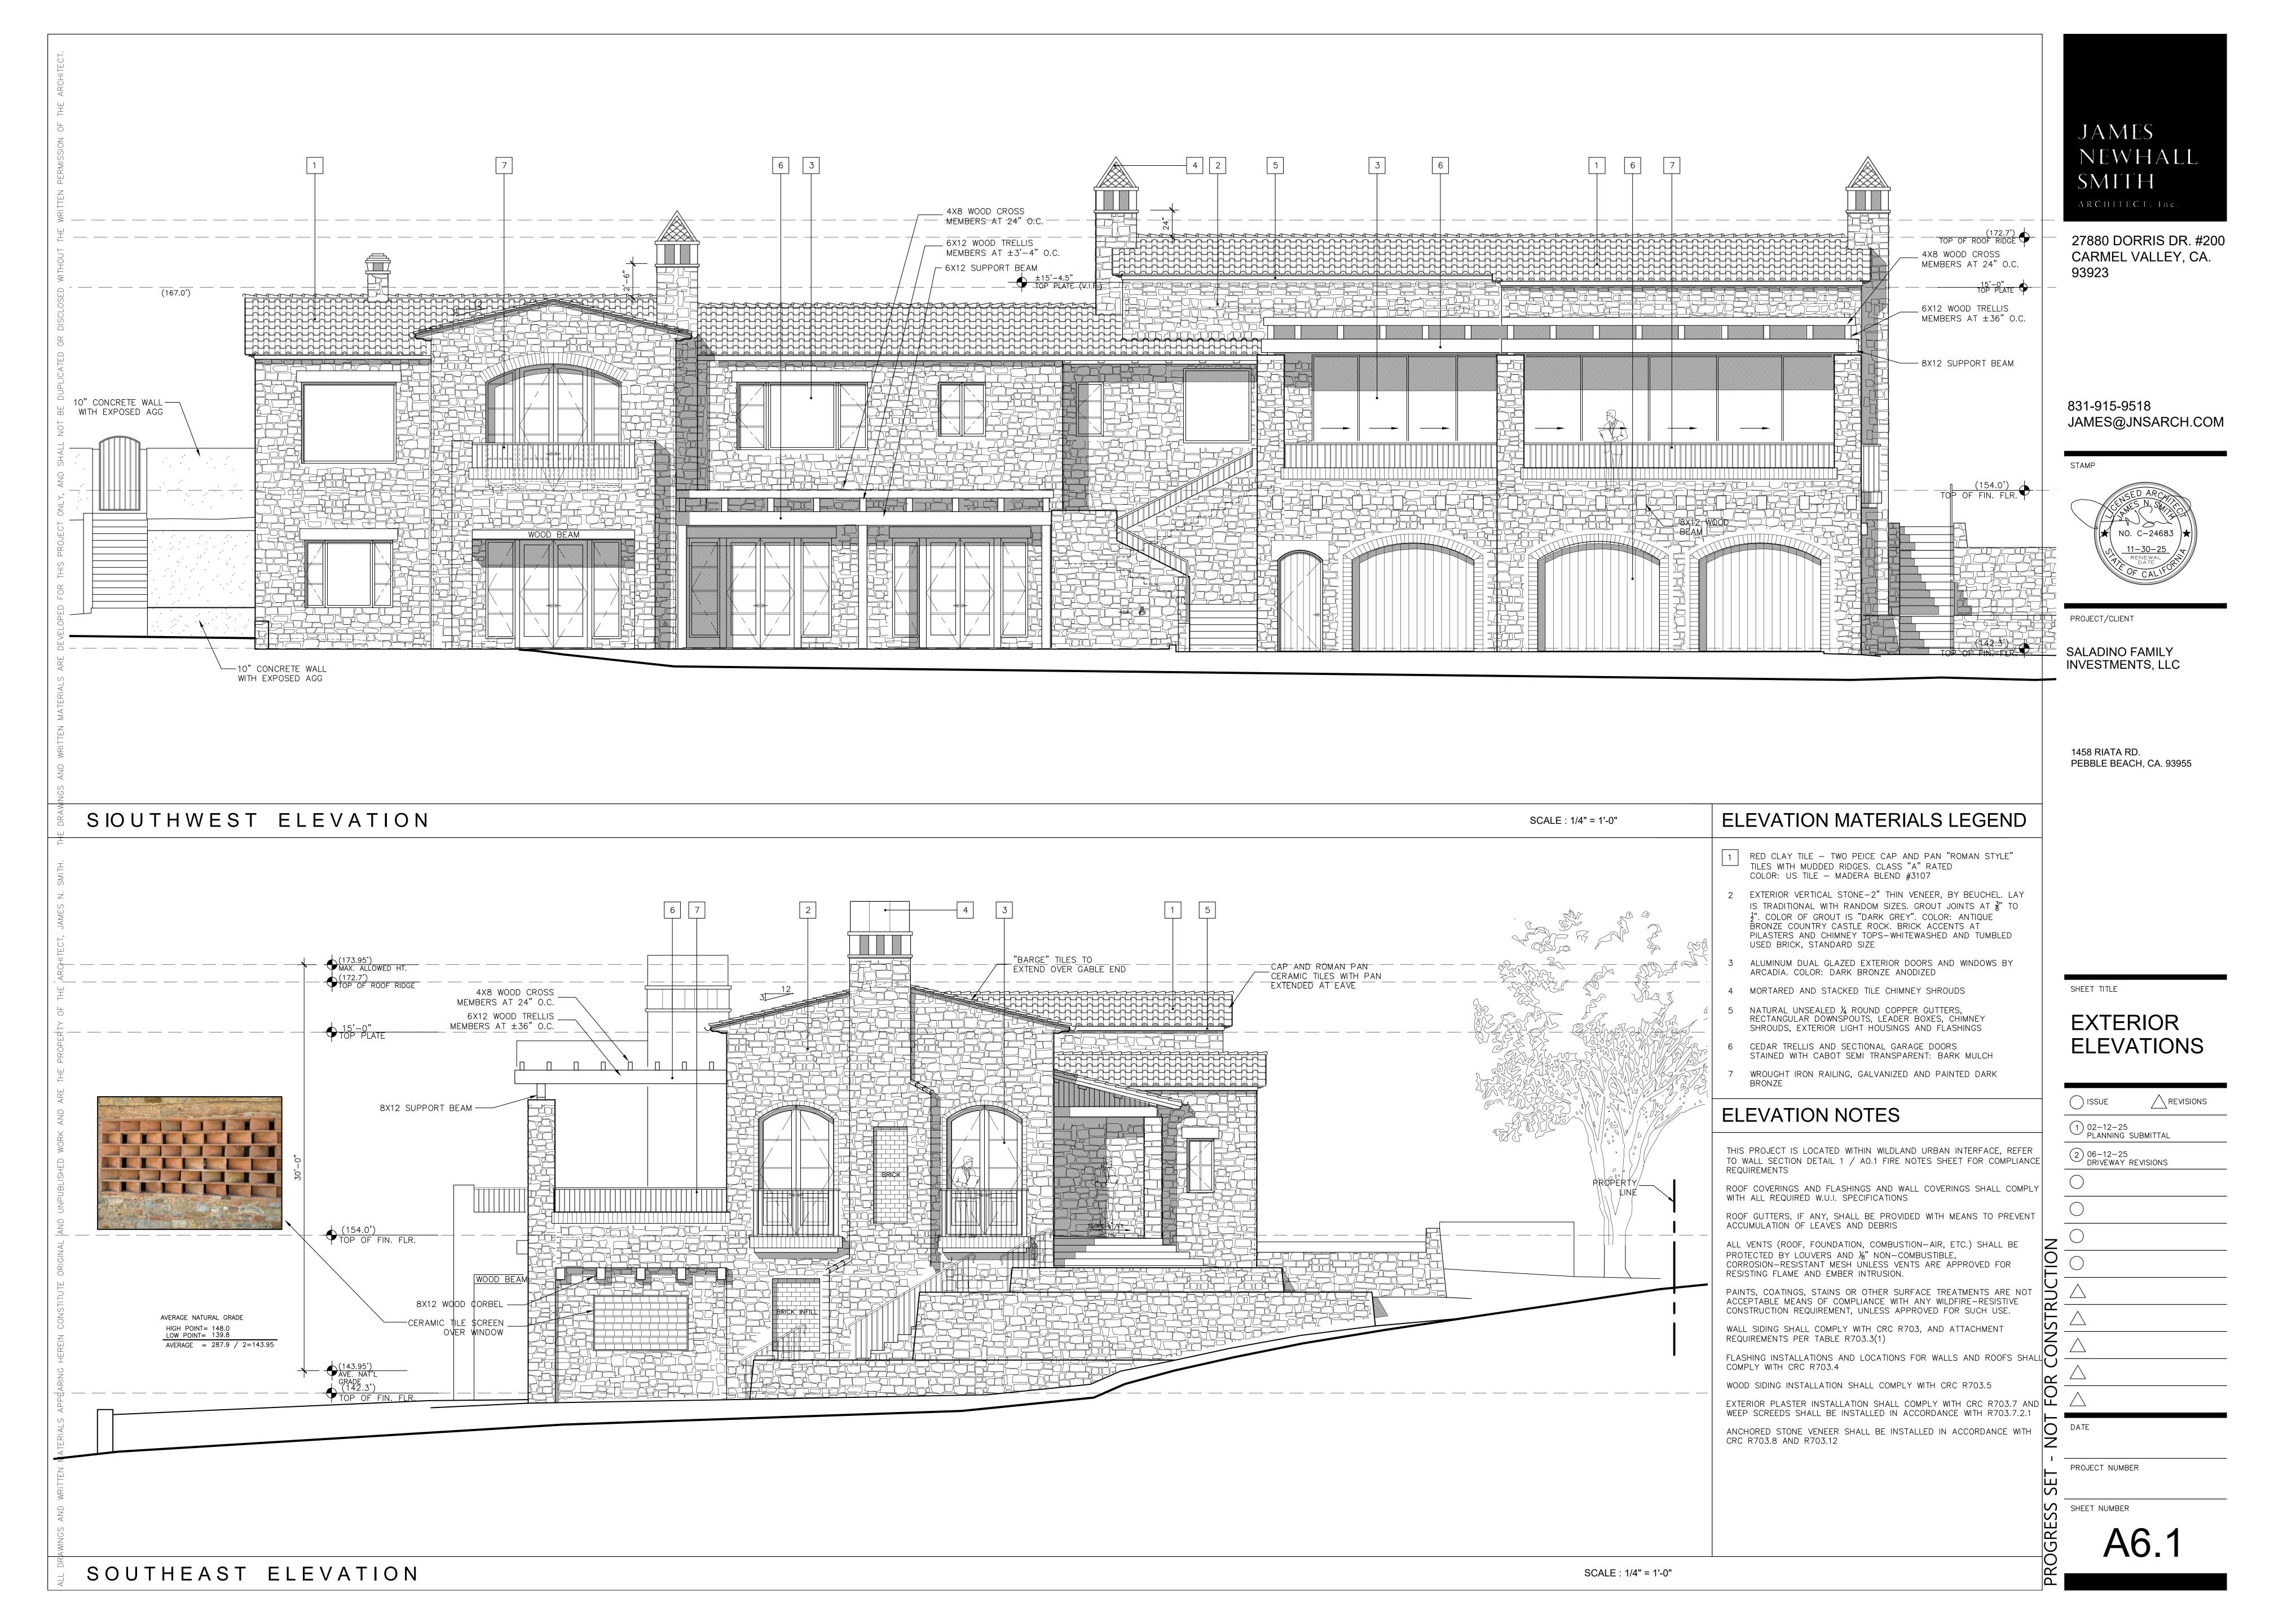

A/C PAVING PER PEBBLE BEACH STNDS

P.L.

LOWER MOTOR

COURT

NEW PERVIOUS GOLDEN GRANITE GRAVEL


GATE

UPPER MOTOR

(152.4') ELEV.
TOP OF PAVING
NEW PERVIOUS GOLDEN
GRANITE GRAVEL

**GATE** 



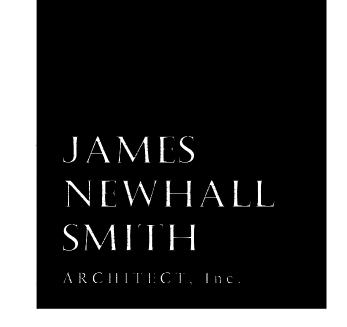


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INTERIOR ELEVATION NOTES

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STAMP



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SITE ELEVATIONS

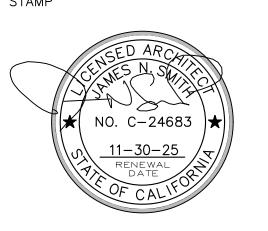ISSUE \_\_\_\_\_ REVISIONS

1) 02-12-25 PLANNING SUBMITTAL

2 06-12-25 DRIVEWAY REVISIONS

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3/8" California Gold

Composition: Grante

Grant With a samp of contrasting colors, from a warm being to a rich gold

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A/C PAVING
PER PEBBLE BEACH STNDS


DRIVEWAY GRAVEL
3/8" CALIFORNIA GOLD

DIMENSIONS' ANTIQUED

TIMELESS SOPHISTICATION REMINISCENT OF HAND-LAIN MEDITERRANEAN STONE

DRIVEWAY PAVERS BELGARD - LUEDERS GREY

DRIVEWAY SURFACES

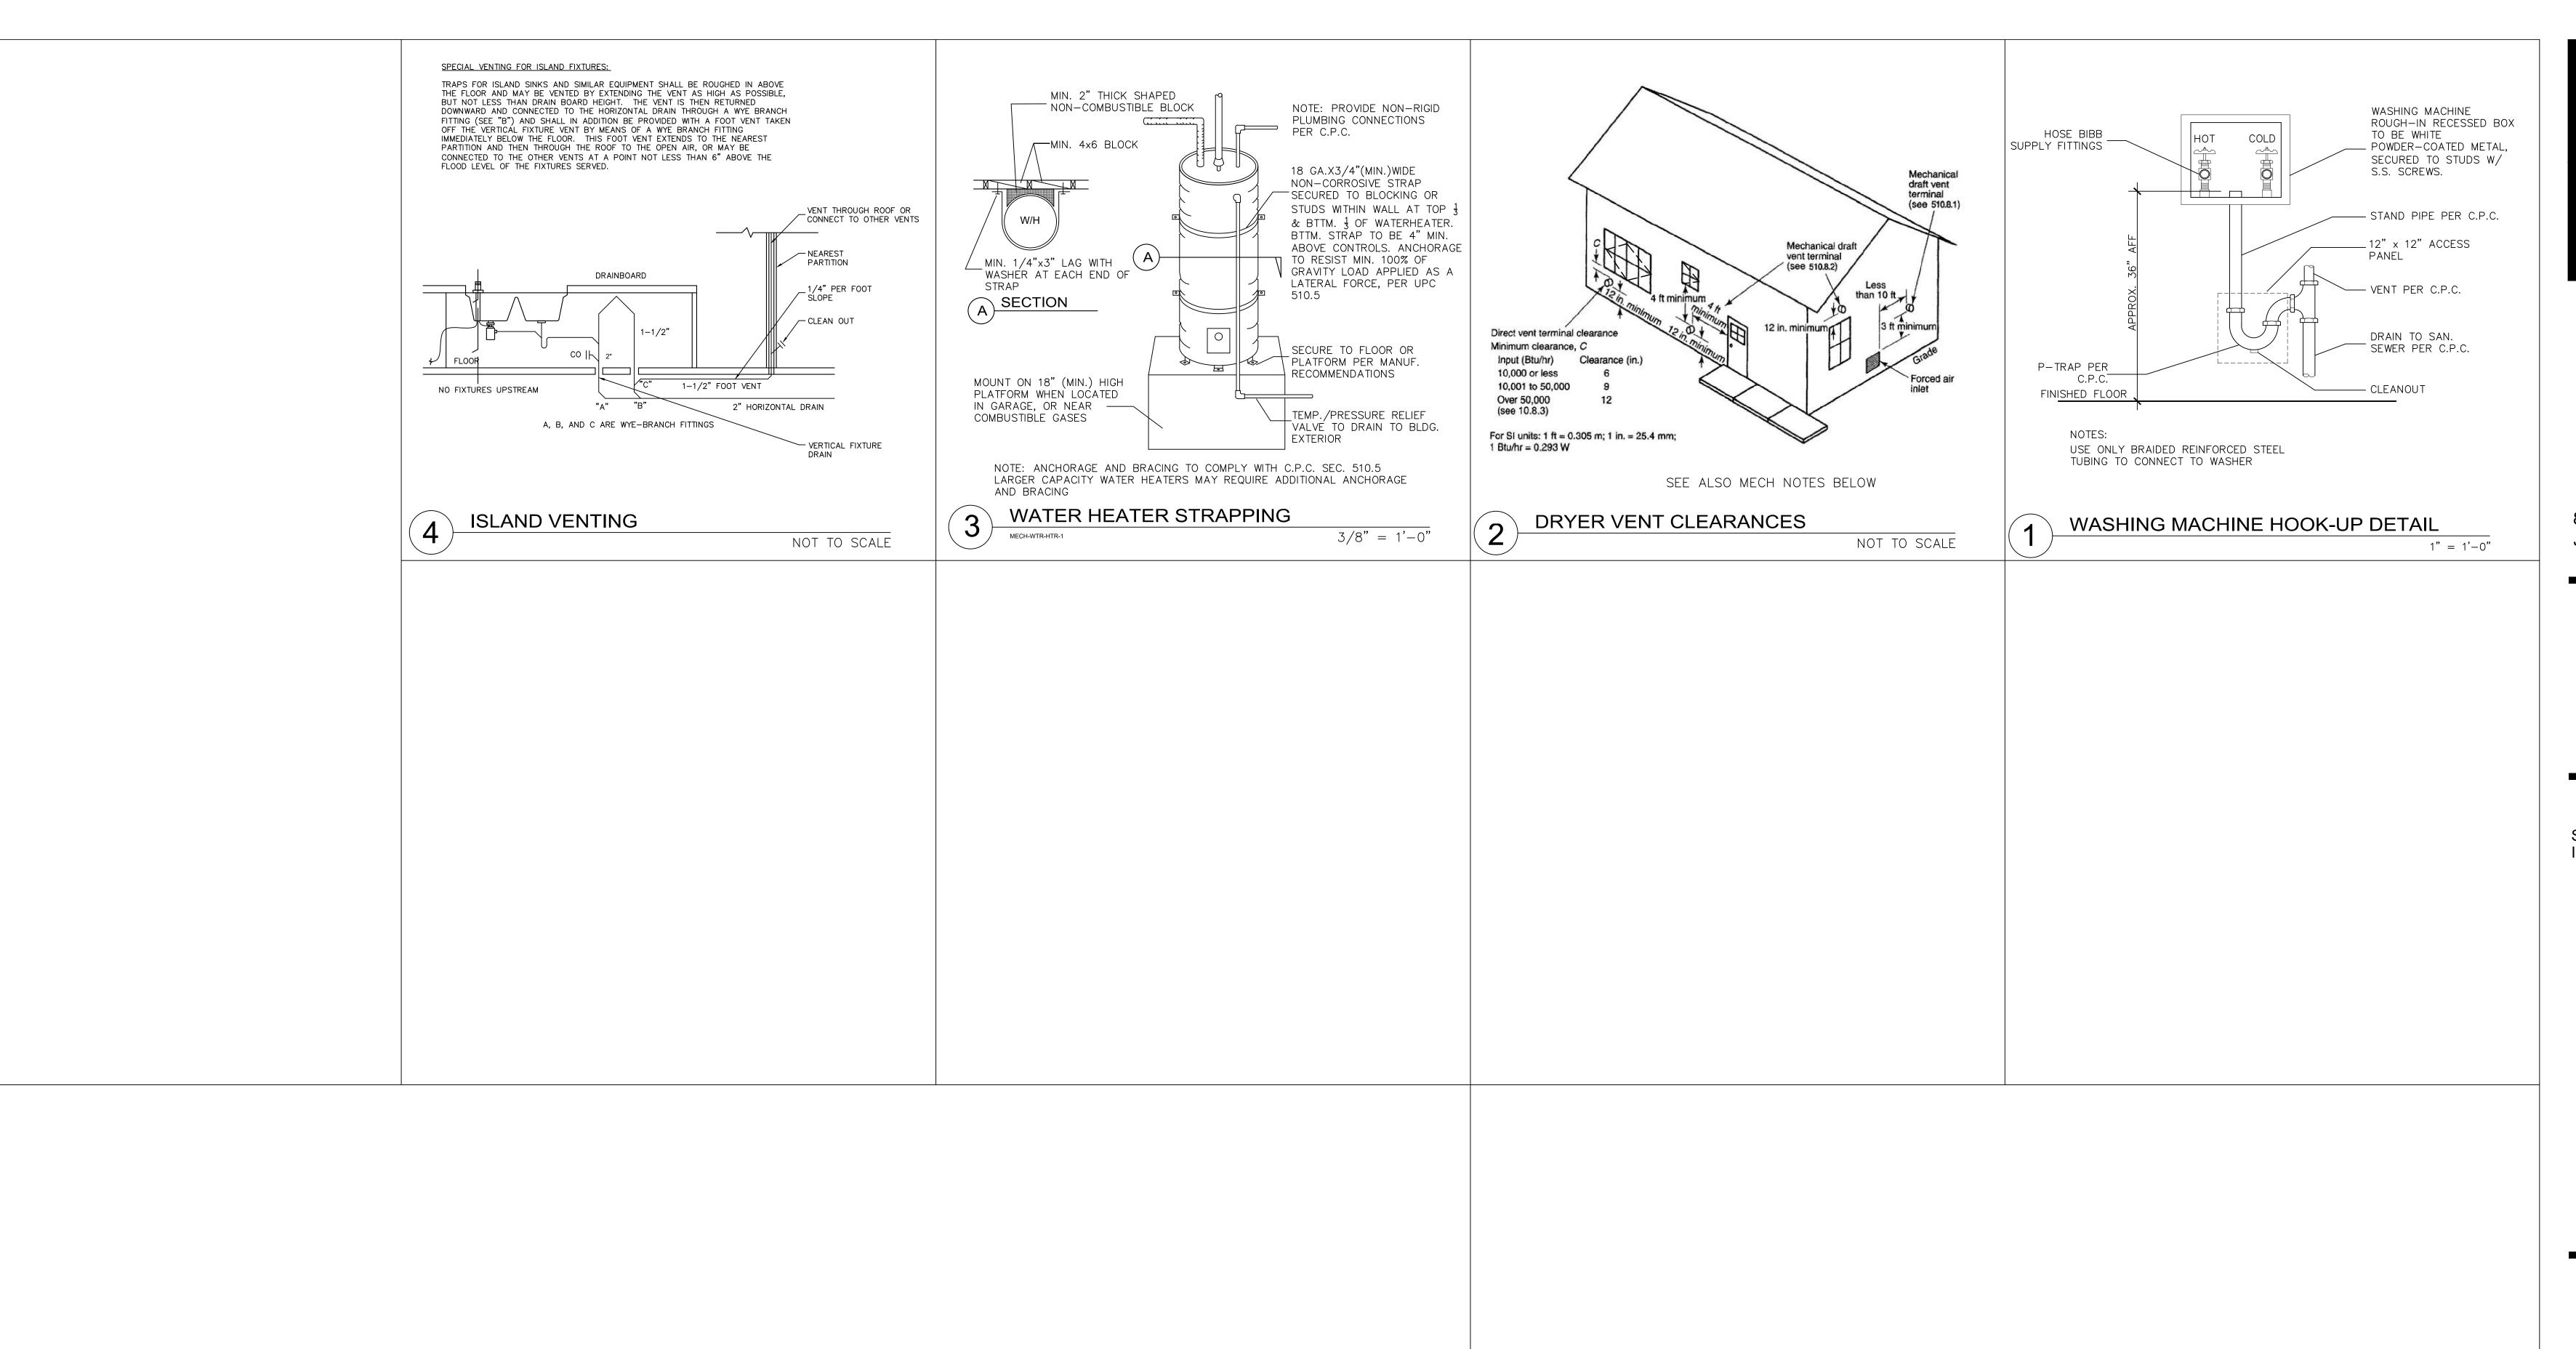

#### **MECHANICAL NOTES:**

HEATING AND COOLING SYSTEM(S) ARE PER MECHANICAL SHEETS

DUCTS IN A PRIVATE GARAGE AND DUCTS PENETRATING THE WALLS OR CEILINGS SEPARATING THE DWELLING UNIT FROM THE GARAGE SHALL BE CONSTRUCTED OF A MINIMUM 0.019" SHEET STEEL AND SHALL HAVE NO OPENINGS INTO THE GARAGE. (CEC SEC 406.1.4(2)).

PER ENERGY REQUIREMENTS (CEC SECTION 150-(E)-1-B). CLOSABLE METAL OR TEMPERED GLASS DOORS SHALL COVER THE ENTIRE OPENING OF THE FIRE BOX. PROVIDE OUTSIDE COMBUSTION AIR INTAKE DIRECTLY INTO THE FIREBOX A MINIMUM OF 6 SQUARE INCHES IN AREA AND EQUIPPED WITH A READILY ACCESSIBLE, OPERABLE, AND TIGHT-FITTING DAMPER. (NOT REQUIRED IF THE FIREPLACE IS INSTALLED OVER CONCRETE OVER SLAB FLOORING AND THE FIREPLACE WILL NOT BE LOCATED ON AN EXTERIOR WALL).

CLOTHES DRYER MOISTURE EXHAUST DUCTS SHALL TERMINATE OUTSIDE THE BUILDING AND HAVE A BACK-DRAFT DAMPER. EXHAUST DUCT IS LIMITED TO 14' WITH TWO ELBOWS. THIS MAX. RUN SHALL BE REDUCED 2' FOR EVERY ELBOW IN EXCESS OF

A PERMANENTLY AFFIXED SIGN SHALL BE INSTALLED IN THE MECHANICAL ROOM WHICH STATES THE FOLLOWING: "ALL GUTTERS, DOWNSPOUTS AND CATCH BASINS SHALL BE INSPECTED AND CLEANED OF SILT AND DEBRIS BEFORE EACH WINTER AND AFTER EACH SIGNIFICANT STORM EVENT"

MECHANICAL AND GRAVITY OUTDOOR AIR INTAKE OPENINGS SHALL BE LOCATED A MINIMUM OF 10' FROM ANY HAZARDOUS OR NOXIOUS CONTAMINANT SUCH AS VENTS, CHIMNEYS, PLUMBING VENTS, STREETS, ALLEYS, PARKING LOTS AND LOADING DOCKS, EXCEPT AS OTHERWISE SPECIFIED IN THIS CODE. TOILET ROOMS, BATHROOMS AND KITCHENS SHALL NOT BE CONSIDERED HAZARDOUS OR NOXIOUS (R303.5.1)

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( ) ISSUE

1) 02-12-25

#### **DETAILS** MECHANICAL

REVISIONS


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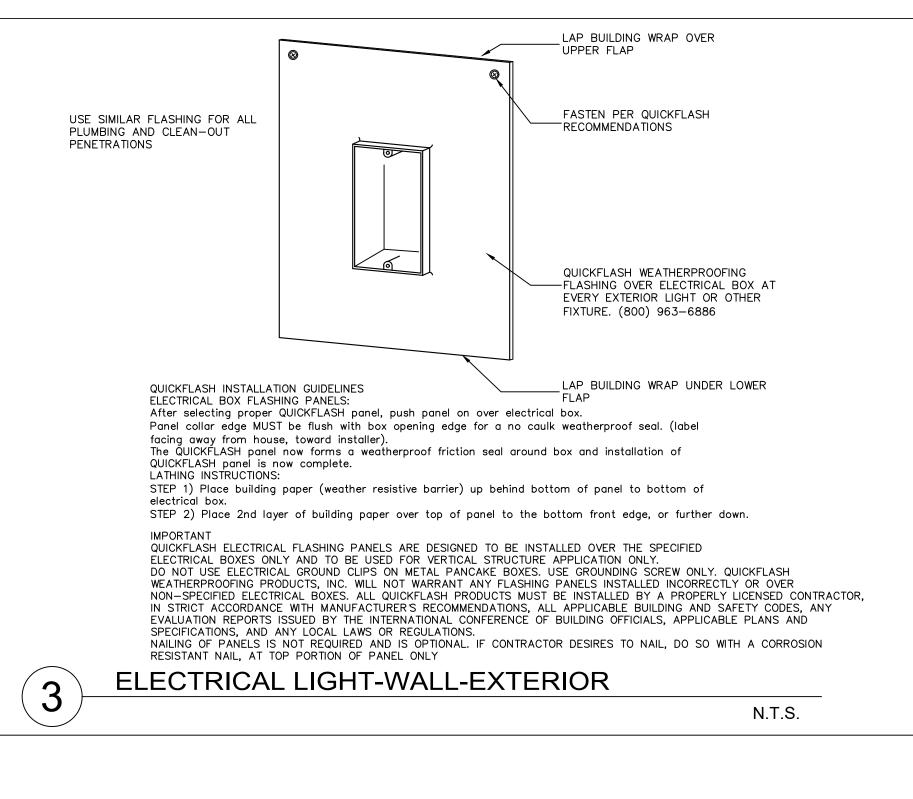
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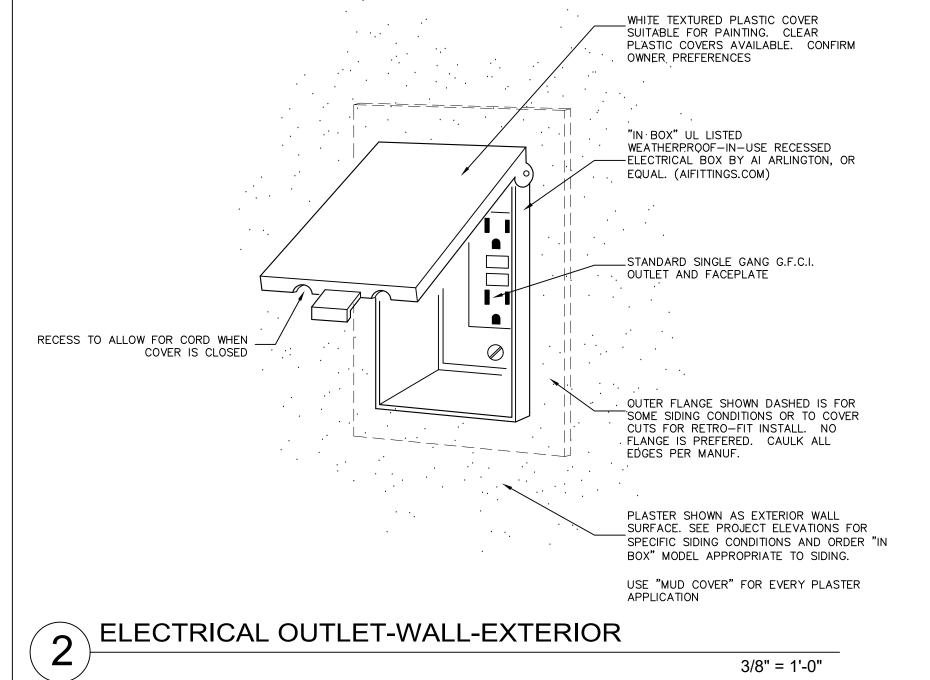
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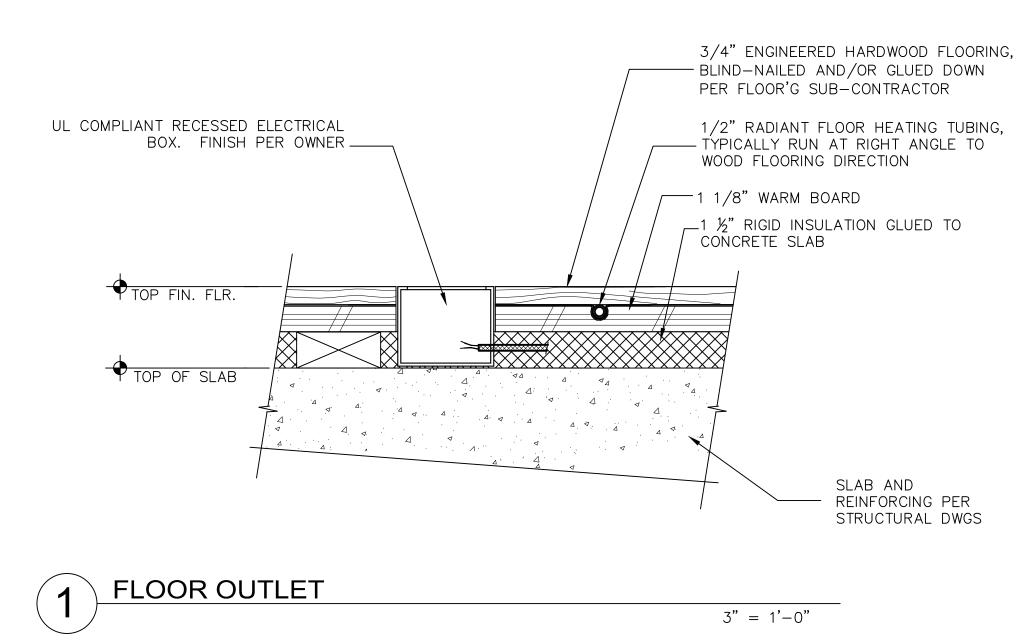
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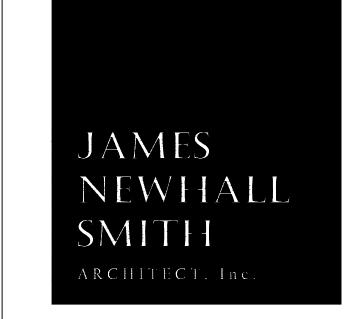
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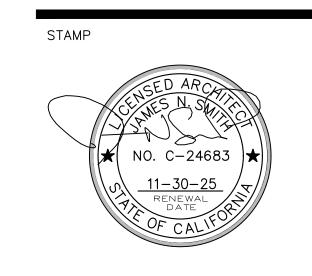






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3'-0" COOR. OUTLET HEIGHTS -WITH OWNER APPROVED MIN. CLR. BACK-SPLASH HEIGHTS SWITCH OR COUNTER OUTLET **EXTENSION** G.F.I. TUB/SHWR G.F.I. W.P. FIN. FLOOR FIN. FLOOR RADE/TERRACE TOP FIN. FLR. DUPLEX OUTLET DUPLEX OUTLET DUPLEX OUTLET LIGHT SWITCH KITCHEN INTERIOR EXTERIOR GARAGE **MOUNTING HEIGHTS** N.T.S.

## **ELECTRICAL NOTES:**

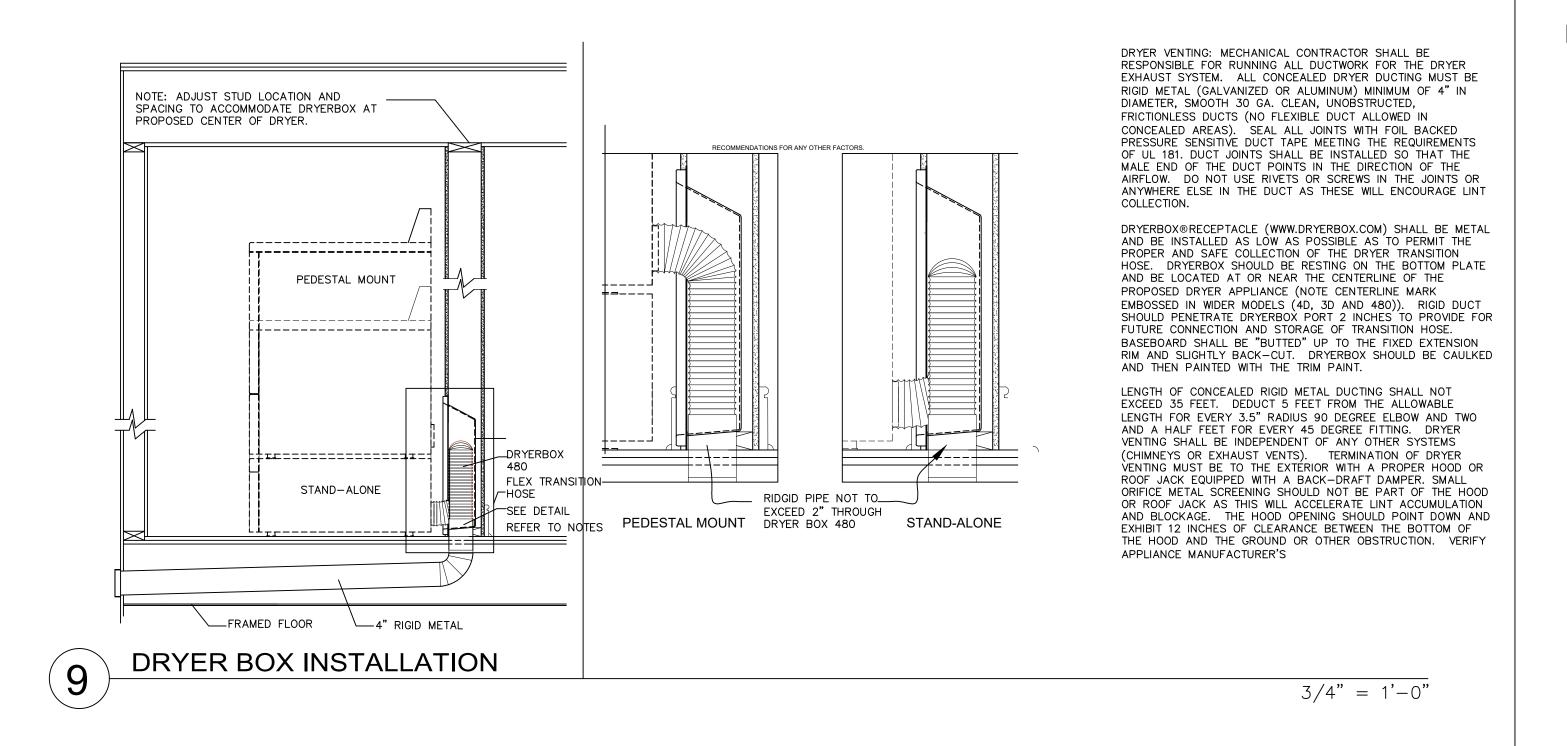SEE ELECTRICAL SYMBOL LEGEND NOTES FOR ADDITIONAL INFORMATION.

ALL NEW ELECTRICAL WORK SHALL MEET 2019 CALIFORNIA ELECTRICAL CODE

ELECTRICIAN TO CONDUCT AN ON-SITE WALK THRU WITH THE OWNERS AND ARCHITECT TO DETERMINE FINAL LOCATIONS FOR RECEPTACLES, FIXTURES, PHONES, CABLE, AUDIO/VISUAL, SECURITY, DATA LINES, ETC. PRIOR TO ROUGH-IN. OBTAIN OWNER APPROVAL AS PER STYLE AND COLOR OF SWITCHES AND OUTLETS.

MAIN ELECTRICAL SERVICE PANELS: SIZE PER PLAN, GROUNDING METHOD PER ELECTRICIAN, INCLUDING UFER GROUNDING, OR CONCRETE-ENCASED-ELECTRODE PER CEC 250-81(C).

ALL 125-VOLT, 15- AND 20- AMPERE RECEPTACLE OUTLETS SHALL BE LISTED TAMPER-RESISTANT RECEPTACLES PER CEC 406.11.

EACH MULTIWIRE BRANCH CIRCUIT SHALL BE PROVIDED WITH A MEANS THAT WILL SIMULTANEOUSLY DISCONNECT ALL UNGROUNDED CONDUCTORS AT THE POINT WHERE THE BRANCH CIRCUIT ORIGINATES.

IN REMODELS, ALL NEW ELECTRICAL WORK SHALL MEET CURRENT CALIFORNIA CODES.

SEE A4.0 SHEETS FOR LIGHTING INFORMATION AND LAYOUT LIVING AREAS / HALLWAYS

RECEPTACLE OUTLETS IN EVERY MAIN HABIITABLE ROOM SHALL BE SPACED SO THAT NO POINT ALONG THE FLOOR LINE OF THE WALL IS MORE THAN 6' HORIZONTALLY FROM AN ELECTRICAL OUTLET PER CEC 210-52. ANY SPACE 2' OR MORE IN WIDTH INCLUDING SPACE MEASURED AROUND CORNERS AND UNBROKEN ALONG THE FLOOR LINE BY DOORWAYS, FIREPLACES AND SIMILAR OPENINGS. FLOOR RECEPTACLE SHALL NOT BE COUNTED AS A PART OF THE REQUIRED RECEPTACLES UNLESS WITHIN 18" OF WALL.

RECEPTACLE OUTLETS AT HALLWAYS 10' OR LONGER SHALL HAVE AT LEAST ONE OUTLET PER CEC 210-52(H). AT LEAST ONE WALL SWITCH-CONTROLLED LIGHTING OUTLET SHOULD BE INSTALLED (CEC 210-70): IN EVERY HABITABLE ROOM, HALLWAYS, STAIRWAYS, ATTACHED GARAGES, AND OUTDOOR ENTRANCES.

ALL 120-VOLT 15 AND 20 AMP OR BRANCH CIRCUITS THAT SUPPLY OUTLETS INSTALLED IN DWELLING UNIT FAMILY ROOMS, DINING ROOMS, LIVING ROOMS, KITCHENS. LAUNDRY AREAS, PARLORS, LIBRARIES, DENS, BEDROOMS, SUNROOMS, RECREATION ROOMS, CLOSETS, HALLWAYS OR SIMILAR ROOMS OR AREAS SHALL BE PROTECTED BY A LISTED ARC-FAULT CIRCUIT INTERRUPTER (AFCI) COMBINATION TYPE. GUESTROOMS (210-18) AND GUEST SUITES THAT ARE PROVIDED WITH PERMANENT PROVISIONS FOR COOKING SHALL HAVE AFCI (CEC 210.12(B).

ALL RECEPTACLE CIRCUITS SHALL NOT BE COMBINED WITH LIGHTING LOADS AT LIVING OR EXITING AREAS.

#### **KITCHEN**

ALL KITCHEN CIRCUITS, INCLUDING FOR DISHWASHERS AND GARBAGE DISPOSALS, SHALL BE AFCI/GFCI

PROTECTED. KITCHEN: ALL ELECTRICAL OUTLETS THAT SERVE THE COUNTER TOPS IN THE KITCHEN SHALL HAVE GFCI (GROUND-FAULT CIRCUIT-INTERRUPTER PROTECTION PER CEC 210-8(A)(6).

SUPPLYING WALL AND COUNTER SPACE OUTLETS ONLY (CEC ARTICLE 210-52(b)).

THERE SHALL BE A MINIMUM OF TWO SMALL APPLIANCE BRANCH CIRCUITS FOR THE KITCHEN, LIMITED TO

ALL KITCHEN COUNTERTOPS WIDER THAN 12" SHALL BE SERVED BY AN ELECTRICAL OUTLET PER CEC 210-52(C). MIN. OF (2) 20 AMP CIRCUITS SERVING COUNTERTOPS SHALL BE DUAL AFCI/GFCI PROTECTED RECEPTACLES

KITCHEN AT ISLANDS AND PENINSULAR COUNTERTOPS SHALL HAVE AT LEAST ONE ELECTRICAL OUTLET THAT SERVES THE COUNTERTOP PER CEC 210-52(C). OUTLETS SHALL BE MOUNTED NOT MORE THAN 12" BELOW COUNTERTOP. RECEPTACLES MAY NOT BE MOUNTED UNDER ANY OVERHANG GREATER THAN 6". A MINIMUM OF TWO 20 AMP SMALL APPLIANCE BRANCH CIRCUITS SHALL BE PROVIDED FOR ALL RECEPTACLE

OUTLETS IN THE KITCHEN, PANTRY, OR OTHER SIMILAR AREAS. (CEC 210.11(C)(1)).

ELECTRICAL OUTLETS FOR THE KITCHEN COUNTERS SHALL BE SPACED SO THAT NO POINT ALONG THE WALL LINE OF THE COUNTER IS MORE THAN 2' FROM AN ELECTRICAL OUTLET (4' O.C. MAX.) AND WITHIN 24" OF EDGE AND/OR BREAK IN THE COUNTERTOP PER CEC 210-52(C). REFRIDGERATORS ARE REQUIRED TO BE DUAL AFCI/GFCI PROTECTED AND MAY BE ON ONE OF THE CIRCUITS SERVING COUNTERS.

FIXED APPLIANCES AND MICROWAVE SHALL BE PROVIDED POWER FROM ADDITIONAL DEDICATED CIRCUITS. KITCHEN SINK SHALL HAVE AN ELECTRICAL OUTLET WITHIN 24" OF BOTH SIDES OF THE SINK, MEASURED FROM THE EDGE OF THE SINK

#### BATHROOM

BATHROOM OUTLETS SHALL HAVE APPROVED GROUND FAULT CIRCUIT PROTECTION PER NEC 210-8(A)(1). A GFCI PROTECTED OUTLET SHALL BE INSTALLED NEXT TO EACH BATHROOM BASIN PER CEC 210-52(D). BATHROOM ELECTRICAL OUTLETS SHALL BE SUPPLIED BY AT LEAST ONE 20 AMP BRANCH CIRCUIT. THE CIRCUIT(S) SHALL HAVE NO OTHER ELECTRICAL OUTLETS PER CEC 210.11(C)(3)

AT LEAST ONE GFCI PROTECTED RECEPTACLE SHALL BE LOCATED WITHIN 3' OF THE OUTSIDE EDGE OF EACH BASIN (SINK) (CEC 210.52(D).

#### LAUNDRY / GARAGE / ACCESSORY BLDGS / EXTERIOR

ALL LAUNDRY ROOM RECEPTACLES, INCLUDING WASHING MACHINE (BUT NOT DRYER) SHALL BE AFCI PROTECTED PER CEC 210.12(A)

ONE ADDITIONAL 20 AMP BRANCH ELECTRICAL CIRCUIT SHALL BE PROVIDED TO SUPPLY THE LAUNDRY RECEPTACLE OUTLETS REQ'D PER CEC 210.52(F). THIS CIRCUIT SHALL HAVE NO OTHER OUTLETS. (CEC 210.11(C)(2) ELECTRICAL CLOTHES DRYERS AND ELECTRIC KITCHEN RANGES SHALL HAVE A 4-WIRE GROUNDED ELECTRICAL OUTLET PER CEC 250-59.

ELECTRICAL PANELS IN GARAGE WALL SHALL BE SURFACE MOUNTED OR HAVE FULL 5/8" TYPE "X" GYPSUM BOARD LINING BEHIND THE PANEL. MONTEREY COUNTY REQUIREMENT.

GARAGE, ACCESSORY BLDGS, AND BASEMENT RECEPTACLES SHALL HAVE GFCI PROTECTION PER CEC 210-8(A). 125- AND 250-VOLT RECEPTACLES INSTALLED OUTDOORS IN A WET LOCATION SHALL HAVE AN ENCLOSURE THAT IS WEATHERPROOF WHETHER OR NOT THE ATTACHMENT PLUG CAP INSERTED PER CEC 406.9 (B) (1) EXTERIOR OUTLETS SHALL HAVE A WEATHERPROOF ENCLOSURE & GFCI PER NEC 410-57(A). GFCI OUTLET SHALL BE INSTALLED AT THE FRONT AND REAR OF THE HOUSE PER CEC 210-52(E).

LAUNDRY. UTILITY AND WET BARS SHALL HAVE GFCI OUTLETS WHEN RECEPTACLE IS WITHIN 6' OF THE OUTSIDE EDGE OF THE SINK.

PROVIDE LISTED RACEWAY TO ACCOMMODATE A DEDICATED 208/240 V BRANCH CIRCUIT FOR FUTURE ELECTRIC

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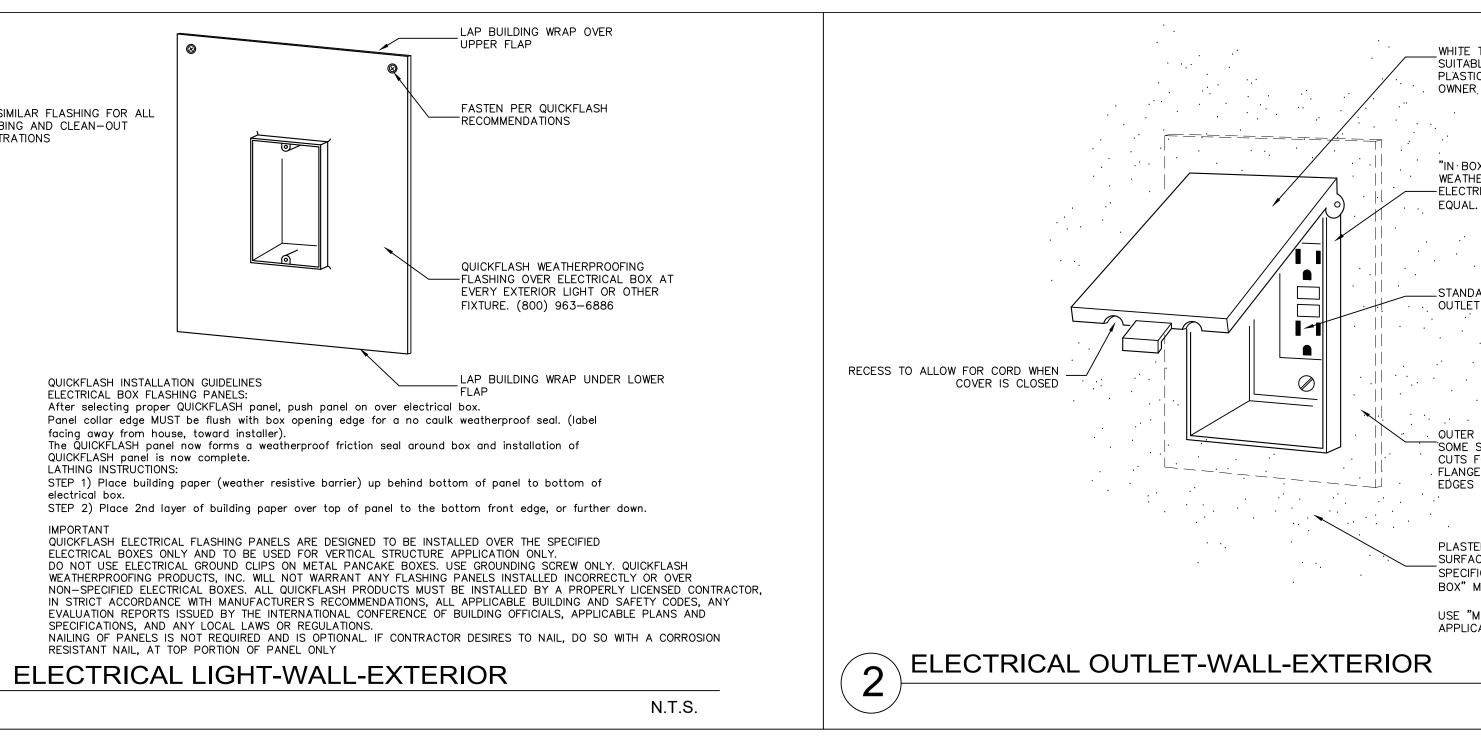
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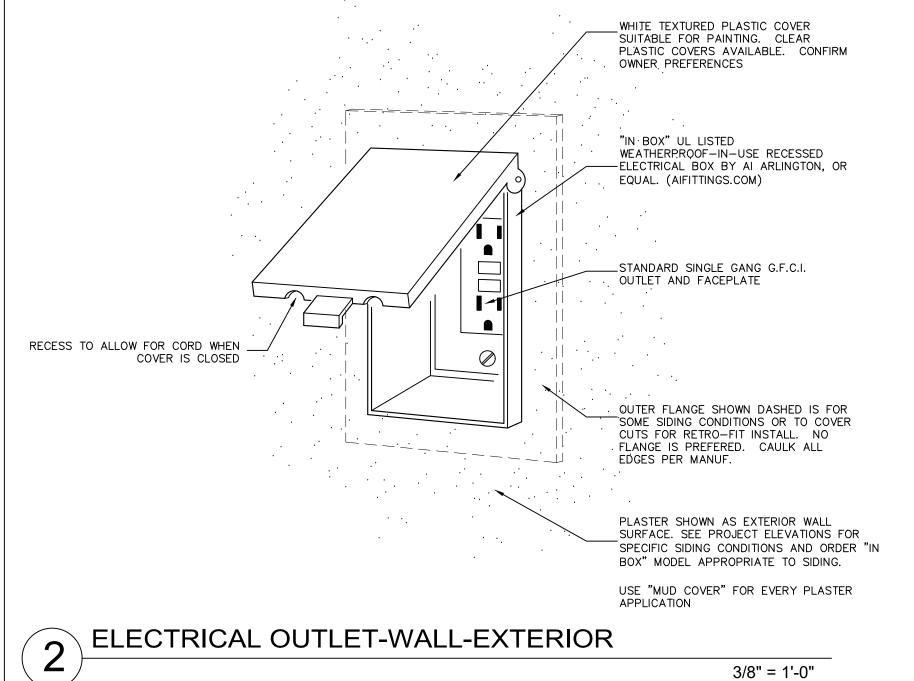
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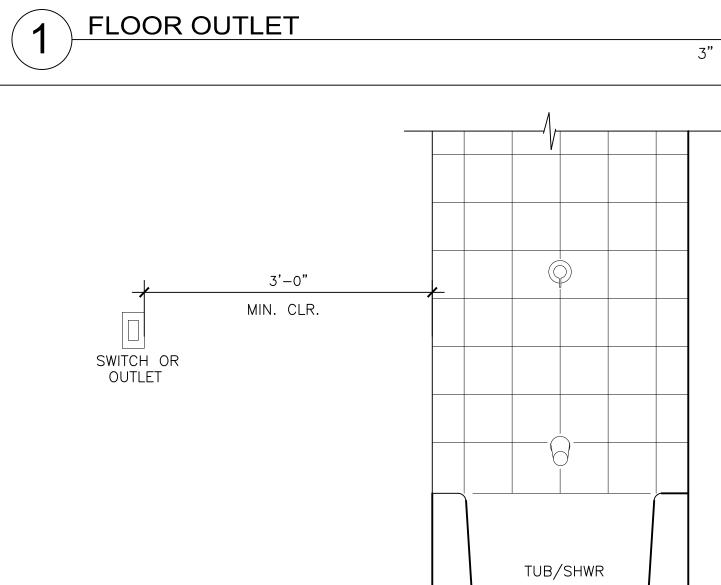
#### DETAILS **ELECTRICAL**


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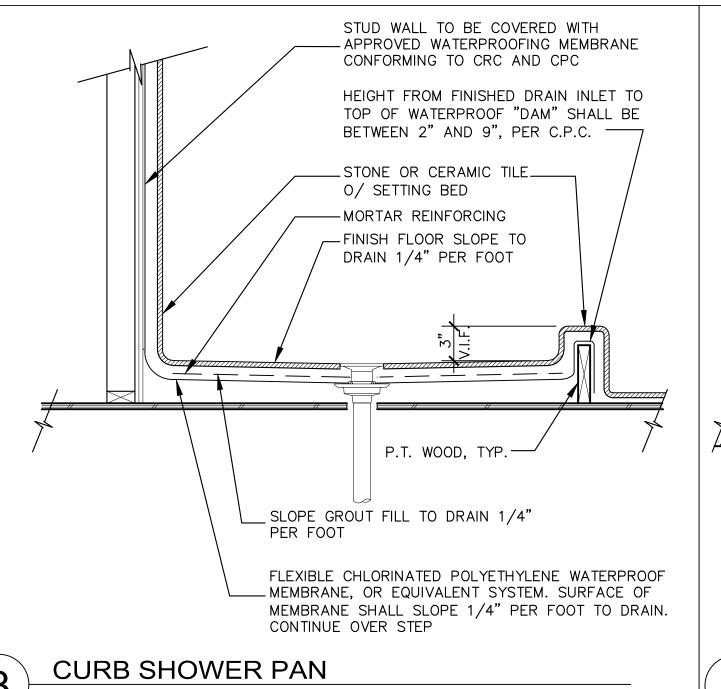
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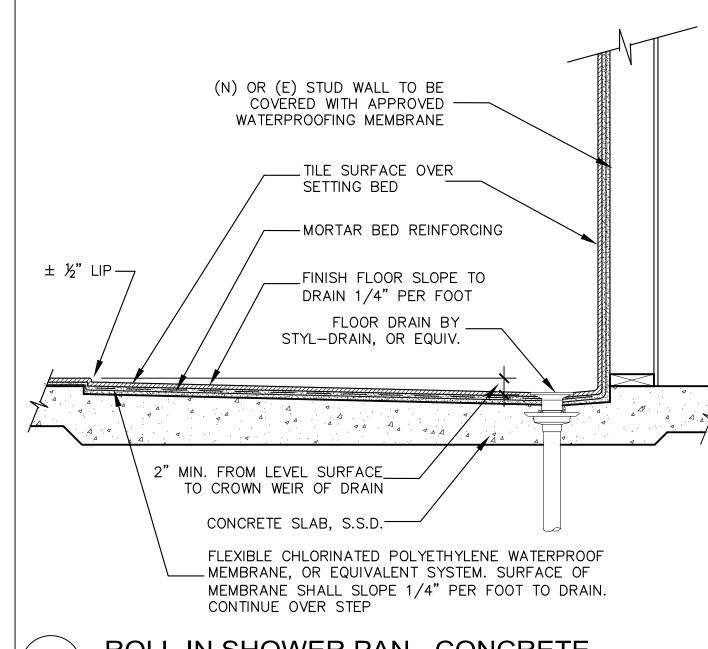








NOT TO SCALE

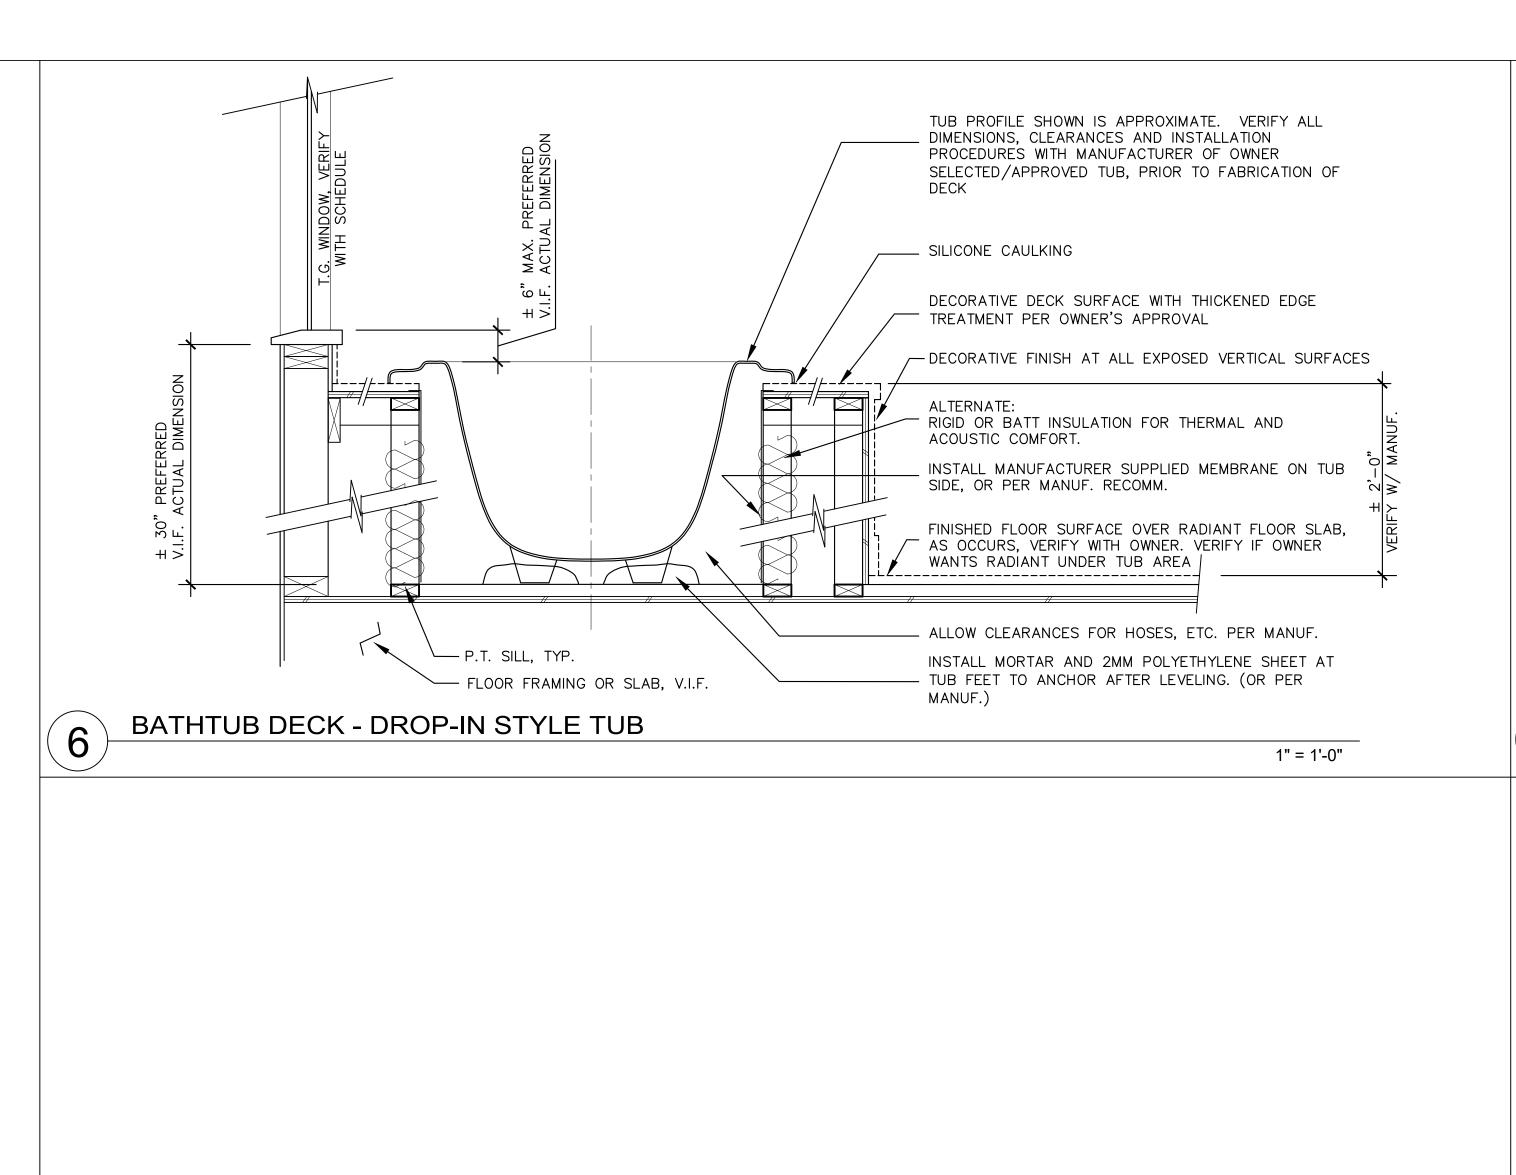

ROLL-IN SHOWER PAN - CONCRETE

(N) OR (E) STUD WALL TO BE

COVERED WITH APPROVED -WATERPROOFING MEMBRANE

SETTING BED

\_TILE SURFACE OVER

--- MORTAR BED REINFORCING

\_FINISH FLOOR SLOPE TO

FLOOR DRAIN BY


FLEXIBLE CHLORINATED POLYETHYLENE WATERPROOF

MEMBRANE SHALL SLOPE 1/4" PER FOOT TO DRAIN.


MEMBRANE, OR EQUIVALENT SYSTEM. SURFACE OF

DRAIN 1/4" PER FOOT

STYL-DRAIN, OR EQUIV.

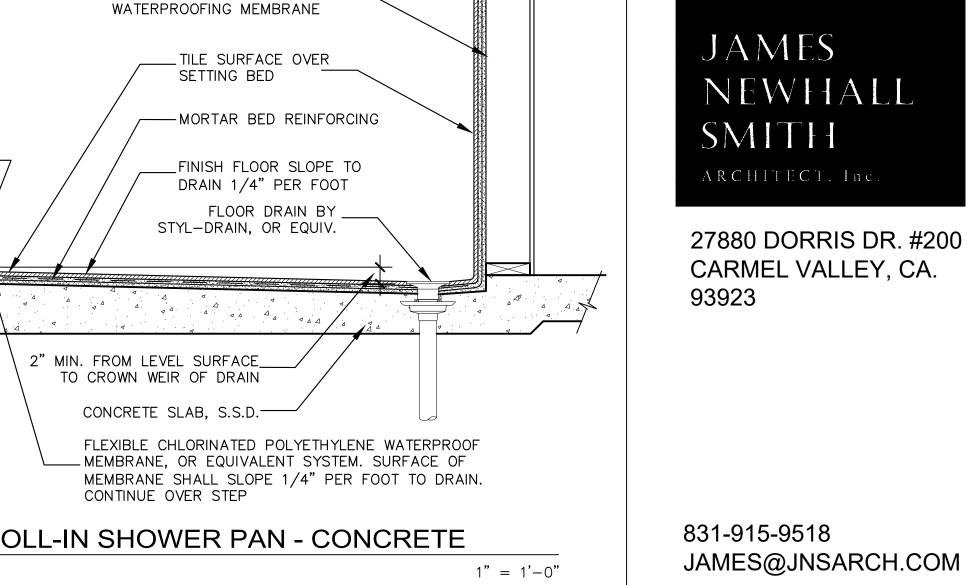

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— (N) STUD WALL TILE SURFACE OVER SETTING TEAK WOOD PLATFORM, OPEN FOR DRAINAGE —— MORTAR REINFORCING ---FINISH FLOOR SLOPE TO DRAIN 1/4" PER FLOOR DRAIN BY STYL-DRAIN, OR EQUIV. FLOOR FRAMING, FLEXIBLE CHLORINATED POLYETHYLENE WATERPROOF MEMBRANE, OR EQUIVALENT SYSTEM. SURFACE OF MEMBRANE SHALL SLOPE 1/4" PER FOOT TO DRAIN.

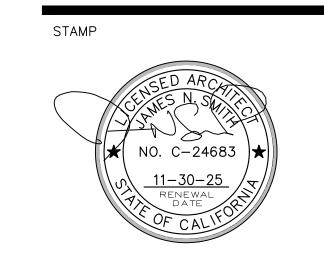**RECESSED SHOWER PAN - WOOD FLOOR** 

### **ROLL-IN SHOWER PAN - WOOD FLOOR** 1" = 1'-0"

S.S. SHOWER CURTAIN . ω<del>\</del> —--

2" MIN. FROM LEVEL SURFACE\_ TO CROWN WEIR OF DRAIN

VERIFY FLOOR FRAM'G

CONTINUE OVER STEP

THIS AREA, S.S.D.

TUB/SHOWER SHOWER HEAD AND VALVE

#### **PLUMBING NOTES:**

#### **GENERAL**

PLUMBING PLAN (INCLUDING GAS LINE LAYOUT AND SIZING) SHALL BE SUBMITTED TO AND APPROVED BY THE BUILDING DEPARTMENT PRIOR TO INSTALLATION. WATER PRESSURE IN THE BUILDING SHALL BE LIMITED TO 50 TO 60 P.S.I. OR LESS. INSTALL/UPGRADE PRESSURE REGULATOR AS REQUIRED.

PROVIDE PRESSURE ABSORBING DEVICES, EITHER AN AIR CHAMBER OR APPROVED MECHANICAL DEVICE THAT WILL ABSORB HIGH PRESSURE RESULTING FROM THE QUICK CLOSING OF QUICK-ACTING VALVES. (CPC 609.10).

PROVIDE NON-REMOVABLE BACKFLOW PREVENTION DEVICES ON ALL EXTERIOR CONTRACTOR TO PROVIDE ACCESS PANEL (MIN 12"x12") OR UTILITY SPACE FOR

ALL PLUMBING FIXTURES HAVING CONCEALED SLIP-JOINT CONNECTIONS. (CPC

PLUMBING LINES UTILIZED AS GROUNDS ARE PROHIBITED.

ALL HOT WATER FIXTURES THAT HAVE MORE THAN 10' OF PIPE FROM THE FIXTURE TO THE HOT WATER HEATER SERVING THE FIXTURE SHALL BE EQUIPPED WITH A HOT WATER RECIRCULATING SYSTEM.

THE MAXIMUM HOT WATER TEMPERATURE DISCHARGING FROM THE BATHTUB AND WHIRLPOOL BATHTUB FILLER SHALL BE LIMITED TO 120° FAHRENHEIT. THE WATER HEATER THERMOSTAT SHALL NOT BE CONSIDERED A CONTROL FOR MEETING THIS PROVISION. (CPC SECTION 414.5)

NO PERSON SHALL USE ANY PIPE, PIPE OR PLUMBING FITTING OR FIXTURE, OR SOLDER OR FLUX THAT IS NOT LEAD FREE (0.25% LEAD) IN PLUMBING SYSTEMS CONVEYING POTABLE WATER FOR HUMAN CONSUMPTION (I.E. PIPING, FITTINGS AND FIXTURES TO/AT KITCHEN AND BATHROOM SINKS).

CONTRACTOR OR PLUMBING SUB-CONTRACTOR SHALL PROVIDE THE TESTING AND LISTING DOCUMENTATION TO THE BUILDING DEPARTMENT INSPECTION STAFF FOR ALL PLUMBING PRODUCTS CONVEYING POTABLE WATER SHOWING THAT EACH MEETS THE LEAD FREE TESTING REQUIREMENTS OF NSF/ANSI 61 ANNEX G.

#### KITCHEN

KITCHEN SINK, UTILITY SINK AND BAR SINK FAUCETS SHALL EMIT A MAXIMUM OF 1.8 G.P.M. AT 60 P.S.I. FAUCETS MAY INCREASE TO 2.2 G.P.M. FOR TEMPORARY POT FILLING BUT MUST DEFAULT BACK TO 1.8 G.P.M. (MPWMD ORD 170)

PER GREEN BUILDING CODE, THE FLOW RATES OF WATER FIXTURES THAT ARE NOT UNDERGOING ALTERATION

#### BATHROOM

LAVATORY SINK FAUCETS IN BATHROOMS SHALL EMIT A MAXIMUM OF 1.2 G.P.M. AT 60 P.S.I. (MPWMD ORD. 170)

TOILETS, EITHER FLUSH TANK, FLUSHOMETER TANK, OR FLUSHOMETER VALVE SHALL BE 1.28 GALLONS MAX. PER FLUSH (U.O.N.). TOILET ENCLOSURE (IF ANY) SHALL HAVE A MINIMUM CLEAR WIDTH OF 30", AND THERE SHALL BE 24" CLEAR AREA IN FRONT OF TOILET STOOL.

#### SHOWERS

DIAMETER CIRCLE OF CLEAR AREA.

PROVIDE INDIVIDUAL CONTROL VALVES OF THE PRESSURE BALANCE OR THE THERMOSTATIC MIXING VALVE TYPE, AT ALL SHOWER LOCATIONS.

ALL SHOWER COMPARTMENTS, REGARDLESS OF SHAPE, SHALL HAVE A MINIMUM CLEAR THRESHHOLD OPENING OF 22" AND THE INTERIOR FLOOR AREA MUST BE A MINIMUM OF 1,024 SQ. IN., AND ALSO CAPABLE OF ENCOMPASSING A 30"

SHOWER/BATH DOOR, IF USED, SHALL BE TEMPERED GLASS AND SHALL OPEN OUTWARD AND BE A MINIMUM CLEAR OPENING WIDTH OF 22". OPENING SHALL ALSO BE A MINIMUM OF 22" PER CPC 408.5.

SHOWER COMPARTMENTS AND WALLS ABOVE BATHTUBS WITH INSTALLED SHOWER HEADS SHALL BE FINISHED WITH A SMOOTH, NON-ABSORBENT SURFACE TO A HEIGHT NOT LESS THAN 72". (CRC SECTION R307.2)

LOCATION OF VALVES AND HEADS: CONTROL VALVES AND SHOWERHEADS SHALL BE LOCATED ON THE SIDEWALL OF SHOWER COMPARTMENTS OR OTHERWISE ARRANGED SO THAT THE SHOWERHEAD DOES NOT DISCHARGE DIRECTLY AT THE ENTRANCE TO THE COMPARTMENT AND THE BATHER CAN ADJUST THE VALVES PRIOR TO STEPPING INTO THE SHOWER SPRAY. CPC 411.10

SHOWER HEADS, RAIN BARS OR BODY SPRAY NOZZLES MUST BE DESIGNED AND MANUFACTURED TO EMIT A MAXIMUM OF 1.8 GALLONS PER MINUTE OF WATER. ALL SHOWER FIXTURES SHOULD BE INSTALLED WITH A SCALD PROTECTION VALVE RATED AT 1.8 G.P.M. (CGBSC SEC 4.303.1)

VERIFY ALL DETAILS, TILE SIZES, EDGE CONDITIONS, FINISHES, COLORS AND SEALERS WITH OWNERS PRIOR TO ORDERING OR INSTALLING ALL TILE/STONE.


MOUNTING HEIGHTS

SHEET TITLE

1" = 1'-0"

# **DETAILS**


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### DETAILS
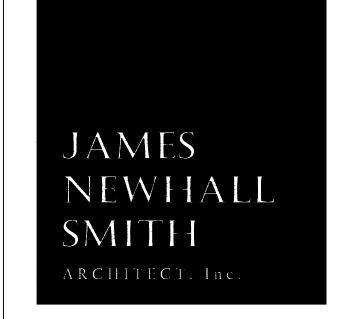
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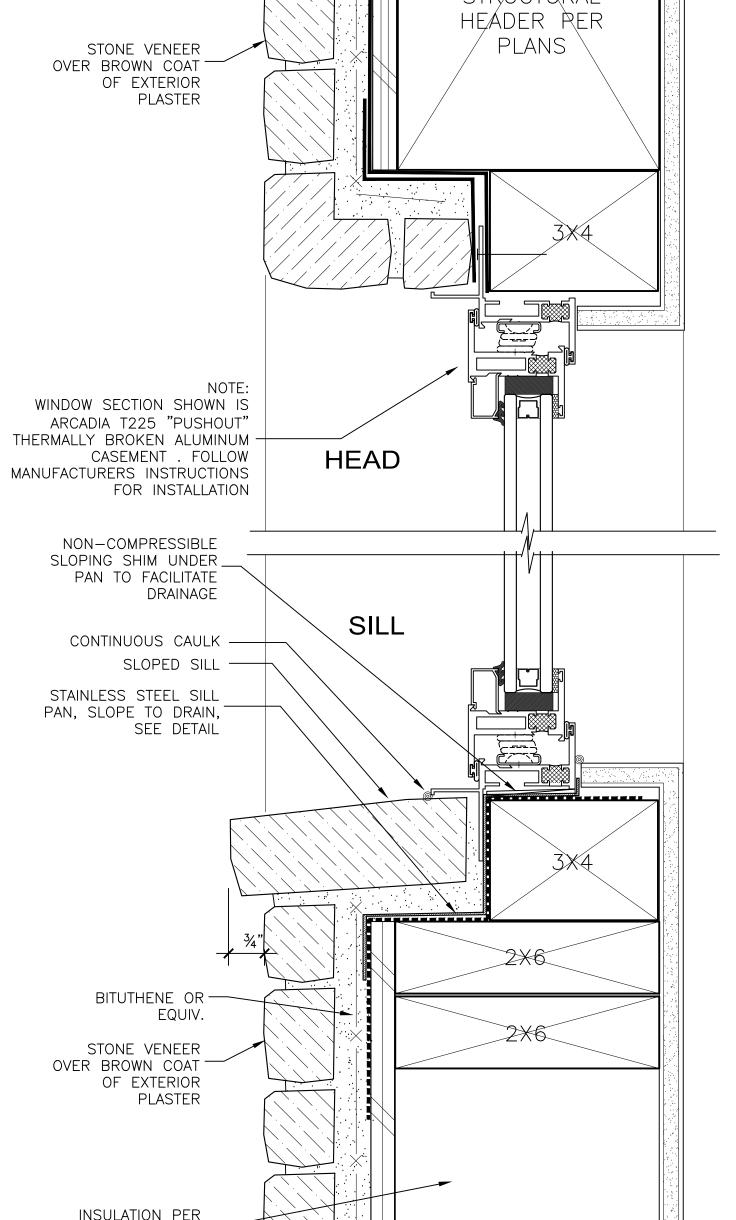
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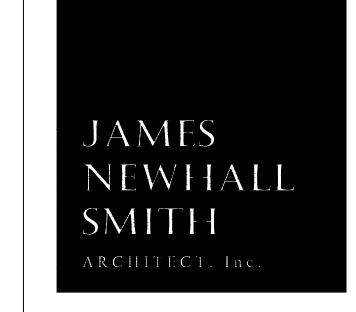
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HENRY BLUESKIN VP100 \_\_ SELF-ADHERED WATER RESISTIVE AIR BARRIER OVER SHEAR PLY, TYP. STRUCTURAL HEADER RER / PLANS \ STONE VENEER
OVER BROWN COAT
OF EXTERIOR
PLASTER WINDOW SECTION SHOWN IS
ARCADIA T225 "PUSHOUT"
THERMALLY BROKEN ALUMINUM—
CASEMENT . FOLLOW
MANUFACTURERS INSTRUCTIONS
FOR INSTALLATION NON—COMPRESSIBLE SLOPING SHIM UNDER \_\_\_ PAN TO FACILITATE DRAINAGE SILL CONTINUOUS CAULK — SLOPED SILL STAINLESS STEEL SILL — PAN, SLOPE TO DRAIN, SEE DETAIL BITUTHENE OR —— EQUIV. STONE VENEER
OVER BROWN COAT
OF EXTERIOR
PLASTER INSULATION PER \_ MECHANICAL SHEETS "PUSHOUT" CASEMENT T225



THERMAL ALUM WINDOW - STONE VENEER

6" = 1'-0"

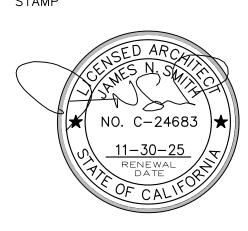

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\_ STRUCTURAL SLAB PER

OUTSWING DOOR -THERMAL ALUMINUM-THRESHOLD AT SLAB TERRACE

STRUCTURAL ENGINEER DWGS

PATIO SUB-SLAB PER STRUCTURAL \_\_

½" MIN. ASPHALT-IMPREGNATED\_

EXPANSION FELT, TYP.


**ARCADIA T225** 

JAMES
NEWHALL
SMITH
ARCHITECT, Inc.

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### **DETAILS**

REVISIONS

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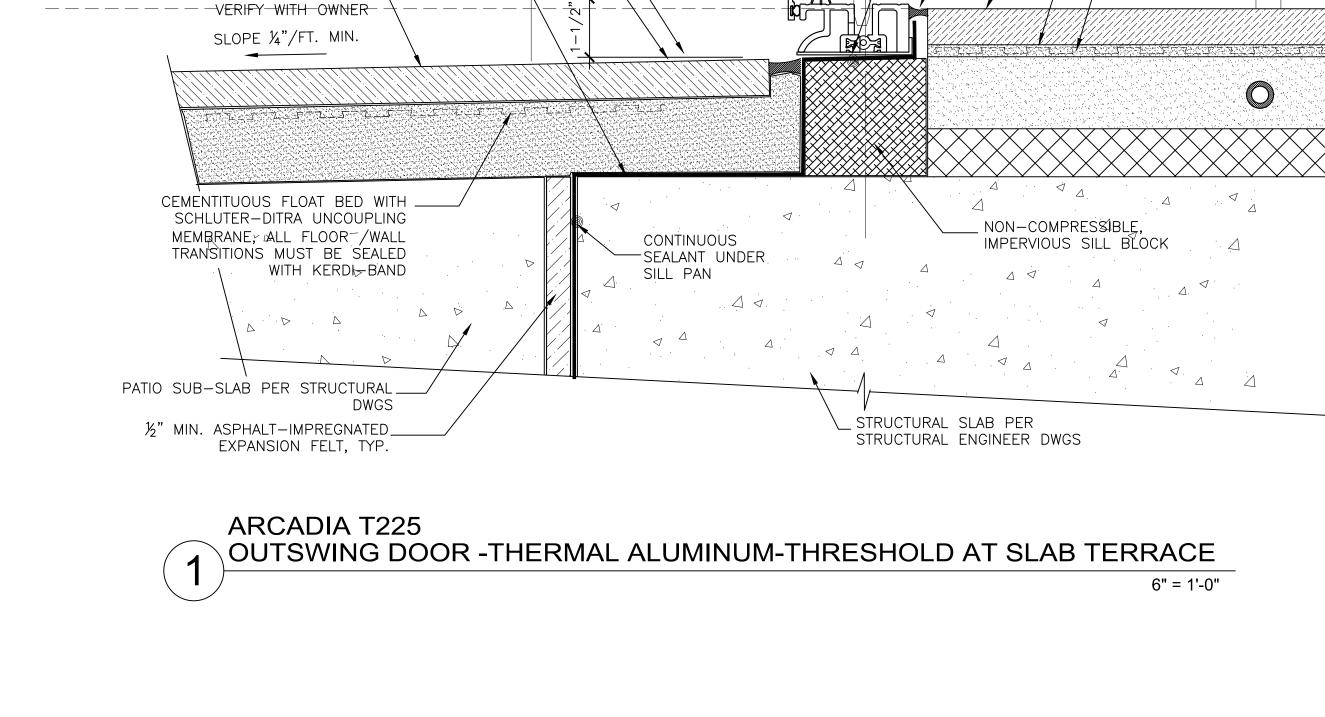
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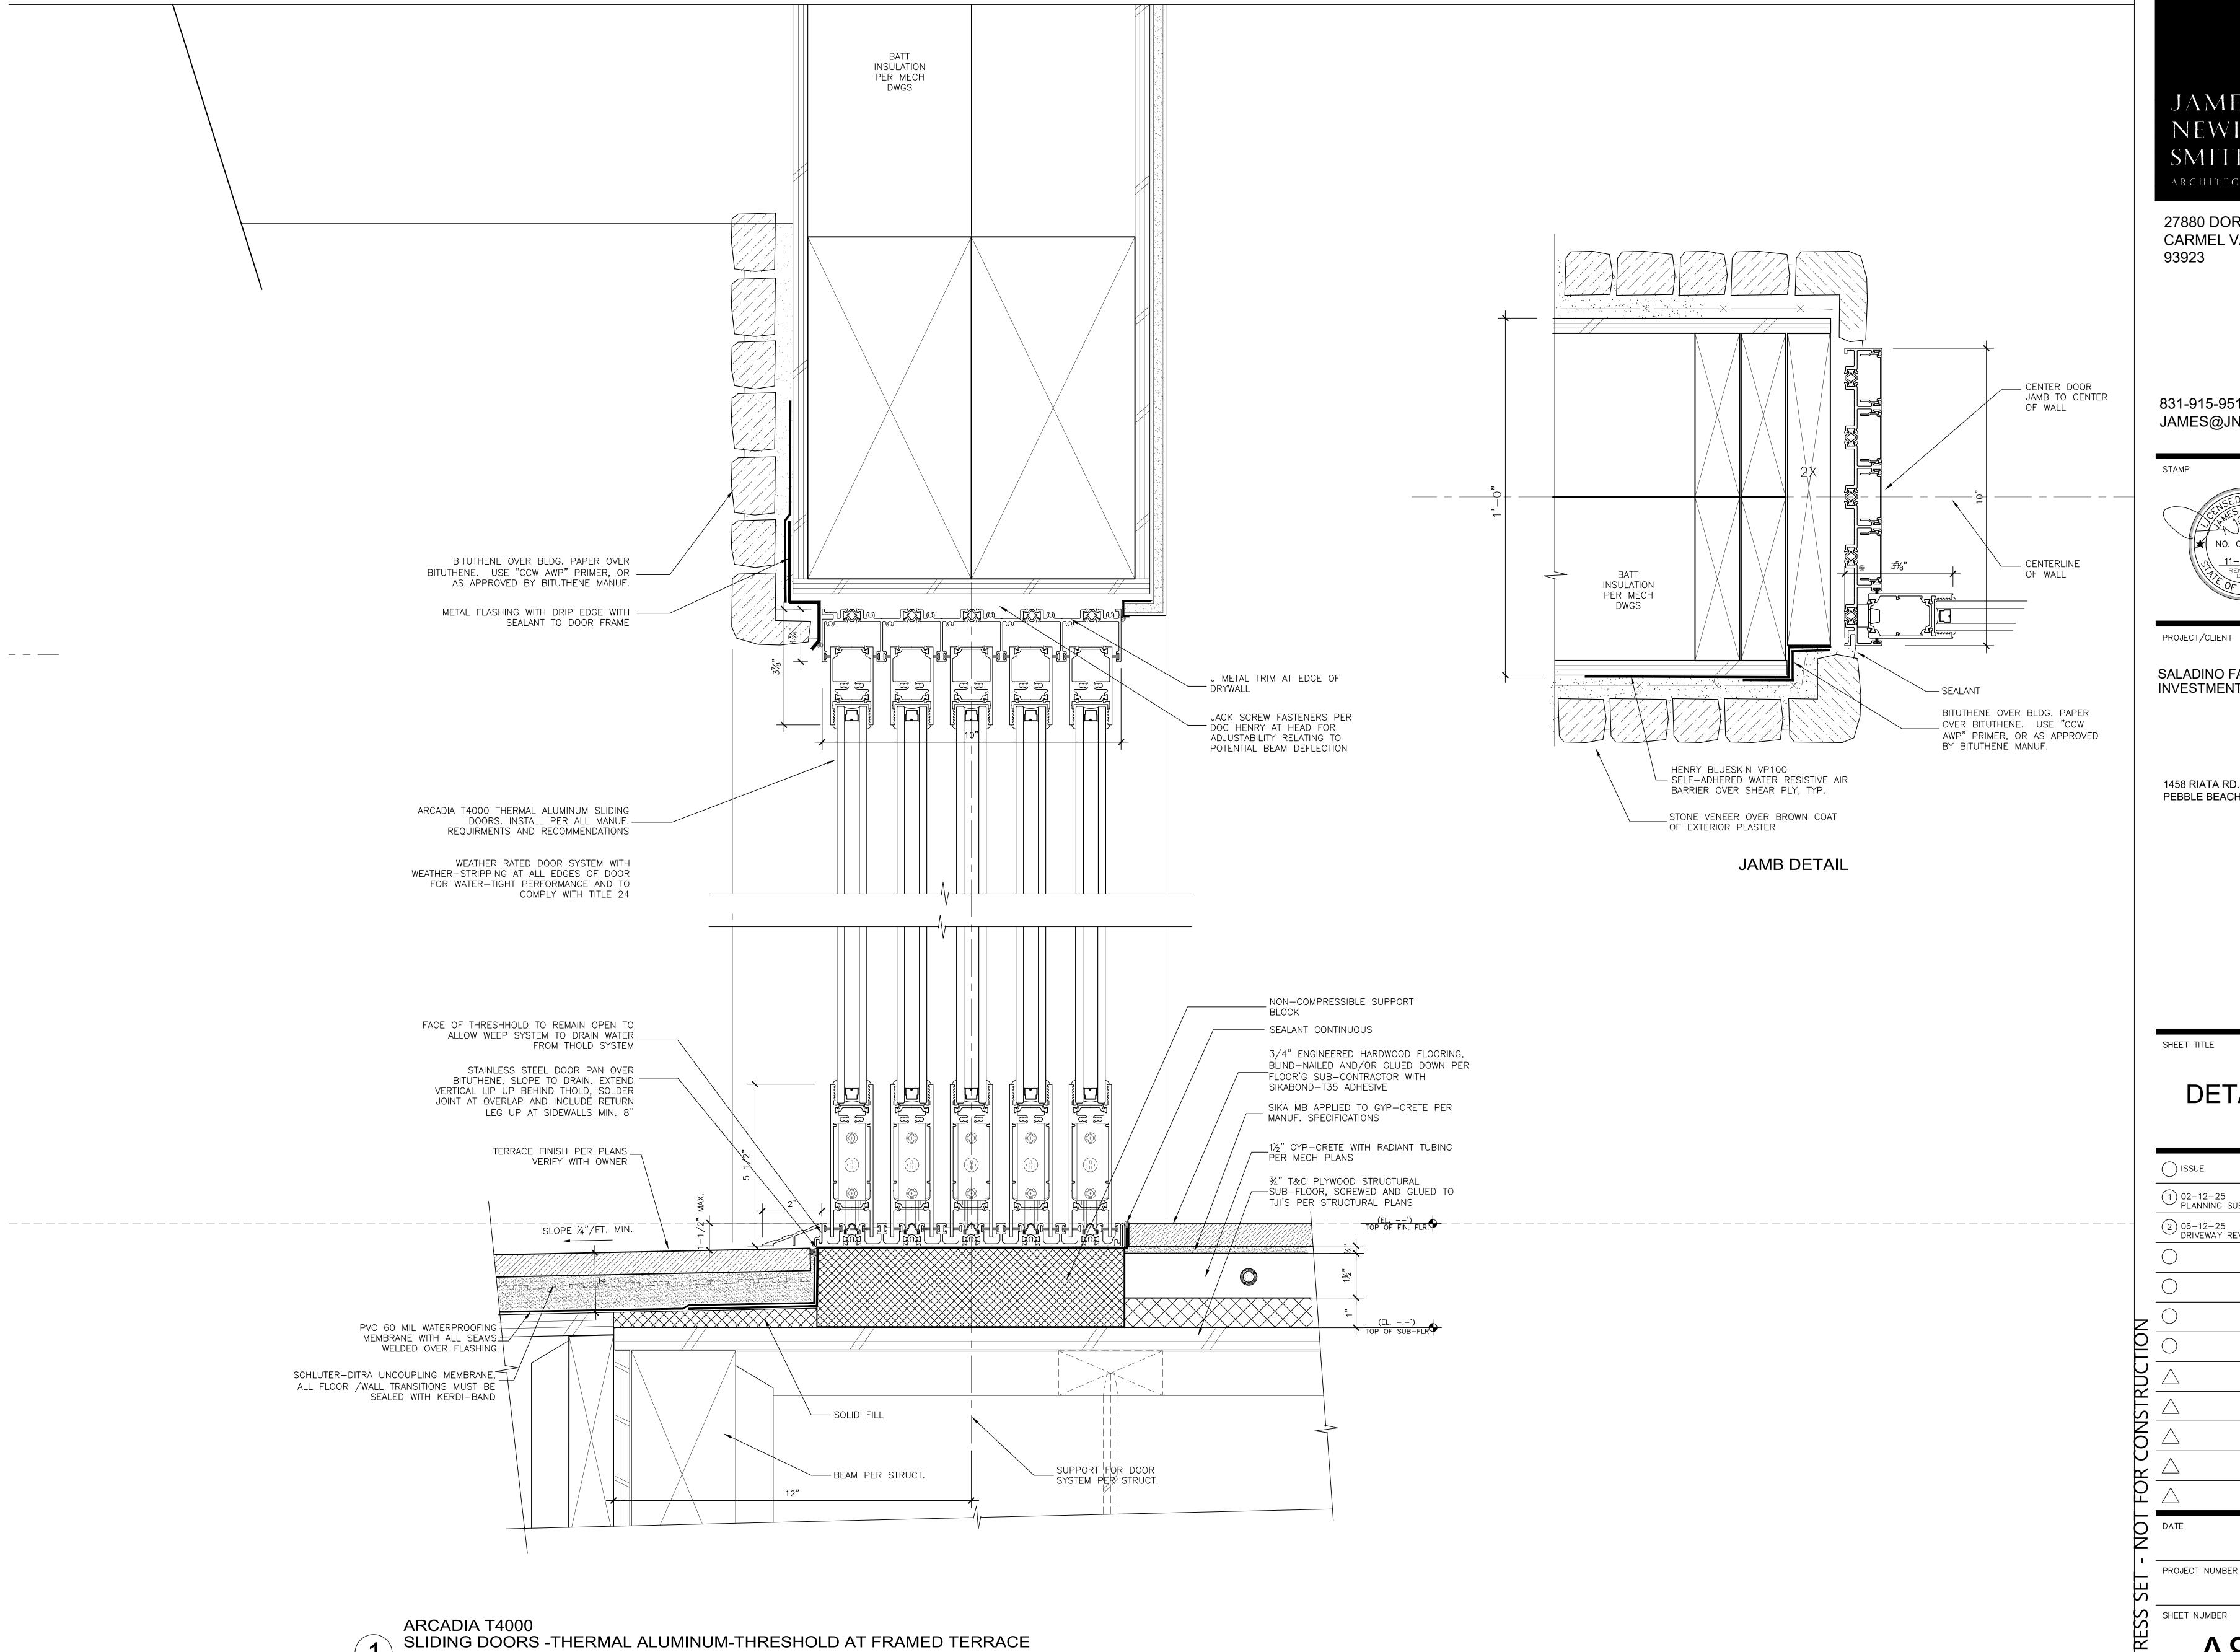
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TERRACE FINISH PER PLANS\_\_\_

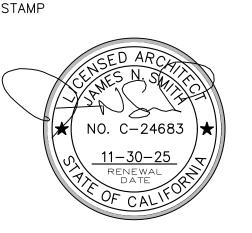\_ ALT: NOBLESEAL TS

COMPOSITE SHEET MEMBRANE



6" = 1'-0"

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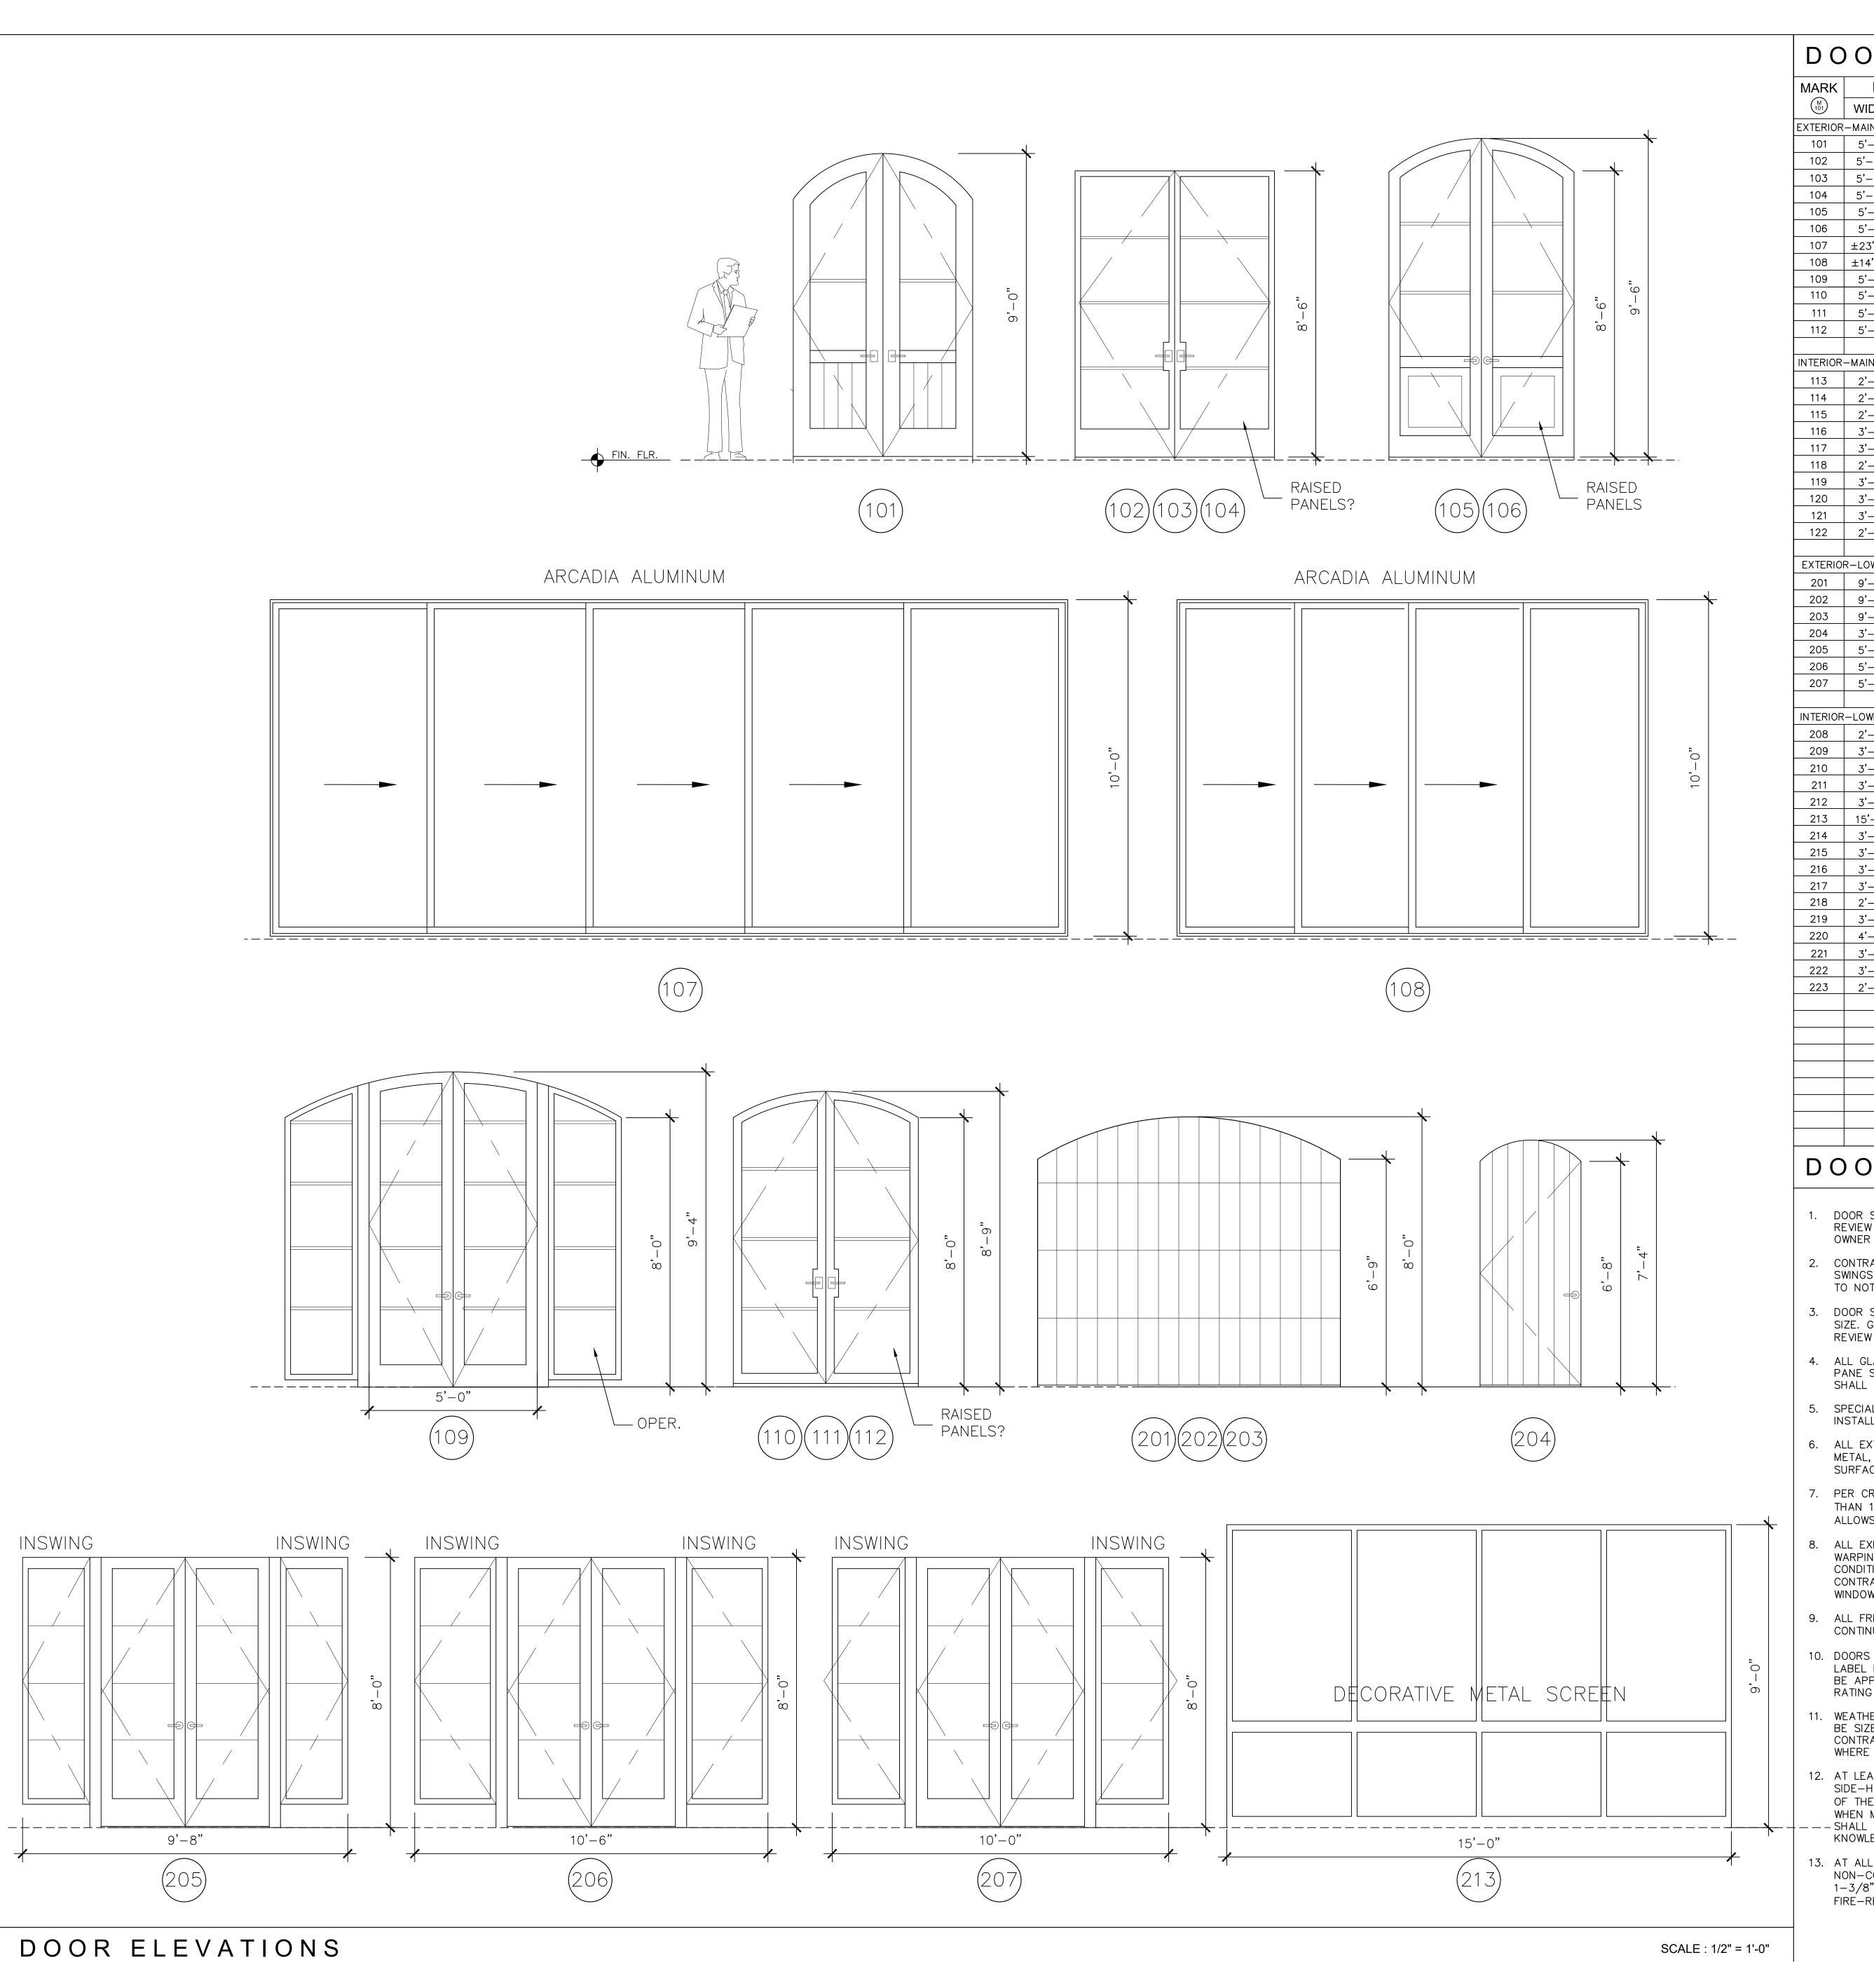
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#### **DETAILS**

REVISIONS ( ) ISSUE 1 02-12-25 PLANNING SUBMITTAL 2 06-12-25 DRIVEWAY REVISIONS




#### DOOR SCHEDULE

MARK	DOC	R SIZE	• •	FINITOLI				
M 101	WIDTH	HEIGHT	THICK.	FINISH MAT'L	CORE	FINISH	ACTION	REMARKS
	-MAIN LEV							DOOR REP TO VERIFY TYPE OF GLASS AND TINT/FILM WITH OWNER RE ALL DOORS, TO MATCH WINDOWS
101	5'-4"	9'-0"	1-3/4"	WD/GLS	WOOD	STAINED	SWING	PAIR, ENTRY DOOR SYSTEM - SEE ELEVS., T
102	5'-11"	8'-6"	_		WOOD	PAINT	SWING	PAIR, T.G., 4 LITES EA.
103	5'-11"	8'-6"	_		WOOD	PAINT	SWING	PAIR, T.G., 4 LITES EA
104	5'-11"	8'-6"	_		WOOD	PAINT	SWING	PAIR, T.G., 4 LITES EA
105	5'-6"	8'-6"	_		WOOD	PAINT	IN-SWING	PAIR, T.G., 4 LITES EA, ARCHED
106	5'-6"	8'-6"	_		WOOD	PAINT	IN-SWING	PAIR, T.G., 4 LITES EA, ARCHED
107	±23'-9"	10'-0"	_		ALUM	ANOD	SLIDING	5 EQUAL PANELS, T.G.,
108	±14'-0"	10'-0"	_		ALUM	ANOD	SLIDING	4 EQUAL PANELS, T.G.,
109	5'-0"	±9'-4"	_		WOOD	PAINT	SWING	PAIR, T.G., 4 LITES EA, SIDELITES, ARCHED
110	5'-6"	±8'-9"	_		WOOD	PAINT	SWING	PAIR, T.G., 4 LITES EA, ARCHED
111	5'-6"	±8'-9"	_		WOOD	PAINT	SWING	PAIR, T.G., 4 LITES EA, ARCHED
112	5'-6"	±8'-9"	_		WOOD	PAINT	SWING	PAIR, T.G., 4 LITES EA, ARCHED
INTERIOR		<u> </u>						
	-MAIN LEV		4 7 /0"			07.111	011#110	
113	2'-6"	8'-0"	1 3/8"	WD	SC	STAIN	SWING	
114	2'-8"	8'-0"	1 3/8"	WD	SC	STAIN	SWING	
115	2'-6"	8'-0"	1 3/8"	WD	SC	STAIN	SWING	
116 117	3'-0" 3'-0"	8'-0" 8'-0"	1 3/8" 1 3/8"	WD WD	SC SC	STAIN STAIN	SWING SWING	
117	2'-8"	8'-0"	1 3/8"	WD WD	SC	STAIN	SWING	
119	3'-0"	8'-0"	1 3/8"	WD	SC	STAIN	SWING	
120	3'-0"	8'-0"	1 3/8"	WD	SC	STAIN	SWING	
121	3'-2"	8'-0"	1 3/8"	WD	SC	STAIN	SWING	PAIR
122	2'-6"	8'-0"	1 3/8"	WD	SC	STAIN	SWING	
			·					
EXTERIOR	R-LOWER L	EVEL						
201	9'-0"	8'-0"	_	WD	SC	STAIN	ROLL-UP	SECTIONAL GARAGE DOOR ARCHED
202	9'-0"	8'-0"	_	WD	SC	STAIN	ROLL-UP	SECTIONAL GARAGE DOOR ARCHED
203	9'-0"	8'-0"	_	WD	SC	STAIN	ROLL-UP	SECTIONAL GARAGE DOOR ARCHED
204	3'-0"	7'-4"	_	WD	SC	PAINT	SWING	ARCHED
205	5'-0"	8'-0"	_	WD	SC	PAINT	SWING	PAIR, T.G., 4 LITES EA, OPER. INSWING SIDEL
206	5'-0"	8'-0"	_	WD	SC	PAINT	SWING	PAIR, T.G., 4 LITES EA, OPER. INSWING SIDEL
207	5'-0"	8'-0"	_	WD	SC	PAINT	SWING	PAIR, T.G., 4 LITES EA, OPER. INSWING SIDEL
	-LOWER LE		4 7 /0"			07.111	011#110	
208	2'-6"	8'-0"	1 3/8"	WD	SC	STAIN	SWING	DOGUET
209	3'-0"	8'-0"	1 3/8"	WD	SC	STAIN	SLIDING	POCKET
210	3'-0"	8'-0"	1 3/8" 1 3/8"	WD	SC	STAIN	SWING	PAIR, ARCHED
211 212	3'-0" 3'-0"	8'-0" 8'-0"	1 3/8"	WD WD	SC SC	STAIN STAIN	SWING SWING	I AIN, ANOTIED
212	3 –0 15'–0"	±9'-2"	-	METAL	SC	PAINT	SLIDING	ORNAMENTAL GATE
214	3'-0"	8'-0"	1 3/8"	WD	SC	STAIN	SWING	ONITABLE TAL VAIL
215	3'-0"	8'-0"	1 3/8"	WD	SC	STAIN	SLIDING	POCKET
216	3'-0"	8'-0"	1 3/8"	WD	SC	STAIN	SWING	
217	3'-0"	8'-0"		GLASS		-	SWING	10' WIDE TEMP. GLASS WALL SYSTEM
218	2'-8"	8'-0"	1 3/8"	WD	SC	STAIN	SWING	
219	3'-0"	8'-0"	1 3/8"	WD	SC	STAIN	SWING	20 MIN. FIRE-RATED DOOR WITH SELF-CLOS
220	4'-0"	8'-0"	1 3/8"	WD	SC	STAIN	SWING	PAIR
221	3'-0"	8'-0"	1 3/8"	WD	SC	STAIN	SWING	
222	3'-0"	8'-0"	1 3/8"	WD	SC	STAIN	SWING	
223	2'-6"	8'-0"	1 3/8"	WD	SC	STAIN	SWING	

#### DOOR SCHEDULE NOTES

- 1. DOOR SCHEDULE PROVIDED ABOVE IS PRELIMINARY IN NATURE. CONTRACTOR AND DOOR SUPPLIER SHALL REVIEW AND COMPILE A COMPLETE AND ACCURATE SCHEDULE BASED UPON FRAMED FIELD CONDITIONS AND OWNER PREFERENCES. CONTRACTOR TO VERIFY ALL ASPECTS OF DOORS WITH OWNER PRIOR TO ORDERING.
- 2. CONTRACTOR SHALL REVIEW ALL FIELD CONDITIONS TO ENSURE THAT THE PROPOSED DOOR SIZES AND SWINGS WILL FUNCTION PROPERLY. IF THERE ARE ANY DISCREPANCIES OR CONFLICTS THE CONTRACTOR IS TO NOTIFY THE ARCHITECT IMMEDIATELY THROUGH A REQUEST FOR INFORMATION (R.F.I.)
- 3. DOOR SIZES SHOWN ARE THE PROPOSED DOOR WIDTH AND HEIGHT DIMENSION, NOT THE ROUGH OPENING SIZE. GENERAL CONTRACTOR TO VERIFY MANUFACTURER'S NEAREST STOCK SIZES FOR ARCHITECT/OWNER TO REVIEW AND APPROVE.
- 4. ALL GLAZING IN DOORS SHALL BE TEMPERED GLASS. EXCEPTION IS FOR SMALL DECORATIVE GLASS OR PANE SANDWICHED BETWEEN TEMPERED LAYERS. INSTALLATION IS PER C.B.C. GLAZING TYPE AND STYLE SHALL MATCH WINDOWS, U.N.O.
- 5. SPECIALTY DOORS SHALL BE COORDINATED WITH GENERAL CONTRACTOR FOR SITE VERIFICATION AND INSTALLATION
- 6. ALL EXTERIOR DOORS SHALL HAVE A COPPER PAN, MIN. 20 OZ. & BRONZE, OR OTHER NON-CORROSIVE METAL, HINGES. OUTSWING DOORS SHALL HAVE A 1/2" MAX CHANGE IN ELEVATION TO THE EXTERIOR FINISH SURFACE.
- 7. PER CRC R311.3.1 LANDINGS OR FINISHED FLOORS AT <u>THE REQUIRED EGRESS DOOR</u> SHALL NOT BE MORE THAN 1½" LOWER THAN THE TOP OF THE THRESHHOLD IF OUT—SWING DOOR. IF IN—SWING, EXCEPTION ALLOWS MAX. 7¾" DROP IN SURFACE
- 8. ALL EXPOSED EDGES OF DOOR(S) INCLUDING TOP TO BE SEALED TO PREVENT MOISTURE PENETRATION AND WARPING. DOORS ARE TO BE STORED VERTICALLY AT JOB SITE AND OUT OF ALL INCLEMENT WEATHER CONDITIONS AND TO BE HUNG AS QUICKLY AS POSSIBLE, ONCE REACHING THE JOB SITE. IT IS THE CONTRACTOR'S RESPONSIBILITY TO MINIMIZE THE AMOUNT OF TIME FOR ON—SITE STORAGE OF DOORS AND WINDOWS PRIOR TO INSTALL.
- 9. ALL FRENCH DOORS ARE TO HAVE DEAD BOLTS AND THREE WAY CONNECTING HARDWARE TO MAXIMIZE CONTINUOUS SEAL AGAINST WIND/WEATHER.
- 10. DOORS REQUIRED TO HAVE 20 MINUTE RATING TO BE MIN. 1 3/8" SOLID WOOD AND SHALL BEAR THE U.L. LABEL NO RAISED PANELS OR OTHER FEATURES MAY REDUCE THIS MINIMUM THICKNESS. SHOULD VENEERS BE APPLIED TO PRE-MANUFACTURED 20 MIN. RATED DOORS, CARE IS TO BE TAKEN NOT TO VIOLATE THE RATING DURING APPLICATION.
- 11. WEATHER—STRIPING OF EXTERIOR DOORS SHALL BE CONTINUOUS ON ALL SIDES OF EACH DOOR AND SHALL BE SIZED, DESIGNED, AND FITTED TO PROVIDE FULL WATER—TIGHTNESS AGAINST WATER AND DRIVING RAIN. CONTRACTOR SHALL WATER TEST A MINIMUM OF ONE DOOR AFTER INSTALLATION ON SIDE OF RESIDENCE WHERE EXPOSURE TO WEATHER IS GREATEST, AND REPORT FINDINGS TO OWNER AND ARCHITECT.
- 12. AT LEAST ONE EGRESS DOOR SHALL BE PROVIDED FOR ALL DWELLING UNITS. THE DOOR SHALL BE SIDE—HINGED, AND SHALL PROVIDE A MINIMUM CLEAR WIDTH OF 32" WHEN MEASURED BETWEEN THE FACE OF THE DOOR AND THE STOP, WHEN OPEN TO 90 DEGREES. THE MINIMUM CLEAR HEIGHT SHALL BE 78" WHEN MEASURED FROM THE TOP OF THE THRESHOLD TO THE BOTTOM OF THE STOP. ALL EGRESS DOORS———SHALL BE READILY OPENABLE FROM THE INSIDE OF THE DWELLING WITHOUT THE USE OF A KEY OR SPECIAL KNOWLEDGE OR EFFORT, PER CRC R311.2.
- 13. AT ALL STATE RESPONSIBILITY AREAS (SRA) EXTERIOR DOOR ASSEMBLIES SHALL BE APPROVED NON-COMBUSTIBLE CONSTRUCTION, OR SOLID CORE WOOD HAVING STILES AND RAILS NOT LESS THAN 1-3/8" THICK WITH INTERIOR FIELD PANEL THICKNESS NO LESS THAN 1 1/4" THICK, OR SHALL HAVE A FIRE-RESISTANCE RATING OF NOT LESS THAN 20 MINUTES. (CRC 327 WILDLAND URBAN INTERFACE)

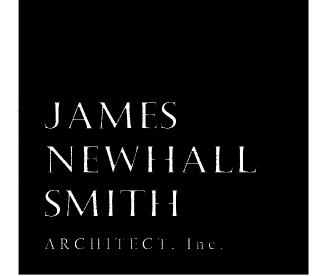

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PROJECT/CLIENT

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SHEET TITLE

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## DOOR SCHEDULE

REVISIONS


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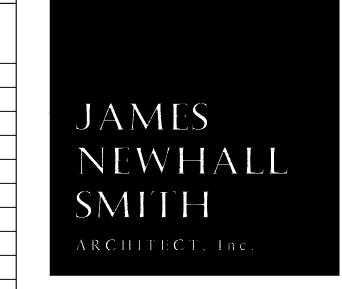
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# WINDOW SCHEDULE

MARK	UNIT SIZE	HEAD HEIGHT	TYPE OF OPERABILITY	FRAME MATERIAL	REMARKS	
	WIDTH X HEIGHT	11210111	OT ETV (BIETT)	WIN CT ET CITY CE	WINDOW REP TO VERIEY TYPE OF GLASS AND TINT/FILM WITH OWNER	
					WINDOW REP TO VERIFY TYPE OF GLASS AND TINT/FILM WITH OWNER RE ALL WINDOWS, SEE "GENERAL" NOTE #4 BELOW	
MAIN LEVEL						
M <sub>O</sub>	24" DIA.	15'-4"	FIXED	STEEL	4 LITES, ARCADIA STEEL	
M 02	3'-0"X7'-8"	8'-9"	FIXED	STEEL	T.G., ARCADIA STEEL	
M 03	2'-0"X4'-0"	7'-2"	CASEMENT	WOOD	4 LITES,	
M 04	5'-0"X5'-6"	9'-0"	FIXED	WOOD		
М 05	2'-0"X4'-0"	8'-0"	CASEMENT	WOOD	3 LITES	
M 06	3'-6"X4'-0"	8'-0"	DBL. CASEMENT	WOOD	3 LITES EA.	
M 07	9'-8"X5'-0"	8'-0"	CASE-FIX-CASE	WOOD	3 LITES EA. CASE	
M 08	4'-6"X5'-0"	8'-0"	DBL. CASEMENT	WOOD	3 LITES EA. CASE	
M 09	7'-0"X6'-0"	8'-0"	FIXED	WOOD	T.G.	
M 10	4'-0"X5'-0"	8'-0"	FIXED	WOOD	T.G.	
M 11	2'-0"X4'-6"	8'-0"	CASEMENT	WOOD		
M 12	2'-6"X8'-2"	9'-3"	FIXED	STEEL	T.G., ARCADIA STEEL	
M 13	1'-8"X6'-0"	7'-1"	FIXED	STEEL	T.G., DECORATIVE GLASS ARCADIA STEEL	
M 14	1'-8"X6'-0"	7'-1"	FIXED	STEEL	T.G., DECORATIVE GLASS ARCADIA STEEL	
M 15	1'-8"X6'-0"	7'-1"	FIXED	STEEL	T.G., DECORATIVE GLASS ARCADIA STEEL	
M 16	2'-0"X4'-7"	8'-3"	FIXED	STEEL	T.G., DECORATIVE GLASS ARCADIA STEEL	
OWER LEVEL						
(b)	7'-0"X4'-0"	7'-0"	FIXED	WOOD		
Ĺ 02	4'-6"X5'-0"	8'-0"	DBL. CASEMENT	WOOD	3 LITES EA. CASE	
L 03	6'-6"X5'-0"	8'-0"	CASE-FIX-CASE	WOOD	3 LITES EA. CASE	
L 04	3'-0"X4'-6"	8'-0"	CASEMENT	WOOD		
L 05	3'-0"X4'-6"	8'-0"	CASEMENT	WOOD		



27880 DORRIS DR. #200 CARMEL VALLEY, CA.

831-915-9518 JAMES@JNSARCH.COM

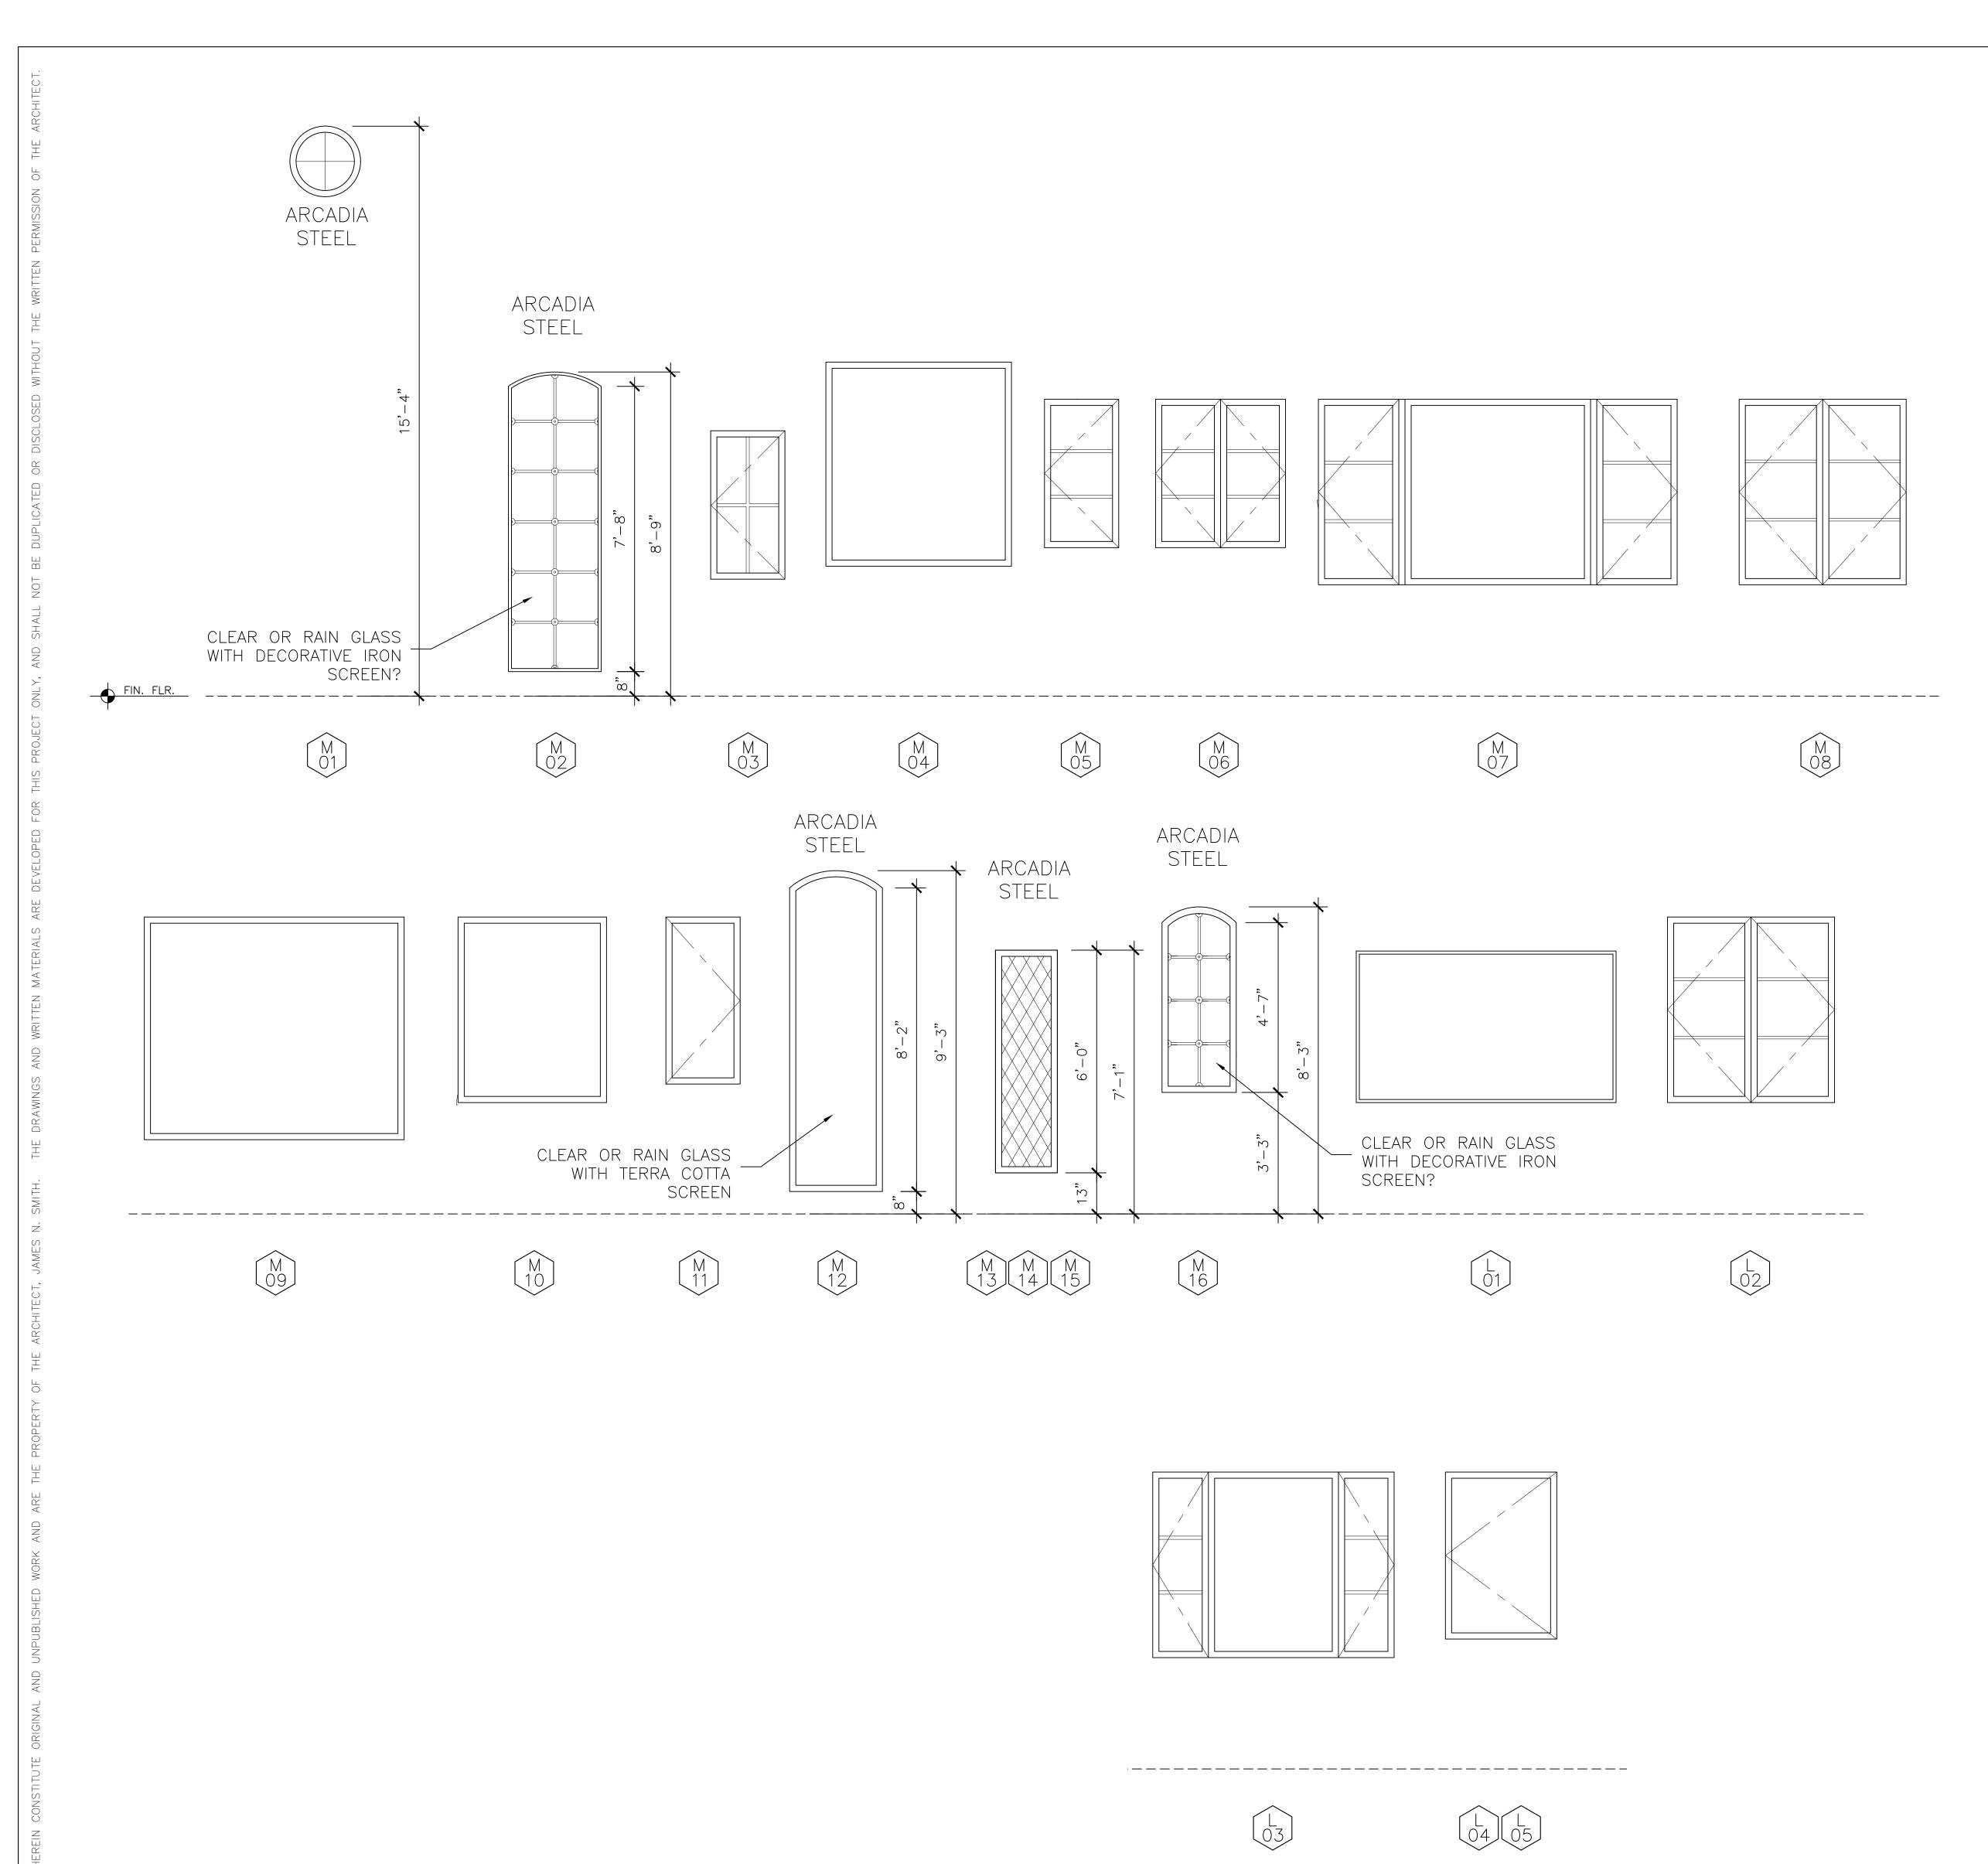PROJECT/CLIENT

SALADINO FAMILY INVESTMENTS, LLC

1458 RIATA RD. PEBBLE BEACH, CA. 93955

SHEET TITLE

( ) ISSUE

(1) 02-12-25

2 06-12-25

PLANNING SUBMITTAL

DRIVEWAY REVISIONS

WINDOW

SCHEDULE

/\ REVISIONS

#### WINDOW SCHEDULE NOTES

#### **GENERAL**


- WINDOW SCHEDULE PROVIDED ABOVE IS PRELIMINARY IN NATURE. CONTRACTOR AND WINDOW SUPPLIER SHALL COMPILE A COMPLETE AND ACCURATE SCHEDULE BASED UPON FRAMED FIELD CONDITIONS OF PROJECT AND OWNER CHANGES/PREFERENCES. SPECIALTY WINDOWS MUST BE COORDINATED WITH THE GENERAL CONTRACTOR.
- 2. WINDOW DIMENSIONS ARE PROPOSED UNIT SIZES. GENERAL CONTRACTOR IS TO VERIFY ALL PROPOSED WINDOW SIZES WITH SITE CONDITIONS AND FOR MANUFACTURER'S NEAREST STOCK SIZES, WHEN APPLICABLE. ALL WINDOW SIZES, SHAPES, COLORS, HARDWARE, SCREENS, GLAZING, ETC. MUST BE APPROVED BY OWNER PRIOR TO ORDERING. CONTRACTOR SHALL PROVIDE ARCHITECT COMPLETE STRUCTURAL WINDOW SHOP DRAWINGS FOR REVIEW.
- 3. ALL WINDOWS ARE TO BE DOUBLE GLAZED UNLESS OTHERWISE NOTED, SEE TITLE 24 CALCS FOR REQUIRED MIN. VALUES
- 4. DUAL GLAZING IS TO BE LOW-E CARDINAL "270" GLAZING. OWNERS TO VERIFY WITH WINDOW REP WHICH, IF ANY, WINDOWS ARE TO BE "366" GLASS OR HAVE TINT WITHIN GLAZING, DUE TO SUN EXPOSURE. FILM IS NOT RECOMMENDED FOR DUAL GLAZED UNITS
- 5. ALL WINDOWS SHALL HAVE A SOLDIERED COPPER PAN, MINIMUM 20 OZ., WITH MOISTSTOP OR EQUIVALENT WATERPROOFING SYSTEM. GALVANIZED IRON IS ACCEPTABLE IN NON-COASTAL ENVIRONMENTS. SEE DETAIL.
- 6. WEATHER-STRIPING OF ALL WINDOWS SHALL BE CONTINUOUS ON ALL SIDES OF EACH WINDOW AND SHALL BE SIZED, DESIGNED, AND FITTED TO PROVIDE FULL WATER-TIGHTNESS AGAINST WATER AND DRIVING RAIN. CONTRACTOR SHALL WATER TEST A MINIMUM OF ONE WINDOW AFTER INSTALLATION ON SIDE OF RESIDENCE WHERE EXPOSURE TO WEATHER IS GREATEST, AND REPORT FINDINGS TO OWNER AND ARCHITECT.
- WINDOWS WHICH EXCEED STANDARD SIZES SHALL BE VERIFIED BY WINDOW SUPPLIER FOR ENGINEERING AND WIND LOAD AT GIVEN PROJECT LOCATION AND PLACEMENT OF WINDOW(S) ON RESIDENCE (EXPOSURE)
- 8. REQUIRED NATURAL LIGHT FOR EVERY SPACE INTENDED FOR HUMAN OCCUPANCY SHALL HAVE GLAZED OPENINGS WITH AN AREA OF NOT LESS THAN 8% OF ROOM FLOOR AREA. (CRC R303.1).
- 9. REQUIRED NATURAL VENTILATION IN OCCUPIED SPACES THROUGH OPENABLE EXTERIOR WALL OPENINGS SHALL BE AN AREA NOT LESS THAN 4% OF THE AREA BEING VENTILATED. (CRC R303.1).


- 1. BASEMENTS AND EACH SLEEPING ROOM SHALL HAVE MIN. ONE EGRESS WINDOW WITH A NET CLEAR OPENABLE AREA OF 5.7 S.F., WITH THE MIN. NET CLEAR OPENABLE HEIGHT OF 24" AND THE MIN. NET CLEAR WIDTH SHALL BE 20". THE SILL HEIGHT SHALL BE MAX. 44" A.F.F. (CBC 1029.2 & 1029.3). EXCEPTIONS: BASEMENTS WITH A CEILING OF LESS THAN 80" OR LESS THAN 200 S.F. IN FLOOR AREA SHALL NOT BE REQUIRED TO HAVE AN EMERGENCY ESCAPE AND RESCUE WINDOWS (CRC R310.1).
- 2. ALL CASEMENT WINDOWS USED IN BEDROOMS AS EMERGENCY EGRESS MUST BE "BREAK AWAY" TYPE TO ENSURE COMPLETE 🔀 OPENABLE AREA FOR ACCESS.
- 3. ALL GLAZING SUBJECT TO HUMAN IMPACT IN HAZARDOUS LOCATIONS AS DEFINED IN CRC R308.4 SHALL MEET MINIMUM REQUIREMENTS OF CRC R308.3.1, INCLUDING GLASS MIRRORS, SHALL BE TEMPERED GLASS OR WIRE SAFETY GLASS (CBC
- 4. GLAZING IN AN INDIVIDUAL, FIXED OR OPERABLE PANEL ADJACENT TO A DOOR WHERE THE NEAREST VERTICAL EDGE OF THE GLAZING IS WITHIN A 24" ARC OF EITHER VERTICAL EDGE OF THE DOOR IN A CLOSED POSITION AND WHERE THE BOTTOM EXPOSED EDGE OF THE GLAZING IS LESS THAN 60" ABOVE THE FLOOR OR WALKING SURFACE SHALL BE SAFETY GLASS (CRC 308.4.2)
- 5. ALL OPERABLE WINDOWS ABOVE ADJACENT GRADE BY 6' OR MORE AND LOCATED WITHIN 36" OF THE FINISHED FLOOR, OR OTHERWISE VULNERABLE TO A PERSON FALLING OUT, SHALL HAVE SUITABLE RESTRAINT BAR(S) INSTALLED. THE BUILDING OWNER CAN ELECT NOT TO INSTALL RESTRAINTS AT THEIR SOLE DISCRETION. INSECT SCREENS DO NOT OFFER PROTECTION -AGAINST PERSONS FALLING OUT OF A WINDOW.
- 6. WINDOWS THAT MEET ALL CONDITIONS SHALL BE TEMPERED PER CRC R308.4.3: WHERE EXPOSED AREA OF INDIVIUAL PANE IS GREATER THAN 9 SQUARE FEET, EXPOSED BOTTOM EDGE IS LESS THAN 18" ABOVE THE FLOOR, EXPOSED TOP EDGE IS GREATER THAN 36" ABOVE THE FLOOR, AND ONE OR MORE WALKING SURFACES ARE WITHIN 36", MEASURED HORIZONTALLY AND IN A STRAIGHT LINE, OF THE GLAZING, SHALL BE TEMPERED GLAZING.(R308.4.3)
- 7. GLAZING IN WET AREAS WHERE THE BOTTOM EXPOSED EDGE OF THE GLAZING IS LESS THAN 60" MEASURED VERTICALLY ABOVE ANY STANDING OR WALKING SURFACE SHALL BE TEMPERED.


1. FOR PROJECTS LOCATED WITHIN WILDLAND URBAN INTERFACE (W.U.I.) ZONES, ADDITIONAL REQUIREMENTS SHALL APPLY SUCH AS THE TEMPERING OF THE OUTER-MOST PANE OF GLASS PER CRC R327.8


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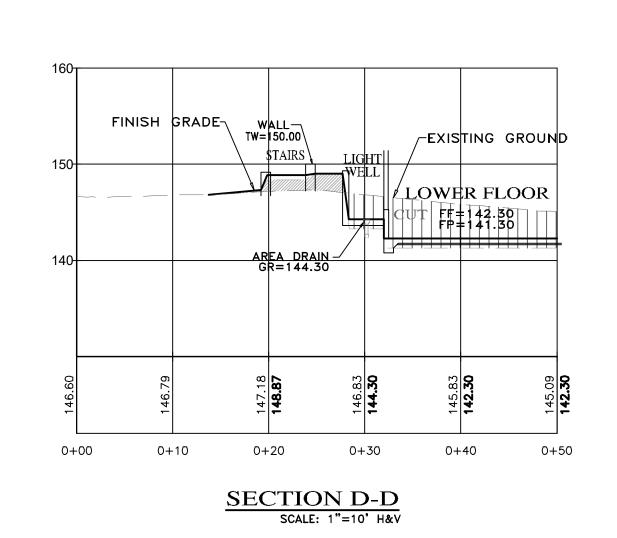
SHEET NUMBER




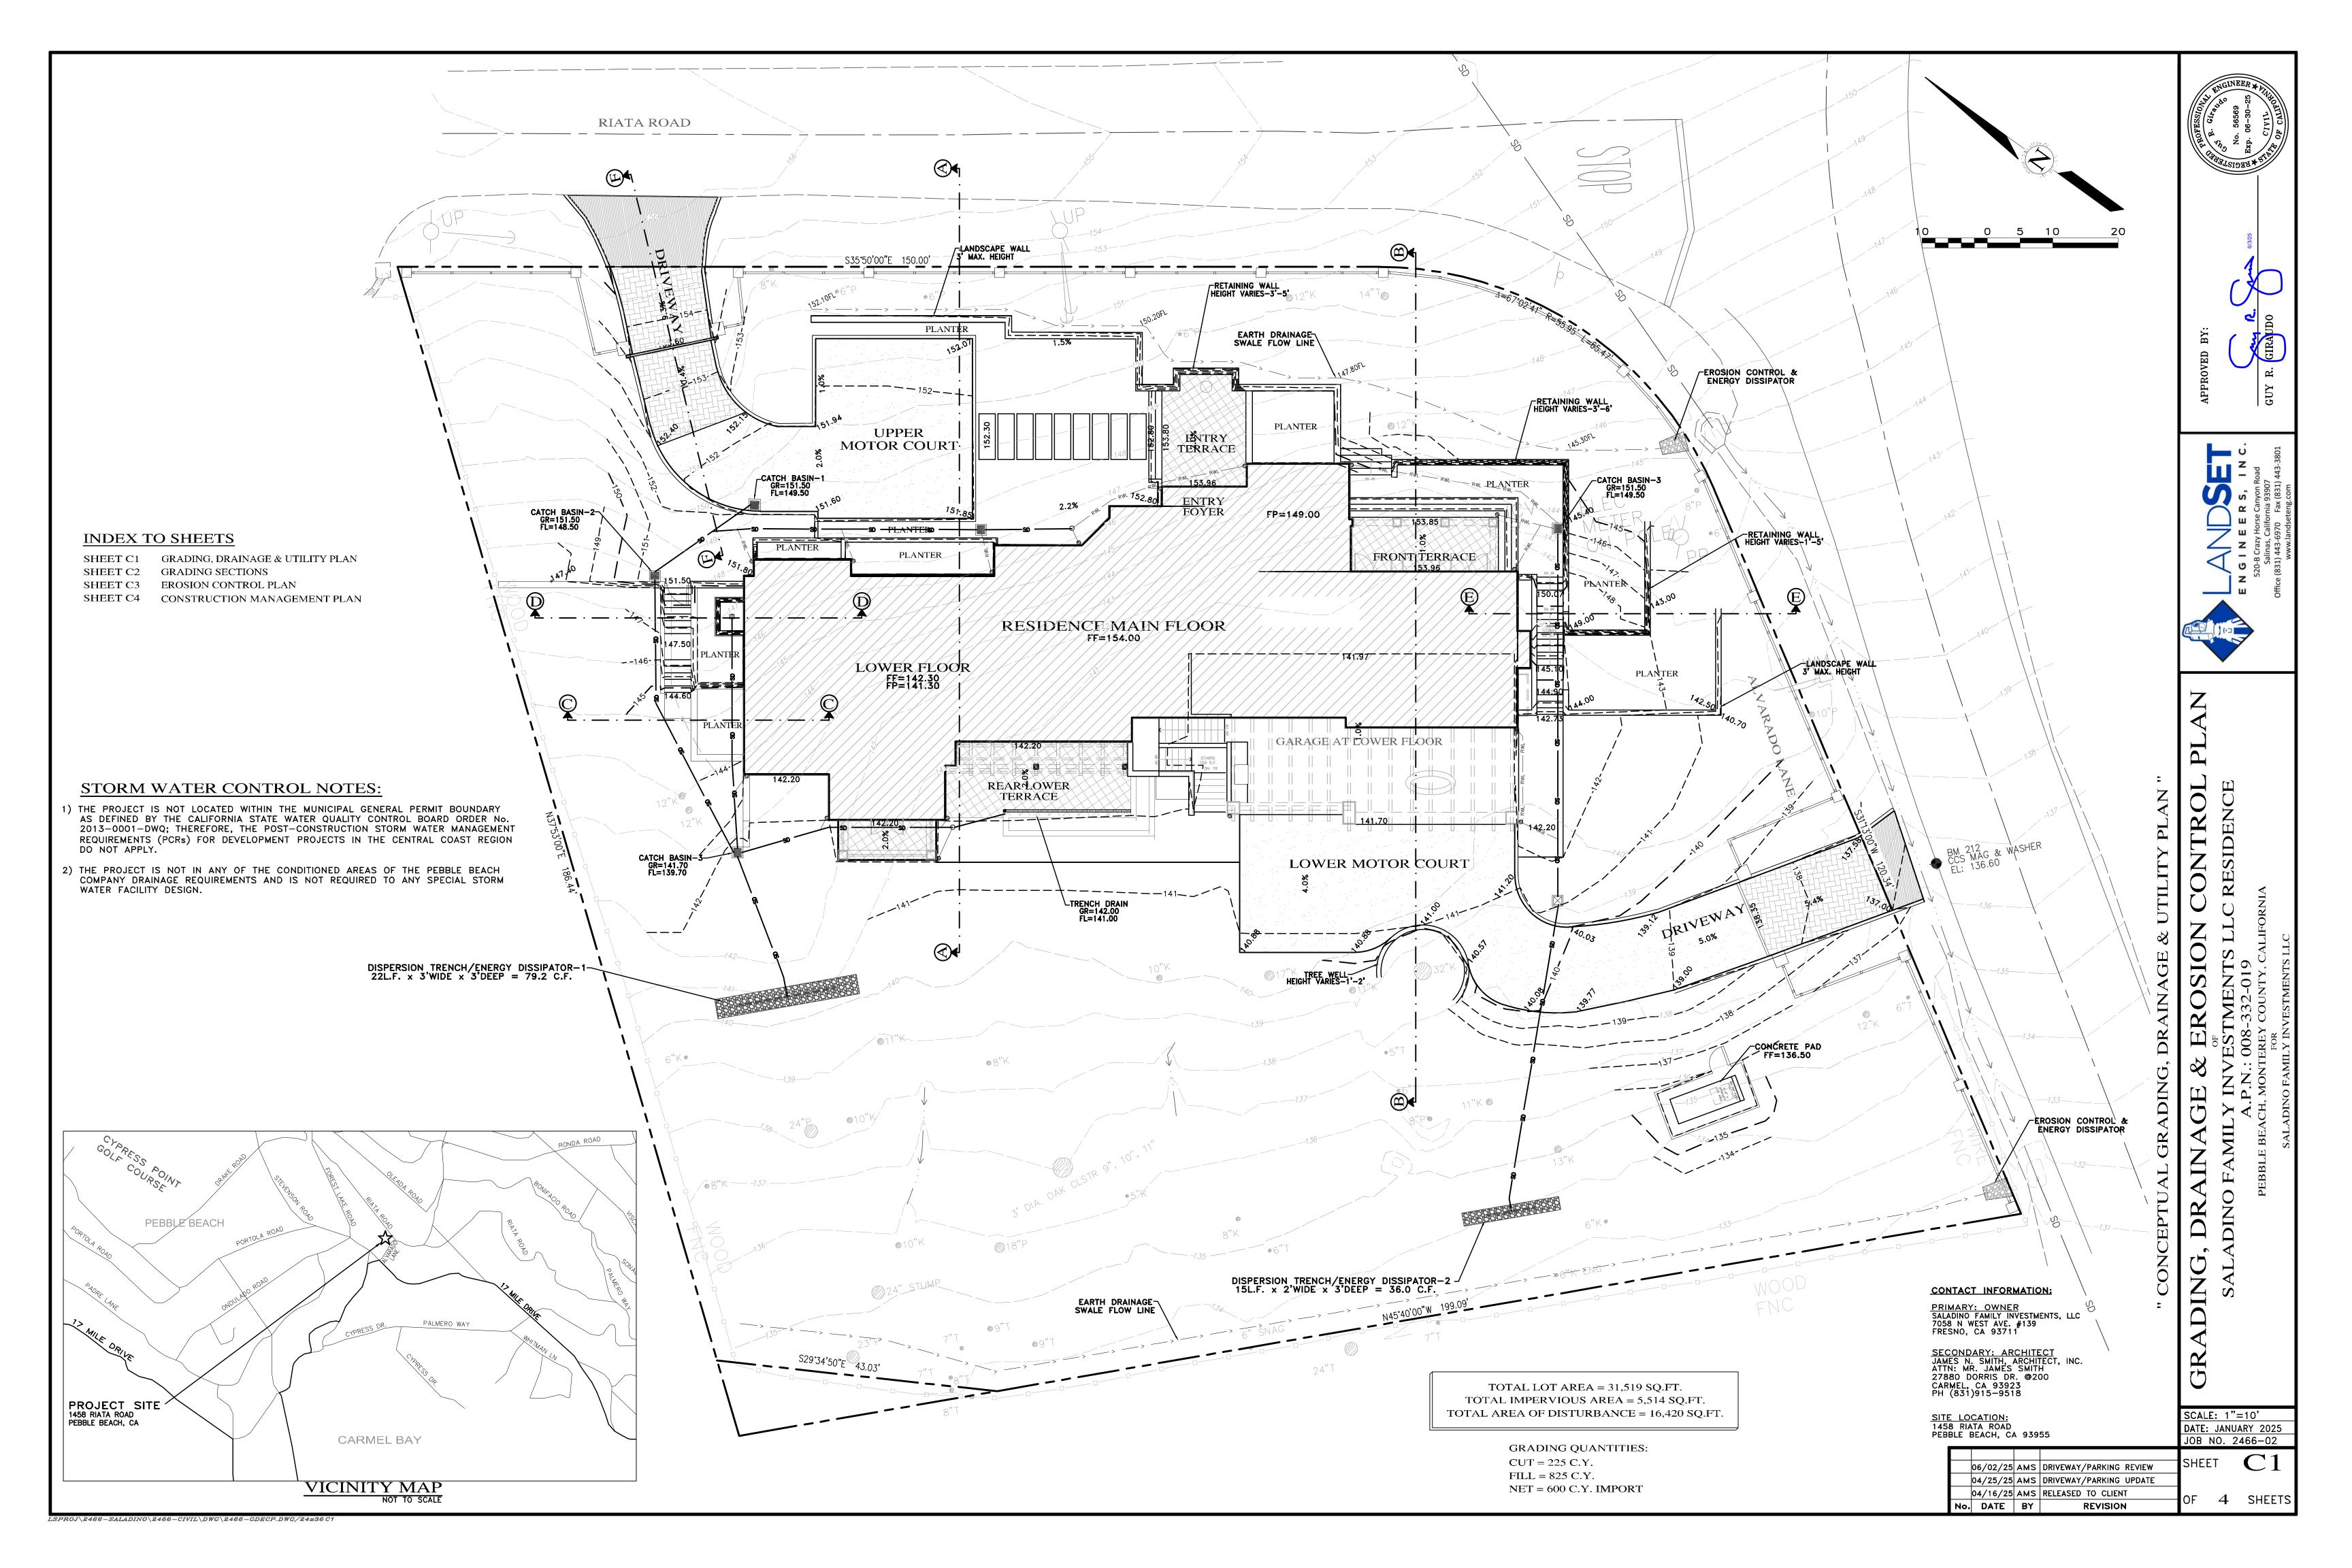


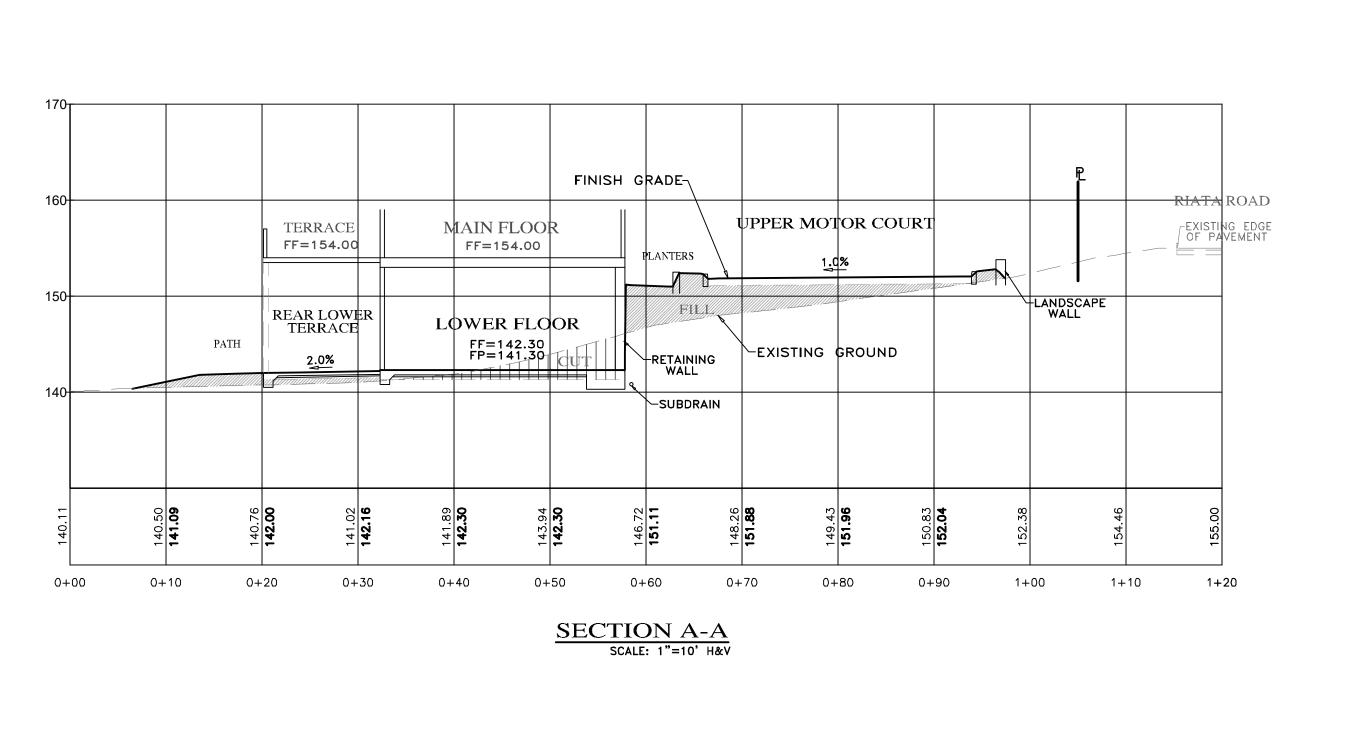

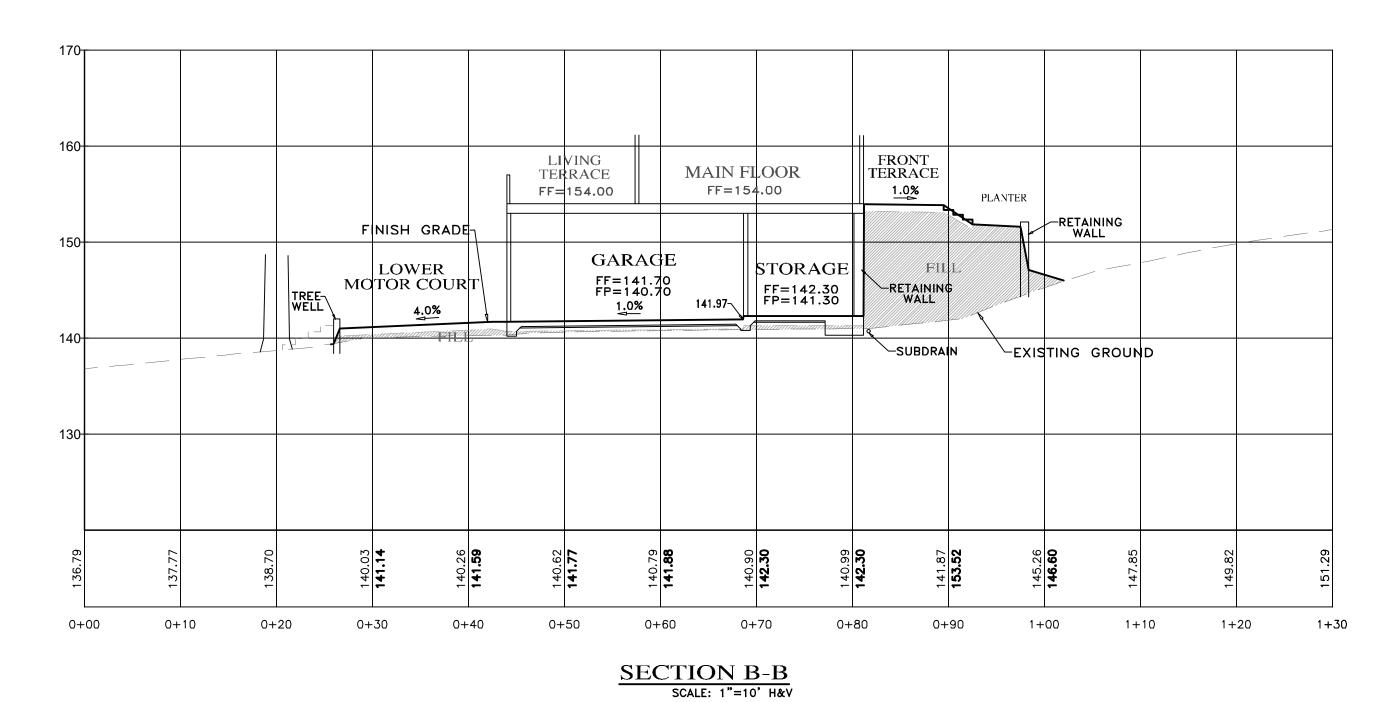

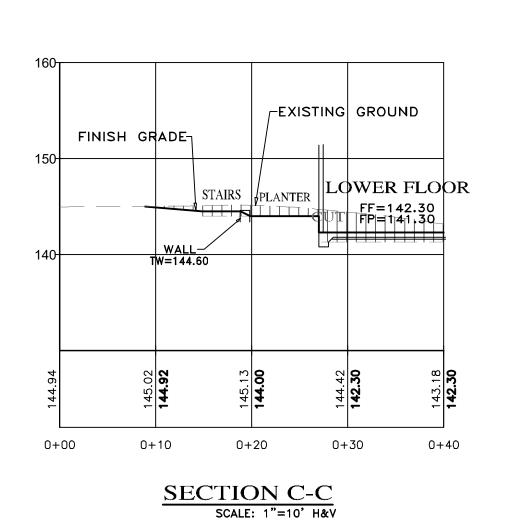

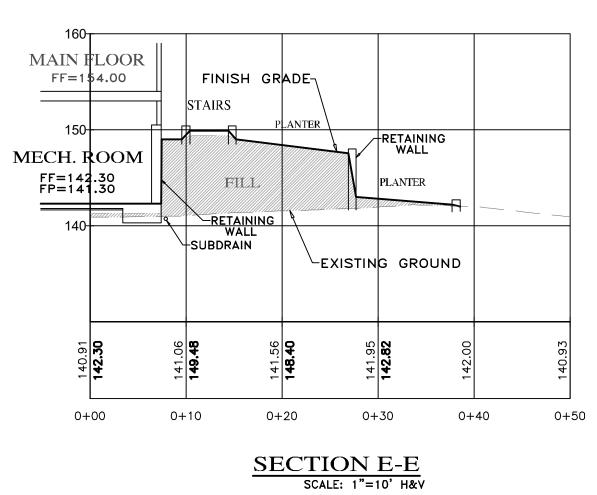

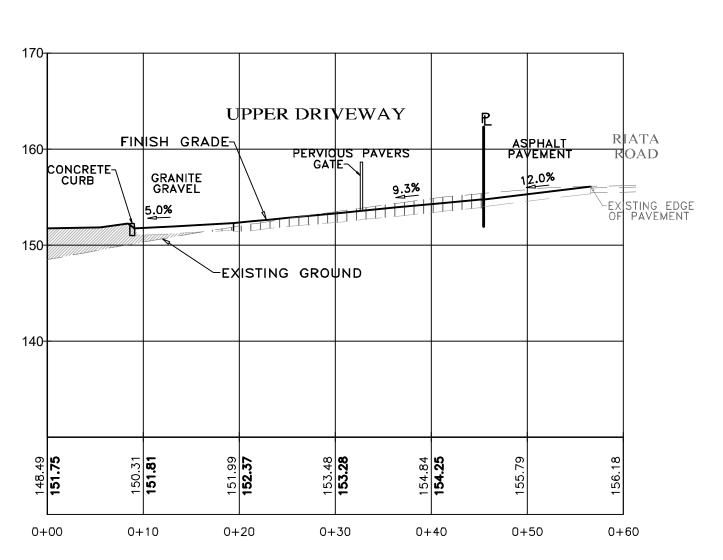

- SEE ARCHITECTURAL AND STRUCTURAL PLANS FOR LAYOUT OF FOUNDATION COMPONENTS.
   OVEREXCAVATION ON BUILDING AREAS PER SOILS ENGINEERING INVESTIGATION REPORT
- FOR SECTION LOCATIONS, SEE SHEET C3 "GRADING, DRAINAGE & UTILITY PLAN".

SCALE: 1"=10' H&V DATE: JANUARY 2025 JOB NO. 2466-02

06/02/25 AMS DRIVEWAY/PARKING REVIEW 04/25/25 AMS DRIVEWAY/PARKING UPDATE 04/16/25 AMS RELEASED TO CLIENT OF 4 SHEETS No. DATE BY


**UPPER DRIVEWAY PROFILE** SCALE: 1"=10' H&V


 $LSPROJ \backslash 2466 - SALADINO \backslash 2466 - CIVIL \backslash DWG \backslash 2466 - GDECP.DWG/24x36C2$ 



#### **EROSION & SEDIMENT CONTROL NOTES:**

- 1) ALL EROSION CONTROL MEASURES SHALL CONFORM WITH THE COUNTY OF MONTEREY EROSION
- 2) EROSION AND SEDIMENT CONTROL MEASURES SHALL BE IN EFFECT FOR ANY CONSTRUCTION DURING THE RAINY SEASON, APPROX. OCTOBER 15 TO APRIL 15. EROSION CONTROL PLAN SHALL BE PREPARED AND SUBMITTED FOR APPROVAL BY SEPT. 15 OF ANY OR EACH CALENDAR YEAR THAT CONSTRUCTION MAY EXTEND BEYOND OCTOBER 15.
- 3) ALL SLOPES SHALL BE PROTECTED WITH STRAW MULCH OR SIMILAR MEASURES TO PROTECT AGAINST EROSION UNTIL SUCH SLOPES ARE PERMANENTLY STABILIZED.
- 4) RUNOFF SHALL BE DETAINED OR FILTERED BY BERMS, VEGETATED FILTER STRIPS, AND/OR CATCH BASINS TO PREVENT THE ESCAPE OF SEDIMENT FROM THE SITE.
- 5) EROSION AND SEDIMENT CONTROL MEASURES SHALL BE IN PLACE AT THE END OF EACH DAY'S
- 6) EROSION CONTROL PLANTINGS AND MULCH SHALL BE CLOSELY MONITORED THROUGHOUT THE WINTER AND ANY RUNOFF PROBLEMS CORRECTED PROMPTLY. SEE LANDSCAPE ARCHITECT'S PLAN FOR PERMANENT PLANTINGS AND TREE SCHEDULES.
- 7) DISTURBED SURFACES NOT INVOLVED IN THE IMMEDIATE GRADING OPERATIONS MUST BE PROTECTED BY MULCHING AND/OR OTHER EFFECTIVE MEANS OF SOIL PROTECTION.
- 8) ALL ROADS AND DRIVEWAYS SHALL HAVE DRAINAGE FACILITIES SUFFICIENT TO PREVENT EROSION ON OR ADJACENT TO THE ROADWAY OR ON THE DOWNHILL PROPERTIES.
- 9) DRAINAGE CONTROL MEASURES SHALL BE MAINTAINED AND IN PLACE AT THE END OF EACH DAY AND CONTINUOUSLY THROUGHOUT THE LIFE OF THE PROJECT DURING WINTER OPERATIONS.
- 10) REVEGETATION SHALL CONSIST OF A MECHANICALLY APPLIED HYDROMULCH SLURRY OR HAND SEEDED WITH A STRAW MULCH COVER. MULCH SHALL BE ANCHORED BY AN APPROVED METHOD SUCH AS PUNCHING, TACKING, OR THE USE OF JUTE NETTING, AS DEEMED NECESSARY FOR THE SITE CONDITIONS TO ALLOW FOR GERMINATION AND ENABLE ADEQUATE GROWTH TO BE
- 11) CHECK DAMS, SILT FENCES, FIBER ROLLS OR OTHER DESIGNS SHALL BE INCORPORATED TO CATCH ANY SEDIMENT UNTIL AFTER THE NEWLY EXPOSED AREAS ARE REVEGETATED SUFFICIENTLY TO CONTROL EROSION. EROSION CONTROL PLANTINGS AND MULCH SHALL BE CLOSELY MONITORED THROUGHOUT THE WINTER AND ANY RUNOFF PROBLEMS SHALL BE CORRECTED PROMPTLY. ALL EROSION AND/OR SLIPPAGE OF THE NEWLY EXPOSED AREAS SHALL BE REPAIRED BY THE PERMITTEE AT THEIR EXPENSE.
- 12) THE GRASS SEED SHALL BE PROPERLY IRRIGATED UNTIL ADEQUATE GROWTH IS ESTABLISHED AND MAINTAINED TO PROTECT THE SITE FROM FUTURE EROSION DAMAGE. ALL NEWLY EXPOSED (DISTURBED) AREAS SHALL BE SEEDED WITH THE FOLLOWING EROSION CONTROL MIX: BROMUS CARINATUS (CALIFORNIA BROME), VULPIA MICROSTACHYS (NUTTALL'S FESCUE), ELYMUS GLAUCUS (BLUE WILD RYE), HORDEUM BRACHYANTHERUM (MEADOW BARLEY), FESTUCA RUNRA'MOLATE BLUE AND A MIXTURE OF LOCALLY NATIVE WILDFLOWERS.
- 13) THE DIRECTOR OF BUILDING INSPECTION (BUILDING OFFICIAL) SHALL STOP OPERATIONS DURING PERIODS OF INCLEMENT WEATHER IF HE OR SHE DETERMINES THAT EROSION PROBLEMS ARE NOT BEING CONTROLLED ADEQUATELY.
- 14) GENERAL CONTRACTOR SHALL BE RESPONSIBLE FOR EROSION AND SEDIMENT CONTROL BMP INSTALLATION AND MAINTENANCE AND SHALL PROVIDE FULL PARTICULARS TO COUNTY RMA-ENVIRONMENTAL SERVICES PRIOR TO BEG. WORK.

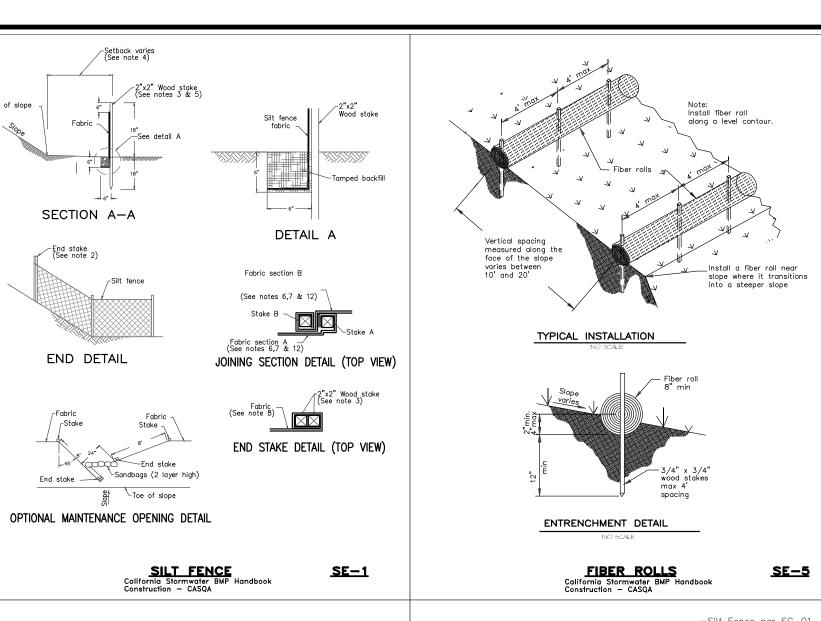

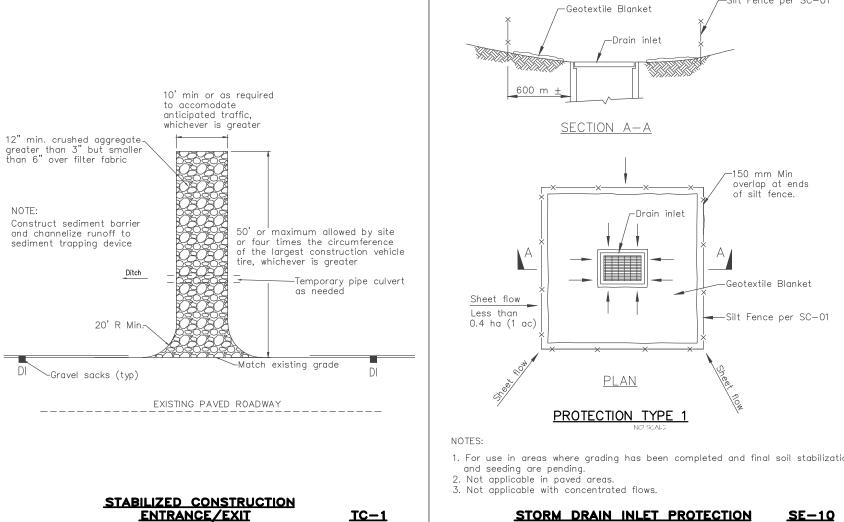



TRASH

RECYCLE

**~~~~** 

FIBER ROLLS: THE CONTRACTOR SHALL MAINTAIN A STOCKPILE OF FIBER ROLLS ONSITE, AS THEY CAN BE USED ALONG ERODIBLE SLOPES, ALONG STOCKPILE PERIMETERS, DOWNSLOPE OF EXPOSED SOIL AREAS, AND TO DELINEATE/PROTECT STAGING AREAS. FIBER ROLLS MUST BE TRENCHED INTO THE SOIL AND STAKED (STAKES SPACED MAX. 4' ON CENTER), SEE DETAIL. INSTALL FIBER ROLLS ALONG LEVEL CONTOURS, AND TURN THE ENDS UPHILL. INSPECT WEEKLY AND REMOVE ACCUMULATED SEDIMENT REGULARLY.

DRAIN INLET PROTECTION: PLACE GEOTEXTILE FILTER FABRIC BENEATH INLET GRATE AND SURROUND ENTIRE INLET WITH GRAVEL BAGS (OVERLAP THE BAGS AND PACK THEM TIGHTLY TOGETHER - SEE DETAIL). INSPECT ALL INLET PROTECTION WEEKLY. REMOVE ACCUMULATED SEDIMENT REGULARLY.

STABILIZED CONSTRUCTION ACCESS: INSTALL STABILIZED CONSTRUCTION ACCESS PRIOR TO COMMENCEMENT OF EARTH MOVING OPERATIONS (SEE DETAIL). INSPECT ENTRANCE DAILY, AND ADD ADDITIONAL STONE AS TOP-DRESSING WHEN REQUIRED. USE FENCING OR BARRICADES TO PREVENT VEHICLE TRAFFIC FROM DRIVING AROUND THE STABILIZED ACCESS.

CONCRETE WASHOUT: WASHOUT MUST BE LOCATED A MINIMUM OF 50 FEET FROM STORM DRAINS, OPEN DITCHES, OR WATER BODIES. DISCONTINUE USE WHEN WASHOUT WASTES REACH 75% OF THE WASHOUT CAPACITY. ALLOW WASHOUT WASTES TO HARDEN, BE BROKEN UP,

AND THEN DISPOSED OF PROPERLY. SANITARY/SEPTIC WASTE MANAGEMENT: PORTABLE TOILETS WILL BE PROVIDED AND MAINTAINÉD ONSITE FOR THE DURATION OF THE PROJECT. ALL PORTABLE TOILETS WILL BE EQUIPPED WITH A SECONDARY CONTAINMENT TRAY, AND SHALL BE LOCATED A MINIMUM OF

50' FROM ALL OPERATIONAL STORM DRAIN INLETS. WEEKLY MAINTENANCE SHALL BE PROVIDED

AND WASTES LEGALLY DISPOSED OF OFF-SITE STOCKPILE MANAGEMENT: SOIL STOCKPILES MUST BE COVERED OR STABILIZED (I.E. WITH SOIL BINDERS) IMMEDIATELY IF THEY ARE NOT SCHEDULED TO BE USED WITHIN 14 DAYS. ACTIVE SOIL STOCKPILES SHALL BE WATERED TWICE DAILY TO AVOID WIND EROSION. SURROUND ALL STOCKPILES WITH FIBER ROLLS OR SILT FENCE. STOCKPILES OF "COLD MIX", TREATED WOOD, AND BASIC CONSTRUCTION MATERIALS SHOULD BE PLACED ON AND COVERED

CONTRACTOR'S STAGING AREA: THE CONTRACTOR'S STAGING AREA SHALL BE SURROUNDED BY FIBER ROLLS. THE STAGING AREA WILL BE USED TO STORE DELIVERED MATERIALS, AND FOR OVERNIGHT EQUIPMENT PARKING/FUELING. STORED CONSTRUCTION MATERIALS SHALL BE MAINTAINED IN THEIR ORIGINAL CONTAINERS, AND COVERED AT ALL TIMES. PETROLEUM PRODUCTS AND HAZARDOUS MATERIALS SHALL BE STORED WITHIN SECONDARY CONTAINMENT STRUCTURES OR A STORAGE SHED. EQUIPMENT FUELING AND MAINTENANCE WILL ONLY OCCUR WITHIN THE DESIGNATED STAGING AREA. DRIP PANS OR ABSORBENT PADS MUST BE

IN WATERTIGHT DUMPSTERS IN THE GENERAL STORAGE AREA OF THE CONTRACTOR'S YARD.

DUMPSTERS AND/OR TRASH BINS SHALL BE COVERED AT THE END OF EACH WORK DAY.

MINIMUM OF 18" LONG X 12" WIDE X 3" THICK, FILLED WITH 1/2" - 1" CRUSHED ROCK.

USED DURING ALL FUELING OR MAINTENANCE ACTIVITIES. AN AMPLE SUPPLY OF SPILL CLEANUP MATERIALS SHALL BE MAINTAINED IN THE STAGING AREA AT ALL TIMES. WASTE MANAGEMENT: SOLID WASTES WILL BE LOADED DIRECTLY ONTO TRUCKS FOR OFF-SITE DISPOSAL. WHEN ON-SITE STORAGE IS NECESSARY, SOLID WASTES WILL BE STORED

WITH PLASTIC SHEETING OR COMPARABLE MATERIAL AND SURROUNDED BY A BERM..

HAZARDOUS WASTES SHALL NOT BE STORED ONSITE. CONSTRUCTION DEBRIS AND GENERAL LITTER WILL BE COLLECTED DAILY AND WILL NOT BE ALLOWED NEAR DRAINAGE INLETS OR DRAINAGE SYSTEMS. GRAVEL BAG CHECK DAM: GRAVEL BAGS SHALL CONSIST OF WOVEN POLYPROPYLENE, POLYETHYLENE OR POLYAMIDE FABRIC, MIN. UNIT WEIGHT OF 40Z/SY. BAGS SHALL BE A

BE A LICENSED AND CERTIFIED ARBORIST.

INSPECT CHECK DAM REGULARLY AND REMOVE ACCUMULATED SEDIMENT. TREE PROTECTION: TREE PROTECTION SHALL CONSIST OF ORANGE PLASTIC MESH FENCING, AND SHALL BE INSTALLED PRIOR TO COMMENCEMENT OF EARTH-MOVING OPERATIONS (SEE DETAIL). INSTALL FENCING ALONG THE DRIP LINE OF TREES, AND INSTRUCT EMPLOYEES AND SUBCONTRACTORS TO HONOR PROTECTIVE DEVICES. TREE INJURIES SHALL BE ATTENDED TO

TIGHTLY ABUT BAGS AND CONSTRUCT CHECK DAM AT LEAST 3 BAGS WIDE X 2 BAGS HIGH.

SILT FENCE: SILT FENCE SHALL CONSIST OF WOVEN GEOTEXTILE FABRIC WITH A MINIMUM WIDTH OF 36 INCHES. WOOD STAKES SHALL BE COMMERCIAL QUALITY LUMBER, SPACED A MAXIMUM OF 6' APART AND DRIVEN SECURELY INTO THE GROUND (SEE DETAIL). FENCING FABRIC SHALL BE KEYED INTO THE SOIL AS PER MANUFACTURER'S RECOMMENDATIONS. INSTALL SILT FENCE ALONG LEVEL CONTOURS. TURN THE ENDS OF THE SILT FENCE UPHILL TO PREVENT WATER FROM FLOWING AROUND THE FENCE. INSPECT SILT FENCE DAILY, AND MAKE REPAIRS IMMEDIATELY.


#### TABLE 1706 6 DECLUDED VEDICICATION AND INSPECTION OF SOILS

TABLE 1706.6 REQUIRED VERIFICATION AND INSPECTION OF SOILS					
VERIFICATION AND INSPECTION TASK	CONTINUOUS DURING TASK LISTED	PERIODICALLY DURING TASK LISTED			
Verify material below shallow foundations are adequate to achieve the design bearing capacity		×			
2. Verify excavations are extended to proper depth and have reached proper material		Х			
3. Perform classification and testing of compacted fill materials		Х			
4. Verify use of proper materials, densities and lift sicknesses during placement and compaction of compacted fill.	X				
5. Prior to placement of compacted fill, observe subgrade and verify that site has been prepared properly.		Х			

#### CONSTRUCTION INSPECTION REQUIREMENTS

- A-PRIOR TO COMMENCEMENT OF ANY LAND DISTURBANCE, THE OWNER/APPLICANT SHALL SCHEDULE AN INSPECTION WITH HCD-ENVIRONMENTAL SERVICES TO ENSURE ALL NECESSARY SEDIMENT CONTROLS ARE IN PLACE AND THE PROJECT IS COMPLIANT WITH MONTEREY COUNTY GRADING AND EROSION CONTROL REGULATIONS.
- B-DURING CONSTRUCTION THE OWNER/APPLICANT SHALL SCHEDULE AN INSPECTION WITH HCD-ENVIRONMENTAL SERVICES TO UPDATE COMPACTION TEST RECORDS, INSPECT DRAINAGE DEVICE INSTALLATION, REVIEW THE MAINTENANCE AND EFFECTIVENESS OF BMP's INSTALLED, AS WELL AS, TO VERIFY THAT POLLUTANTS OF CONCERN ARE NOT DISCHARGED FROM THE SITE.
- C-PRIOR TO FINAL INSPECTION, THE OWNER/APPLICANT SHALL SCHEDULE AN INSPECTION WITH HCD-ENVIRONMENTAL SERVICES TO CONDUCT A FINAL GRADING INSPECTION, COLLECT FINAL GEOTECHNICAL LETTER OF CONFORMANCE, ENSURE THAT ALL DISTURBED AREAS HAVE BEEN STABILIZED AND THAT ALL TEMPORARY EROSION AND SEDIMENT CONTROL MEASURES THAT ARE NO LONGER NEEDED HAVE BEEN REMOVED.

#### **Material Delivery and Storage**

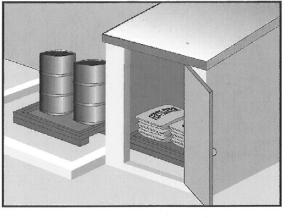

**Description and Purpose** Prevent, reduce, or eliminate the discharge of pollutants from material delivery and storage to the stormwater system or watercourses by minimizing the storage of hazardous materials onsite, storing materials in watertight containers and/or a completely enclosed designated area, installing secondary containment, conducting regular inspections, and training employees and subcontractors.

This best management practice covers only material delivery and storage. For other information on materials, see WM-2, Material Use, or WM-4, Spill Prevention and Control. For information on wastes, see the waste management BMPs in this

# **Targeted Constituents** Oil and Grease

WM-1

SE Sediment Control

TC Tracking Control

WE Wind Erosion Control

Non-Stormwater

Primary Category

Secondary Category

Management Control

Waste Management and

Materials Pollution Control

**Potential Alternatives** 

EC Erosion Control

SE Sediment Control

C Tracking Control

WE Wind Erosion Control


Non-Stormwater

Secondary Objective

Management Control

Waste Management and

#### Hazardous Waste Management

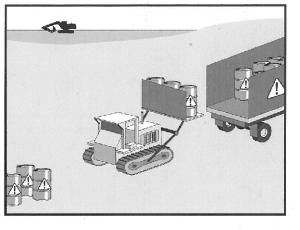


Prevent or reduce the discharge of pollutants to stormwater from hazardous waste through proper material use, waste disposal, and training of employees and subcontractors.

Targeted Constituents Oil and Grease Organics


Potential Alternatives

#### Stockpile Management

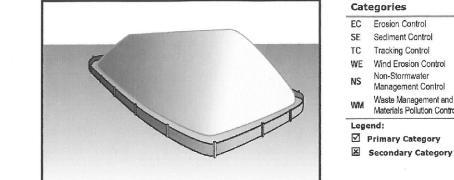

**Description and Purpose** Stockpile management procedures and practices are designed to reduce or eliminate air and stormwater pollution from stockpiles of soil, soil amendments, sand, paving materials such as portland cement concrete (PCC) rubble, asphalt concrete (AC), asphalt concrete rubble, aggregate base, aggregate sub base or pre-mixed aggregate, asphalt minder (so called "cold mix" asphalt), and pressure treated wood.

#### Sanitary/Septic Waste Management WM-9

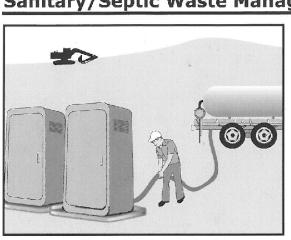

**Description and Purpose** Proper sanitary and septic waste management prevent the discharge of pollutants to stormwater from sanitary and septic waste by providing convenient, well-maintained facilities, and arranging for regular service and disposal.

Targeted Constituents Bacteria Oil and Grease Organics

California Stormwater BMP Construction — CASQA

WM-3

Non-Stormwater

Management Control

**Targeted Constituents** 

**Potential Alternatives** 

Oil and Grease

Categories

EC Erosion Control

SE Sediment Control

WE Wind Erosion Control

☑ Primary Category

■ Secondary Category

Non-Stormwater

Management Control

Waste Management and

Materials Pollution Control

TC Tracking Control


Waste Management and

Materials Pollution Control

Potential Alternatives

#### **Solid Waste Management**

California Stormwater E Construction — CASQA

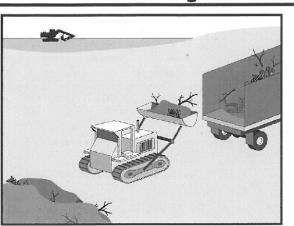

**Description and Purpose** Solid waste management procedures and practices are designed to prevent or reduce the discharge of pollutants to stormwater from solid or construction waste by providing designated waste collection areas and containers, arranging for regular disposal, and training employees and subcontractors.

#### Targeted Constituents Nutrients Bacteria Oil and Grease

SE Sediment Control

Tracking Control

WE Wind Erosion Control

☑ Primary Objective

Secondary Objective

Non-Stormwater

Management Control

Waste Management and

Materials Pollution Control

**Potential Alternatives** 

EC Erosion Control

SE Sediment Control


TC Tracking Control

WE Wind Erosion Control

Non-Stormwater

Management Control

#### **Preservation Of Existing Vegetation EC-2**

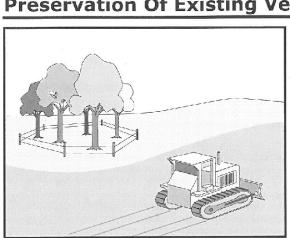

**Description and Purpose** Carefully planned preservation of existing vegetation minimizes the potential of removing or injuring existing trees, vines, shrubs, and grasses that protect soil from erosion.

Waste Management and Materials Pollution Control ☑ Primary Objective ▼ Secondary Objective

**Targeted Constituents** Nutrients Trash

Oil and Grease

REVISION


06/02/25 AMS DRIVEWAY/PARKING REVIEW 04/25/25 AMS DRIVEWAY/PARKING UPDATE 04/16/25 AMS RELEASED TO CLIENT


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SCALE: AS SHOWN DATE: JANUARY 2025

OB NO. 2466-02



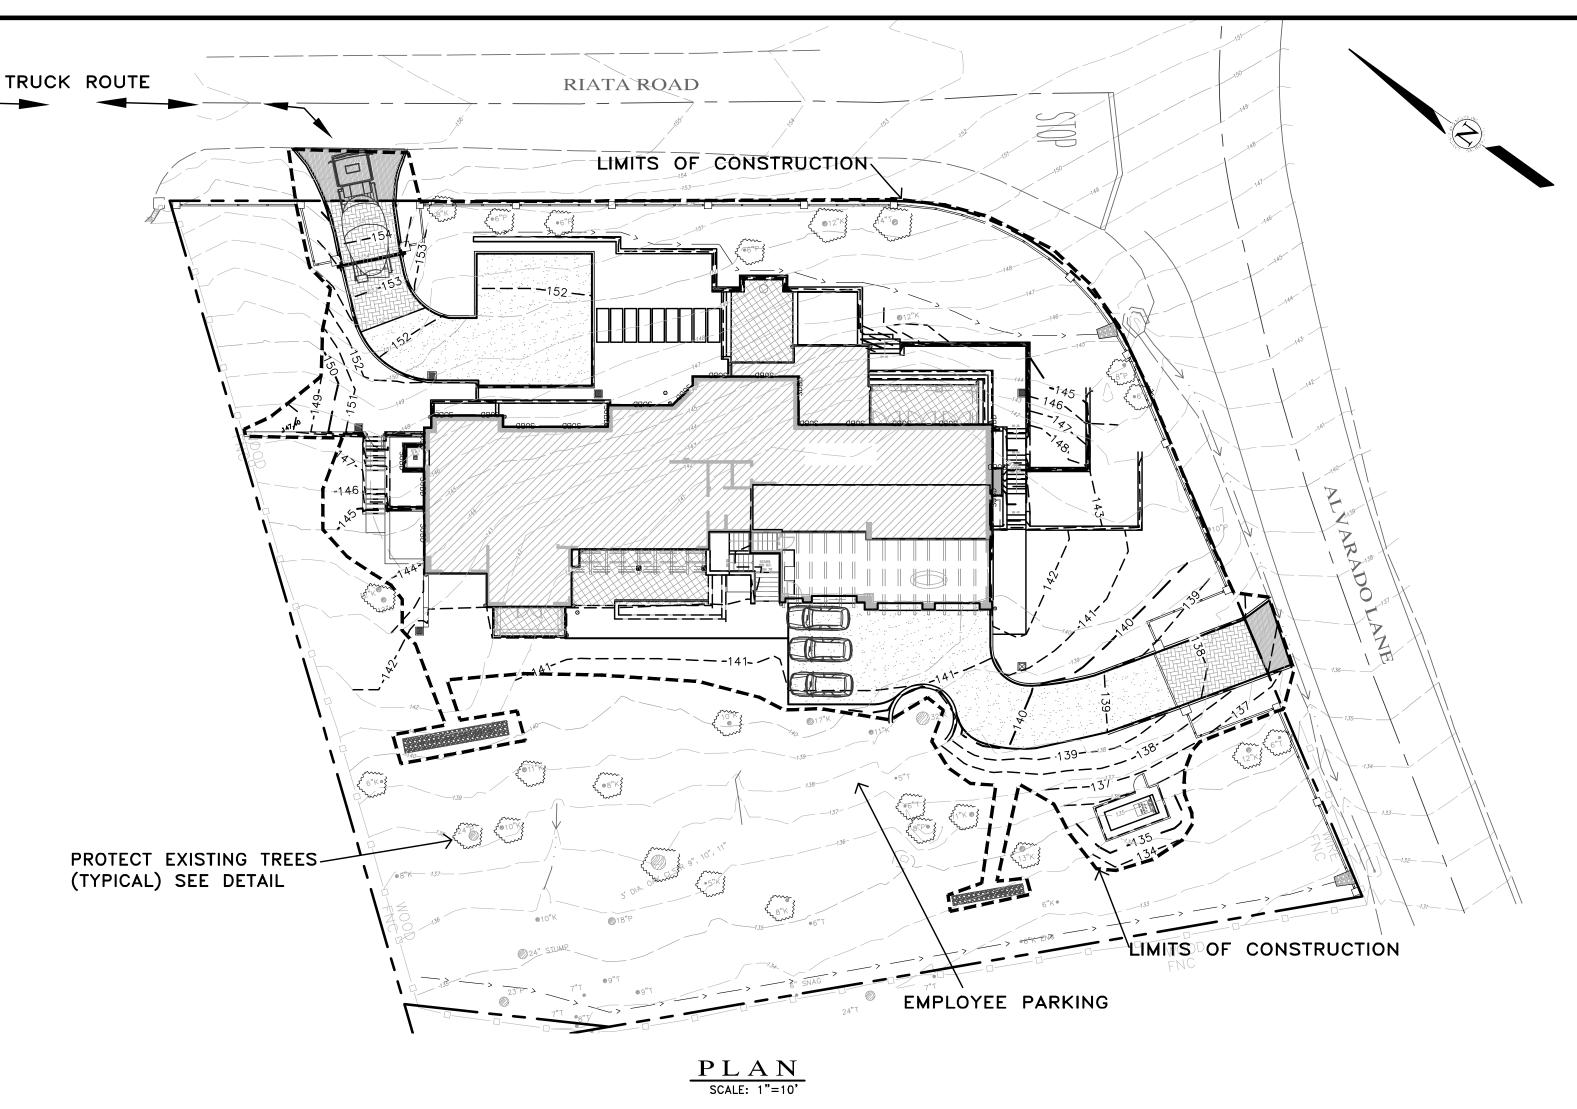

EARTHWORK QUANTITIES PER CIVIL ENGINEERING PLANS BY LANDSET ENGINEERS, INC.: 225 CY CUT 825 CY FILL

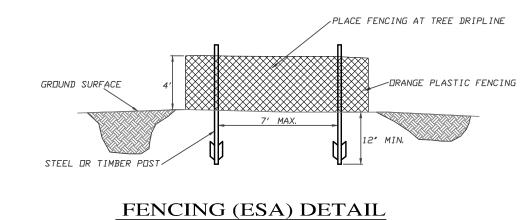CONSTRUCTION STAGING:
DEMOLISH EXISTING HARDSCAPE AND OFFHAUL DEBRIS: EXISTING DRIVEWAY TO BE USED FOR EQUIPMENT STAGING AND TEMPORARY STOCKPILE AREA.

PERFORM GRADING, CONSTRUCT STRUCTURES, AND INSTALL UNDERGROUND UTILITIES: EXISTING DRIVEWAY AREA TO BE USED FOR MATERIAL AND EQUIPMENT STAGING.

#### INSTALL NEW DECOMPOSED GRANITE DRIVEWAY AND LANDSCAPING.

SEE ARCHITECTURAL AND CIVIL PLANS FOR EROSION CONTROL AND DEMOLITION NOTES.

CONSTRUCTION EQUIPMENT AND MATERIALS SHALL NOT BE STAGED ON RIATA ROAD AT ANY TIME DURING CONSTRUCTION. MATERIAL DELIVERIES SHALL BE SCHEDULED SUCH THAT THEY ARE USED PROMPTLY, AND MATERIAL STORAGE IS MINIMIZED. ALL CONSTRUCTION EQUIPMENT AND MATERIALS SHALL BE STORED IN A DESIGNATED AREA ON THE SUBJECT PROPERTY.

THE HAUL ROUTE TO THE SITE IS FROM HIGHWAY 1 TO 17 MILE DRIVE TO SUNRIDGE RD TO RONDA ROAD TO VISCAINO RD TO FOREST LAKE RD TO RIATA ROAD. (HAUL TRUCKS EXIT IN THE SAME FASHION.) VEHICLES SHALL NOT BE LEFT UNATTENDED WHILE IN QUEUE (IF NECESSARY) ON BONIFACIO ROAD. CONTRACTOR TO ENSURE THAT HEIGHT RESTRICTIONS WITHIN THE DRIVEWAY AREA SHALL BE ADDRESSED BEFORE CONSTRUCTION VEHICLES ENTER THE SITE. SEE DETAILS B AND C, TRUCK ROUTING PLANS.

IN THE EVENT THAT MATERIAL DELIVERIES CAUSE ANY STREETS ALONG THE HAUL ROUTE TO BE PARTIALLY BLOCKED BY DELIVERY TRUCKS OR LOADING/UNLOADING OPERATIONS, A FLAGMAN SHALL BE PRESENT TO DIRECT TRAFFIC AROUND THE LANE OBSTRUCTION. THE FLAGMAN SHALL BE PRESENT AT ALL TIMES DURING WHICH DELIVERY/CONSTRUCTION OPERATIONS MAY IMPACT TRAFFIC ON THE HAUL ROUTE AND SURROUNDING STREETS.

LIMITED EMPLOYEE PARKING ON-SITE. EMPLOYEES SHALL USE PUBLIC PARKING LOTS AND CARPOOL TO JOBSITE IF POSSIBLE. ON-SITE PARKING SHALL BE IN PROPOSED LOWER MOTOR COURT AND/OR IN LEGAL SPACES ALONG RIATA ROAD, OBEYING ALL PARKING LAWS. PARKING IS PROHIBITED IN ALL NATURAL AREAS WHICH ARE NOT CURRENTLY

<u>LIMITS OF CONSTRUCTION:</u> ALL CONSTRUCTION SHALL TAKE PLACE WITHIN THE BORDER AS SHOWN. EXISTING CYPRESS, PINE, AND OAK TREES LOCATED WITHIN THE LIMITS SHOWN SHALL BE SURROUNDED BY ORANGE PROTECTIVE FENCING (SEE DETAIL).

#### TRUCK TRIP GENERATION CHART:

CATEGORY	NO. OF TRUCK TRIPS	TOTAL DAYS
DEMOLITION/CLKEARING	3	2
GRADING & SOIL REMOVAL (EXPORT)	1	1
ENGINEERING MATERIALS (IMPORT)	30	5
TOTALS	34	8


#### TRUCK TRIP GENERATION NOTES:

- 1. TRUCK TRIPS FOR THE GRADING/SOIL REMOVAL IS BASED UPON 20 CUBIC YARDS PER TRUCKLOAD WITH AN AVERAGE OF 7 TRUCK LOADS PER DAY. 2. THERE ARE 600 C.Y. OF SOIL MATERIAL THAT WILL BE IMPORTED TO THE
- 3. GRADING OPERATIONS SHALL TAKE APPROXIMATELY 8 WORKING DAYS TO
- 4. THE AMOUNT OF GRADING PER DAY WILL VARY, THE AVERAGE BETWEEN 80 & 120 CUBIC YARDS.

#### NUMBER OF EMPLOYEES/DAY: 6-10

HOURS OF OPERATION/DAY: 8

PROJECT SCHEDULING: PROJECTED START DATE 23 JUNE 2025, 8 WORKING DAYS TO COMPLETE GRADING, MONDAY THRU FRIDAY, 8:00 A.M. - 4:30 P.M. TOTAL PROJECT DURATION IS APPROXIMATELY 12 MONTHS.

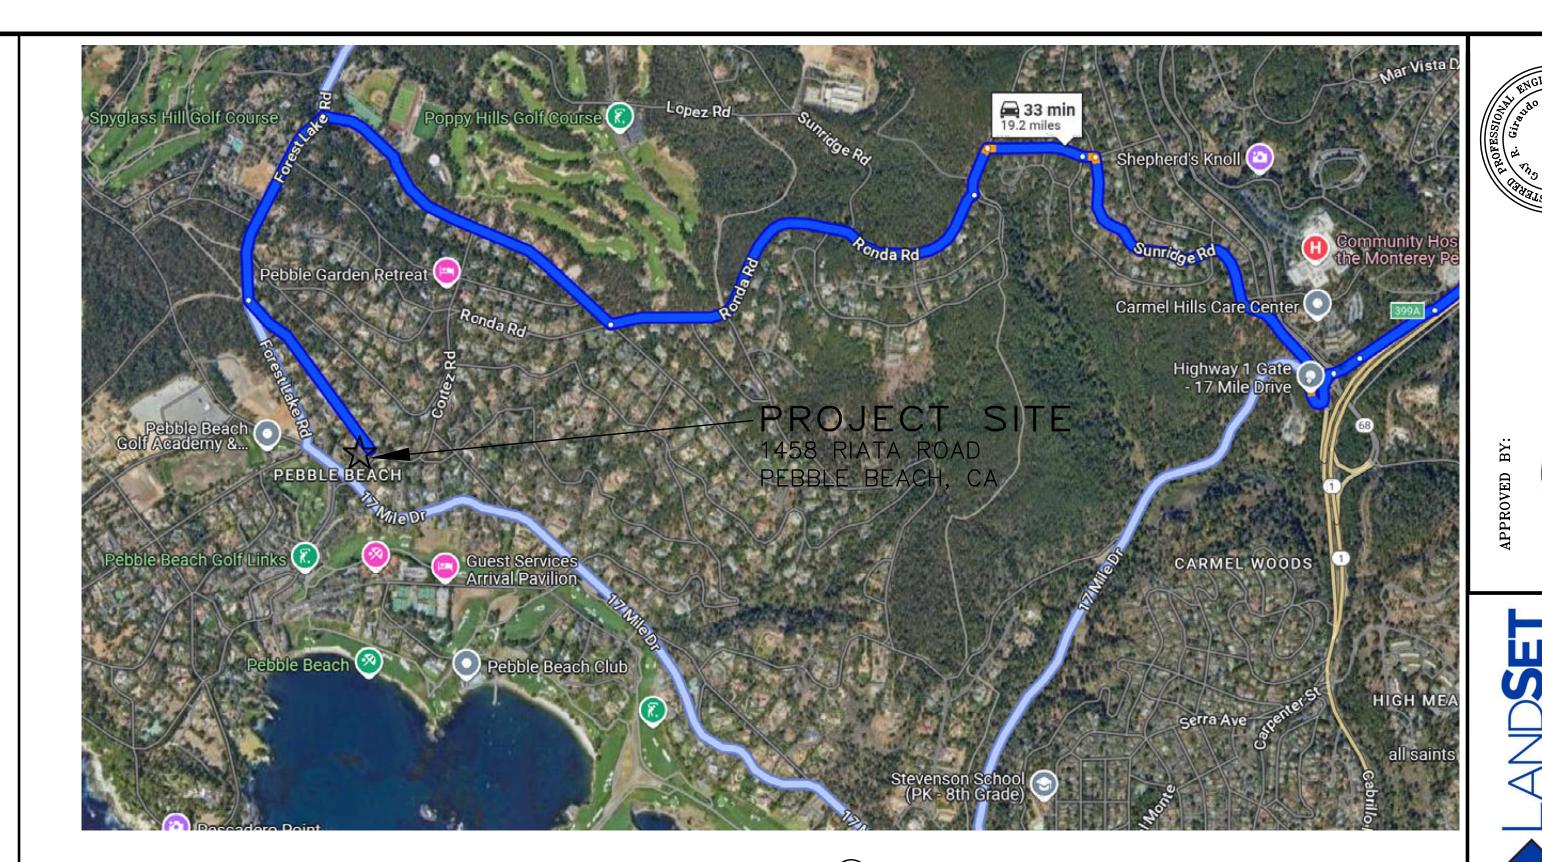



No. DATE BY





