#### Exhibit B

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From:	Geramaldi, Geramaldi@DOT
То:	Honorato, Hya
Cc:	<u>O"Connor, Jill@DOT</u>
Subject:	Geramaldi - Request CDP extension, Castro Canyon Bridge Rail, PLN210039
Date:	Tuesday, February 18, 2025 7:05:07 AM
Attachments:	image001.png
	CDP Extension PLN210039 Caltrans EA 05-1H490 Castro Canyon 250217.pdf
	<u>05-1H490 CDP Mon Co PLN210039.pdf</u>
Importance:	High

[CAUTION: This email originated from outside of the County. Do not click links or open attachments unless you recognize the sender and know the content is safe. ]

Morning Hya,

Attached is the Development Project Application for the CDP extension request for PLN210039, Castro Canyon Bridge Rail Upgrade (EA 05-1H490).

No changes in the project's description, impacts, or mitigation since the original CDP (attached) was issued back in 2022, so no updated documents have been prepared for the project.

If any additional information or materials are required to process the CDP extension, please let us know.

Also, is there a general time frame on how long it typically takes to process an extension? Thank you very much.

#### Geramaldi (Aldi)

Environmental Scientist – Coastal Coordinator *Caltrans District 5 San Luis Obispo geramaldi.geramaldi@dot.ca.gov* 805-441-0561 Teleworking, 7 AM – 4 PM, Monday – Friday

From: Honorato, Hya <HonoratoH@countyofmonterey.gov>
Sent: Friday, February 14, 2025 1:28 PM
To: Geramaldi, Geramaldi@DOT <Geramaldi.Geramaldi@dot.ca.gov>
Subject: RE: Geramaldi - Inquiry, CDP extension, Castro Canyon Bridge Rail, PLN210039

**EXTERNAL EMAIL.** Links/attachments may not be safe.

Hi Aldi,

We can definitely process an extension for the project. It will not necessarily be handled by me, I am going to send it through our normal processing channels and the extension will be assigned to a planner. Send me the application and any updated documents and I will forward

#### to our staff to get the extension processed.

#### Thank you,



**Hya Honorato** (She/Her) Assistant Planner Housing and Community Development 1441 Schilling Place, 2<sup>nd</sup> Floor, Salinas CA 93901 Direct: (831)755-5173 | F: (831)757-9516 HonoratoH@countyofmonterey.gov www.countyofmonterey.gov

#### Please note, I am currently available until 3 pm on Mondays, Wednesdays, and Fridays until further notice. Thank you.

From: Geramaldi, Geramaldi@DOT <<u>Geramaldi.Geramaldi@dot.ca.gov</u>>
Sent: Wednesday, February 12, 2025 10:04 AM
To: Honorato, Hya <<u>HonoratoH@countyofmonterey.gov</u>>
Subject: Geramaldi - Inquiry, CDP extension, Castro Canyon Bridge Rail, PLN210039

[CAUTION: This email originated from outside of the County. Do not click links or open attachments unless you recognize the sender and know the content is safe. ] Morning Hya,

It was brought to my attention that PLN210039 (attached) will expire on March 18, 2025 (end of three years).

I wanted to ask about the feasibility of an extensions for the permit given there is only 4 weeks left.

The project has been on hold due to legal issues; hence it has been inactive for the last three years.

This is the Castro Canyon Bridge Rail Replacement project (05-1H490), located on SR-1 in Big Sur.

I presume if an extension is still feasible, I would need to submit the attached extension form?

Let me know if a phone all would be beneficial for this discussion. Thank you.

#### Geramaldi (Aldi)

Environmental Scientist – Coastal Coordinator Caltrans District 5 San Luis Obispo geramaldi.geramaldi@dot.ca.gov 805-441-0561 Teleworking, 7 AM – 4 PM, Monday – Friday

5	Nanning – Building - Housing 441 Schilling Place, South 2nd Floor Ialinas, California 93901-4527 831) 755-5025		1850	RAT
	Development Project	: Ар	plication	
Th	iis application is for: Combined Development Permit Rezoning Administrative Permit [Coastal/Non-Coastal] Use Permit Variance Design Approval General Development Plan Coastal Development Permit Modification of Conditions Local Coastal Plan Amendment [L.U.P. or C.I.P.] General Plan Amendment Minor Amendment [Coastal/Non-Coastal]		Vesting Tentative Map Preliminary Map Preliminary Project Review Map Lot Line Adjustment Revised Final Map Revised Parcel Map Amended Final Map Amended Parcel Map Subdivision Extension Request	
1.	Owner[s] Name: California Department of Transportation (Caltrans) - Dis	strict 5	5, San Luis Obispo c/o Geramaldi	
	Address: 50 Higuera Street		City: San Luis Obispo State: CA	
	Telephone: 805-441-0561		Zip Code: 93401	
2.	Applicant's Name: California Department of Transportation (Caltrans	) - Dist	trict 5, San Luis Obispo c/o Geramaldi	
	Address: 50 Higuera Street		City: San Luis Obispo State: CA	
	Telephone: 805-441-0561		Zip Code: 93401	
3.	•	ic.]	Owner and Operator	-
4.	Property address and nearest cross street: Highway 1 postmil	e 43.12	12 and Rancho Grande Road in Big Sur	
5.	Assessor's Parcel Number[s]: 000-000-000 (State Right-of-Way)			
	Current Zoning: WSC/40-D(CZ)			
6.	Property area [acres or square feet]: 0.1 acre			
6. 7.		sting b	bridge rail on SR-1 at Castro Canyon Bridge in Big	
7.	to meet current design and safety standards with concrete and metal			-
7.	to meet current design and safety standards with concrete and metal includes re-striping, upgrading two down drains, and retaining wall co			-
7.	to meet current design and safety standards with concrete and metal	nstruc	ction. The project will require temporary and permar	ent
7.	to meet current design and safety standards with concrete and metal includes re-striping, upgrading two down drains, and retaining wall co utility relocations.	nstruc	ction. The project will require temporary and permar	ent

 Subdivision Information Only
 Number of Lots:
 N/A

 Purpose of Subdivision:
 Sale:
 Lease:
 Financing:
 Other:

			N/A	
Will The Adjustment Reloca	te The Building Area?	Yes 🗆 No		
Adjusted Parcel Size[s]:	<u>N/A</u>			
Owner's Signature		Owner's Signature		
N/A		N/A		
Owner's Name [Please Prin	nt]	Owner's Name [Please P	rint]	
N/A		N/A		
Assessor's Parcel Number		Assessor's Parcel Numb	er	

13. Variances Only: Describe the proposed variance: N/A

11.

14. If new or additional construction is proposed, o	complete the following information:
A. Residential Development: Single Fami	ily Residence D Other [how many total units] N/A
No. of covered parking spaces $\underline{N/A}$ No.	Io. of uncovered parking spaces <u>N/A</u> Lot Coverage <u>N/A</u> %
B. Commercial or Industrial Development:	No. of employees [include all shifts] <u>N/A</u>
No. of covered parking spaces	No. of uncovered parking spaces N/A
No. of Loading Spaces	Lot Coverage <u>N/A %</u>
15. Will grading or filling be required: Yes	No         Cubic Yards         92.6
16. Will the project require placement of structures, road	ids, grading cuts or fills on slopes of 30% or greater: Yes ■ No □
17. Will any trees be removed: Yes □       No ■         No trees will be removed.       No	If yes, indicate the number, specie[s] and diameter:
Other vegetation to be removed: No vegetati	tion will be removed, but vegetation trimming is anticipated.
18. How will water be supplied: Individual Well	lls N/A Mutual System N/A
Name of Public or Private Water System:	
19. How will sewage or other waste be disposed:	N/A
Name of Public or Private Sewer System:	A
20. Is this land currently in row crop production:	Yes 🗆 No 🖬
22. Is this land under an Agricultural Preservation	n Contract: Yes □ No □ If yes, indicate the Contract No
I/We state that as the owner[s] or agent for owne application and know the contents herein. I/We application including the plans and documents su	nvironmental Health Dept., Phone 831-755-4500.] er[s] for the development permit application. <i>I/We</i> have read the complete e declare under penalty of perjury that the information contained in this submitted herewith are true and correct to the best of my/our knowledge. If may be charged an additional fee for staff time required to satisfy conditions
Dated:	San Luis Obispo , California
	I declare under penalty that I am authorized by the owner[s] of the described property to make this application.
Caltrans - District 5, San Luis Obispo c/o Geramaldi	Geramaldi
Owner's Name [Please Print or Type]	Agent's Name [Please Print or Type]
S. M.	A NA
Owner's Signature	Agent's Signature
billed to the applicant at an hourly rate	a deposit basis. Processing hours in excess of the deposit will be te, prior to issuance of entitlements or permits. Processing hours ded at the same rate after issuance of the entitlements or permits.
	For Department Use Only
Plan Designation:	
Legal Lot:	Zoning Violation Case No.: Height: Lot Coverage
Property Owner Verified: Yes □ No □ Setbacks: F R S	Height: Lot Coverage Special OPL
FAR Fire Haz.	SRA Flood
Advisory Committee:	
Geo. Hazard Zones: Arch. Se	ensitivity Zone: ESH:
Misc.:	

Date:

Date:

Application Given Out By:

Application Received By:

#### Before the Planning Commission in and for the County of Monterey, State of California

#### In the matter of the application of: (PLN210039) CALIFORNIA DEPARTMENT OF TRANSPORTATION RESOLUTION NO. 22 - 004

Resolution by the Planning Commission:

- 1. Finding that the project, which involves utility extension and street improvements for bridge safety improvements, qualifies as a Class 3 categorical exemption pursuant to Section 15303 of the CEQA Guidelines, and there are no exceptions pursuant to Section 15300.2; and
- 2. Approving a Combined Development Permit consisting of:
  - a. Coastal Development Permit and Design Approval to allow safety improvements to the Castro Canyon Bridge, inclusive of restriping of lanes, bridge rail and crash cushion upgrades, placement of a new retaining wall, and drainage upgrades;
  - b. Coastal Development Permit to allow development within the Big Sur Critical Viewshed;
  - c. Coastal Development Permit to allow development on slopes exceeding 30 percent; and
  - d. Coastal Development Permit to allow development within 100 feet of environmentally sensitive habitat.

State Route 1 (Highway 1) Castro Canyon Bridge (Br. No. 44-0035, Post Mile 43.12, located between Post-Mile Markers 43.05 – 43.25), Big Sur (No Assessor's Parcel Number), Big Sur Coast Land Use Plan, Coastal Zone (APN: 000-000-000)

The CALIFORNIA DEPARTMENT OF TRANSPORTATION (CASTRO CANYON BRIDGE) application (PLN210039) came on for a public hearing before the Monterey County Planning Commission on March 9, 2022. Having considered all the written and documentary evidence, the administrative record, the staff report, oral testimony, and other evidence presented, the Planning Commission finds and decides as follows:

#### FINDINGS

 1.
 FINDING:
 CONSISTENCY – The proposed project and/or use, as conditioned, is consistent with the policies of the Monterey County 1982 General Plan, Big Sur Land Use Plan, Monterey County Coastal Implementation Plan – Part 3, Monterey County Zoning Ordinance 

Coastal (Title 20), and other County health, safety, and welfare ordinances related to land use development.

- **EVIDENCE:** a) The project involves upgrades to the Castro Canyon Bridge consisting of replacement and installation of new bridge and approach rails, upgrade of guardrails on the north and south of the bridge, and upgrades to the crash cushions. The project also proposes the restriping of lanes and shoulders, a new retaining wall (Appox. 20 feet long), upgrades to the culvert and pipes for improved drainage, and the relocation of existing above-ground utilities underground. The existing Castro Canyon Bridge is a 239-foot, five-span steel girder bridge that has timber rails and wooden beam approach rails. The existing bridge rails, approach rails, guardrails, and crash cushions do not meet Caltrans safety standards. This proposed guardrail replacement is compliant with current design and safety standards per American Association of State Highway and Transportation Officials (AASHTO) requirements. The bridge's length will remain the same. The total project area includes approximately 25,000 square feet of paved area which will be restriped but remain located in the same area and not be extended. The project also involves development within the Big Sur critical viewshed, development on slopes exceeding 30 percent, and development within 100 feet of environmentally sensitive habitat.
  - b) The project has been reviewed for consistency with the text, policies, and regulations in the:
    - 1982 Monterey County General Plan;
    - Big Sur Coast Land Use Plan (LUP);
    - Monterey County Coastal Implementation Plan, Part 3 (CIP); and

- Monterey County Zoning Ordinance - Coastal (Title 20). No conflicts were found to exist. No communications were received during the course of review of the project indicating any inconsistencies with the text, policies, and/or regulations of the applicable Monterey County Code (MCC). The subject property is located within the Coastal Zone; therefore, the 2010 Monterey County General Plan does not apply.

- c) Staff reviewed the application materials, County GIS information, and aerial imagery, to verify consistency of the proposed development with applicable policies and regulations.
- d) <u>Allowed Use</u>. The project site is located along State Route 1 (Highway 1), Castro Canyon Bridge (Br. No. 44-0035, located between Post-Mile Markers 43.05 – 43.25, Big Sur (No Assessor's Parcel Number), approximately 5 miles south of the Big Sur Community, Big Sur, Big Sur Coast Land Use Plan, Coastal Zone. The proposed construction is located entirely within the Caltrans right-of-way, and the zoning is unclassified. The project area is located adjacent to Assessor's Parcel Number 420-181-015-000, and the surrounding property is zoned Rural Density Residential, 40 acres per unit, with a Design Control Overly (Coastal Zone) [RDR/40-D (CZ)]. The proposed project will include upgrades which include the replacement of the bridge guardrail, bridge rail, and crash cushions, to bring this section of highway up to current design and safety

standards needed for compliance with standards set forth by the American Association of State Highway and Transportation Officials (AASTHO. The project includes improvements of an existing highway facility and would preserve utility and public access to the Big Sur area. The General Plan and Big Sur Land Use Policy (LUP) promote improvements for public safety and traffic capacity. The LUP promotes improvements for safety and traffic capacity (Policy 4.1.2.1). LUP Policy 4.1.2.1 states that "[1]mprovements to Highway 1 shall be undertaken in order to increase its service capacity and safety, consistent with its retention as a scenic two-lane road." Consistent with this policy, the purpose of project improves the safety and maintains the roadway to provide continued use of the highway for access to the Big Sur community as an improvement for safety, recreational, and emergency access. See also subsequent Evidence "e". Therefore, the project is an allowed land use for this site.

- e) <u>Highway 1</u>. LUP Policies in Chapter 4 are directed at maintaining and enhancing the aesthetic beauty of Highway 1, and to protect its primary function as a recreational route. The LUP also promotes improvements for safety and service capacity (Policies 4.1.2.1). The project, as proposed, is an improvement required to assure the continued use of the highway for recreational and emergency access; therefore, it is consistent with applicable policies.
- f) <u>Design</u>. Pursuant to MCC Chapter 20.44, the surrounding area is designated as a Design Control Zoning District ("D" zoning overlay), which regulates the location, size, configuration, materials, and colors of structures and fences to assure the protection of the public viewshed and neighborhood character. The proposed upgrades to the bridge rails and beams include a simple design that is intended to complement the rustic and rural environment. The proposed colors and materials design consists of a light beige concrete base and dark brown metal rails (approach rail, guardrails, bridge rail), end treatments, and crash cushions as show in the *Visual Simulations* "Exhibit B, Attachment 3." As proposed, the project assures protection of the public viewshed and visual integrity. See also subsequent Evidence "g" and "h".
- g) <u>Big Sur Critical Viewshed.</u> The project includes a Coastal Development Permit to allow development within the Big Sur critical viewshed. As demonstrated in Finding 6 and supporting evidence, the project minimizes development within the Critical Viewshed and is consistent with applicable LUP policies and regulations.
- h) Land Use Advisory Committee. The project was referred to the Big Sur Land Use Advisory Committee (LUAC) for review based on the LUAC Procedure guidelines adopted by the Monterey County Board of Supervisors. The proposed project was brought before the LUAC on September 28, 2021 and October 26, 2021. The LUAC had concerns with design, specifically that the railing and concrete post would potentially stand out and detract from the natural setting, and the potential for cushion placement to impact ingress and egress to Deetjen's Inn parking area. On October 26, 2021 the LUAC voted, 5-0, to support the project with the following recommendations: 1) reduce the speed limit at the bridge and project site area to match the

"commercial corridor"; 2) decrease the length of crash cushions at the end of the bridge to allow vehicles that enter and leave Deetjen's Inn more room to maneuver and access the bridge, therefore making it more safe; and 3) use of a natural concrete design that blends in the surroundings instead of the faux multi-color stone as initially proposed by applicant. The plans were revised to accommodate the LUAC's recommendation for a redesigned crash cushion which would be the minimum size allowable to fulfill size allowable for the intended safety function. Prior to the LUAC's request, Caltrans conducted studies into speed zones in the area and found that a reduction in the speed limit was not warranted. The color scheme of the rails and beams were updated to a design incorporating a light beige concrete base and dark brown rails that better blends in with the rustic and rural environment when compared to the originally proposed multi-tonal rock design scheme (Exhibit B, Attachment 3 shows the proposed design).

- <u>Development on slope exceeding 30%</u>. The project includes a Coastal Development Permit to allow development on slopes that exceed 30%. As demonstrated in Finding 7 and supporting evidence, there is no feasible alternative that would allow development to occur on slopes of less than 30% in this case.
- Environmentally Sensitive Habit. The project site is in an area i) identified as being within 100 feet of an environmentally sensitive habitat. A biological report- Natural Environmental Study (NESMI *biological report*), was prepared for the site and submitted to the County for review (see Finding 2, Evidence "c"). The NESMI biological report identified the potential for several environmentally sensitive habitats to occur near the project area and that suitable conditions for California red-legged frog and the Western pond turtle are present. The report found that it is unlikely that any frogs would be found in the actual project footprint; however, there may be the potential for minor direct and indirect impacts to the California redlegged frog and the Western pond turtle because of the existence of suitable habitat nearby. However, the project as proposes includes measures to avoid indirect impacts on nearby habitat. For example, grading, staging areas, and other improvements would be confined within the right-of-way. Additionally, measures contained in the Programmatic Biological Opinion outlined within the NESMI report would apply to the project. Therefore, although environmentally sensitive habitat may occur within close proximity to this project the potential for inadvertent impacts is limited, as further identified in Finding 8.
- i) <u>Public Access</u>. As demonstrated in Finding No. 5 and supporting evidence, the project is consistent with applicable public access policies.
- j) <u>Historical Resources.</u> The project includes changes to the Castro Canyon bridge, which was constructed in 1937. As such, staff required a historical assessment report for the proposed development. *The Historical Resources Evaluation Report*, Prepared by Lindsay Kozub, Principal Architectural Historian (LIB210164)(see Finding 2, Evidence "c") concluded that the Castro Canyon bridge is not eligible

for listing in the National Register of Historic Places or California Register of Historical Resources as an individual resource, or as a contributor to the Carmel – San Simeon Highway District.

- Archeological and Cultural Resources. The project site is in an area k) identified in County records as having a high archaeological sensitivity. In addition to the Historic Resources Evaluation Report, the Historical Property Survey, dated September 2019 was conducted by Lindsay Kozub, Principal Architectural Resources Historian, and Alvin Rosa- Figueroa, PQS Co-Principal Investigator for Prehistoric Archaeology (LIB210164). The report included an Archaeological Survey Report and concluded that potential impacts to archaeological resources are not anticipated from the proposed project. There is no evidence that any cultural resources would be disturbed as part of this project, and the potential for inadvertent impacts to cultural resources is limited and will be controlled by application of the County's standard project condition (Condition No. 3) which requires the contractor to stop work if previously unidentified resources are discovered during construction.
- The application, plans and supporting materials submitted by the project applicant to Monterey County HCD-Planning for the proposed development found in Project File PLN210039.
- 2. **FINDING: SITE SUITABILITY** The site is physically suitable for the proposed development and/or use.
  - **EVIDENCE:** a) The project involves rail safety improvements and upgrades to the Castro Canyon bridge, improvements to crash cushions, and a new retaining wall to improve and protect the highway facility at this location.
    - b) The project was reviewed for site suitability by the following departments and agencies: HCD-Planning, CalFire Coastal (Fire Protection District), HCD-Engineering Services, and HCD-Environmental Services. County staff reviewed the application materials and plans, as well as the County's GIS database, to verify that the proposed project on the subject site conforms to the applicable plans and regulations, and that the site is suitable for the proposed development. There has been no indication from these departments/agencies that the site is not suitable for the proposed development. Conditions recommended have been incorporated.
    - c) Several technical reports have been prepared for the proposed project and include the following:
      - <u>Geotechnical Report (LIB210163)</u>, Prepared by Caroline Chen, West Geotechnical Services, March 21, 2021.
      - <u>Cultural Resources Reports</u>: Historical Property Survey and Historic Resources Evaluation Report (LIB210164), prepared by Lindsay Kozub, Principal Architectural Resources Historian, Caltrans Central Coast Cultural Resources Branch, San Luis Obispo, California and also Alvin Rosa- Figueroa, PQS Co-Principal Investigator for Prehistoric Archaeology, dated September 2019;
      - <u>Biology Report</u>: *Natural Environment Study*, (LIB210162) prepared by Stephanie Herbert, Associate Environmental Planner,

Caltrans District 5, San Luis Obispo, California, December 12, 2019 and;

- <u>Visual Impact Assessment</u> (LIB210200) prepared by Robert Carr, Caltrans District 5 Landscape Architecture Branch, San Luis Obispo, California, January 2020.
- d) County staff independently reviewed these reports and concurs with their conclusions. There are no physical or environmental constraints that would indicate that the site is not suitable for the use proposed, and all development shall be in accordance with these reports.
- e) Staff reviewed application materials, County GIS information, and aerial imagery, to verify site suitability for the proposed development.
- f) The application, plans and supporting materials submitted by the project applicant to Monterey County HCD-Planning for the proposed development found in Project File PLN210039.

# 3. **FINDING: HEALTH AND SAFETY** – The establishment, maintenance, or operation of the project applied for will not under the circumstances of this particular case be detrimental to the health, safety, peace, morals, comfort, and general welfare of persons residing or working in the neighborhood of such proposed use, or be detrimental or injurious to property and improvements in the neighborhood or to the general welfare of the County.

- **EVIDENCE:** a) The project was reviewed by HCD-Planning, CalFire Coastal (Fire Protection District), HCD-Engineering Services, and HCD-Environmental Services. Conditions have been recommended, where appropriate, to ensure that the project will not have an adverse effect on the health, safety, and welfare of persons either residing or working in the neighborhood.
  - b) The project will bring bridge rail design standards up to current safety guidelines to reduce vehicle crash impacts. The project is necessary to maintain service essential to the public health, safety, and welfare of persons either residing or working in the Big Sur community.
  - c) As proposed, the project is a safety improvement that would stabilize the highway facility at this location. Therefore, it is consistent with LUP Policy 4.1.2.1, which states "Improvements to Highway 1 shall be undertaken in order to increase its service capacity and safety, consistent with its retention as a scenic two-lane road."
  - d) See also Finding Nos. 1, 2, 3, 6 and 7, and supporting evidence.
  - e) The application, plans, and supporting materials submitted by the project applicant to Monterey County HCD-Planning for the proposed development found in Project File PLN210039.
- 4. **FINDING: NO VIOLATIONS** The subject property is in compliance with all rules and regulations pertaining to zoning uses, subdivision, and any other applicable provisions of the County's zoning ordinance. No violations exist on the property.
  - **EVIDENCE:** a) Staff reviewed Monterey County HCD-Planning and HCD-Building Services records and is not aware of any violations existing on the subject property.
    - b) There are no violations on the subject parcel or project site.

- c) The application, plans and supporting materials submitted by the project applicant to Monterey County HCD-Planning for the proposed development found in Project File PLN210039.
- 5. FINDING: PUBLIC ACCESS The project is in conformance with the public access and recreation policies of the Coastal Act (specifically Chapter 3 of the Coastal Act of 1976, commencing with Section 30200 of the Public Resources Code) and applicable Local Coastal Program, and does not interfere with any form of historic public use or trust rights. No substantial adverse impact on access, either individually or
  - cumulatively, as described in Section 20.145.150 of the Monterey County Coastal Implementation Plan (Part 3) can be demonstrated.
    - b) No evidence or documentation has been submitted or found showing the existence of historic public use or trust rights over this property.
    - c) The subject property is described as an area where the Local Coastal Program requires public access (LUP Figure 3; Trails Plan – North Section). Public access presently exists along the State Route 1 rightof-way (a public highway), and the proposed development would not obstruct this lateral access along the highway facility. Additionally, as proposed, the project would not obstruct public views of the shoreline from the highway nor obstruct public visual access.
    - d) The project planner reviewed plans of the proposed development, as well as aerial imagery of the site and surrounding area, to verify that the proposed structures will not impact visual resources/access.
    - e) The application, plans and supporting materials submitted by the project applicant to Monterey County HCD-Planning for the proposed development found in Project File PLN210039.

#### 6. **FINDING: DEVELOPMENT WITHIN THE BIG SUR CRITICAL**

**VIEWSHED** – The subject project minimizes development within the Big Sur Critical Viewshed in accordance with the applicable goals and policies of the Big Sur Coast Land Use Plan and applicable zoning codes.

- **EVIDENCE:** a) The project includes application for development within the Big Sur Critical Viewshed. In accordance with the applicable policies of the Big Sur Coast Land Use Plan (LUP) and the Monterey County Zoning Ordinance (Title 20), a Coastal Development Permit is required and the authority to grant said permit has been met.
  - b) The proposed project involves restriping, replacement and installation of new bridge and approach rails, upgrading guardrails on the north and south of the bridge, and installation of crash cushions. The proposed guardrail replacement is compliant with current design and safety standards per American Association of State Highway and Transportation Officials (AASHTO) requirements. The proposed replacement bridge rail will be concrete post and beam rail (Type 85 bridge rail) and "see through" metal that is taller and wider than the existing rail.
  - c) County staff reviewed plans of the proposed development, as well as aerial imagery of the site and the surrounding area, to assess the potential viewshed impacts of the project and ensure consistency with applicable LUP policies. LUP Policy 3.2.5.C.1 allows exceptions to

the Scenic Resources Key Policy involving safety improvements to Highway 1 facilities, provided they are consistent with LUP Sections 4.1.1, 4.1.2., and 4.1.3. Key Policy 4.1.1 states that the County's objective is to maintain and enhance the highway's aesthetic beauty and to protect its primary function as a recreational route. General Policy 4.1.2.1 directs that improvements to Highway 1 shall be undertaken in order to increase its service capacity and safety, consistent with its retention as a scenic two-lane road. County staff has reviewed the required sections, and the project is consistent with the subject policies. The project is an improvement that is needed to comply with current bridge rail safety standards that, as proposed, will maintain the roadway and its continued use as a two-lane highway for access to the Big Sur community.

- County staff reviewed and analyzed using independent judgement the d) Visual Impact Assessment (LIB210200), and the project visual simulations and found that the project will not have a significant effect on the views of the surround on the views of the surround scenic vista and landscape. Castro Canyon bridge is located in an area with dense vegetation and much of the visual context includes the redwood trees surrounding the bridge and highway. Also, the historic Deetjens's Inn is located adjacent to the bridge and includes rustic wood cabin style architecture. The bridge upgrade project would replace the existing white wooden post bridge rail with an aesthetically treated, open-style rails. The improvements include light tan concrete rail with dark brown metal approach rails, guardrails, end treatments, and crash cushions (refer to Attachment 3). The purpose of the design is to be simple with the intention of blending in with the rural background including the natural settings and rustic settings.
- e) The project, as proposed and conditioned, is consistent with policies of the Big Sur Coast Land Use Plan dealing with visual resources and will have no significant impact on the critical viewshed.
- f) The application, plans and supporting materials submitted by the project applicant to the Monterey County Planning Department for the proposed development are found in Project File PLN210039.

#### 7. FINDING: DEVELOPMENT ON SLOPES EXCEEDING 30 PERCENT –

There is no feasible alternative which would allow development to occur on slopes of less than 30 percent.

- **EVIDENCE:** a) Pursuant to the policies of the 1982 General Plan, Big Sur Coast Land Use Plan (LUP) and applicable Monterey County Code (MCC), a Coastal Development Permit is required for development on slopes in excess of 30% and the criteria to grant said permit has been met in this case.
  - b) The project site is located over the Castro Canyon Bridge on State Route 1. Based on site topography, improvements to the bridge, and drainage inlet areas, and the construction of an additional retaining wall is not feasible without encroaching into slopes exceeding 30 percent. The proposed development is necessary to improve traffic safety at the highway facility by improving crash cushions and installing bridge rails that will be higher and able to withstand more impact upon collision.

- c) As proposed, the subject project minimizes development on slopes exceeding 30 percent in accordance with the applicable goals and policies of the LUP. The project planner reviewed the plans and application materials to analyze possible development alternatives and to verify the subject project minimizes development on slopes exceeding 30 percent. Also, the project proposes to further stabilize the bridge and immediate area as the purpose of the retaining wall proposed to be constructed east of the southern bridge abutment will prevent upslope debris from entering and resting on the bridge structure. Rockslope protection will be added to the existing outlet of the southwest drain which will also improve drainage. This is the minimum necessary to provide adequate and safe site when traveling this section of road.
- d) The application, project plans, and related support materials submitted by the project applicant to Monterey County HCD-Planning for the proposed development found in Project File PLN210039.

#### 8. FINDING: DEVELOPMENT WITHIN 100 FEET OF ENVIRONMENTALLY SENSITIVE HABITAT-

- **EVIDENCE:** a) The project site is in an area identified as being within 100 feet of an environmentally sensitive habitat. MCC Section 20.145.040 requires a biological survey for development in areas within Big Sur that are within 100 feet of environmentally sensitive habitat.
  - b) The following biological report was prepared for the proposed project and was submitted to the County for review:
    - Biology Report: Natural Environment Study, (LIB210162) prepared by Stephanie Herbert, Associate Environmental Planner, Caltrans District 5, San Luis Obispo, California, December 12, 2019.
  - c) The NESMI biological report identified the potential for several environmentally sensitive habitats to occur near the project area and that suitable conditions for California red-legged frog and the Western pond turtle are present. The report found that it is unlikely that any frogs would be found in the actual project footprint; however, there may be the potential for minor direct and indirect impacts to the California red-legged frog and the Western pond turtle because of the existence of suitable habitat nearby.
  - d) Monterey County Code (MCC) Section 20.145.040, which includes the Environmentally Sensitive Habitat Development Standards in the Big Sur, requires that all practical efforts shall be made to maintain, restore, and if possible, enhance Big Sur's environmentally sensitive habitats.

The project as proposes measures to avoid indirect impacts on nearby habitat. As proposed, grading, staging areas, and other improvements would be confined within the right-of-way. Also, in order to ensure the area of disturbance is confined, the biological report recommends installation of protective fencing, re-seeding disturbed ground with native seed mix, and stockpiling and replacement of any woody debris found onsite. Erosion control measures and other best management practices would be in place during construction to avoid indirect impacts on nearby habitat. Caltrans also anticipates that the proposed project would be covered under the Programmatic Biological Opinion for Projects Funded or Approved under the FHWA's Federal Aid Program for incidental take. As such, measures contained in the Programmatic Biological Opinion would apply to the project. A condition of approval has been incorporated which requires the applicant to file a Notice of Report stating that all development shall be done in accordance with the NESMI biological report. Therefore, although a environmentally sensitive habitat may occur within close proximity to this project the potential for inadvertent impacts is limited.

- e) County staff independently reviewed these reports and concurs with their conclusions.
- f) The application, plans and supporting materials submitted by the project applicant to Monterey County HCD-Planning for the proposed development found in Project File PLN210039.

# 9. **FINDING: CEQA (Exempt)** – The project is categorically exempt from environmental review and no unusual circumstances were identified to exist for the proposed project.

- **EVIDENCE:** a) California Environmental Quality Act (CEQA) Guidelines Section 15303 categorically utility and street improvements. The exemption applies to water main, sewage, electrical, gas, and other utility extensions including street improvements, or reasonable length to serve such construction.
  - b) The proposed project involves the utility and street improvements for bridge safety improvements, which qualifies as a Class 3 categorical exemption pursuant to Section 15303 of the CEQA Guidelines. This project includes the underground placement of utilities, the construction of retaining wall to protect from slope movement, and street improvements consisting of the bridge safety. The proposed project involves safety improvements that would upgrade and protect the users of this highway facility and help prevent future car collisions at this location. Therefore, the proposed development qualifies as a Class 3 categorical exemption pursuant to Section 15303(d) of the CEQA Guidelines.
  - c) Caltrans, as Lead Agency, applied the Class 3 categorical exemption to the project. The County, serving as a responsible agency for this project, in its independent judgment has also determined that the project is categorically exempt. The Caltrans CEQA Determination is attached as Exhibit C to the staff report.
  - d) None of the exceptions under CEQA Guidelines Section 15300.2 apply to this project. Also, there is no substantial evidence of an unusual circumstance because there is no feature or condition of the project that distinguishes the project from the exempt class. The project does not involve a hazardous waste site, unusual circumstances that would result in a significant effect or development that would result in a cumulative significant impact. The project site is located within view of a scenic highway (State Route 1); however, the development proposed is consistent with the existing development on the site and in the area, and will not result in an adverse impact to

visual resources (see also Finding No. 6 and supporting evidence). Additionally, as proposed, the development would not result in damage to scenic resources such as trees, historic buildings, rock outcroppings, or similar resources as described in CEQA Guidelines Section 15300.2.

- e) Based on the record as a whole, there is no substantial evidence that would support a fair argument that the project has a reasonable possibility of having a significant effect on the environment or that it would result in a cumulative significant impact. The evidence in the record includes data and analysis supporting the Class 1 categorical exemption; information presented or discussed during public meetings and/or hearings; staff reports that reflect the County's independent judgment and analysis regarding the above referenced data and analysis, and project application materials.
- f) No adverse environmental effects were identified during staff review of the development application.
- g) The Planning Commission considered the Class 3 categorical exemption at a duly noticed public hearing. The materials upon which the County's decision is based are located in HCD-Planning, 1441 Schilling Place, 2<sup>nd</sup> Floor, Salinas, California.
- h) The application, project plans, and related support materials submitted by the project applicant to Monterey County HCD-Planning for the proposed development found in Project File PLN210039.
- 10. **FINDING:** APPEALABILITY The decision on this project may be appealed to the Board of Supervisors and the California Coastal Commission.
  - **EVIDENCE:** a) <u>Board of Supervisors</u>. Pursuant to Section 20.86.030 of the Monterey County Zoning Ordinance (Title 20), an appeal may be made to the Board of Supervisors by any public agency or person aggrieved by a decision of an Appropriate Authority other than the Board of Supervisors.
    - b) <u>Coastal Commission</u>. Pursuant to Section 20.86.080.A of the Monterey County Zoning Ordinance (Title 20), the project is subject to appeal by/to the California Coastal Commission because it involves development between the sea and the first through public road paralleling the sea (State Route 1), and development that is permitted in the underlying zone as a conditional use (i.e., development within the Big Sur critical viewshed).

#### **DECISION**

**NOW, THEREFORE**, based on the above findings and evidence, the Planning Commission does hereby:

- 1. Find that the project qualifies as a Class 3 Categorical Exemption pursuant to Section 15303 of the CEQA Guidelines, and there are no exceptions pursuant to Section 15300.2; and
- 2. Approve a Combined Development Permit consisting of a:
  - a. Coastal Development Permit and Design Approval to allow safety improvements to the Castro Canyon Bridge, inclusive of restriping of lanes, bridge rail and crash cushion upgrades, placement of a new retaining wall, and drainage upgrades;

b. Coastal Development Permit to allow development within the Big Sur Critical Viewshed; *PLN210039 – CALTRANS Page 11* 

c. Coastal Development Permit to allow development on slopes exceeding 30 percent; and

d. Coastal Development Permit to allow development within 100 feet of environmentally sensitive habitat.

All development shall be in general conformance with the attached plans and subject to the attached conditions, all being attached hereto and incorporated herein by reference.

**PASSED AND ADOPTED** this 9<sup>th</sup> day of March 2022.

AYES: Getzelman, Diehl, Roberts, Gonzalez, Ambriz, Monsalve, Coffelt, Daniels, Mendoza NOES: None ABSENT: None ABSTAIN: None

Craig Spencer Craig Spencer, Planning Commission Secretary

#### COPY OF THIS DECISION MAILED TO APPLICANT ON MAR 18 2022.

THIS APPLICATION IS APPEALABLE TO THE BOARD OF SUPERVISORS. IF ANYONE WISHES TO APPEAL THIS DECISION, AN APPEAL FORM MUST BE COMPLETED AND SUBMITTED TO THE CLERK TO THE BOARD ALONG WITH THE APPROPRIATE FILING FEE ON OR BEFORE MAR 28 2022.

THIS PROJECT IS LOCATED IN THE COASTAL ZONE AND IS APPEALABLE TO THE COASTAL COMMISSION. UPON RECEIPT OF NOTIFICATION OF THE FINAL LOCAL ACTION NOTICE (FLAN) STATING THE DECISION BY THE FINAL DECISION MAKING BODY, THE COMMISSION ESTABLISHES A 10 WORKING DAY APPEAL PERIOD. AN APPEAL FORM MUST BE FILED WITH THE COASTAL COMMISSION. FOR FURTHER INFORMATION, CONTACT THE COASTAL COMMISSION AT (831) 427-4863 OR AT 725 FRONT STREET, SUITE 300, SANTA CRUZ, CA.

This decision, if this is the final administrative decision, is subject to judicial review pursuant to California Code of Civil Procedure Sections 1094.5 and 1094.6. Any Petition for Writ of Mandate must be filed with the Court no later than the 90th day following the date on which this decision becomes final.

#### NOTES

1. This permit expires 3 years after the above date of granting thereof unless construction or use is started within this period.

#### Monterey County RMA Planning

#### Conditions of Approval/Implementation Plan/Mitigation Monitoring and Reporting Plan

PLN210039

#### 1. PD001 - SPECIFIC USES ONLY

Responsible Department: RMA-Planning

Condition/Mitigation This Combined Development Permit (PLN210039) allows Coastal for: 1) а **Monitoring Measure:** Development Permit and Design Approval to allow safety improvements to the Castro Canyon Bridge, inclusive of restriping of lanes, bridge rail and crash cushion upgrades, placement of a new retaining wall, and drainage upgrades; 2) a Coastal Development Permit to allow development within the Big Sur Critical Viewshed: 3)Coastal Development Permit to allow development on slopes exceeding 30 percent; and 4) Coastal Development Permit to allow development within 100 feet of environmentally sensitive habitat.

> The property is located at State Route 1 (Highway 1), Post Mile 43.12, Castro Canyon Bridge (Br. No. 44-0035, between Post-Mile Markers 43.05 - 43.25), Big Sur, (Assessor's Parcel Number 000-000-000, Big Sur Coast Land Use Plan. This permit was approved in accordance with County ordinances and land use regulations subject to the terms and conditions described in the project file. Neither the uses nor the construction allowed by this permit shall commence unless and until all of the conditions of this permit are met to the satisfaction of the Director of HCD - Planning. Any use or construction not in substantial conformance with the terms and conditions of this permit is a violation of County regulations and may result in modification or revocation of this permit and subsequent legal action. No use or construction other than that specified by this permit is allowed unless additional permits are approved by the appropriate authorities. To the extent that the County has delegated any condition compliance or mitigation monitoring to the Monterey County Water Resources Agency, the Water Resources Agency shall provide all information requested by the County and the County shall bear ultimate responsibility to ensure that conditions and mitigation measures are properly fulfilled. (HCD - Planning)

Compliance or Monitoring Action to be Performed: The Owner/Applicant shall adhere to conditions and uses specified in the permit on an ongoing basis unless otherwise stated.

#### 2. PD002 - NOTICE PERMIT APPROVAL

Responsible Department: RMA-Planning

Condition/Mitigation The applicant shall record a Permit Approval Notice. This notice shall state:

"A Combined Development Permit (Resolution Number 22-004) was approved by the Planning Commission for Assessor's Parcel Number 000-000-000-000, Castro Canyon Bridge (Br. No. 44-0035, Post Mile 43.12, located between Post-Mile Markers 43.05 – 43.25), on March 9, 2022. The permit was granted subject to four( 4) conditions of approval which run with the land. A copy of the permit is on file with Monterey County HCD - Planning."

Proof of recordation of this notice shall be furnished to the Director of HCD - Planning prior to issuance of grading and building permits, Certificates of Compliance, or commencement of use, whichever occurs first and as applicable. (HCD - Planning)

Compliance or<br/>Monitoring<br/>Action to be<br/>Performed:Prior to the issuance of grading and building permits, certificates of compliance, or<br/>commencement of use, whichever occurs first and as applicable, the Owner/Applicant<br/>shall provide proof of recordation of this notice to the HCD - Planning.

#### 3. PD003(A) - CULTURAL RESOURCES NEGATIVE ARCHAEOLOGICAL REPORT

#### Responsible Department: RMA-Planning

Performed:

**Condition/Mitigation** lf, during the course of construction, cultural, archaeological, historical or **Monitoring Measure:** paleontological resources are uncovered at the site (surface or subsurface resources) work shall be halted immediately within 50 meters (165 feet) of the find until a qualified professional archaeologist can evaluate it. Monterey County HCD - Planning and a qualified archaeologist (i.e., an archaeologist registered with the Register of Professional Archaeologists) shall be immediately contacted the by responsible individual present on-site. When contacted, the project planner and the archaeologist shall immediately visit the site to determine the extent of the resources and to develop proper mitigation measures required for recovery. (HCD - Planning)

Compliance or Monitoring Action to be

Prior to the issuance of grading or building permits and/or prior to the recordation of the final/parcel map, whichever occurs first, the Owner/Applicant shall include requirements of this condition as a note on all grading and building plans. The note shall state "Stop work within 50 meters (165 feet) of uncovered resource and contact Monterey County HCD - Planning and a qualified archaeologist immediately if cultural, archaeological, historical or paleontological resources are uncovered."


When contacted, the project planner and the archaeologist shall immediately visit the site to determine the extent of the resources and to develop proper mitigation measures required for the discovery.

#### 4. BIOLOGICAL REPORT-NOTICE OF REPORT

Responsible Department: RMA-Planning


Condition/Mitigation Monitoring Measure: The applicant shall file a Notice of Report stating that all development shall be done in accordance with the Natural Environment Study (LIB210162) biological report that was conducted on December 12, 2019, prior to the issuance of grading and/or building permits


**Compliance or Monitoring Action to be Prior to the issuance of grading and/or building permits, the Applicant shall submit, to <b>HCD-Planning, a Notice of Report stating that all development shall be done in accordance with the Natural Environment Study (LIB210162).** 

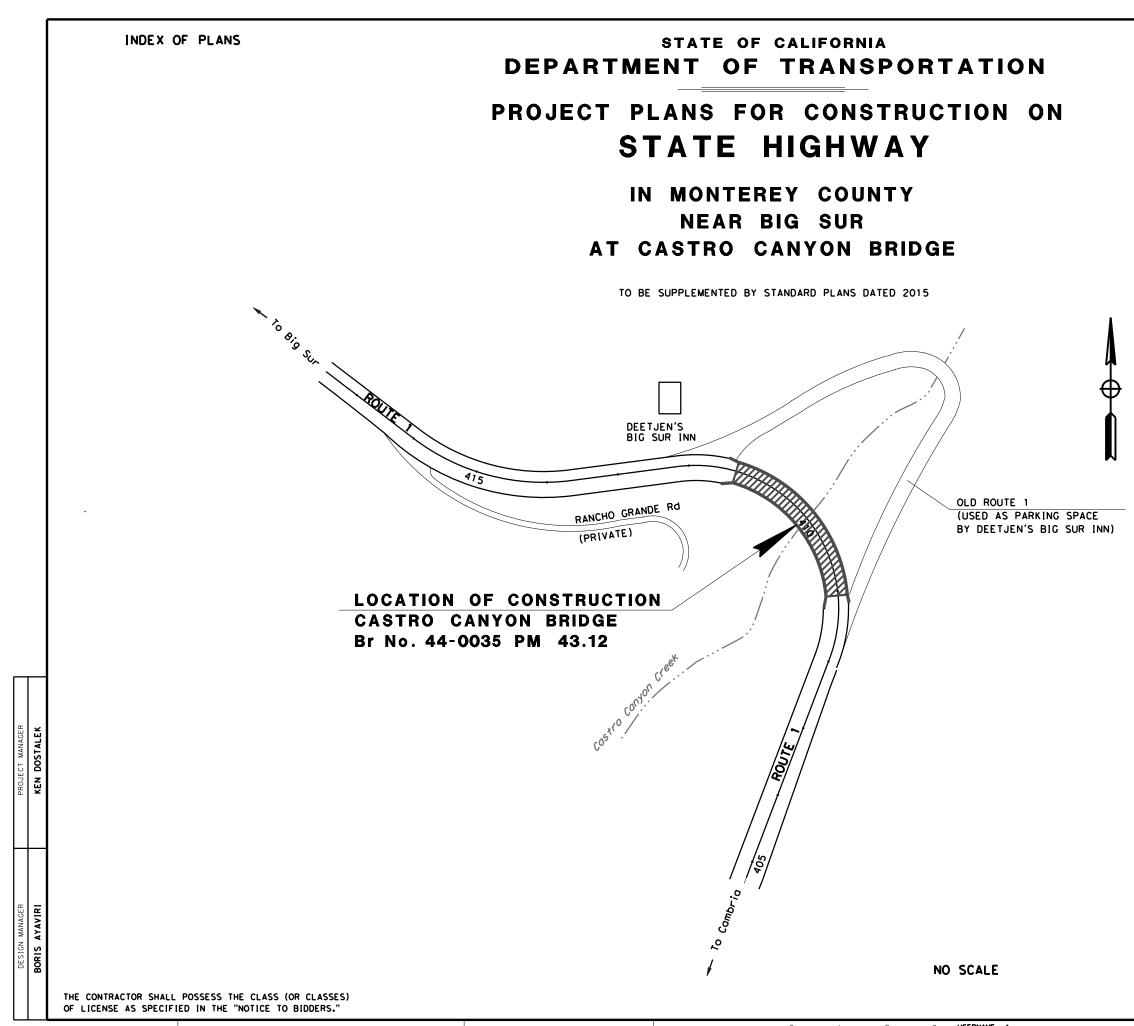


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THE STATE OF CALIFORNIA OR ITS OFFICERS OR AGENTS SHALL NOT BE RESPONSIBLE FOR THE ACCURACY OR COMPLETENESS OF SCANNED COPIES OF THIS PLAN SHEET.								


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PROJECT NUMBER & PHASE
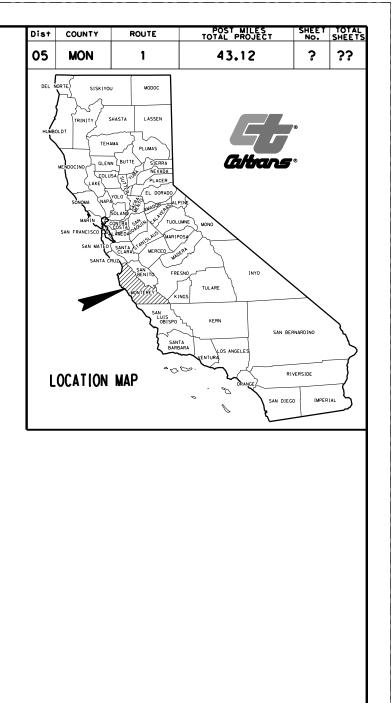
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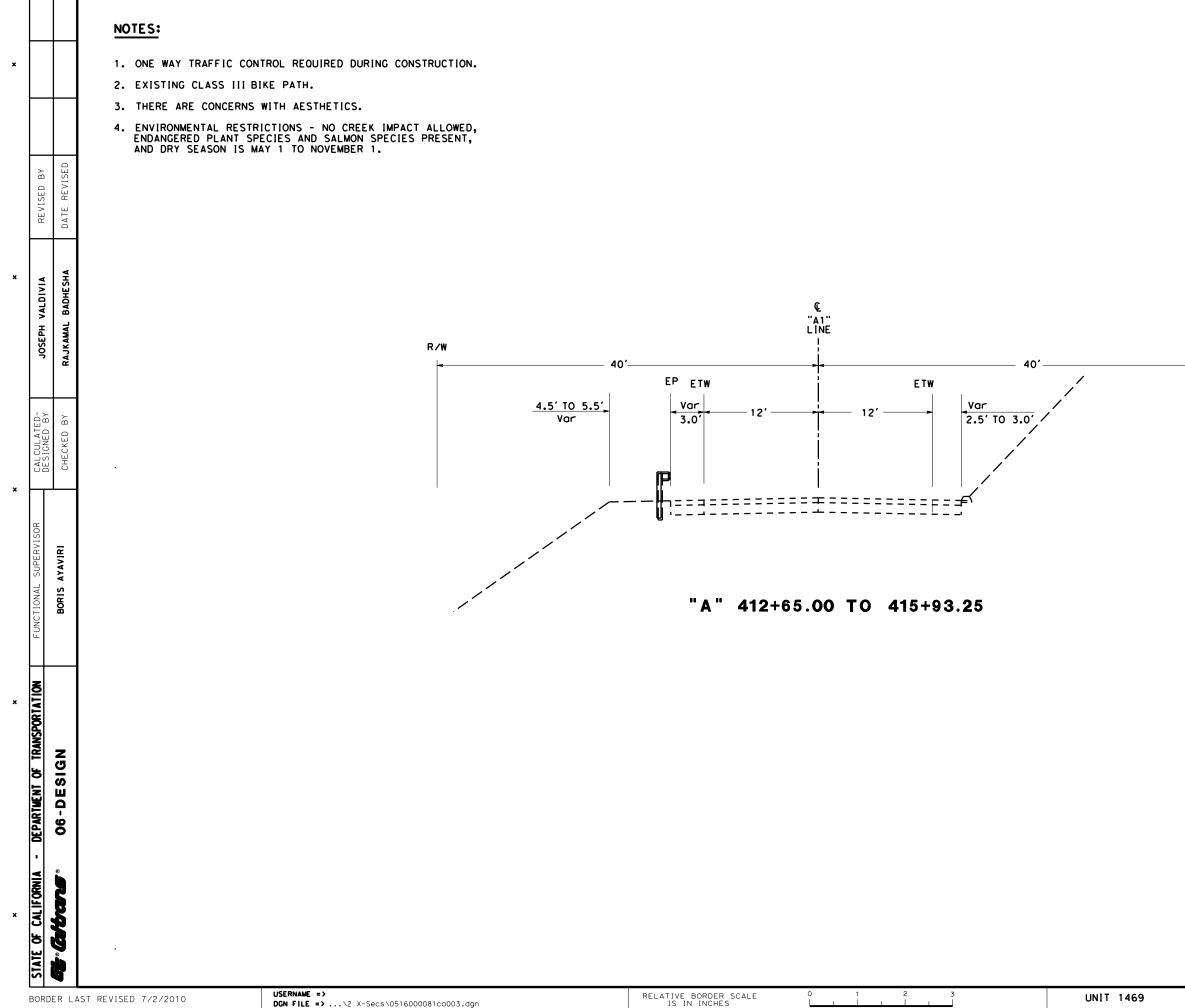
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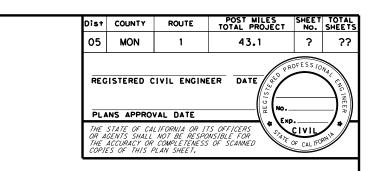

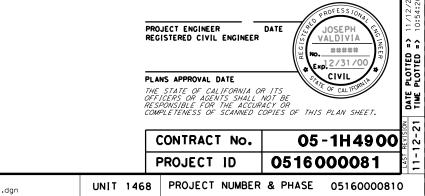
#### TYPICAL X-SECTIONS
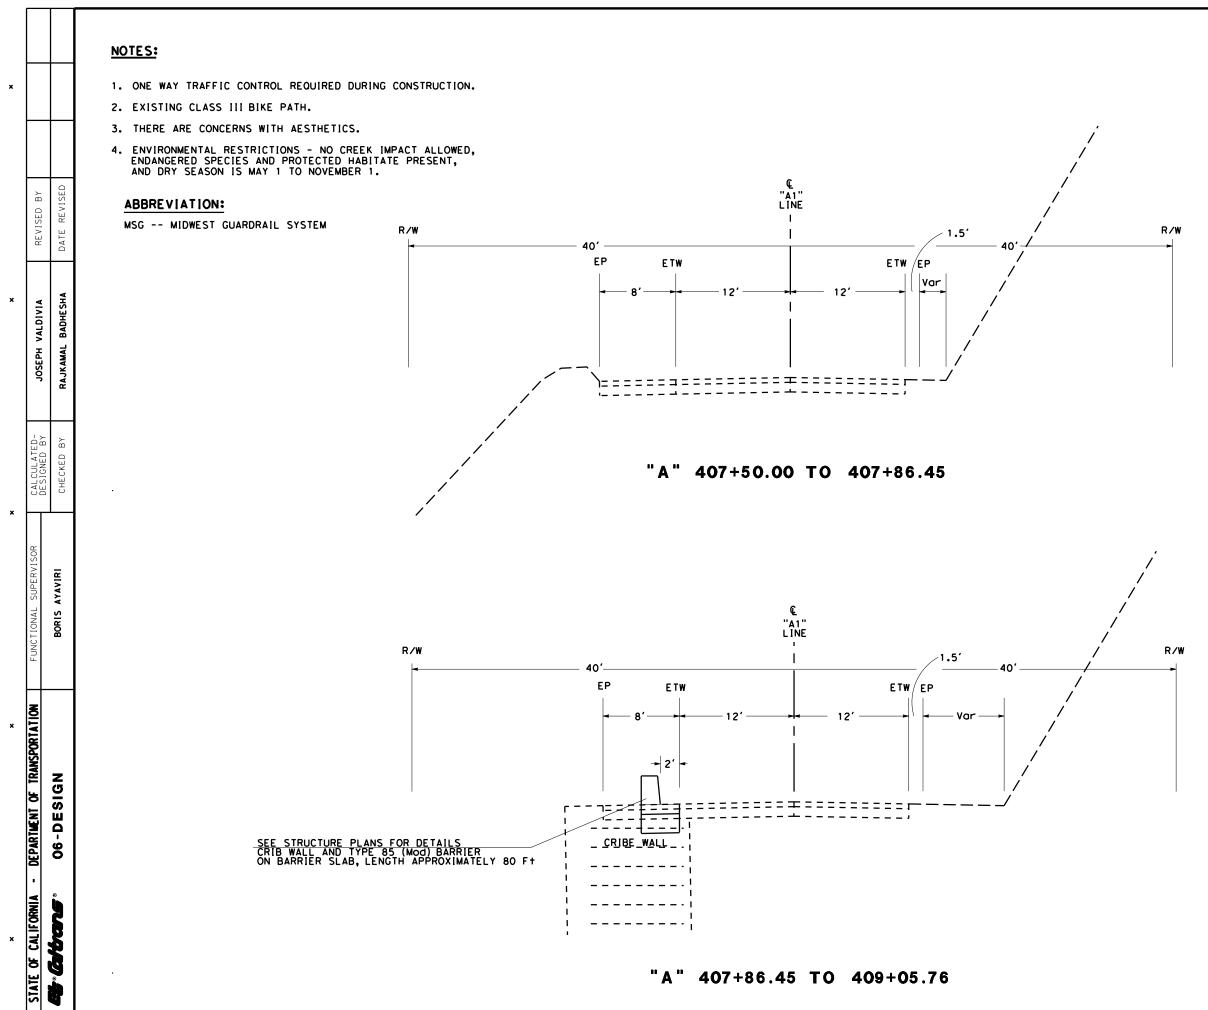
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#### **TYPICAL X-SECTIONS**

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- 1. FOR ACCURATE RIGHT OF WAY DATA, CONTACT RIGHT OF WAY ENGINEERING AT THE DISTRICT OFFICE.
- 2. DEETJEN'S INN HISTORIC PROPERTY TO BE AVOIDED DURING CONSTRUCTION.

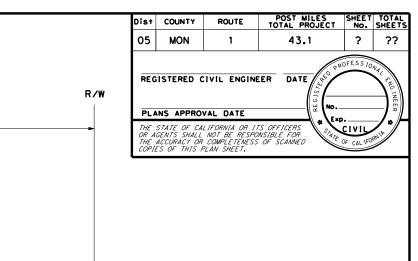
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#### ABBREVIATIONS

TR TRANSITION RAILIING



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 184.66'

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Costro Conyon Creek

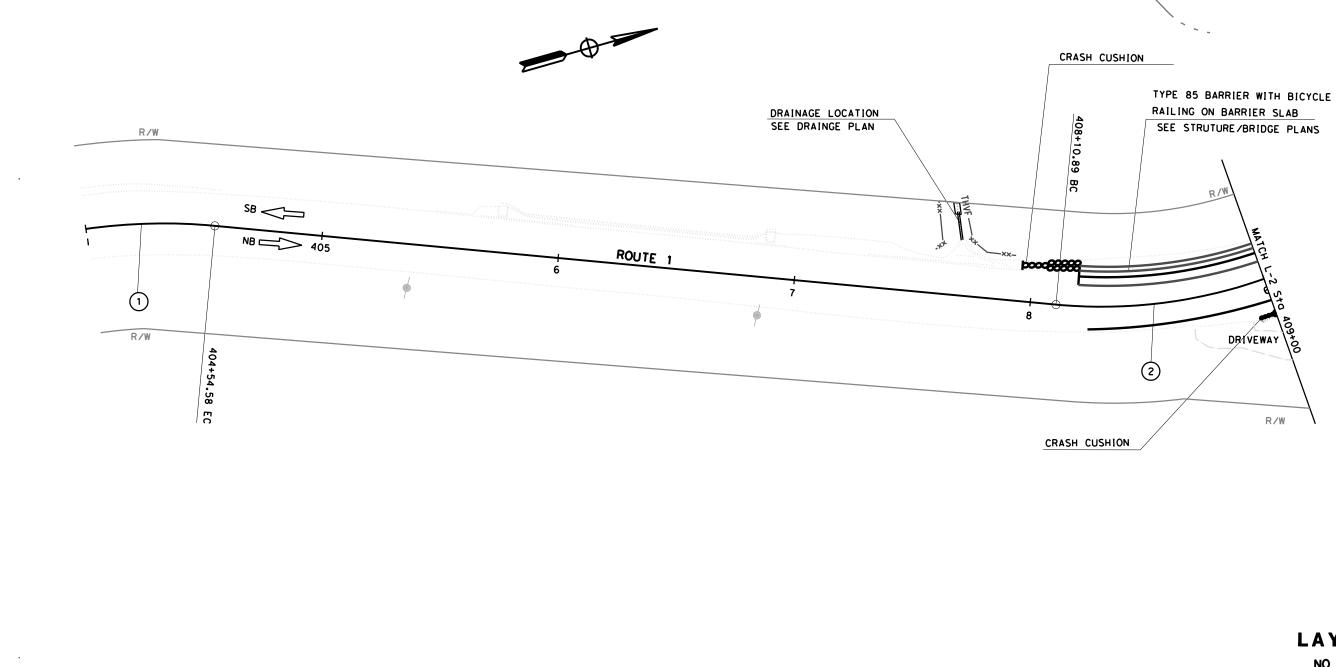
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#### LAYOUT PLAN NO SCALE L-1


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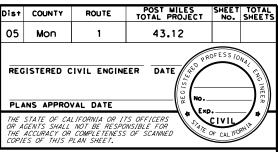
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#### LAYOUT PLAN

NO SCALE

L-3

# DALLED EDAGIAN CANTDAL DDADHAT

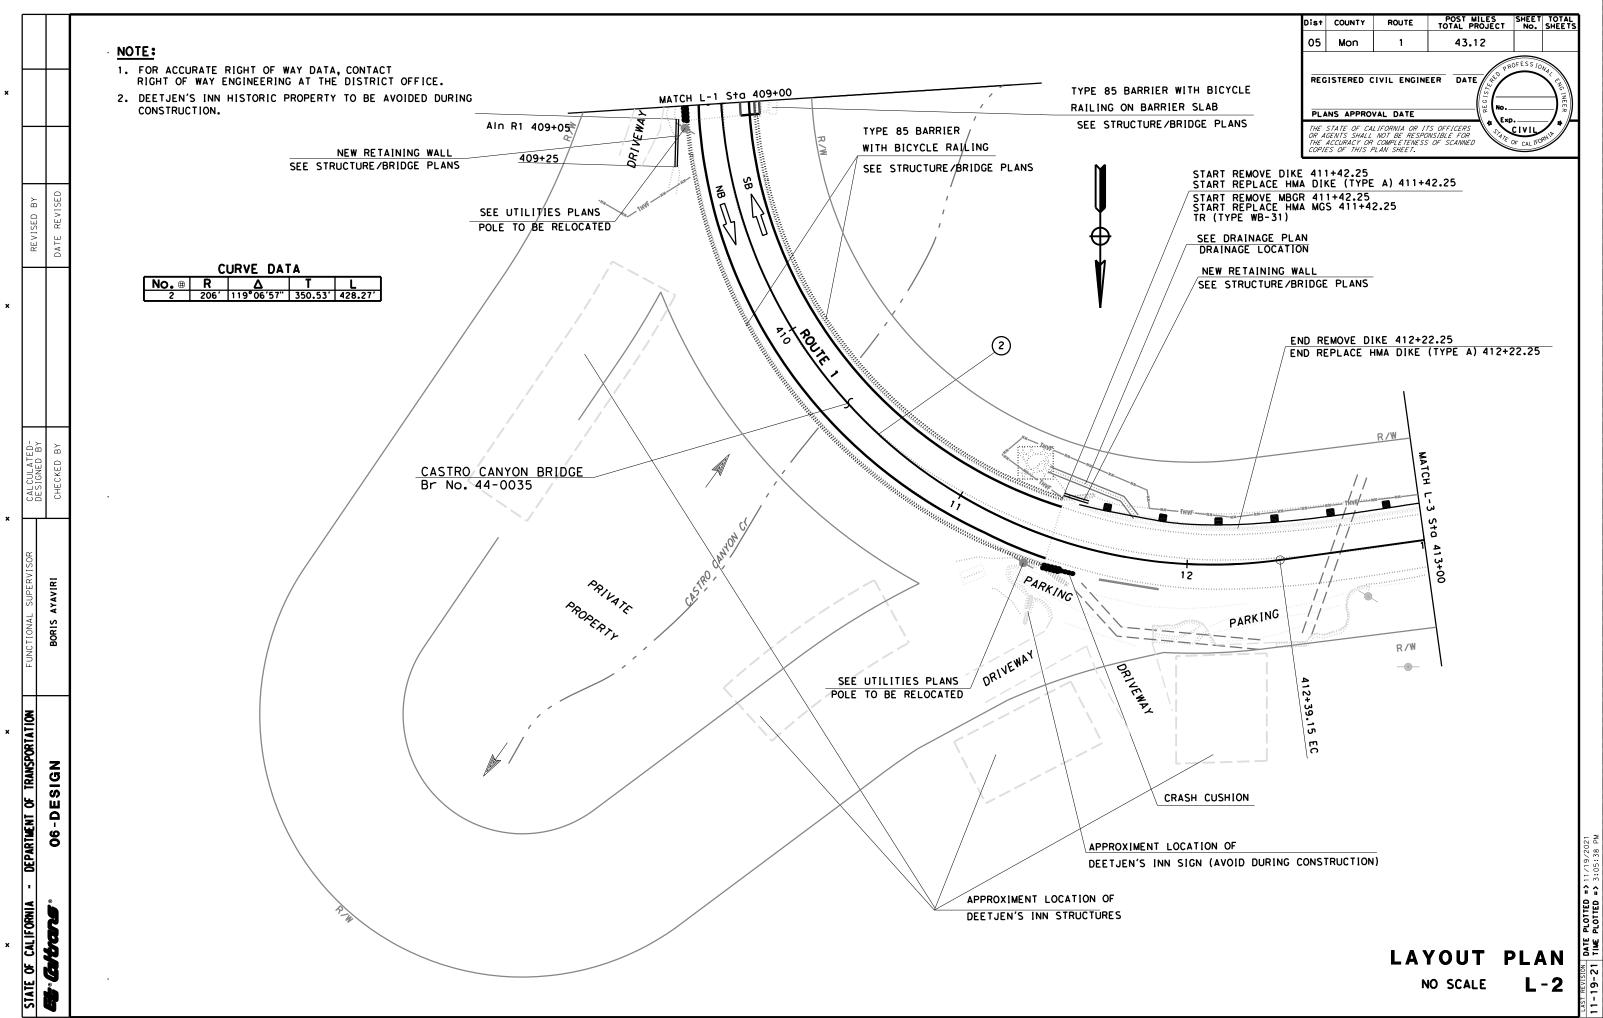	ROL	LED ERUSION	CONTROL PI	RODUCI	
				MATERIAL	
	SEQUENCE	ITEM	DESCRIPTION	TYPE	FASTENER
	INSTALL BEFORE DUFF Placement	ROLLED EROSION CONTROL PRODUCT (NETTING)	100% COIR NETTING (COCONUT FIBER)	ECTC TYPE 4 NETTING TYPE A	8-GAUGE, 8 INCH Steel staple
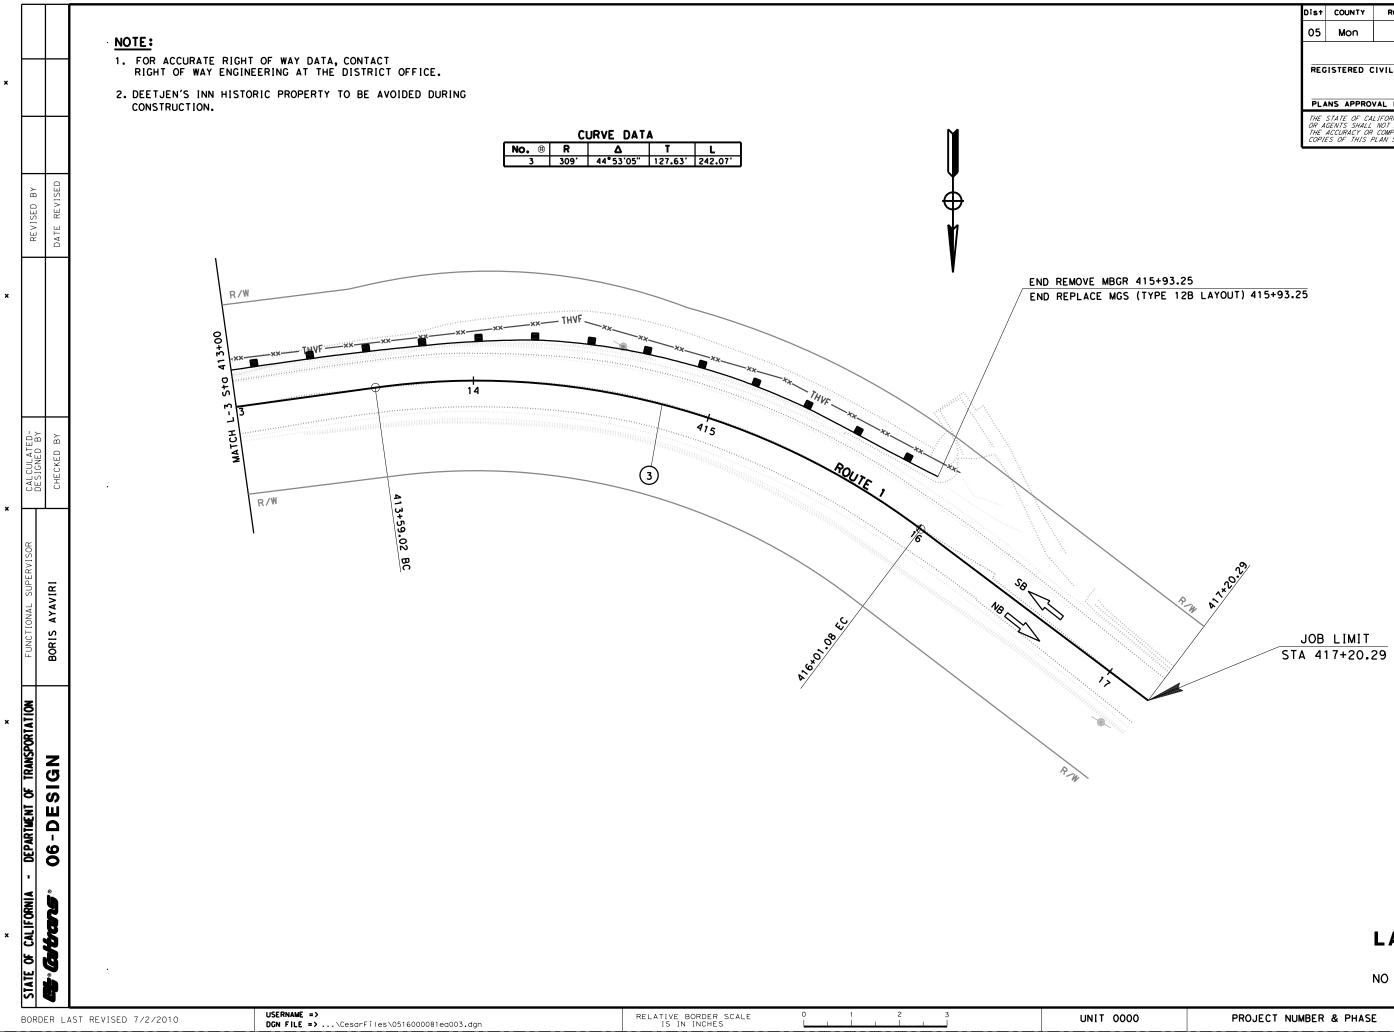
#### COMPOST SOCK


SEQUENCE	ITEM	MATERIAL	MATERIAL TYPE
INSTALL AFTER RECP (NETTING), BEFORE DUFF PLACEMENT	COMPOST SOCK	COMPOST FILLED BIODEGRAD-ABLE TUBE	8" DIA.

### DRY SEED

ITEM	MATERIAL		APPLICATION	REMARKS		
	DESCRIPTION	TYPE	RATE			
DRY SEED	SEED	MIX	15 LB/ACRE	MIX SEED WITH A MEDIUM SAND OR COMPOST TO APPLY		

#### SEED MIX

	•===	
BOTANICAL NAME (COMMON NAME)	PERCENT GERMINATION (MINIMUM)	POUNDS PURE LIVE SEED PER ACRE (SLOPE MEASUREMENT)
ACHILLEA MILLEFOLIUM (YARROW)	50	0.5
ARTEMESIA DOUGLASIANA (MUGWORT)	30	0.5
DESCHAMPSIA CESPITOSA SPP. HOLCIFORMIS (TUFTED HAIR GRASS)	70	8
FESTUCA MICROSTACHYS (SMALL FESCUE)	50	3
KOELERIA MACRANTHA (JUNE GRASS)	60	3

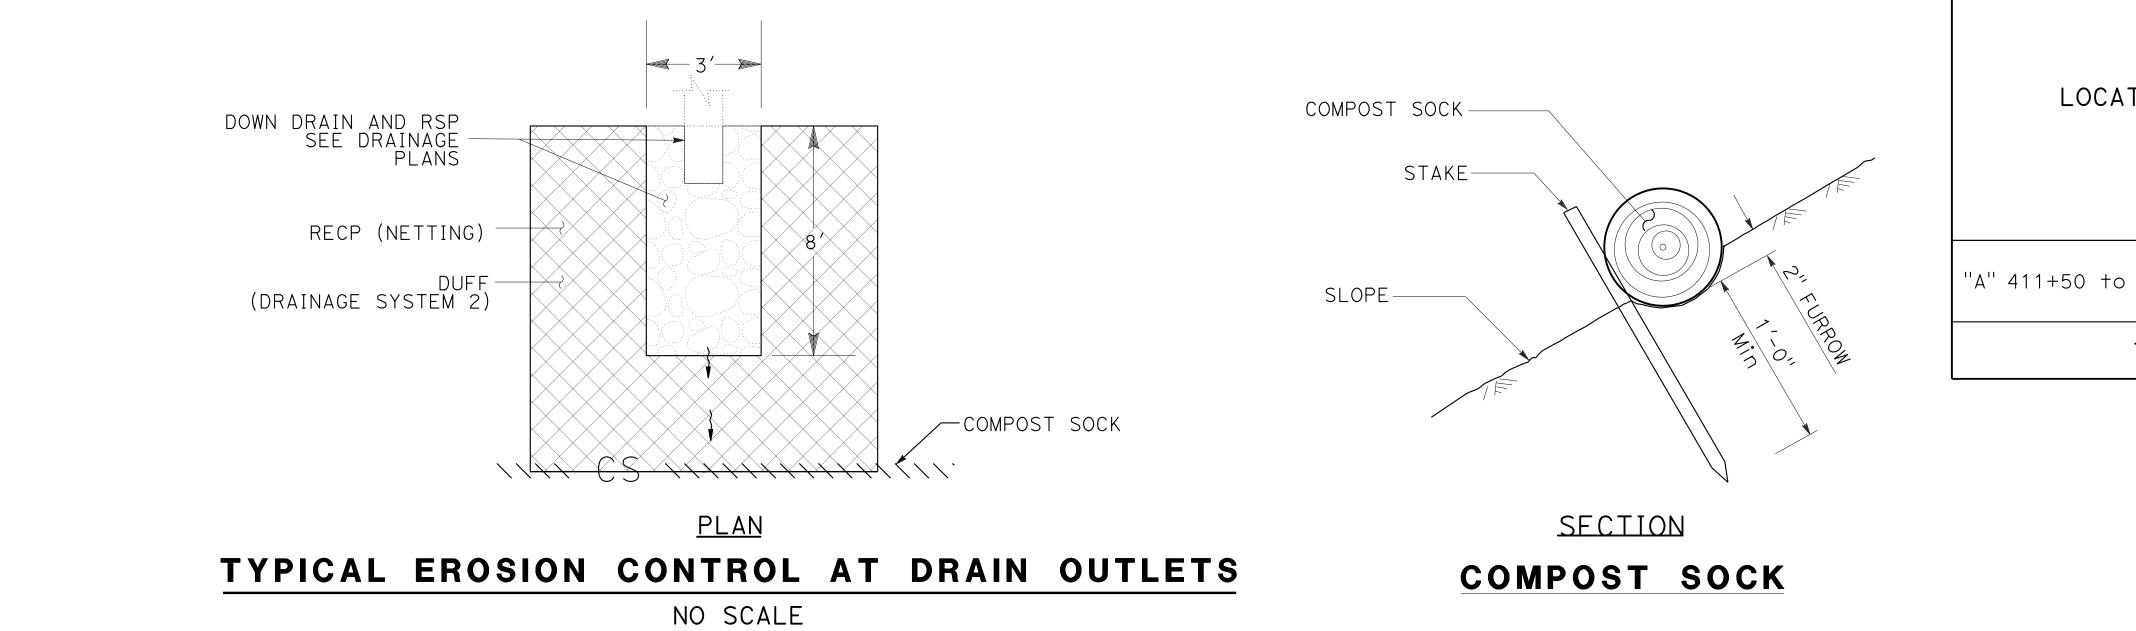

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JESSICA BAILEY PATRICK BOLGER

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LOCATION	COMPOST SOCK LF	DRY SEED	RECP (NETTING) SQFT	REMARKS
				SEE DRAINAGE PLANS
"A" 407+60 to 407+85 LF	15	220	220	AND DETAILS, SYTEM 1
"A" 411+50 to 412+50 RT		650	650	SEE DRAINAGE PLANS AND DETAILS, SYSTEM 2
"A" 407+85 to 409+50 RT	150	750		SEE SOLDER PILE WALL PLANS AND DETAILS
"A" 407+70 to 409+10 LF	60	600		SEE CRIB WALL REMOVAL PLANS AND DETAILS
TOTAL	225	2220	220	

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# **EROSION CONTROL QUANTITIES**

## **DUFF COLLECTION AND PLACEMENT**

	( N )	(N)				
LOCATION	DUFF COLLECTION	DUFF PLACEMENT		REMARKS		
	SQFT	SQFT	SQFI			
1+50 to 412+50 RT	650	650	650	SEE DRAINAGE PLANS AND DETAILS.		
TOTAL	650	650	650	PLACE DUFF IN DISTURBED SOIL AREAS.		


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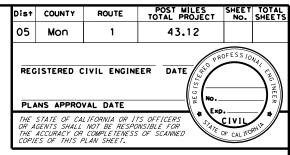
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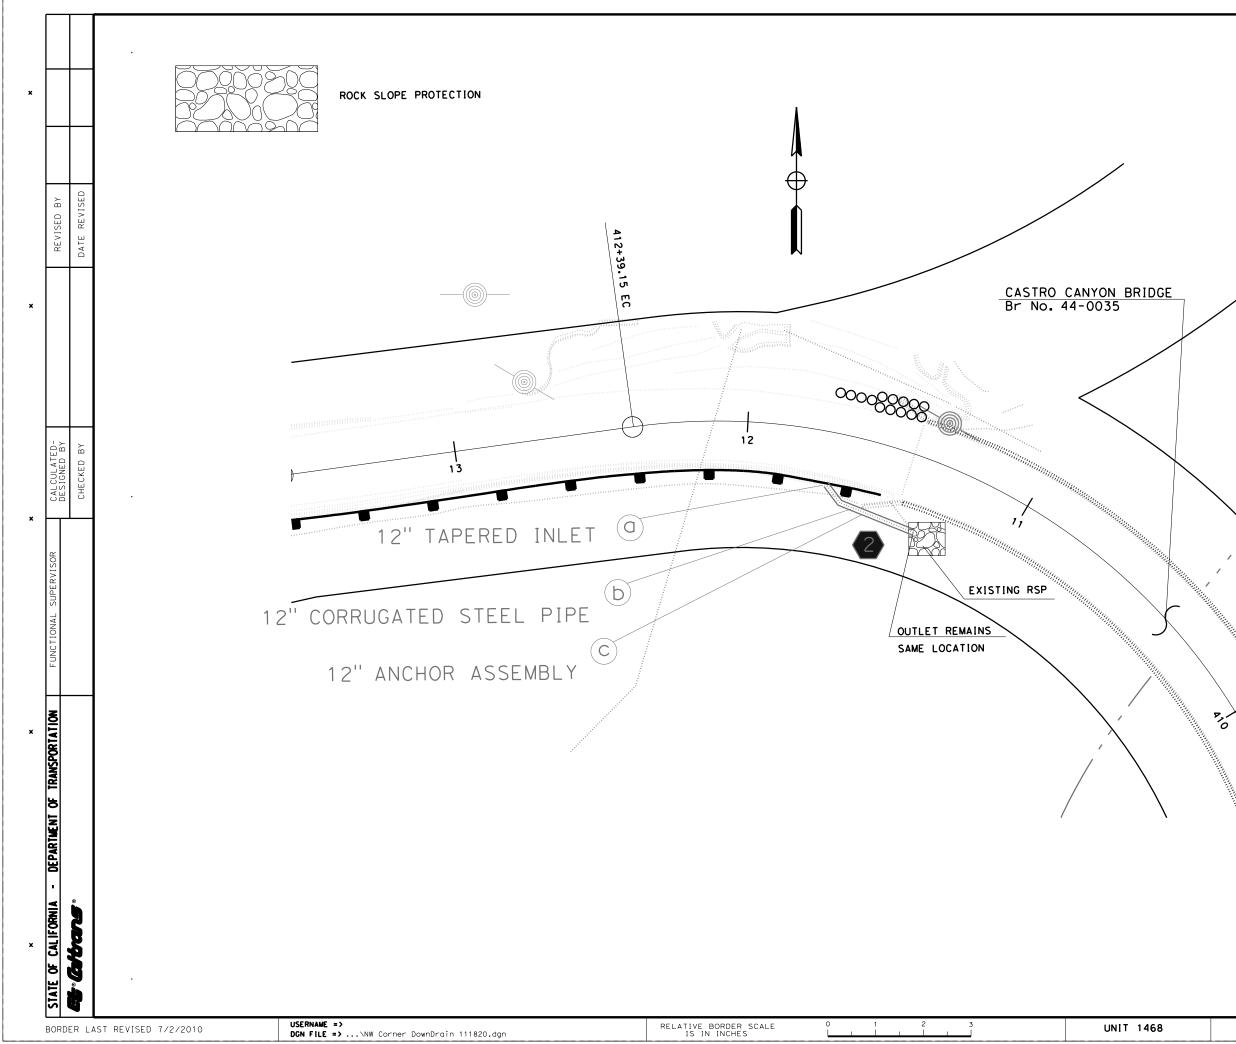


#### DRAINAGE PLAN

SCALE 1":50' DP-1

 LAST REVISION
 DATE
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 > 11 / 17 / 2021


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#### DRAINAGE PLAN

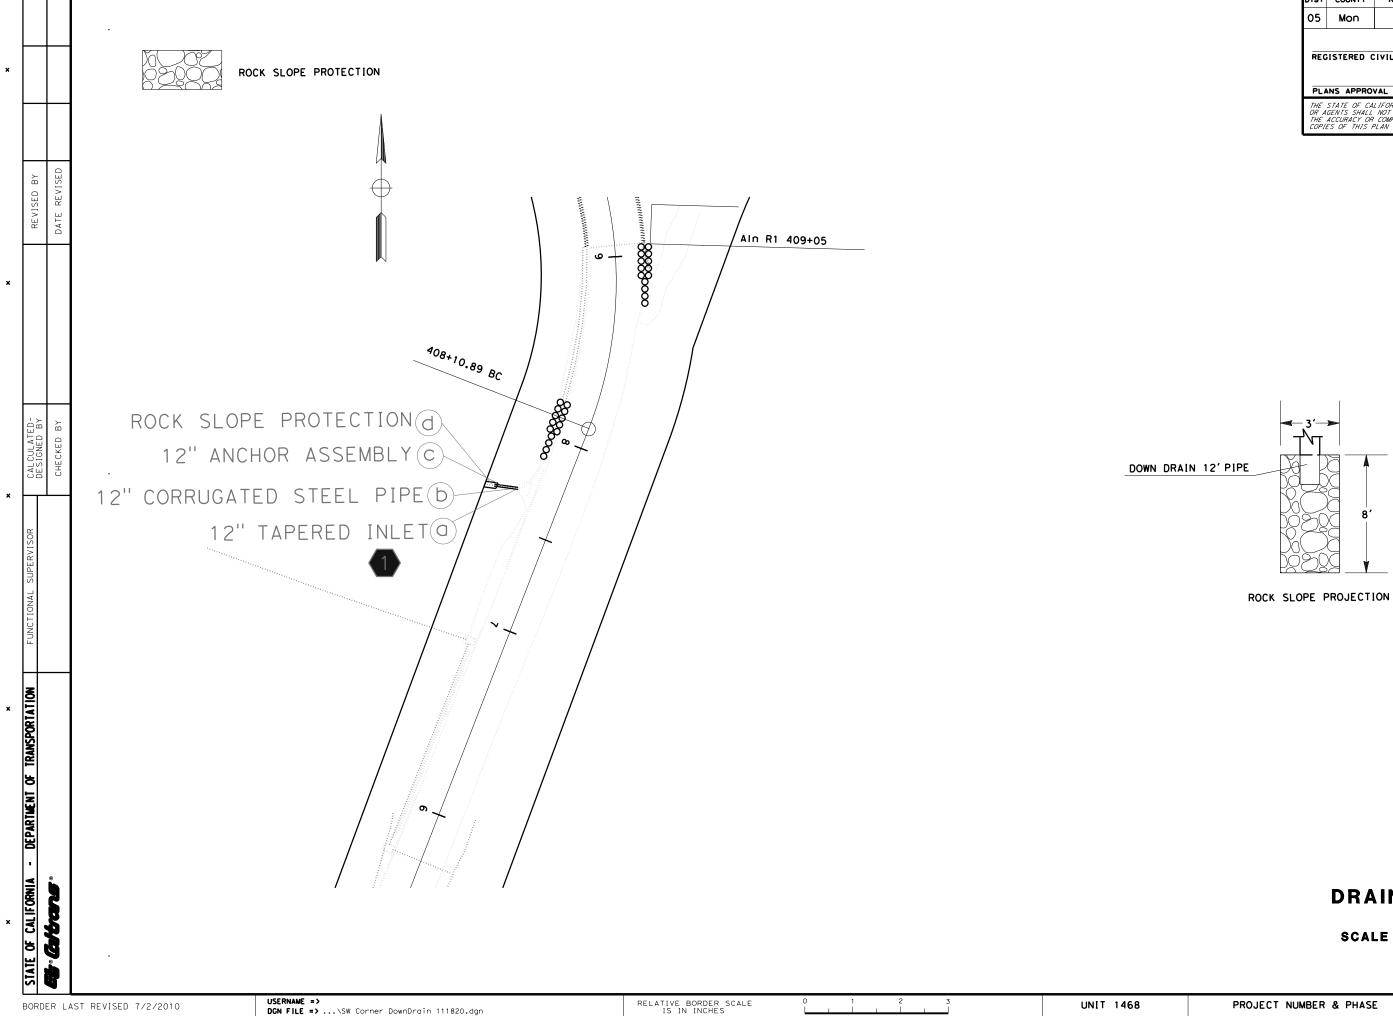SCALE 1":50' DP-2



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DRAINAGE SYSTEM NO. 🔿	DRAINAGE UNIT	Distribution 12" ENTRANCE TAPER	T 12" ANCHOR ASSEMBLY	T 12" CORRUGATED STEEL PIPE	2 RSP (LIGHT, METHOD B)	S RSP FABRIC (CLASS 8)	AGK STAIN	H MAXIMUM COVER (N)	G PLACE HMA G (Misc AREA) *	Z HMA X (TYPE A) *	DESCRIPTION	LOCATION
1	a	1							2.16	0.3	12" ENTRANCE TAPER	407+69.22, 22.49' L†
1	b			8				0.5			12" CORRUGATED STEEL PIPE DOWNDRAIN	407+68.75/407+69.22, Var Lt
1	С		2								12" ANCHOR ASSEMBLY	407+68.75/407+69.22, Var Lt
1	d				1	5	24				RSP (LIGHT, METHOD B) AND RSP FABRIC (CLASS 8)	407+65.32/407+66.87, Var Lt
2	a	1							2.16	0.3	12" ENTRANCE TAPER	411+75.12, 17.33' L+
2	b			43				0.5			12" CORRUGATED STEEL PIPE DOWNDRAIN	411+73.94/411+30.06, Var Lt
2	с		8								12" ANCHOR ASSEMBLY	411+73.94/411+75.12, Var Lt
TOI	AL	2	10	51	1	5	24		4.32	0.6		

(N) = NOT A SEPARATED PAY ITEM, FOR INFORMATION ONLY

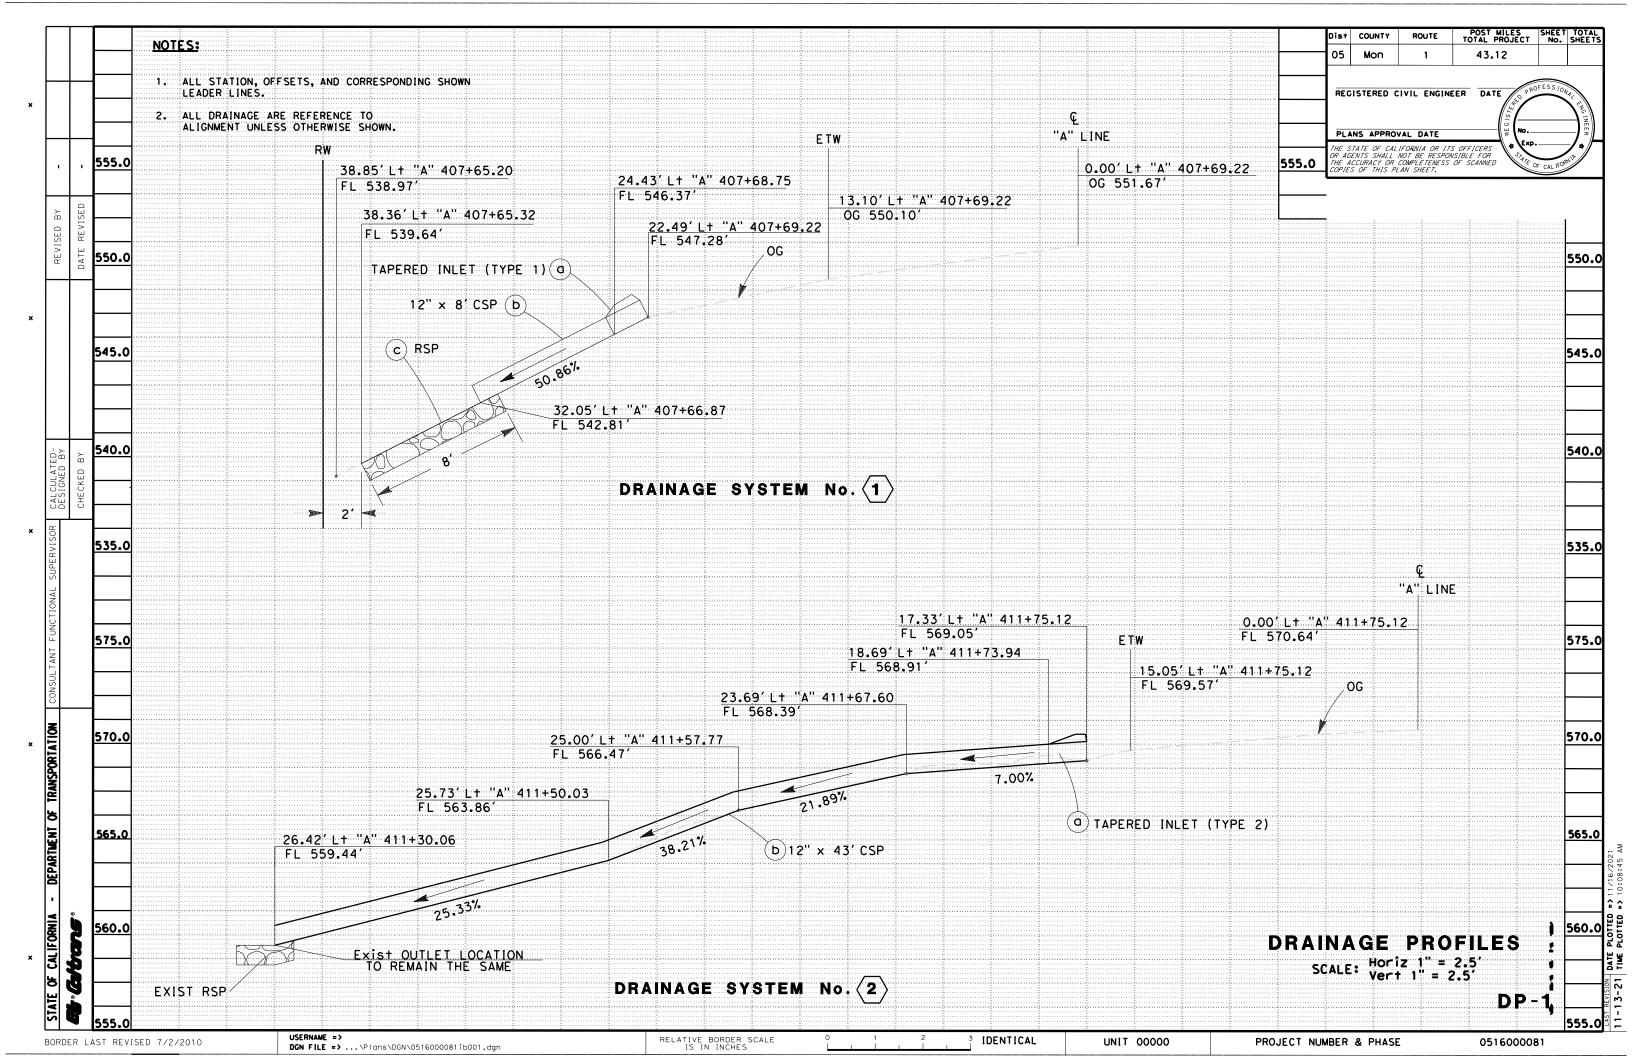\* QUANTITY INCLUDED IN ROADWAY QUANTITIES TABLE.

×	STATE OF CALIFORNIA
	BORDER LAST REVISED 7/2/2010

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JOSEPH VALDIVIA

CALCULATED-DESIGNED BY

DEPARTMENT OF TRANSPORTATION

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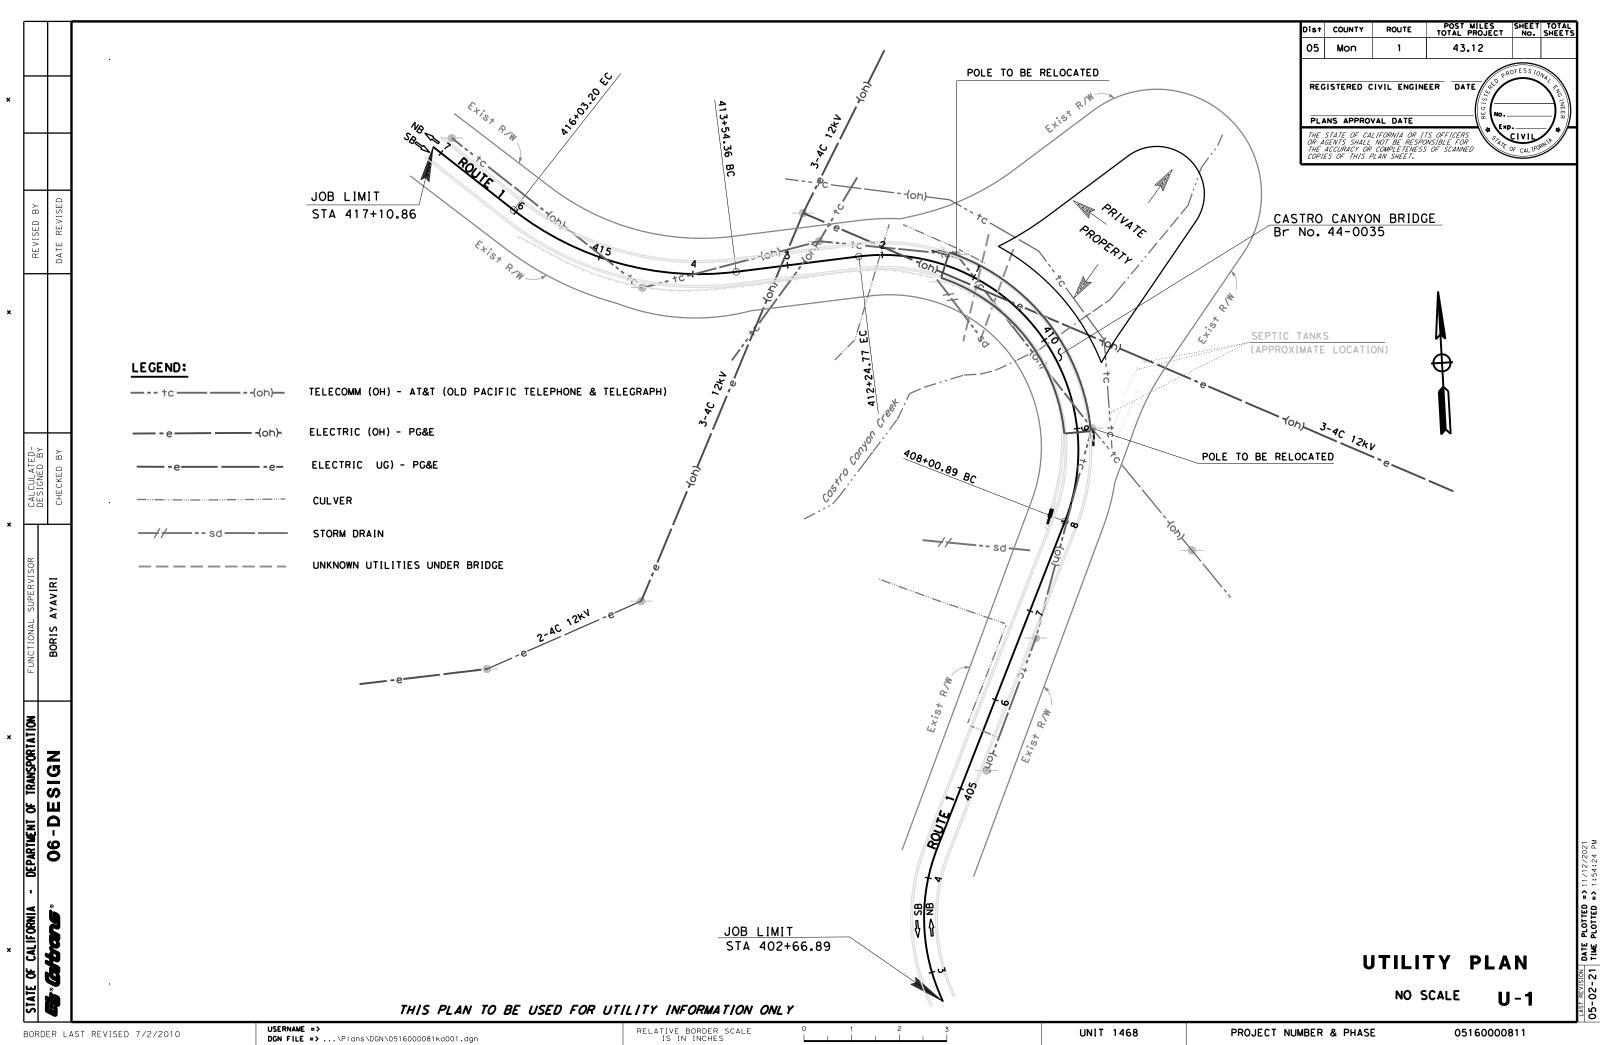
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THE STATE OF CALIFORNIA OR ITS OFFICERS OR AGENTS SHALL NOT BE RESPONSIBLE FOR THE ACCURACY OR COMPLETENESS OF SCANNED COPIES OF THIS PLAN SHEET.							

# LAST REVISION DATE PLOTTED 11/19/2021 11-19-20 TIME PLOTTED 11:45:57 PM

#### DRAINAGE QUANTITIES DQ-1




PROJECT NUMBER & PHASE

#### NOTES:

1. EXACT LOCATION OF SIGNS TO BE DETERMINED BY THE ENGINEER.


#### STATIONARY MOUNTED CONSTRUCTION AREA SIGNS

SIGN	SIGN CODE		PANEL SIZE	SIGN MESSAGE	No. OF POST AND SIZE	No. OF SIGNS
	FEDERAL	CALIFORNIA				010110
1	W20-1		60" × 60"	ROAD WORK AHEAD	2 - 6" × 6"	2
2	W20-1		36" × 36"	ROAD WORK AHEAD	1 - 4" × 6"	3
3	G20-2		36" × 18"	END ROAD WORK	1 - 4" × 6"	2
4		C40A (CA)	60" × 60"	TRAFFIC FINES DOUBLED IN WORK ZONES	2 - 6" × 6"	2

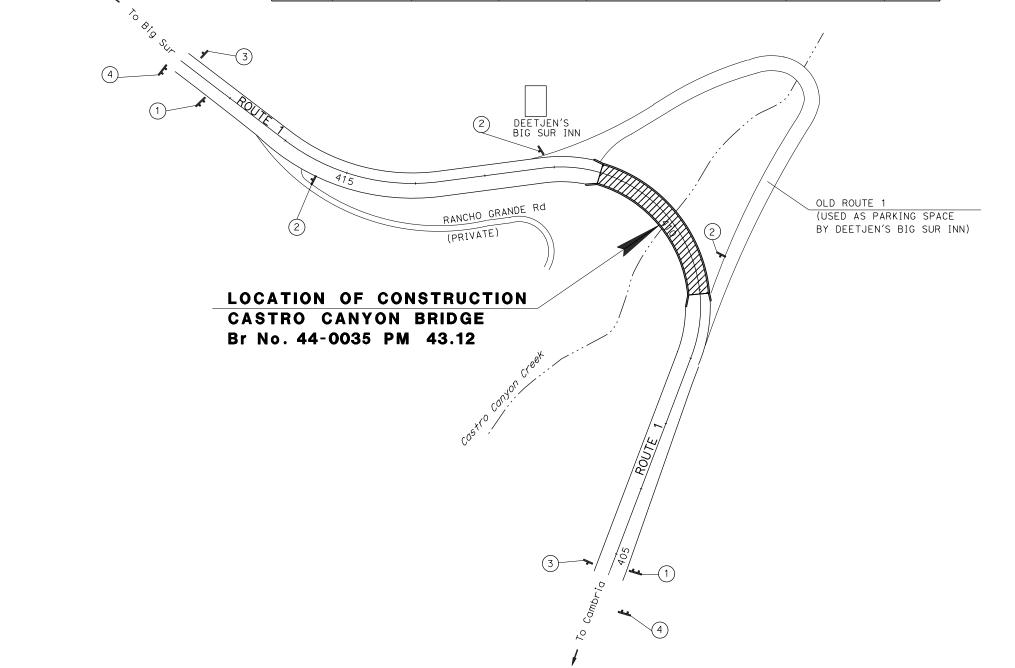

APPROVED FOR CONSTRUCTION AREA SIGN WORK ONLY


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E	BORDER LA	ST REVISED 7/2/2010	USERNAME => s128443 DGN FILE => 0516000081 a001.dgn	RELATIVE BORDER SCALE IS IN INCHES	UNIT 1468

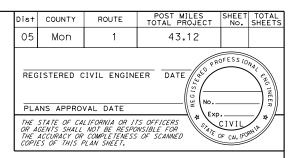






PROJECT NUMBER & PHASE

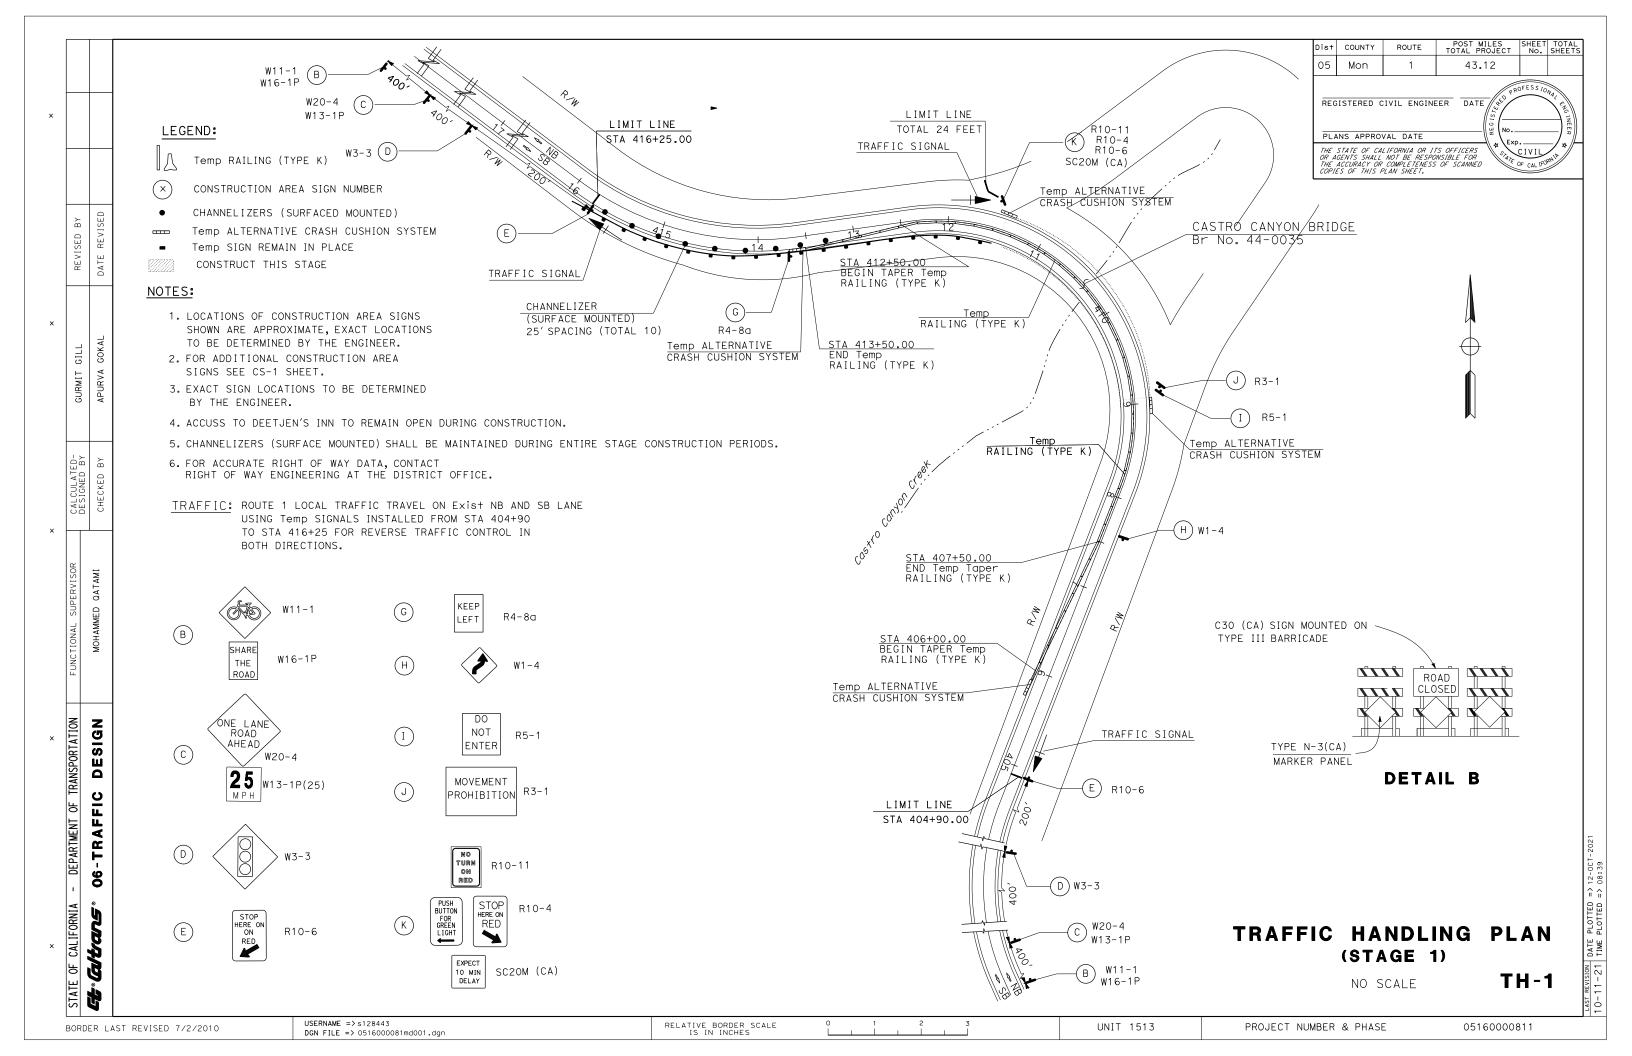

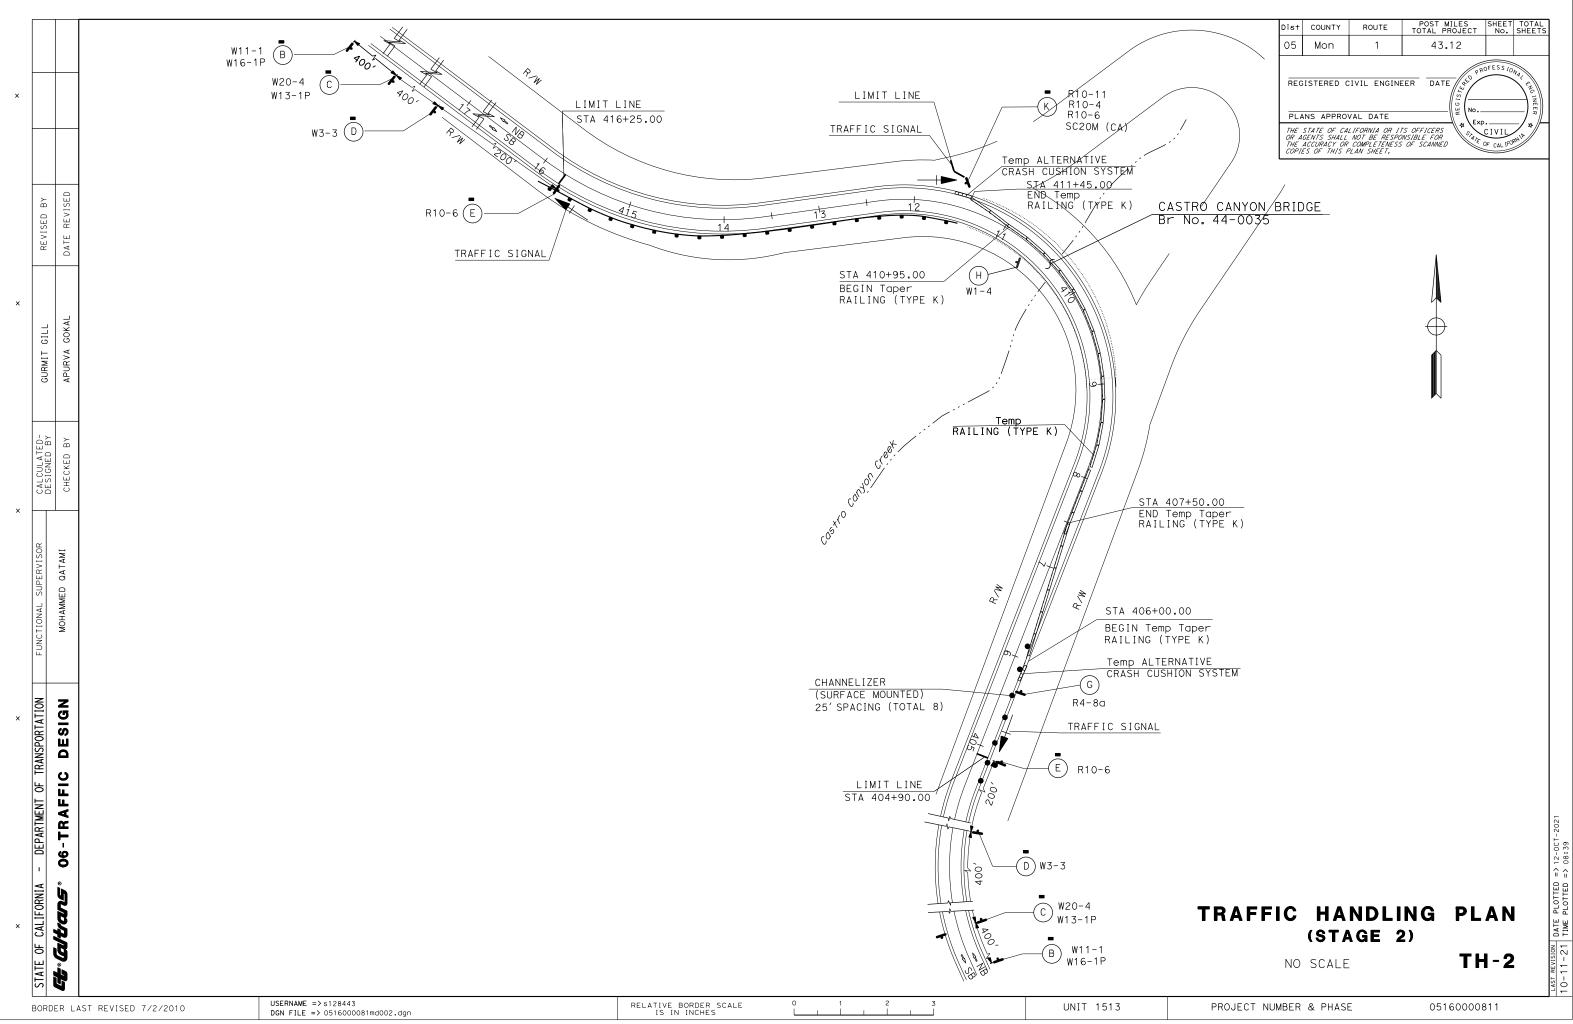

STATE OF CALIFORNIA - DEPARTMENT OF TRANSPORTATION	FUNCTIONAL SUPERVISOR	CALCULATED-	CURMIT GILL	REVISED BY	
<b>Gt</b> °G/trang° 06-TRAFFIC DESIGN	ΜΟΗΑΜΜΕD QATAMI	CHECKED BY	APURVA GOKAL	DATE REVISED	
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## STATIONARY MOUNTED CONSTRUCTION AREA SIGNS

SIC Nc	·· (\/)	SIGN DESIGNATION	PANEL SIZE	SIGN MESSAGE	NUMBER OF POSTS AND SIZE	NUMBER OF SIGNS
	5	W11-1	18" × 18"	BICYCLE WARNING	1 - TS 2-1/2" x 2-1/2"	2
	В	W16-1P	18" × 24"	SHARE THE ROAD	1 - 13 Z-17Z X Z-17Z	2
	С	W20-4	36" × 36"	ONE LANE ROAD AHEAD	1 - TS 2-1/2" x 2-1/2"	2
	D	W3-3	36" × 36"	SIGNAL AHEAD SYMBOL	1 - TS 2-1/2" x 2-1/2"	2
	E R10-6		24" × 36"	STOP HERE ON RED	1 - TS 2-1/2" × 2-1/2"	2
	G	R4-8a	24" × 30"	KEEP LEFT	1 - TS 2-1/2" x 2-1/2"	2
	Н	W1-4	36" × 36"	REVERSING CURVE SYMBOL	1 - TS 2-1/2" x 2-1/2"	2
	Ι	R5-1	??" × ??"	DO NOT ENTER	1 - TS 2-1/2" x 2-1/2"	1
	J	R3-1	24" × 24"	NO RIGHT TURN SYMBOL	1 - TS 2-1/2" x 2-1/2"	1
		R10-11	24"× 30"	NO TURN ON RED		
	к	R10-4	9 "× 12"	PUSH BUTTON FOR GREEN LIGHT	1 - TS 2-1/2" x 2-1/2"	1
		R10-6	24"× 36"	STOP HERE ON RED		
		SC20M	24" X 24"	EXPECT 10 MN DELAY		

SHEET No.	ΕA
TH-1	13
TH-2	8
TOTAL	21

# TEMPORARY RAILING (TYPE K)

SHEET No.	STATION	LENGTH (LF)
TH-1	406+00 TO 413+50 ("MAIN-1" LINE)	760
TH-2	406+00 TO 411+45 ("MAIN-1" LINE)	760
	TOTAL	1,520

## TEMPORARY CRASH CUSHION

SHEET No.	TEMPORARY ALTERNATIVE CRASH CUSHION SYSTEM
	EA
TH-1	4
TH-2	2
TOTAL	6

## **TEMPORARY PAVEMENT QUANTITIES**

ROUTE	SHEET	LOCATION/ POST MILE	IRECTION	TEMPORARY PAVEMENT MARKING (TAPE)				
				DESCRIPTION	SQFT			
		406+00	NB	1-LIMIT LINE (TH-1)	12.00			
1	TH-1	416+25	NB	1-LIMIT LINE (TH-1) 24.00				
		416+25	SB	1-LIMIT LINE (TH-1)	12.00			
	TOTAL							

BORDER	LAST	REVISED	7/2/2010
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Dist	Dist COUNTY ROUTE POST MILES SHEET TOTAL TOTAL PROJECT NO. SHEETS												
05	Mon	43.1	?	??									
PLA THE OR A THE	XX ANS APPROV STATE OF CA. GENTS SHALL	LIFORNIA OR II NOT BE RESPO COMPLETENESS		N. GOK 61979 09-30- CIVIL DF CALIFO	AL 21 21								


## CHANNELIZER (SURFACE MOUNTED)

# TYPE III BARRICADES

LOCATION	TYPE III BARRICADES
	EA
TH-1	3
TH-2	3
SUBTOTAL	6



-11-21 DATE PLOTTED =>

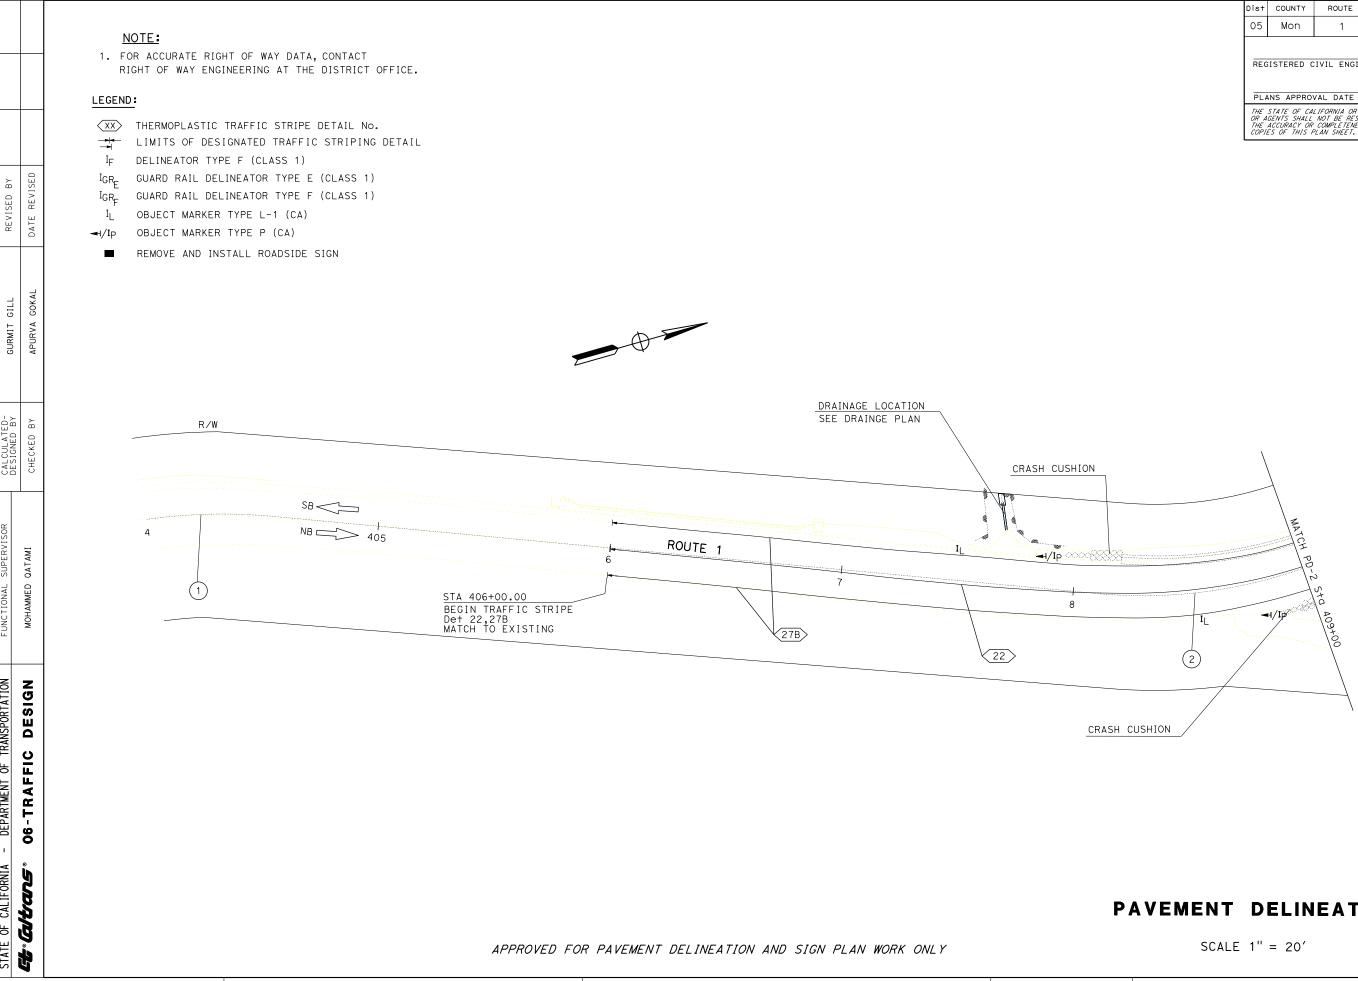

BORDER LAST REVISED 7/2/2010

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DEPARTMENT OF TRANSPORTATION

**CALIFORNIA** 


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USERNAME => s128443 DGN FILE => 0516000081na001.dgn

RELATIVE BORDER SCALE IS IN INCHES

UNIT 1468





# **PAVEMENT DELINEATION PLAN**
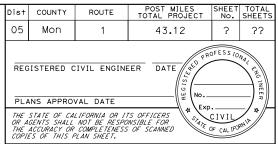
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PLO PLO DATE TIME


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BORDER LAST REVISED 7/2/2010

Dist	Dist COUNTY ROUTE POST MILES SHEET TOTAL TOTAL PROJECT NO. SHEETS											
05	Mon	1	43.12	?	??							
REGISTERED CIVIL ENGINEER DATE												
OR A THE	GENTS SHALL	LIFORNIA OR II NOT BE RESPO COMPLETENESS PLAN SHEET.		CIVIL DF CAL IFO	ANIA ANIA							

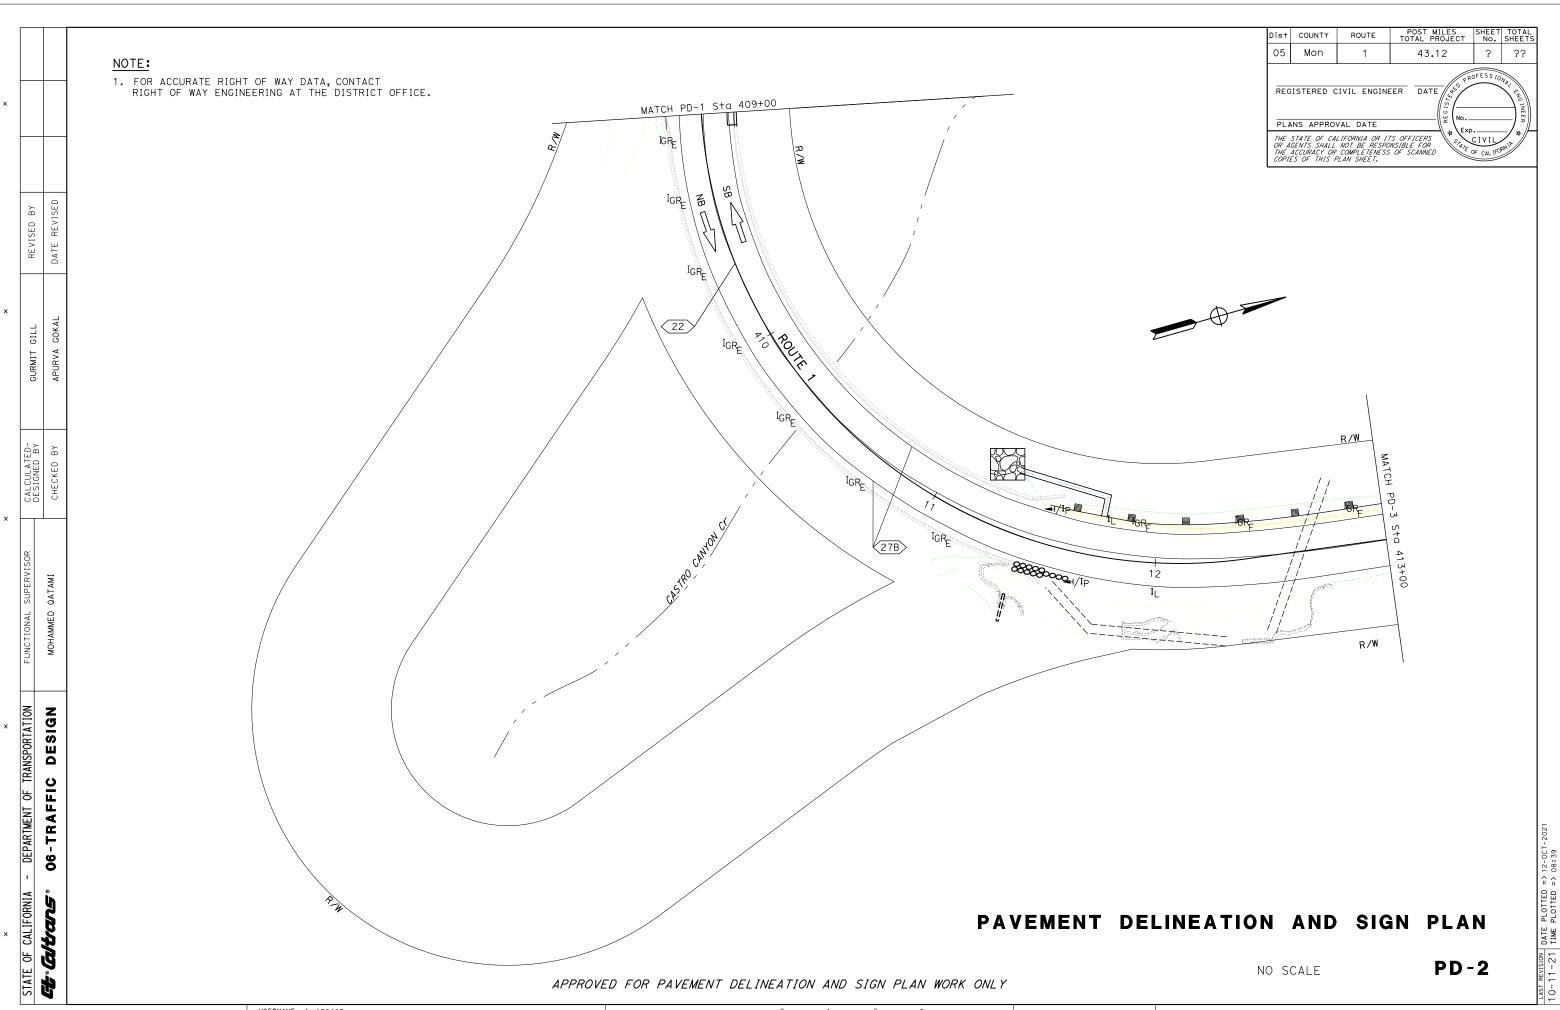
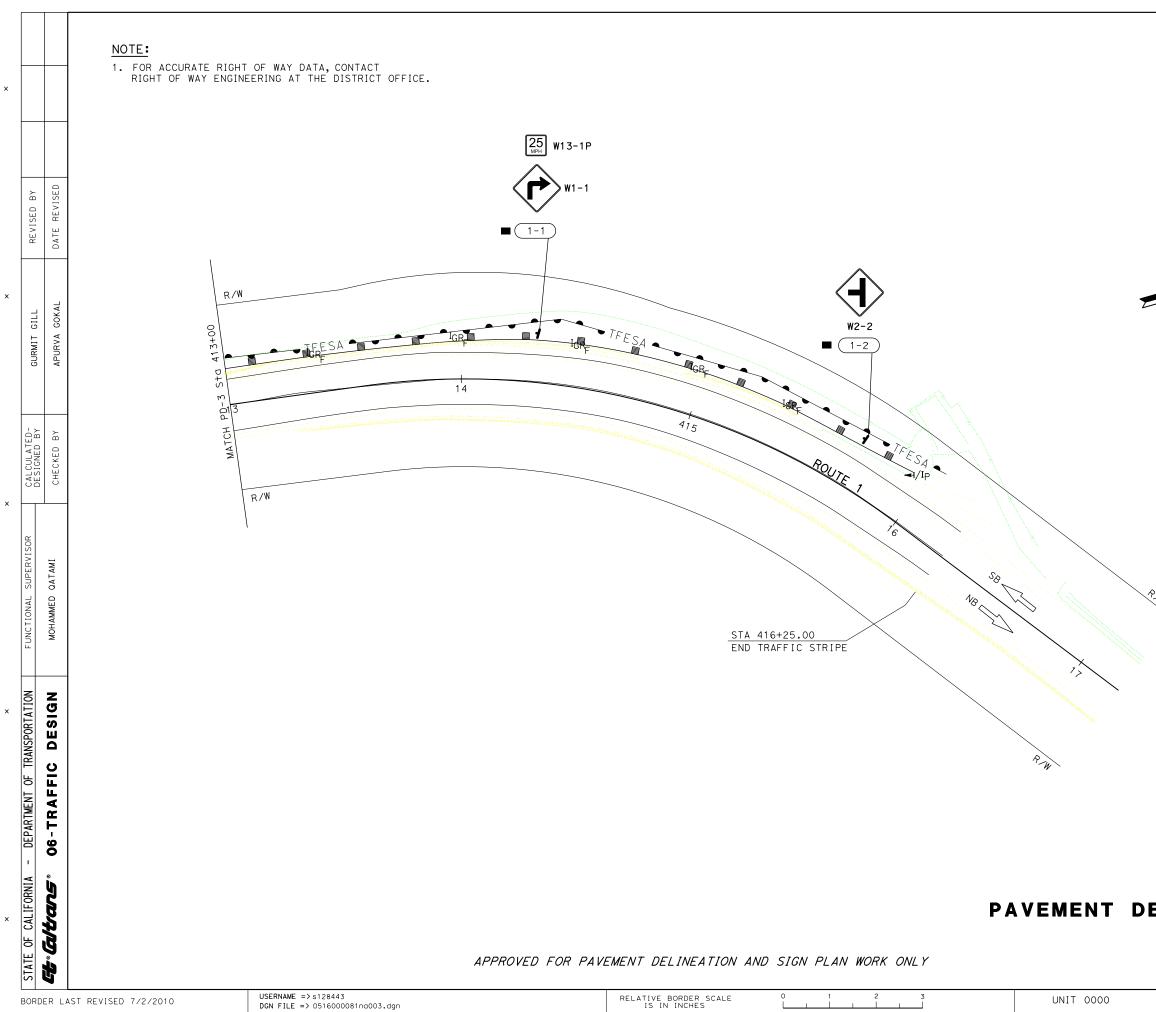
# PAVEMENT DELINEATION AND SIGN PLAN

SCALE 1'' = 20'

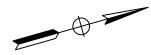						BACKGF	ROUND	LEG	END	FURNISH SINGLE SHEET ALUMINUM SIGN UNFRAMED	ONE POST	E SIGN	WASTE
SHEET NUMBER	SIGN NUMBER	SIGN DESIGNATION	SIGN MESSAGE	NO. OF POST AND POST SIZE	PANEL SIZE L X D	SHEETING COLOR	RETROREFLECTIVITY ASTM TYPE	SHEE TING COLOR	RETROREFLECTIVITY ASTM TYPE	0.063"	ROADSIDE SIGN - O	REMOVE ROADSIDE (WOOD POST)	TREATED WOOD W
					INCHES		ц		ц К	SQF T	ΕA	ΕA	LB
	3-1	W1 – 1	RIGHT TURN (SYMBOL)	- 1-2 <sup>1</sup> / <sub>2</sub> " × 2 <sup>1</sup> / <sub>2</sub> "	30 × 30	FY	IX	BLACK	XI	6.25	1	1	86.25
PD-3	J-1	W13-1P	ADVISORY SPEED PLAQUE (25 MPH)		18 x 18	FY	XI	BLACK	XI	2.25			
	3-2	W2-2	SIDE ROAD (SYMBOL)	1-2 <sup>1</sup> / <sub>2</sub> " × 2 <sup>1</sup> / <sub>2</sub> "	30 × 30	FY	XI	BLACK	XI	6.25	1	1	86.25
							τοτα			14.75	2	2	187.5

## SIGN QUANTITIES

## **PAVEMENT DELINEATION QUANTITIES**

		LOCA	TION/	LION	, 11	PAVEMENT MARKER RETROREFLECTIVE	THERMOPLASTIC TRAFFIC STRIPE (ENHANCED WET NIGHT VISIBILITY)	REMOVE AVEMENT MARKER	REMOVE THERMOPLASTIC	OB . MAF	JECT RKER	GU RAI DELIN	ARD LING NEATOR
ROUTE SHEET		POST MILE		LU	ш I iu Z		TYPE YELLOW/WHITE		TRAFFIC STRIPE	TYPE	TYPE	TYPE	TYPE
				L H	Δ		6"		YELLOW/WHITE	L	Р	E	F
		FROM	ТО			EA	LF	EA	LF	EA	ΕA	ΕA	EA
	PD-1	406+00	416+25	NB	27B		1025		1025	4	5	7	8
1	ТО	406+00	416+25	NB/SB	22	88	2050	88	2050				
	PD-3	406+00	416+25	SB	27B		1025		1025				
SUBTOTAL		OTAL			88	4,100	88	4,100	4	5	7	8	
TOTAL			88	4,100	88	4,100	ç	)	1 :	5			


USERNAME => s128443 DGN FILE => 0516000081nc001.dgn	RELATIVE BORDER SCALE IS IN INCHES	0	1	2	3	UNIT 1513
DON FILE = 2 05180000811C001.dg1	IS IN INCHES					

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Dis†	COUNTY	ROUTE	POST MILES TOTAL PROJECT	SHEET No.	TOTAL SHEETS			
05 Mon 1 43.1 ?								
REGISTERED CIVIL ENGINEER XX-XX-XX PLANS APPROVAL DATE								
THE STATE OF CALIFORNIA OR ITS OFFICERS OR AGENTS SHALL NOT BE RESPONSIBLE FOR THE ACCURACY OR COMPLETENESS OF SCANNED COPIES OF THIS PLAN SHEET.								

**PAVEMENT DELINEATION QUANTITIES** PDQ-1

TI1-21 DATE PLOT

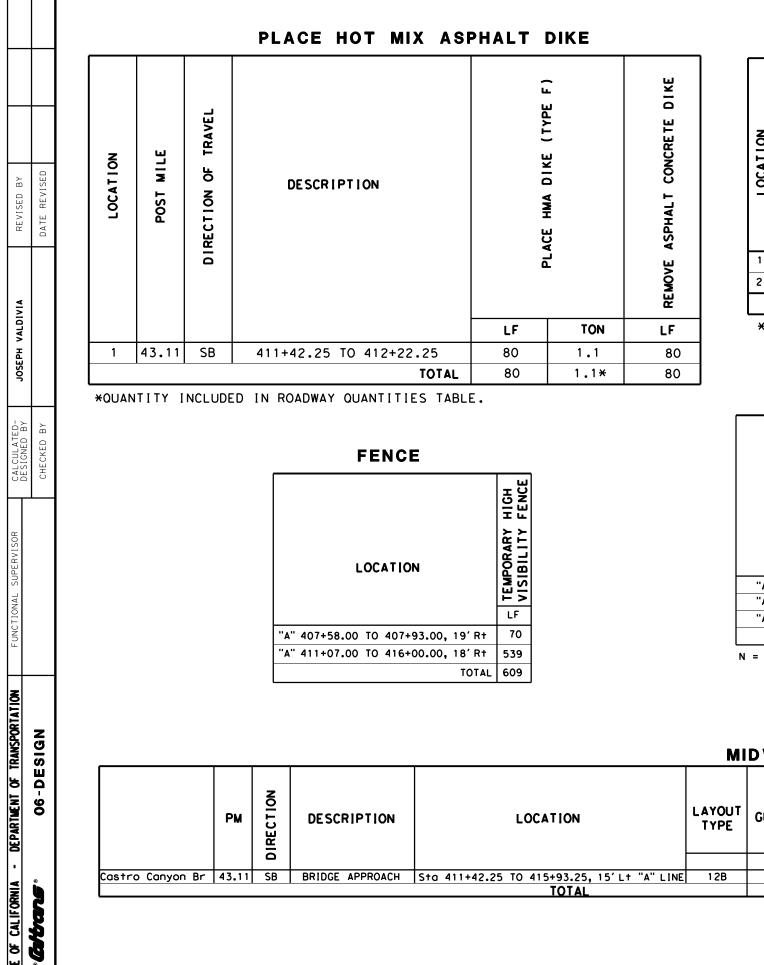

			HMA APRONS		
LOCATION	POST MILE	DIRECTION OF TRAVEL	LOCATION/DESTRIPTION	PLACE HMA (Misc Area)	НМА A) (ТҮРЕ A) *
		NB/SB		SOYD	TON
1	43.03	SB	"A" 411+76, 17.3' L+ / TYPE 2	40	16.2
2	43.11	SB	"A" 407+69, 23.5′ L† / TYPE 1	15	6.1
			TOTAL	1.4	22.3*
жC		TY INC	LUDED IN ROADWAY QUANTITIES TABLE		-

QUANIILY INCLUDED IN ROADWAY QUANIILIES LABLE.

## **CRASH CUSHION**

LOCATION	CRASH CUSHION TEST LEVEL II PENDING	CRASH CUSHION TEST LEVEL III	CONCRETE CRASH CUSHION 2 FOUNDATION
	EA	EA	CY
"A" 408+00.00, 14.0'Lt		1	1.0
"A" 409+00.00, 14.0' Rt	1		0.6
"A" 411+45.00, 14.0' Rt	1		0.6
TOTAL	2	1	

N = NON PAY ITEM

## MIDWEST GUARDRAIL SYSTEM

	РМ	IRECTION	DESCRIPTION	LOCATION	LAYOUT TYPE	REMOVE GUARDRAIL	TREATED WOOD WASTE	MGS (STEEL POST)	31" FLARED TERMINAL SYSTEM END TREATMENT	TRANSITION RAILING (TYPE WB-31)	END ANCHOR ASSEMBLY (TYPE SFT)	OBJECT MARKER (TYPE P)	VEGETATION CONTROL (MINOR CONCRETE)
		0				LF	LB	LF	EA	EA	EA	EA	SOYD
astro Canyon Br	43.11	SB	BRIDGE APPROACH	Sto 411+42.25 TO 415+93.25, 15'Lt "A" LINE	12B	426.0	5344	451.0	1	1	0	1	x
				TOTAL		426.0	5344	451.0	1	1	0	1	X

BORDER LAST REVISED 7/2/2010

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PLANS APPROVAL DATE     DATE       THE STATE OF CALIFORNIA OR ITS OFFICERS OR AGENTS SHALL NOT BE RESPONSIBLE FOR THE ACCURACY OR COMPLETENESS OF SCANNED     SALL FORMULA		05	SCR	1	43.1		
THE STATE OF CALIFORNIA OR ITS OFFICERS OR AGENTS SHALL NOT BE RESPONSIBLE FOR THE ACCURACY OR COMPLETENESS OF SCANNED					EER DATE		ENG INEE
	<b>(v</b>	OR AU THE	GENTS SHALL ACCURACY OR	NOT BE RESPO COMPLETENES	TE OFFICERE		1 - //

MIDWEST GUARDRAIL SYSTEM (STEEL POSTS)	TRANSITION RAILING (TYPE WB-31)	TYPE TL-2 CRASH CUSHIONS	TYPE TL-3 CRASH CUSHION	TUBURLAR BICYLE RAIL (TYPE 85 BARRIER)	CABLE RAILING	FLARED END TREATMENT	CORRUGATED STEEL PIPE
LF	EA	ΕA	ΕA	LF	LF	ΕA	LF
426.0	1	2	1	470	20	1	51

\* THIS IS A LUMPSUM ITEM, FOR INFORMATION PURPOSES ONLY


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SUMMARY	OF	QUANTITIES	
		Q-1	

			MATERIAL	
SEQUENCE	ITEM	DESCRIPTION	TYPE	FASTENER
INSTALL BEFORE DUFF PLACEMENT	ROLLED EROSION CONTROL PRODUCT (NETTING)	100% COIR NETTING (COCONUT FIBER)	ECTC TYPE 4 NETTING TYPE A	8-GAUGE, 8 INCH STEEL STAPLE

# COMPOST SOCK

SEQUENCE	ITEM	MATERIAL	MATERIAL TYPE
INSTALL AFTER RECP (NETTING), BEFORE DUFF PLACEMENT	COMPOST SOCK	COMPOST FILLED BIODEGRAD-ABLE TUBE	8" DIA.

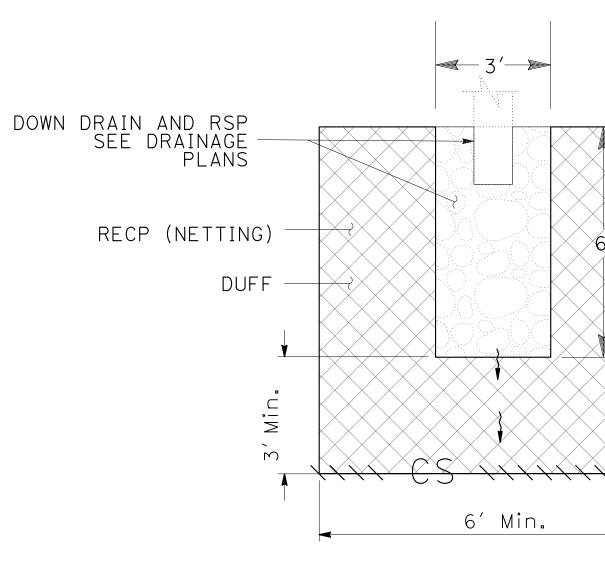

<u>PLAN</u>

# TYPICAL EROSION CONTROL AT DRAIN OUTLETS

NO SCALE

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DEPARTMENT OF TRANSPORTATION

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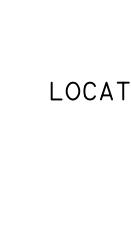
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# **ROLLED EROSION CONTROL PRODUCT**

LOCATION	COMPOST SOCK	RECP (NETTING)	REMARKS
	LF	SQFT	
"A" 408 to 407+50 LF	10	210	
"A" 411 to 412 LF	10	340	SEE DETAIL AND DRAINAGE PLANS
TOTAL	20	550	





✓ COMPOST SOCK

RELATIVE BORDER SCALE IS IN INCHES	0	1	2	3		UNIT 1502
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Dist	COUNTY	ROUTE	POST MILES TOTAL PROJECT	SHEET No.	TOTAL SHEETS
05	MON	1	43.12		
		LIMINA Ndscape arc	CHITECT	Signature 7-31-2	APCHITECT
OR A THE	GENTS SHALL	LIFORNIA OR II NOT BE RESPO COMPLETENESS PLAN SHEET.	WSIBLE FOR	Date OF CALLE	ORNIA

# **EROSION CONTROL QUANTITIES**

# **DUFF COLLECTION AND PLACEMENT**

	(N)	(N)					
LOCATION	DUFF COLLECTION	DUFF PLACEMENT		REMARKS			
	SQFT	SQFT	SQFT				
"A" 408 to 407+50 LF	500	500	500	SEE DETAIL			
"A" 411 to 412 LF	700	700	700	AND DRAINAGE PLANS			
TOTAL	1200	1200	1200	PLACE DUFF IN DISTURBED SOIL AREAS.			

EROSION CONTROL LEGEND 

		NOTES:			
		1. OVERHEAD ENTRANCE CONDUIT FITTING MUST FORM A DRIP LOOP AT ENTRANCE FITTING.		ABBREVIATIONS:	
+		2. ESTABLISH CONTINUOUS GROUND WITH SYSTEM GROUND TO ALL METAL PARTS IN SYSTEM BY BONDING JUMPERS AND CONDUITS.		VIDA - VIDEO IMAGE DETECTION ASSEMBLY UPS - UNINTERRUPTIBLE POWER SUPPLY ATS - AUTOMATIC TRANSFER SWITCH	
		3. SIGNS SHOWN ARE "CONSTRUCTION AREA SIGNS". SEE TRAFFIC HANDLING PLANS FOR DETAILS.		TSS - TEMPORARY SIGNAL SYSTEM	
REVISED BY	DATE REVISED				
	DANIEL VO	LEGEND: (SHEETS E-2, E-3 AND E-4)		<u>CONDUIT RUNS:</u>	
HIM MC	DA	1 POWER FOR TSS SHALL BE PROVIDED BY GENERATOR WITH A BACKUP GENERATOR, SEE DETAIL H ON SHEET ED-3.		<u>∕1</u> 1 <sup>1</sup> / <sub>2</sub> "C, 3#4, 1#8 (G)	
HAS		2 DEPARTMENT-FURNISHED MODEL 170 CONTROLLER ASSEMBLY. YOU MUST FURNISH AND INSTALL UPS, VIDA EQUIPMENT AND TEMPORARY FOUNDATION PLATFORM FOR MODEL 332L CABINET PER DETAIL D ON SHEET ED-2.		<pre>11/2"C, 2#6 (Sig), 2#8 (L+g), 2#10 (FB E), 2#10 (FB W)</pre>	
ED- BY	ВY	3 FOR DETECTOR LOOP INSTALLATION, SEE DETAIL A ON SHEET ED-1.		3 1 <sup>1</sup> / <sub>2</sub> "C, 2#6 (Sig), 4 DLC, 3-5CSC,	
CALCULATED- DESIGNED BY	CHECKED	4 DETECTOR LOOP MUST HAVE 5 TURNS. 5 INSTALL GROUND ELECTRODE IN PB.		1-VIDA CABLE	
CAL	СН	6 TEMPORARY WOOD POLE, SEE DETAIL C ON SHEET ED-1.		2"C, 4 DLC,2#8 (L+g), 3-5CSC,2#10 (FB E),	
		7 TEMPORARY WOOD POLE WITH FB, SEE DETAIL B ON SHEET ED-1.		Ž#10 (FB W), 1-VIDA CABLE	
SOR		8 TEMPORARY WOOD POST WITH SERVICE ENCLOSURE, SEE DETAIL G ON SHEET ED-3.		5 2"C, 3 DLC, 2#8 (L+g), 3-5CSC,	
SUPERVISOR	ano	9 TEMPORARY WOOD POLES WITH SIGNAL EQUIPMENT ON SPAN WIRE, SEE DETAIL E ON SHEET ED-2.		2"C, 3 DLC, 2#8 (L+g), 3-5CSC, 2#10 (FB E), 1-VIDA CABNLE	
AL	ВАКНОООО	TEMPORARY WOOD POLE WITH SIGNAL EQUIPMENT,			
01	ALI	III       SEE DETAIL F ON SHEET ED-2.         III       TEMPORARY WOOD POLES WITH VIDA SENSOR.			
FUNCT					
	z				
	N 10 10				
SPORTATION	D D D				
<b>a</b> -	AL				
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	5				
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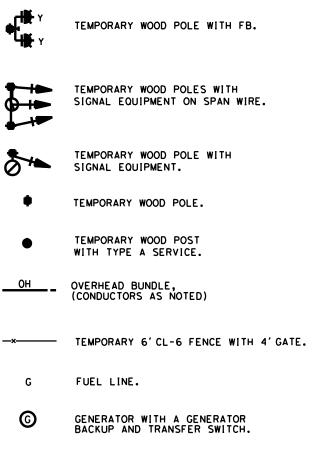
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Dist	COUNTY	ROUTE	POST MILES TOTAL PROJECT	SHEET No.	TOTAL SHEETS
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## SYMBOLS:




FUEL FUEL TANK.

TEMPORARY SIGNAL SYSTEMS E-1 21 PM

PLOTTED PLOTTED

DATE

11-16-21

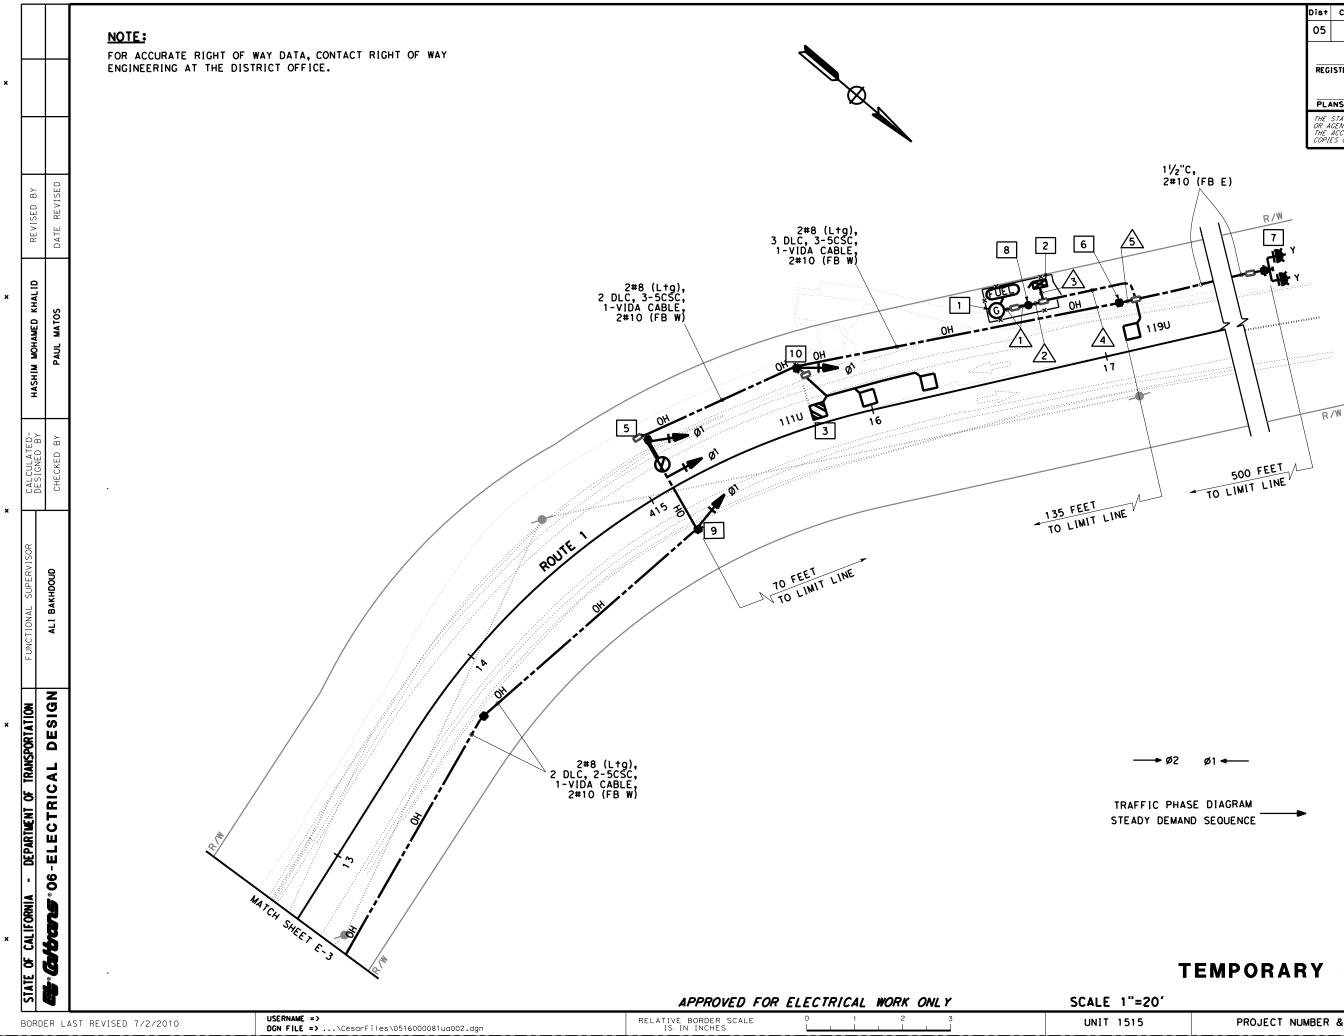


Dist	COUNTY	ROUTE	POST MILES TOTAL PROJECT	SHEET No.	TOTAL SHEETS
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	ISTERED ELE XX-XX		NEER DATE	HASHIM KHAL ID . 1805 	ENG INEE
OR A THE	GENTS SHALL	LIFORNIA OR II NOT BE RESPO COMPLETENESS PLAN SHEET.		ELECTRICAL	/ - //

₽ 1 LAST REVISION DATE PLOTTED => 11/18/20 11-16-21 TIME PLOTTED => 1:40:04

**TEMPORARY SIGNAL SYSTEMS** E-2

PROJECT NUMBER & PHASE

05180001131

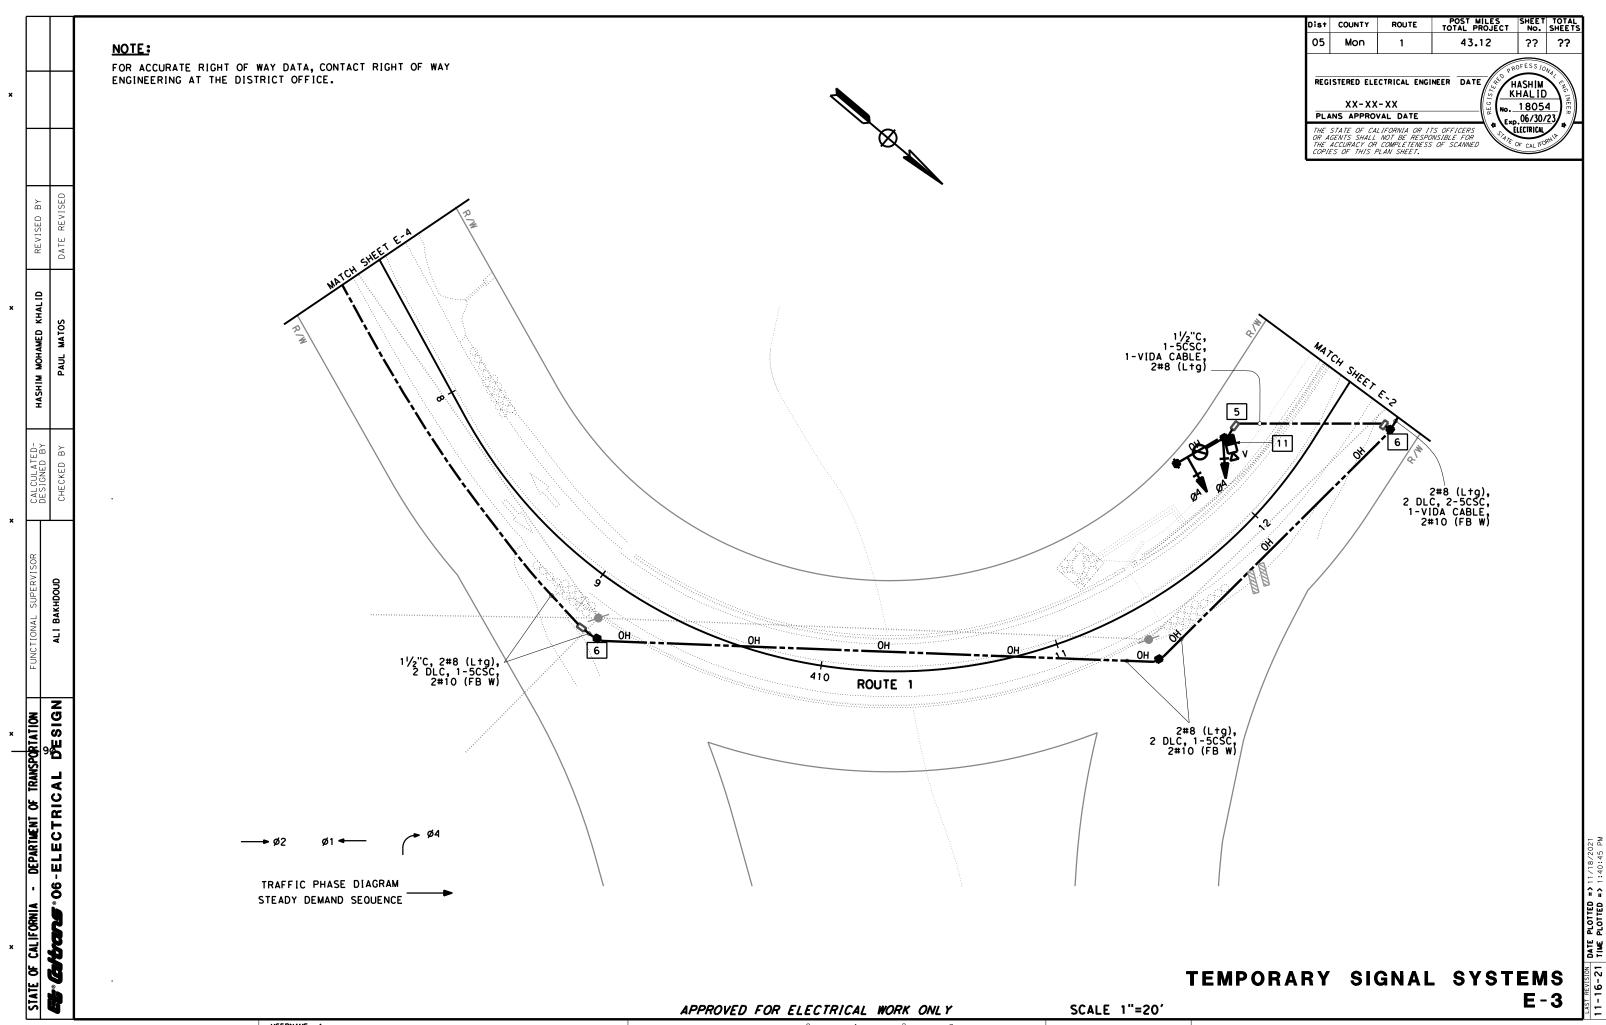

BORDER LAST REVISED 7/2/2010


		-		-		
USERNAME =>	RELATIVE BORDER SCALE	0	1	2	3	UNIT 1515
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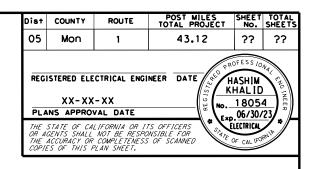
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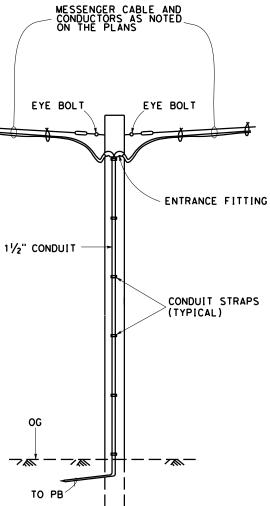
STATE OF CALIFORNIA - DEPARTIMENT OF TRAN <b> Geventation</b> • 06 - ELECTRICAL	→ Ø2 TRAFFIC PHASE STEADY DEMAND		1 APPROVED FOR ELECTRI	The second se	WATCH SHEET E-3 T SCALE 1"=20'
- 90 • 0	TRAFFIC PHASE	DIAGRAM	1	1/2"C, 2#8 (L+g), 2 DLC, 1-5CSC, 2#10 (FB W)	
DEPARTMENT OF TRANSPORTATION - ELECTRICAL DESIGN					
FUNCTIONAL SUPERVISOR ALI BAKHDOUD					
CALCULATED- DESIGNED BY CHFCKFD BY			to refer to 2	11/2"C, 2#8 (L 2 DLC, 1-5 2#10 (F	.tg), iCSC, B W)
HASHIM MOHAMED KHALID PAIN WATOS		TO LIMIT LINK			
REVISED BY				1½"C, 1 DLC, 2#10 (FB ₩)	
	NOTE: FOR ACCURATE RIGHT OF WAY DATA, CONTACT RI ENGINEERING AT THE DISTRICT OFFICE.	SHT OF WAY	2#10 (FB W) 2#10 (FB W) 11/2"C, 1 2#10 (F	DLC, BW)	×

Dist	COUNTY	ROUTE	POST MILES TOTAL PROJECT	SHEET No.	TOTAL SHEETS
05	Mon	1	43.12	??	??
	ISTERED ELE XX-XX			HASHIM HALIC 1805	4 23 ENGINEER
OR A THE	GENTS SHALL	LIFORNIA OR I NOT BE RESP COMPLETENES PLAN SHEET,		OF CAL IFC	/ - //

# TEMPORARY SIGNAL SYSTEMS E-4





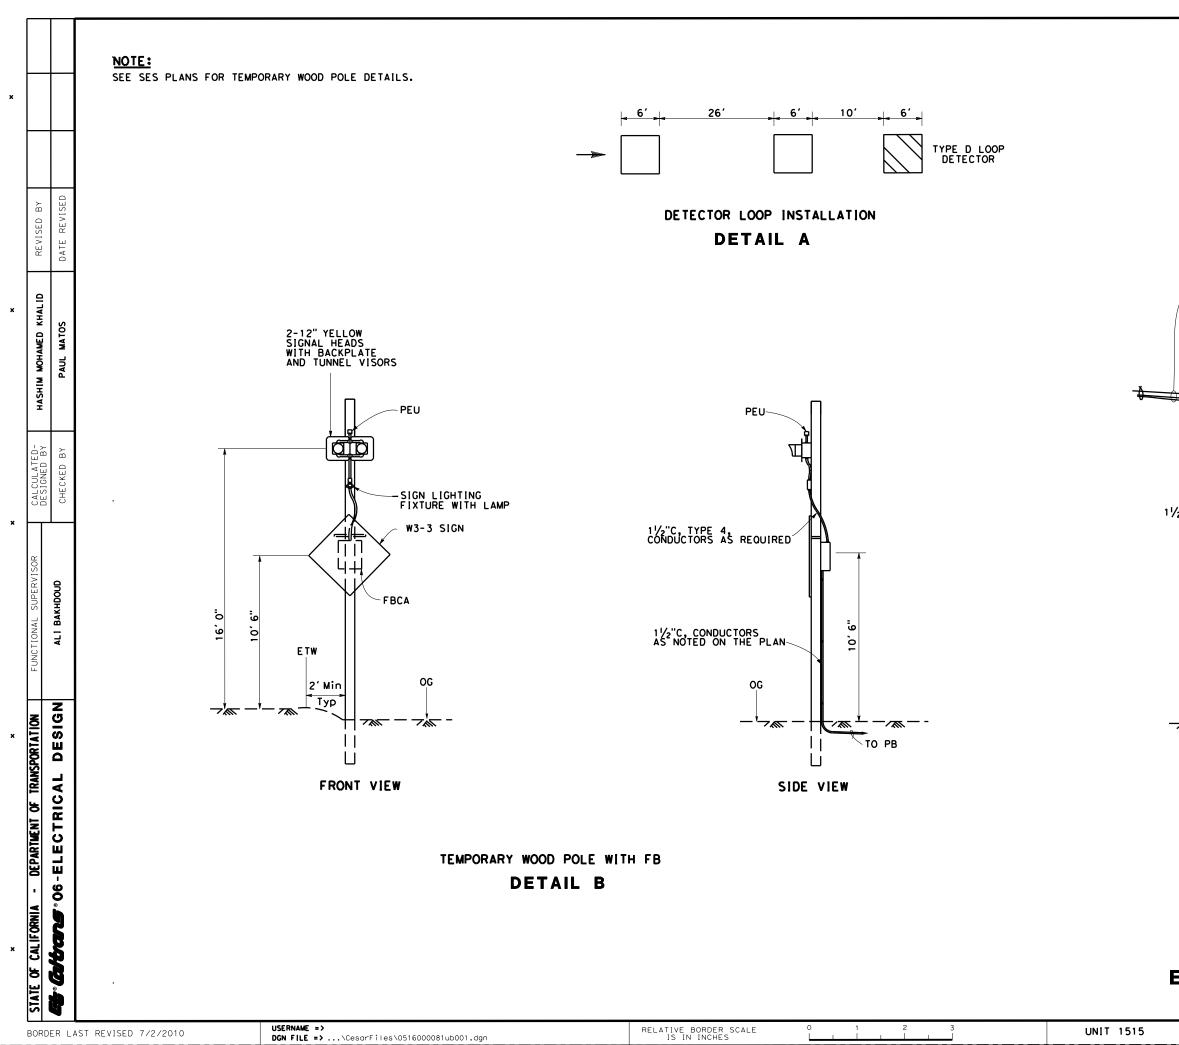


TEMPORARY WOOD POLE DETAIL C

## ELECTRICAL SYSTEMS DETAILS ED-1

NO SCALE

PROJECT NUMBER & PHASE

LAST REVISION DATE PLOTTED => 11/18/2021 11-16-21 TIME PLOTTED => 1:43:06 PM

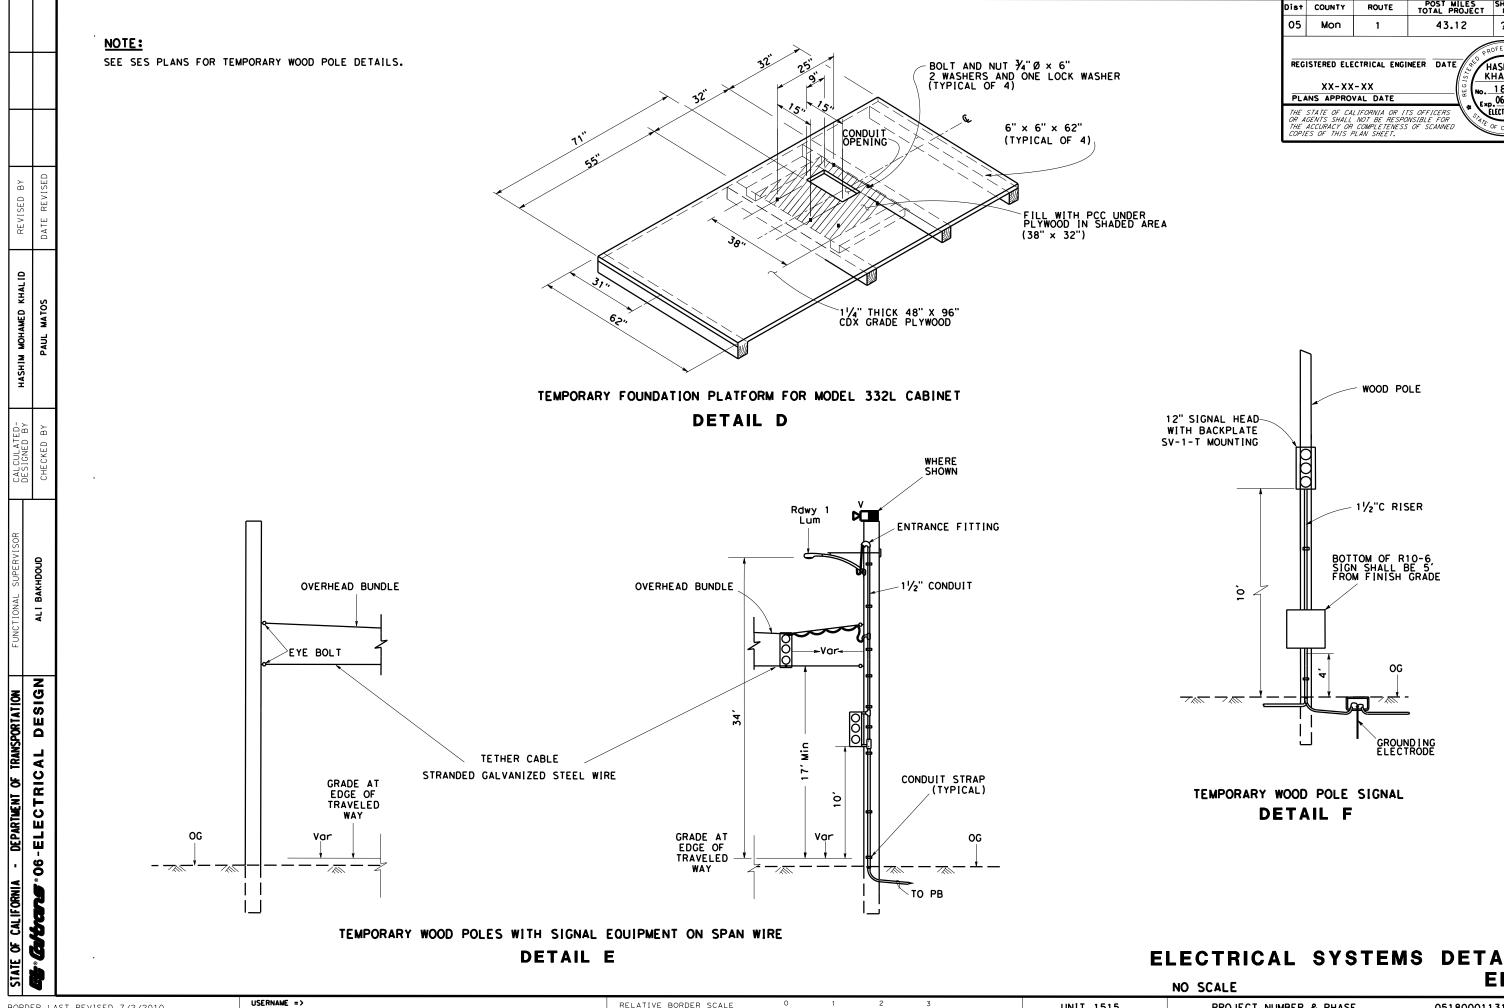


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RELATIVE BORDER SCALE IS IN INCHES

UNIT 1515




# **ELECTRICAL SYSTEMS DETAILS** ED-2

PROJECT NUMBER & PHASE

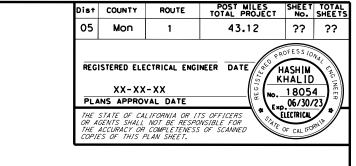 LAST REVISION
 Date
 PLOTTED
 > 11/18/2021

 11-16-21
 TIME
 PLOTTED
 => 1:43:51 PM

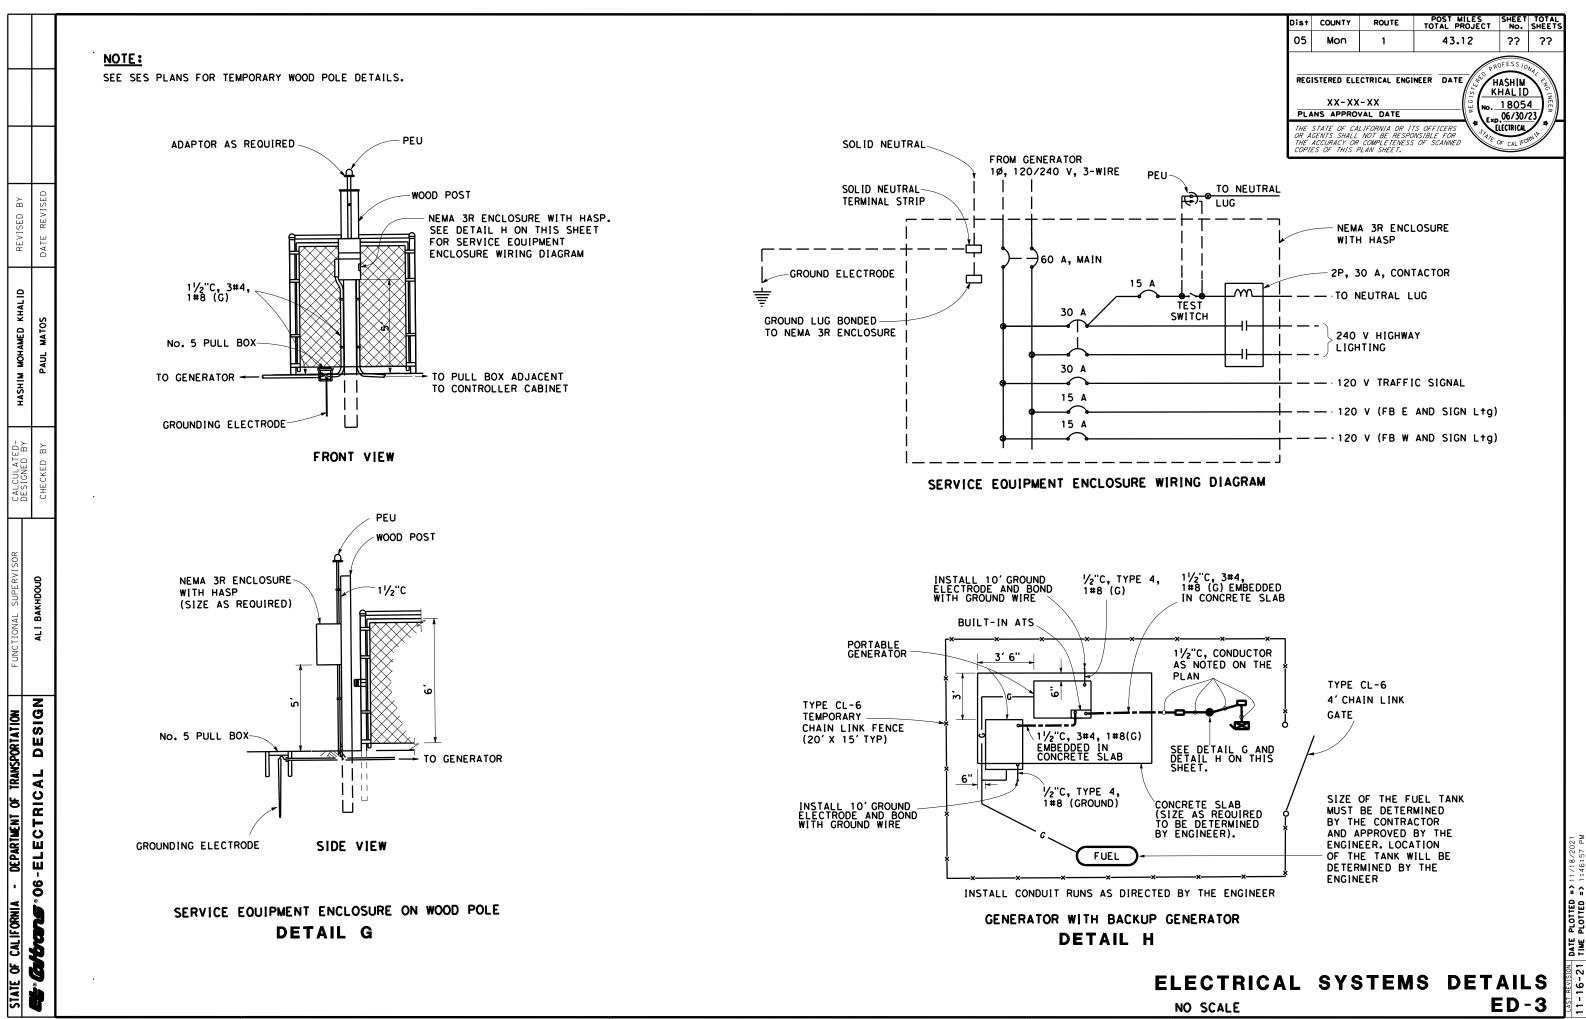

BORDER LAST REVISED 7/2/2010

USERNAME => RELATIVE BORDER SCALE IS IN INCHES UNIT 1515 DGN FILE => ...\CesarFiles\0516000081ub003.dgn

**PROJECT NUMBER & PHASE** 

NOTE:

					_	TEMF	PORAY	' SIGI	NAL S	YSTE	MS		
SHEE T No.	1½"C, 3 TYPE, 3	2"C, TYPĖ 3	No. 4 CONDUCTOR	No. 6 CONDUCTOR	No. 8 CONDUCTOR	No. 10 CONDUCTOR	No. 8 (G) CONDUCTOR	SCSC	DLC	OVERHEAD BUNDLE	VIDA CABLE	TYPE CL-6 TEMPORARY CHAIN LINK FENCE	TYPE

1120

1120

350

2000

1120

1500

FOR INFORMATION ONLY. ELECTRICAL SYSTEMS QUANTITY TABLES SUMMARIZE SIGNIFICANT COMPONENTS. SEE ELECTRICAL SYSTEMS PLANS AND SPECIFICATIONS TO DETERMINE ALL MATERIALS NEEDED FOR EACH SYSTEM.

E-2

E-3

E-4

400

60

760

40

60

40

		<u>. Mpur</u>	AI J	IGNAL	313	IEMJ		
SHEE T No.	GENERATOR	VIDA SENSOR	VIDA EOUIPMENT	VIDA CABLE	No. 5 PB	TEMPORAY WOOD POLE WITH SIG EQUIPMENT ON SPAN	TEMPORAY WOOD POLE WITH FB	TEMPORAY WOOD POLE
				Ε	A			
E-2	2		1		6	1	1	6
E-3		1			3	1		3
E-4					5	1	1	

## TEMPORAY SIGNAL SYSTEMS

1100

560

180

1 300

1120

640

500

560

540

80

100

LF

900

560

760

TYPE A DETECTOR LOOP

4

4

TYPE D DETECTOR LOOP

1

1


USERNAME =>	RELATIVE BORDER SCALE	0	1	2	3	UNIT 1515
DGN FILE =>\CesarFiles\0516000081uc001.dgn	IS IN INCHES					0411 1515

BORDER LAST REVISED 7/2/2010

Dist C	OUNTY	ROUTE	POST MIL TOTAL PRO	.ES JECT	SHEET No.	TOTAL SHEETS			
05	Mon	1	43.12	2	??	??			
REGISTERED ELECTRICAL ENGINEER XX-XX-XX PLANS APPROVAL DATE THE STATE OF CALIFORNIA OR ITS OFFICERS OR AGENTS SHALL NOT BE RESPONSIBLE FOR THE ACCURACY OF CALIFORNIA OF ITS OFFICERS OR AGENTS SHALL NOT BE RESPONSIBLE FOR THE ACCURACY OF CALIFORNIA OF ITS OFFICERS OF AGENTS SHALL NOT BE RESPONSIBLE FOR THE ACCURACY OF CALIFORNIA OF ITS OFFICERS THE ACCURACY OF CALIFORNIA OFFICERS THE ACCURACY OFFICERS T									

MODEL 334L CABINET	TEMPORAY WOOD POLE WITH FB EOUIPMENT	TEMPORAY WOOD POLE WITH Sig EQUIPMENT
EA		
1	1	1
	1	

# **ELECTRICAL SYSTEMS QUANTITIES** EQ-1

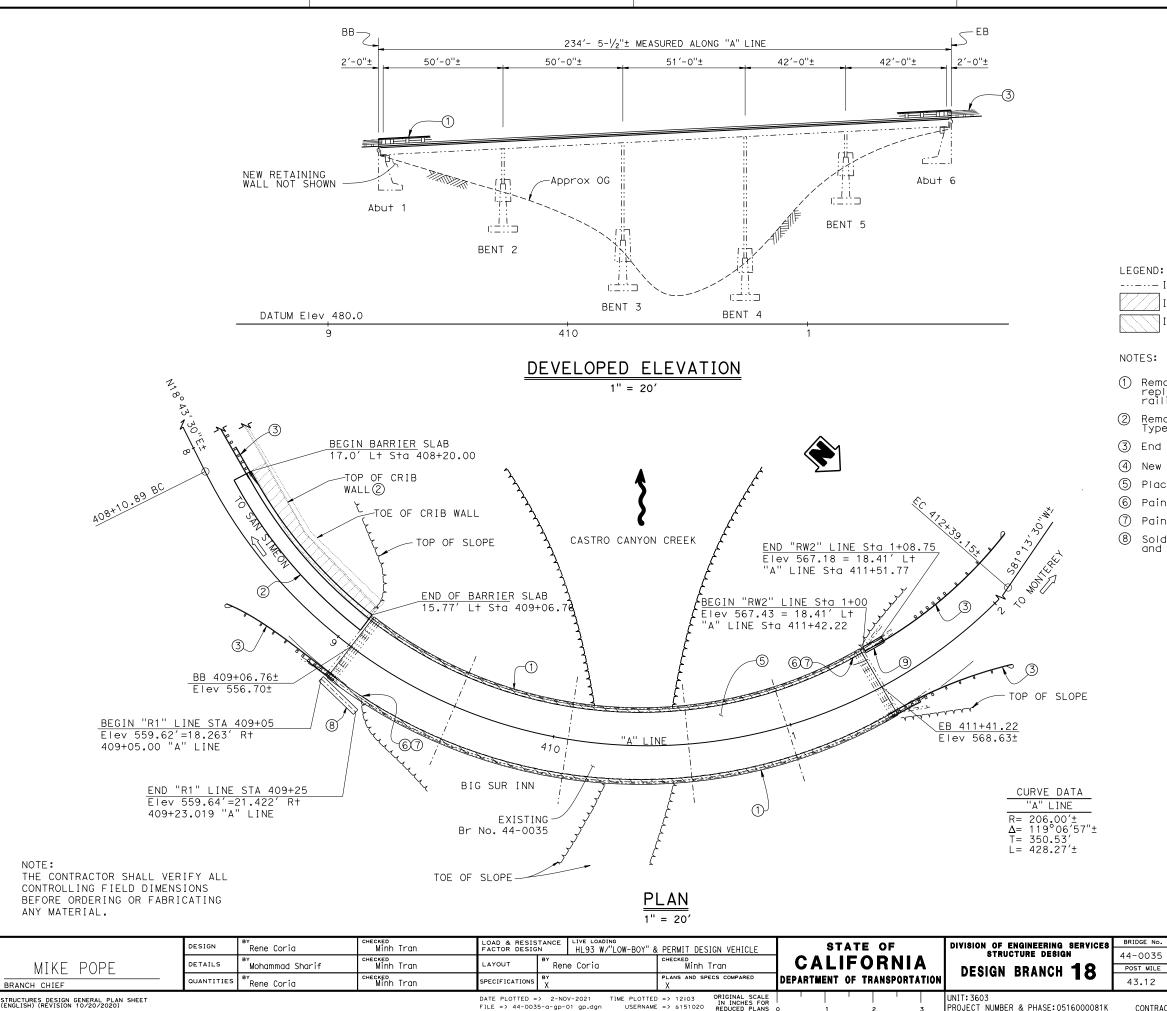

DATE PLOTTED => 2-NOV-2021 FILE => 44-0035-0-gp-01 gp.dgn STRUCTURES DESIGN GENERAL PLAN SHEET ENGLISH) (REVISION 10/20/2020)


PROJECT NUMBER & PHASE:0516000081K


I	Dis†	COUNTY	ROUTE	POST MILES TOTAL PROJECT	SHEET No.	TOTAL SHEETS
	05	Mon	1	43.12	<u> </u>	####
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- ----- Indicates existing structure
  - Indicates Crib Wall Removal
  - Indicates Barrier Rail and Curb removal

- (1) Remove existing concrete curb and timber rail, and replace with concrete barrier Type 85 with tubular bicycle railing, existing reinforcement to remain.
- Remove existing crib wall and K-Rail(not shown), replace with Type 85 barrier on barrier slab, see "BARRIER SLAB" sheet 3 End treatment by District, see "ROADWAY PLANS".
- (4) New Retaining wall, see "SECANT WALL" sheets.
- (5) Place 3/4" polyester concrete overlay over Exist deck.
- 6 Paint: Br. No. 44-0035
- ⑦ Paint: CASTRO CANYON BRIDGE
- (8) Soldier Pile wall with timber lagging, concrete coping and cable railing, see "SOLDIER PILE WALL" sheets.

IDGE No.			<b>A A N N</b>	<b>A</b> N							
-0035	CA	STRO	CANY	ON		3 K I	DG	i E )	K		
ST MILE											
3.12		GENERAL PLAN									
		DISREGARD PRINTS BEARING				REVISIO	N DATES		SHEET	OF	
CONTRACT No.:05-1H490K		CARLIER DEVICION RATES		10/14/21				1	17		



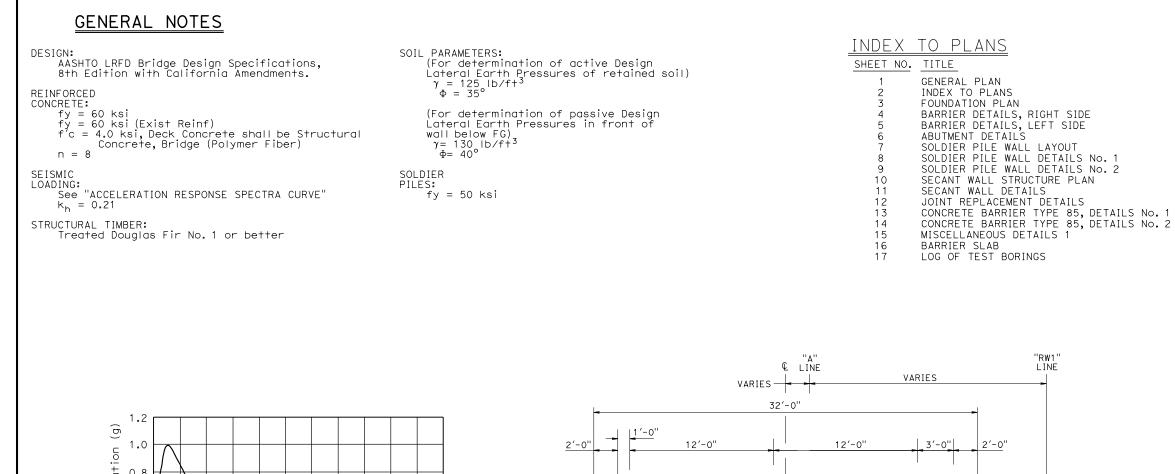
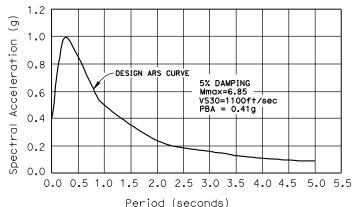
## SITE SPECIFIC ACCELERATION RESPONSE SPECTRA

NO SCALE

I '-0'' WIDEN STAGE 2 TRAFFIC STAGE 2 CONSTRUCTION 15'-0' 15'-0" 10" WIDEN ---STAGE 1 TRAFFIC STAGE 1 CONSTRUCTION 17'-0" 13'-0" (2) 2 LÐ  $\sim 0G = FG$ Ø X Ю Y/XV/X -5.4%± (1)-Approx OG j. يار ر يار\_ OG = FG30'-2"±

> <u>TYPICAL SECTION</u> 1/4" = 1'-0"

NOTE: THE CONTRACTOR SHALL VERIFY ALL CONTROLLING FIELD DIMENSIONS BEFORE ORDERING OR FABRICATING ANY MATERIAL.

	DESIGN		CHECKED	-	e	STATE OF		DIVISION OF ENGINEERING SERVICES	BRIDGE No
		M Rene Coria M		Minh Tran				STRUCTURE DESIGN	44-003
	DETAILS	вү Mohammad Sharif	CHECKED	Tran		IFO	RNIA		
		Monalilliaa sharit	Minh	Iran				DESIGN BRANCH <b>18</b>	POST MIL
	QUANTITIES	ву Rene Coria	снескер Minh	Tran	DEPARTMEN	DEPARTMENT OF TRANSPORTATION			43.12
STRUCTURES DESIGN DETAIL SHEET	DATE PLOTTED =	> 2-NOV-2021 TIME PLOTTED	) => 12:03	ORIGINAL SCALE				UNIT: 3603	
STRUCTURES DESIGN DETAIL SHEET ( (ENGLISH) (REVISION 12/13/2019)	TILE => 44-003	35-a-itp.dgn USERNAME	=> s15102	IN INCHES FOR REDUCED PLANS	0 1		2 3	PROJECT NUMBER & PHASE: 0516000081	CONTR

	I					
	Dis†	COUNTY	ROUTE	POST MILES TOTAL PROJECT	SHEET No.	TOTAL SHEETS
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			<u>S DAI</u>	EU ZUIO		
		IPTION				
A3B A3C A10A A10B A10B A10C L A10C L A10F L A10F L A10F L A10H A10H A10H L A77U1 E	ABBRE ABBRE EGEN EGEN EGEN EGEN EGEN EGEN AIDWE BRIDG	VIATION VIATION ID LINES ID LINES ID LINES ID LINES ID - SOI ID - SOI ID - ROO ST GUAR	S (SHEET AND SYM AND SYM AND SYM AND SYM AND SYM L (SHEET L (SHEET CK DRAIL SY	2 OF 3) 3 OF 3) BOLS (SHEET 1 BOLS (SHEET 2 BOLS (SHEET 3 BOLS (SHEET 4 BOLS (SHEET 5	OF OF OF OF OF	5) 5) 5) 0
A77U2 N				STEM CONNECTI DUT SIDEWALKS,		
A77U4 M	IDWE			STEM TRANSITI	N	
B6-21 B11-47 RSP B11-83 RSP B11-84	JOINT CABLE Concr Concr	SEALS RAILIN ete Bar ete Bar	Ġ rier Typ rier Typ	MOVEMENT RAT e 85 Details e 85 Details e 85 Details	No. 1	")

STANDARD PLAN SHEET NO.

### LEGEND:


----- Indicates Existing structure


Indicates Bridge Removal (Portion)

NOTES:

- Remove existing concrete curb and timber rail, and replace with concrete barrier Type 85 with tubular bicycle railing, existing reinforcement to remain.
- (2) Temporary Railing (Type K) see "ROADWAY PLANS"
- (3) Soldier Pile wall with timber lagging, concrete coping and cable railing, see "SOLDIER PILE WALL" sheets.

No.				
035		CASTRO CANYON BRIDGE		
MILE				
12		INDEX TO PLAN		
		DISREGARD PRINTS BEARING REVISION DATES SI	SHEET	OF
NTRACT	No.: 05-1H490	EARLIER REVISION DATES 10/14/21 10/22/21	2	17

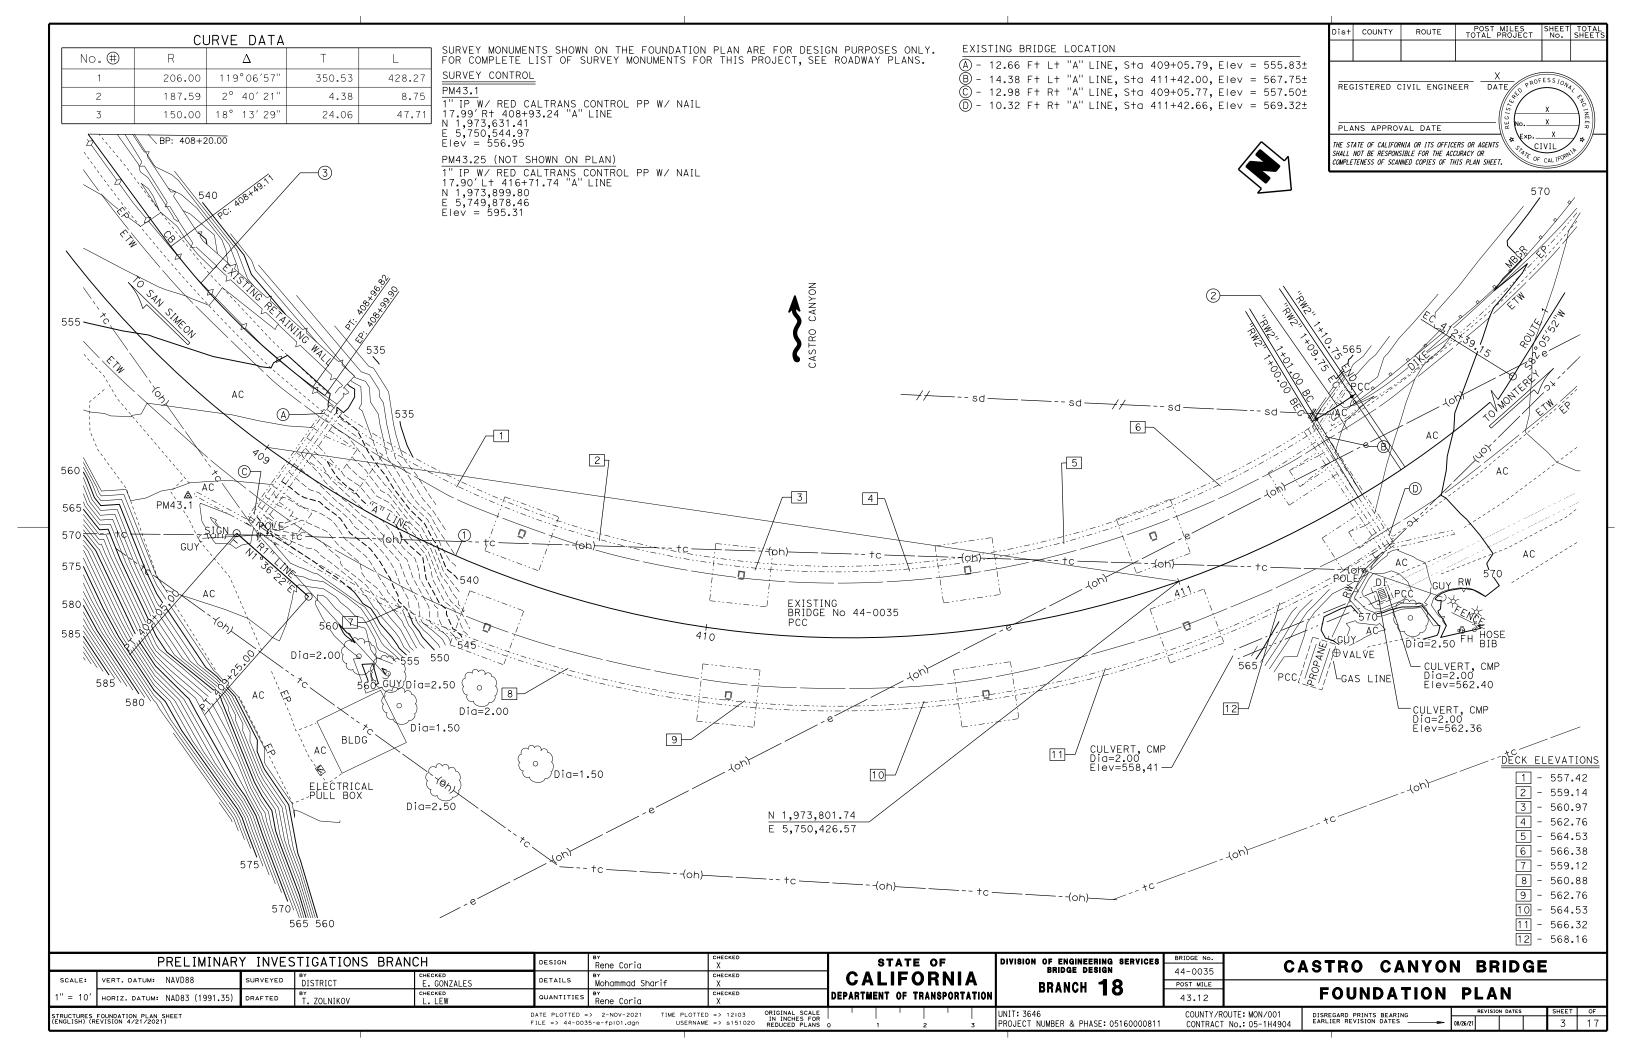

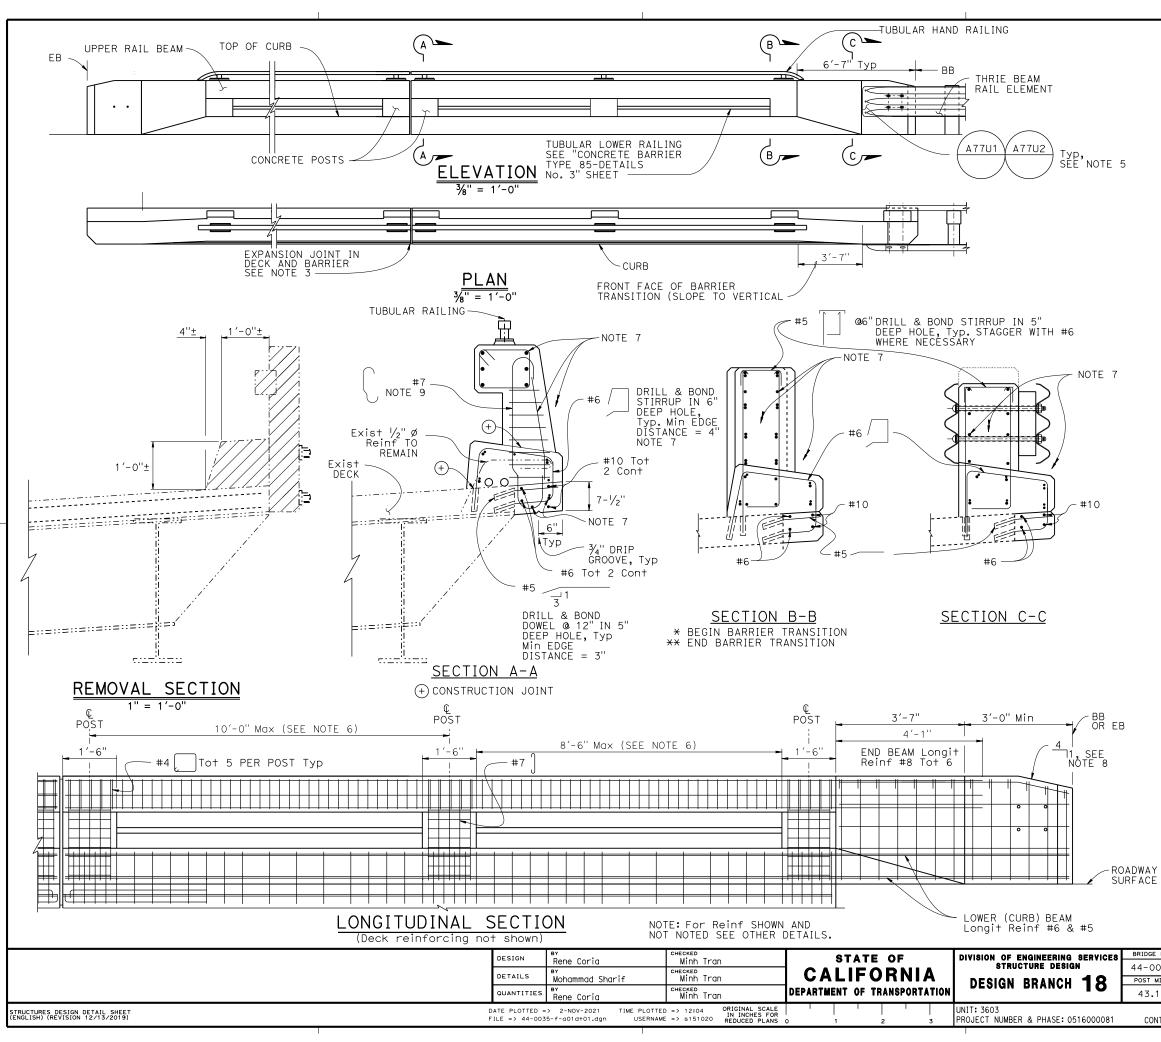

Dis†	COUNTY	ROUTE	POST MILES TOTAL PROJECT	SHEET No.	TOTAL SHEETS
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LEGEND:

----- Indicates Existing structure


[///] Indicates Bridge Removal (Portion)


NOTES:

- Longitudinal reinforcing steel to stop at all expansion joints.
- 2. The front face dimensions are to be constant above the finish roadway profile, but the overall height will vary with certain thicknesses of surfacing and roadway slopes.
- Expansion joint to match deck joint. See "CONCRETE BARRIER TYPE 85, DETAILS No. 1" sheet for "EXPANSION JOINT DETAIL" and NOTES.
- 4. Splicing in longitudinal rail reinforcing must be staggered.
- 5. For typical metal railing connection details not shown, see Standard Plans A77U1 and A77U2.
- 6. Posts to be spaced equally, typically 10'-0" spacing. Post spacing may be reduced where location of expansion joints or the length of wingwalls will not accommodat the 10'-0" spacing. Maximum see-through availability is to be strived for, where 10'-0" post spacing cannot be achieved.
- 7. For additional reinforcement details, see "CONCRETE BARRIER TYPE 85-DETAILS No. 1 & 2" sheets.
- 8. Taper top of the end of the bridge railing at 4:1 to match the top elevation of the thrie beam railing element.
- 9. #7 Rebar may be bent to avoid Exist edge of Deck.


NOTE: THE CONTRACTOR SHALL VERIFY ALL CONTROLLING FIELD DIMENSIONS BEFORE ORDERING OR FABRICATING ANY MATERIAL.

E No.			
035		CASTRO CANYON BRIDGE	
MILE			
12	BAR	RIER DETAILS, RIGHT SIDE	
		DISREGARD PRINTS BEARING REVISION DATES SHEET	OF
NTRACT	No.: 05-1H490	EARLIER REVISION DATES 10/9/21 4	19

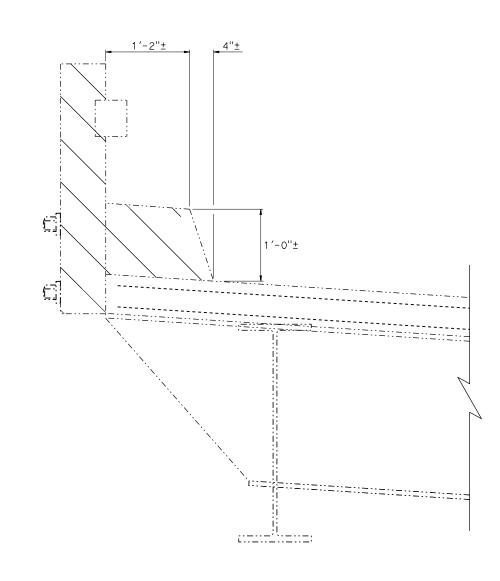

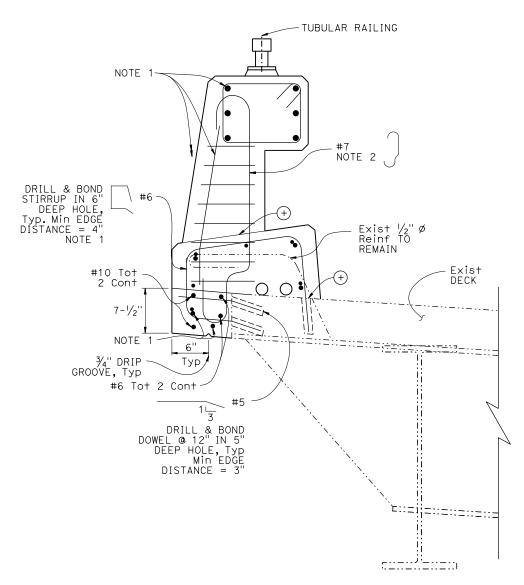

LEFT WIDENING

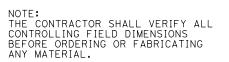

DESIGN	BY			DIVISION OF ENGINEERING SERVICES	BRIDGE No.
DESIGN	Rene Coria	Minh Tran		STRUCTURE DESIGN	44-0035
DETAILS Wohammad Sharif Minh Tran CALIFO		<b>CALIFORNIA</b>			
	Mohalilliaa sharri			DESIGN BRANCH <b>18</b>	POST MILE
QUANTITIES	Rene Coria	Minh Tran	DEPARTMENT OF TRANSPORTATION		43.12
DATE PLOTTED	=> 2-NOV-2021 TIME PLOTTED	D => 12:04 ORIGINAL SCALE		UNIT: 3603	
FILE => 44-0035-f-a01d+02.dgn USERNAME => s151020 IN INCHES FOR REDUCED PLANS		0 1 2 3	PROJECT NUMBER & PHASE: 0516000081	CONTRA	

 $\frac{\text{REMOVAL SECTION}}{1 \frac{1}{2} = 1^{\prime} - 0^{\prime\prime}}$ 

Dis†	COUNTY	ROUTE	POST MILES TOTAL PROJECT	SHEET No.	TOTAL SHEETS
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LEGEND:

(+)

----- Indicates Existing structure


//////// Indicates Bridge Removal (Portion)

CONSTRUCTION JOINT

NOTES:


- For additional reinforcement details, see "CONCRETE BARRIER TYPE 85-DETAILS No. 1 & 2" sheets.
- #7 rebar may be bent to avoid existing adge of deck.

E No.				
035		CASTRO CANYON BRIDGE		
MILE				
12	BAR	RIER DETAILS, LEFT SID	DE	
		DISREGARD PRINTS BEARING REVISION DATES	SHEET	OF
NTRACT	No.: 05-1H490	EARLIER REVISION DATES 10/9/21	5	17

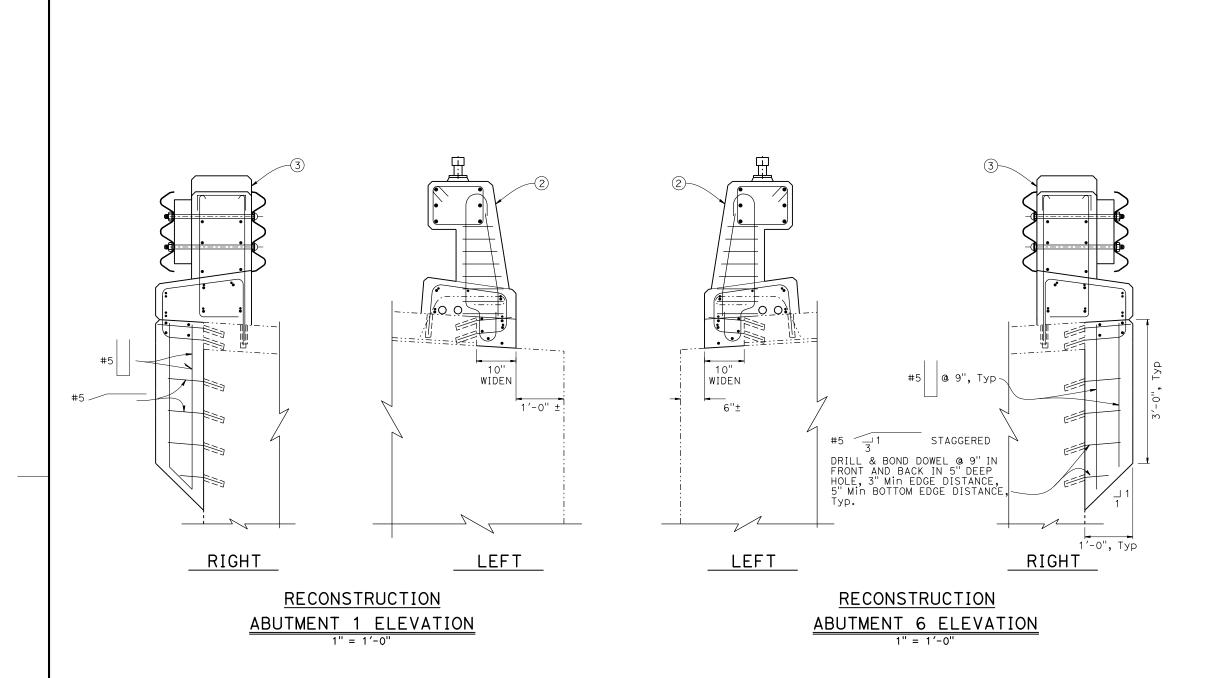


NOTE: THE CONTRACTOR SHALL VERIFY ALL CONTROLLING FIELD DIMENSIONS BEFORE ORDERING OR FABRICATING ANY MATERIAL.

DESIGN	BY	CHECKED	STATE OF	DIVISION OF ENGINEERING SERVICES	BRIDGE No
DESIGN	Rene Coria	Minh Tran CHECKED		STRUCTURE DESIGN	44-003
DETAILS	Mohammad Sharif	Minh Tran	<b>CALIFORNIA</b>		POST MILE
	BY			DESIGN BRANCH <b>18</b>	
QUANTITIES	Rene Coria	Minh Tran	DEPARTMENT OF TRANSPORTATION		43.12
DATE PLOTTED	=> 2-NOV-2021 TIME PLOTTE	0 => 12:04 ORIGINAL SCALE		UNIT: 3603	
FILE => 44-00	35-f-a01d+03.dgn USERNAME	IN INCHES FOR REDUCED PLANS	0 1 2 3	PROJECT NUMBER & PHASE: 0516000081	CONTR

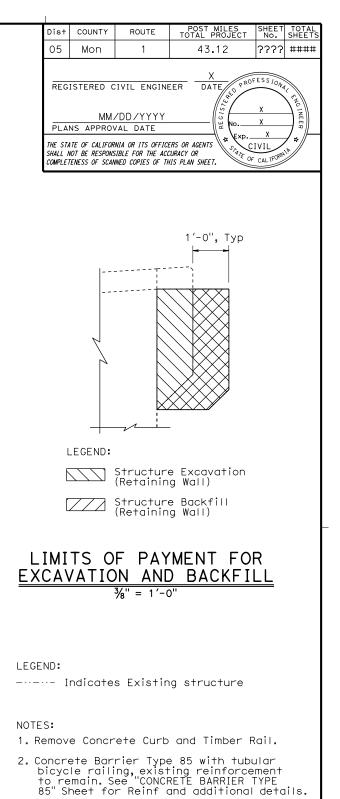

- 3. Concrete Barrier Type 85 transition, see "BARRIER DETAILS, RIGHT SIDE" Sheet, "Detail C-C" for Reinf and additional information.
- 4. For Bridge Removal (Portion) at About, see "BARRIER DETAILS, LEFT SIDE" and "BARRIER DETIALS, RIGHT SIDE" Sheets for "REMOVAL SECTION" Details.


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035		CASTRO CANYON BRIDGE		
4ILE .				
12		ABUTMENT DETAILS		
		DISREGARD PRINTS BEARING REVISION DATES S	HEET	OF
ITRACT	No.: 05-1H490	EARLIER REVISION DATES 10/15/21	6	17

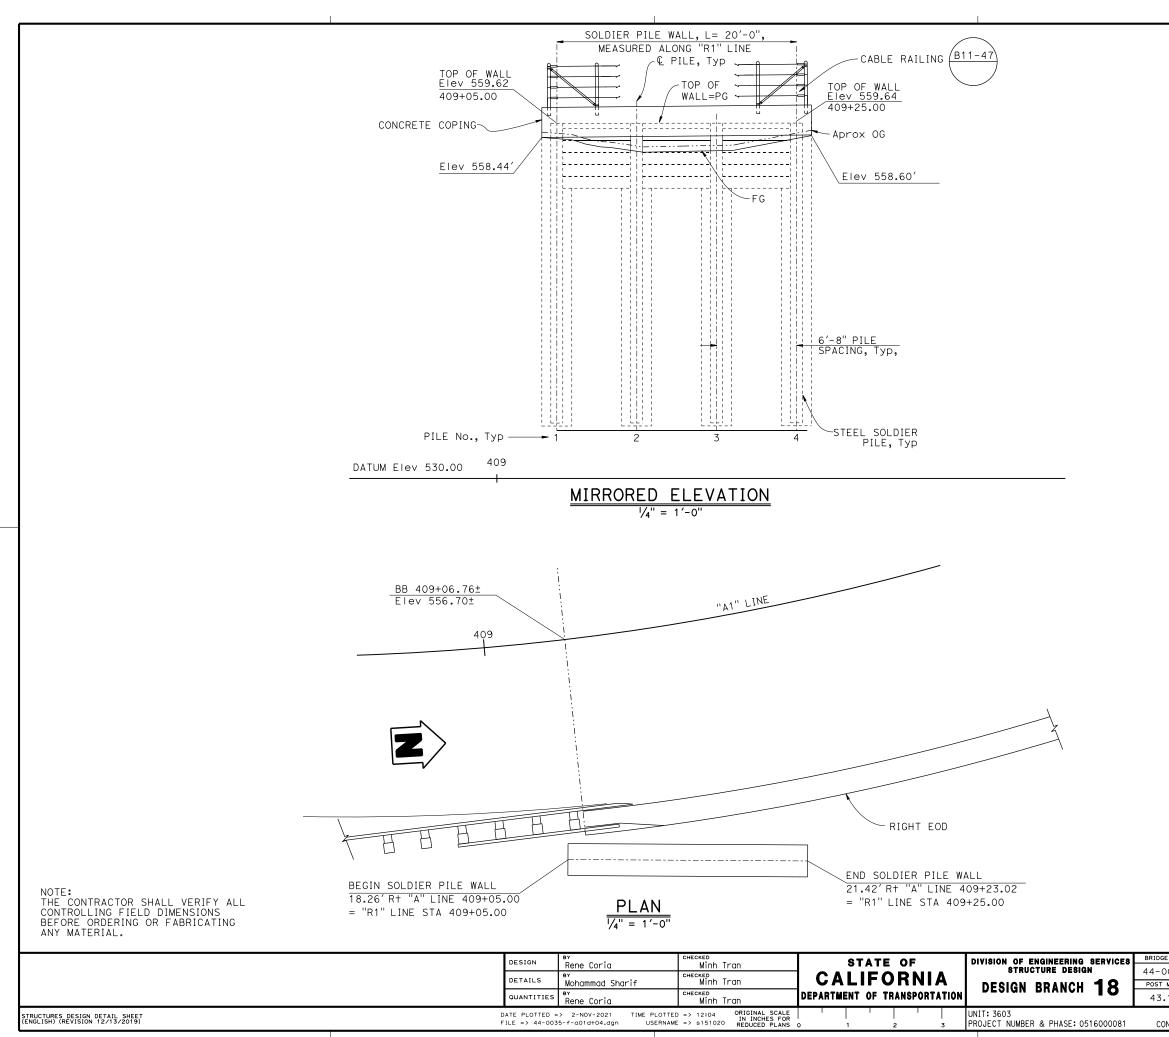

Dis†	COUNTY	ROUTE	POST MILES TOTAL PROJECT	SHEET No.	TOTAL SHEETS
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PILE LENGTH25252525NUMBER OF TIMBER LAGGING BETWEEN PILES555	PILE NO.	1	2	3	4
	PILE LENGTH	25	25	25	25
		5	5	5	5

				TOP OF WALL
PILE	"R1" LOL	FG	OG	ELEVATION
No.	STATION	Elev	Elev ±	(f+)
1	409+05.00		558.88	559.62
2	409+11.67	557.29	557.73	559.63
	409+18.34			559.63
4	409+25.00	558.36	559.04	559.64

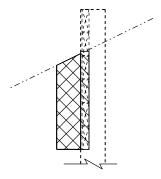

### LEGEND:

SSSS Structure Excavation (Retaining Wall) Structure Backfill (Retaining Wall)

## LIMITS OF PAYMENT FOR EXCAVATION AND BACKFILL 3/8" = 1'-0"


### LEGEND:


----- Denotes Existing

NOTES:

1. See "SOLDIER PILE WALL DETAILS No. 1" sheet for Soldier Pile Typical Section.


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0035		CASTRO	CANYO	JN E	SKIDG			
MILE								
.12	SOL	DIER P	ILE W	ALL	LAI	οι	JT	
		DISREGARD PRINTS	BEARING		REVISION DATES		SHEET	OF
ONTRACT	No.: 05-1H490	EARLIER REVISION		► 10/30/2 <sup>-</sup>	1		7	19

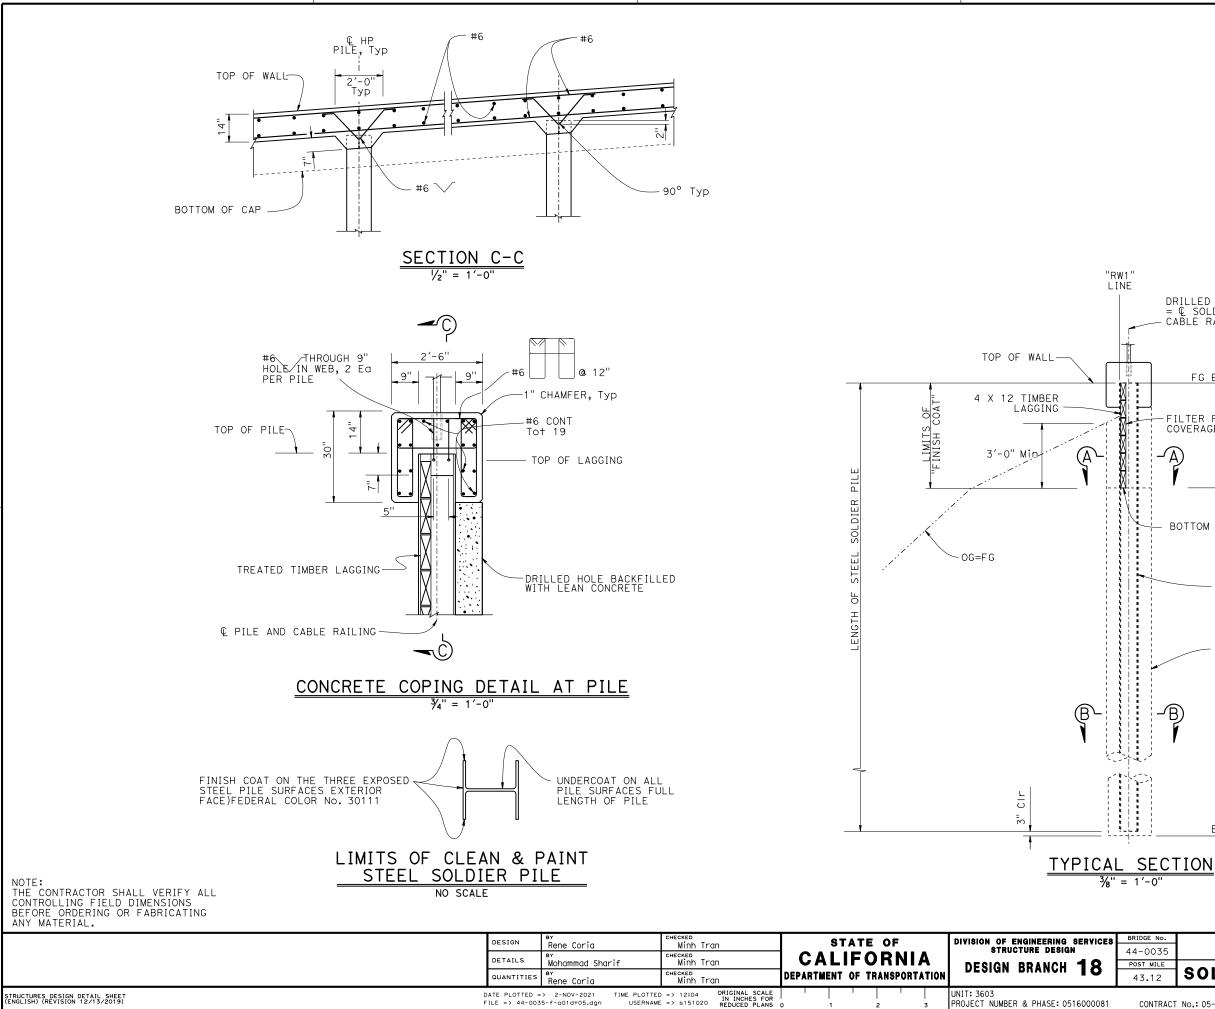


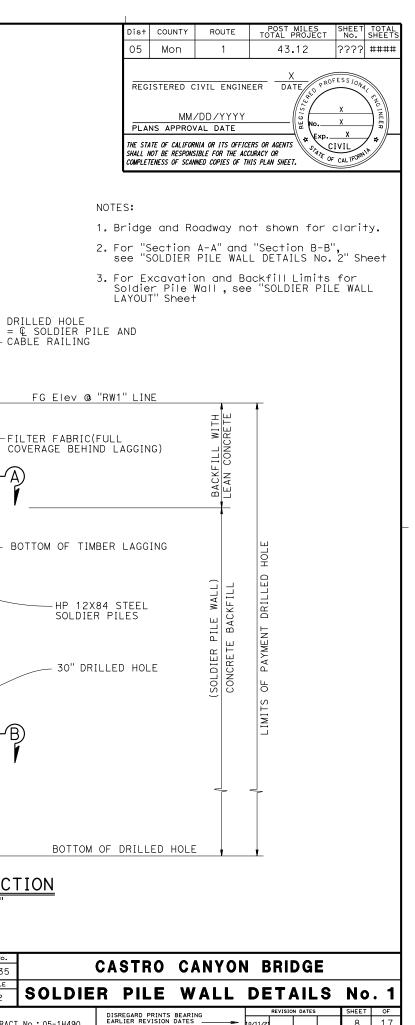


CONTRACT No.: 05-1H490

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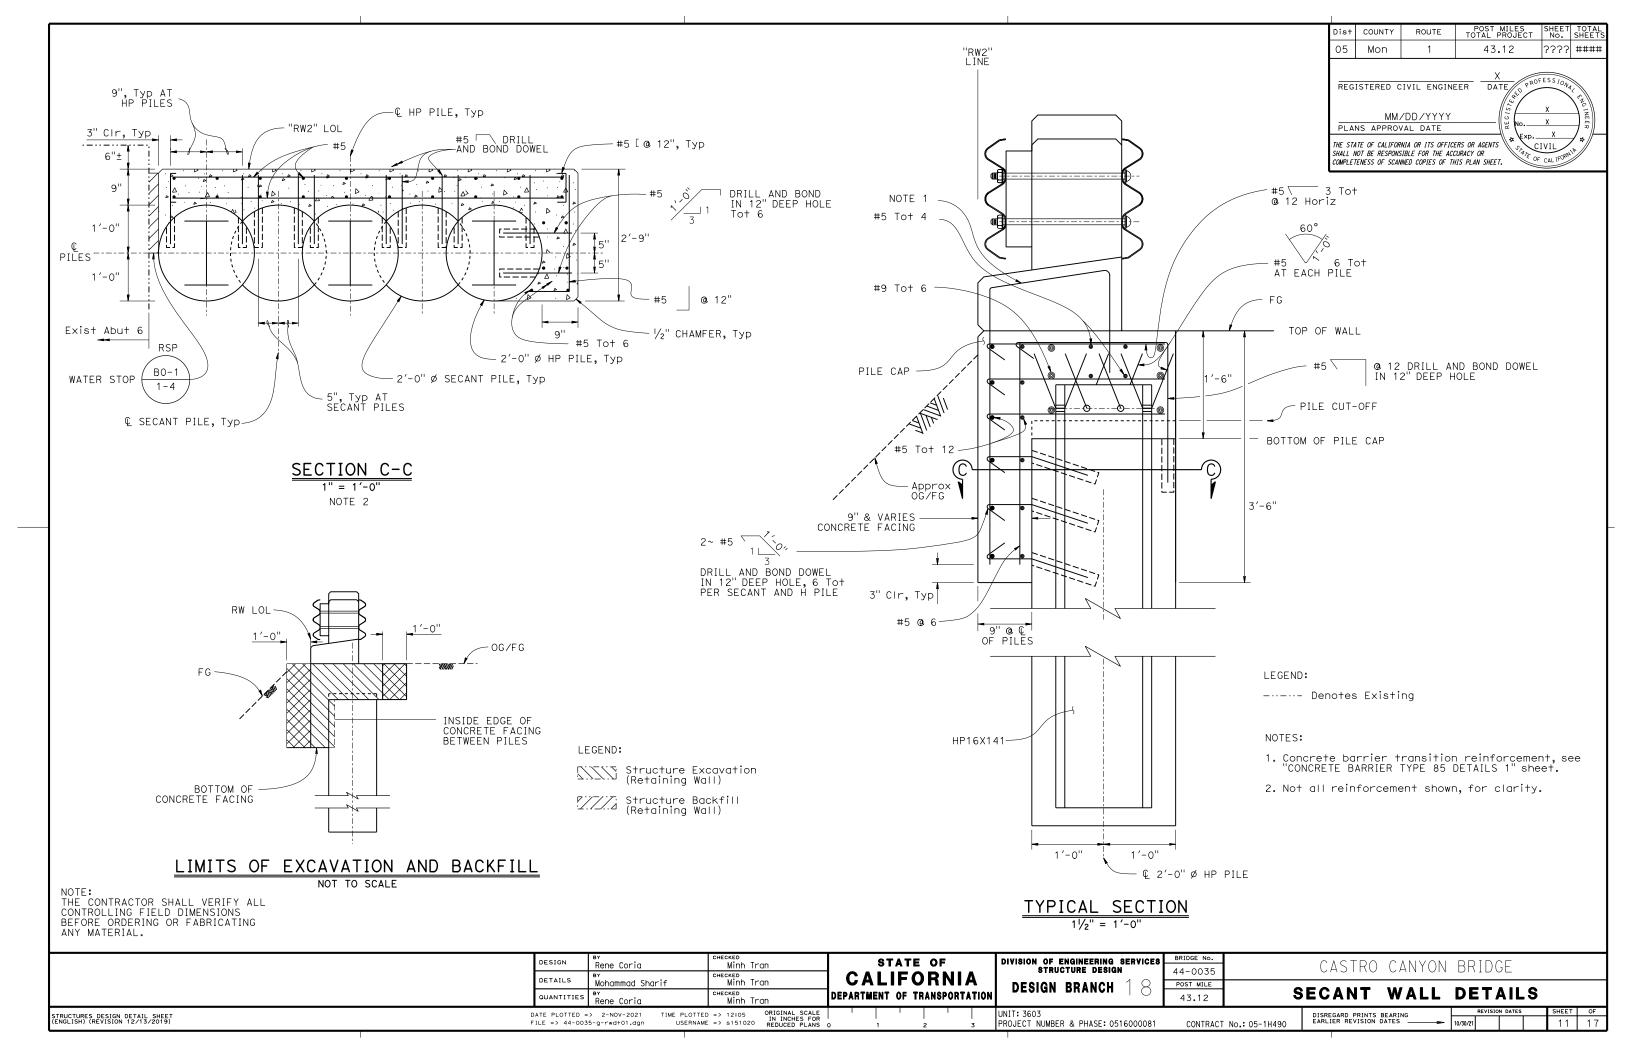


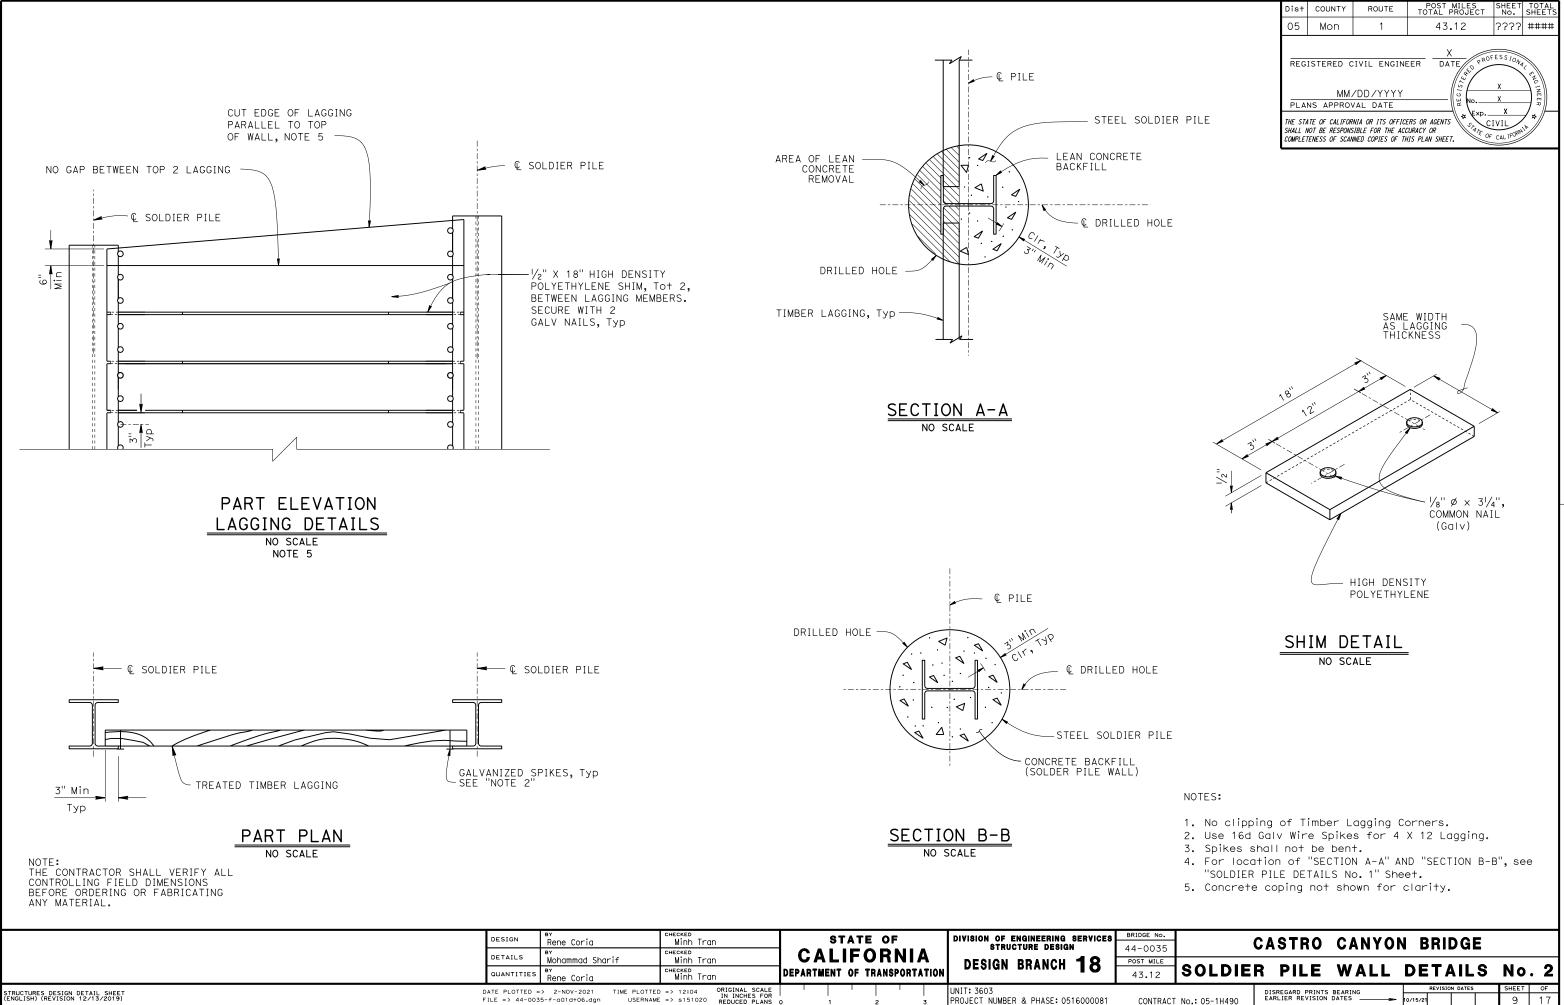


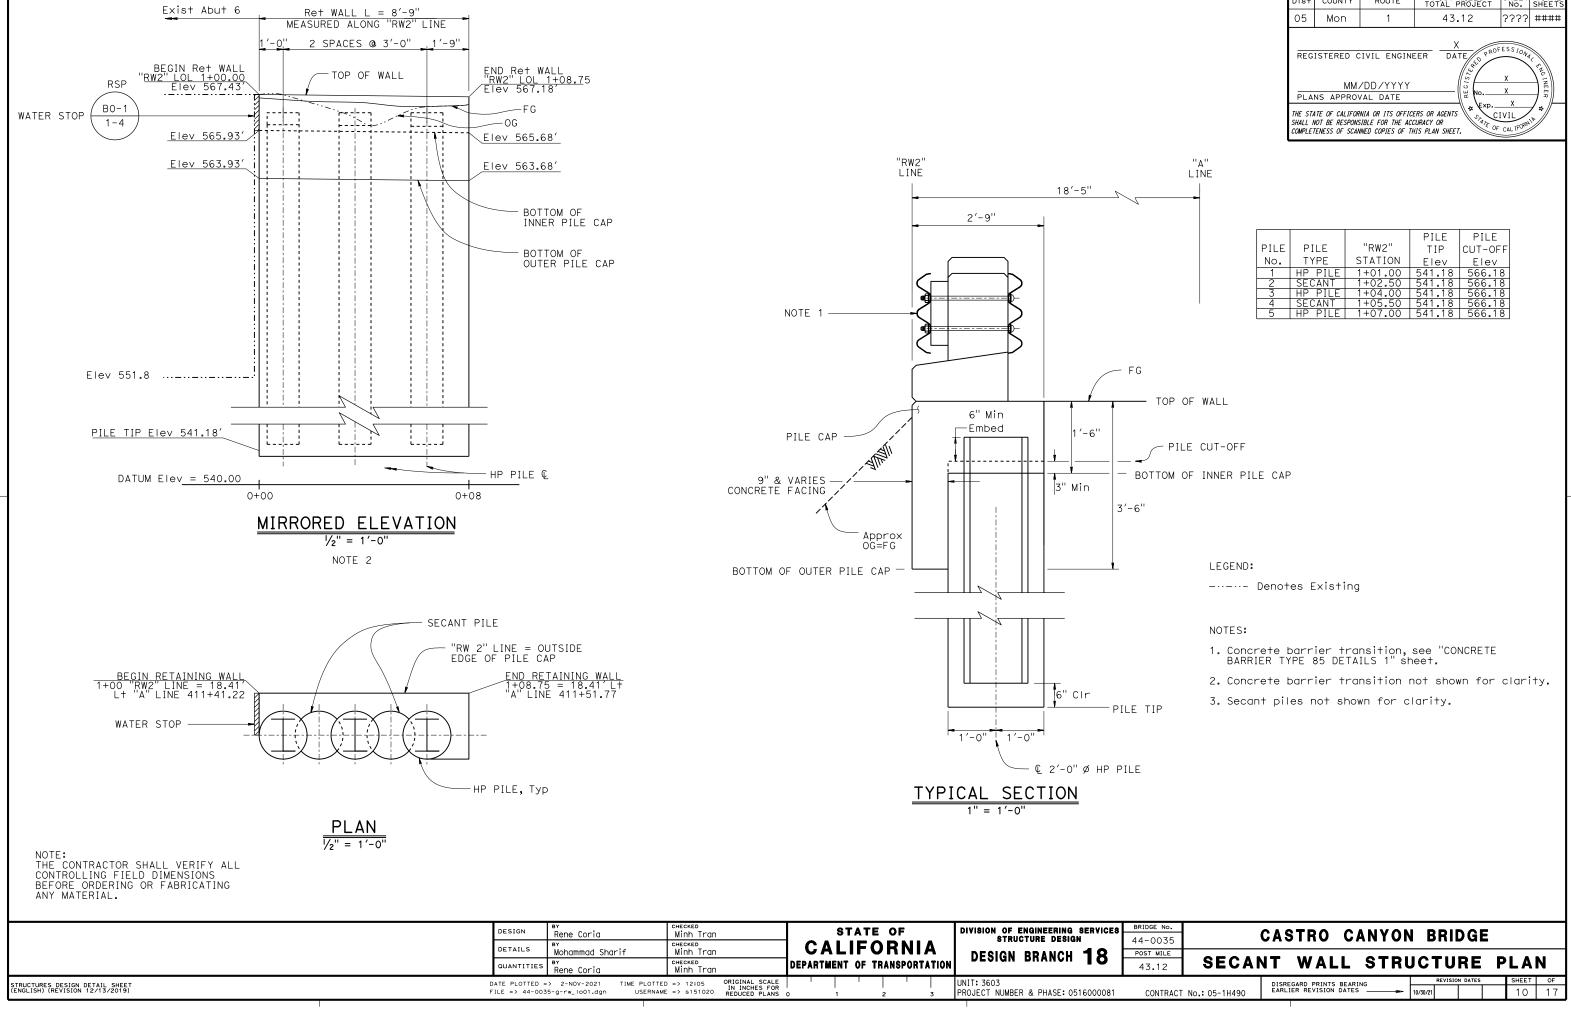

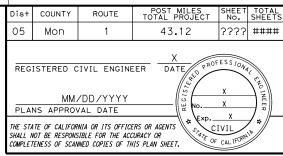

			PILE	PILE
PILE	PILE	"RW2"	TIP	CUT-OFF
No.	TYPE	STATION	Elev	Elev
1	HP PILE	1+01.00	541.18	566.18
2	SECANT	1+02.50	541.18	566.18
3	HP PILE	1+04.00	541.18	566.18
4	SECANT	1+05.50	541.18	566.18
5	HP PILE	1+07.00	541.18	566.18



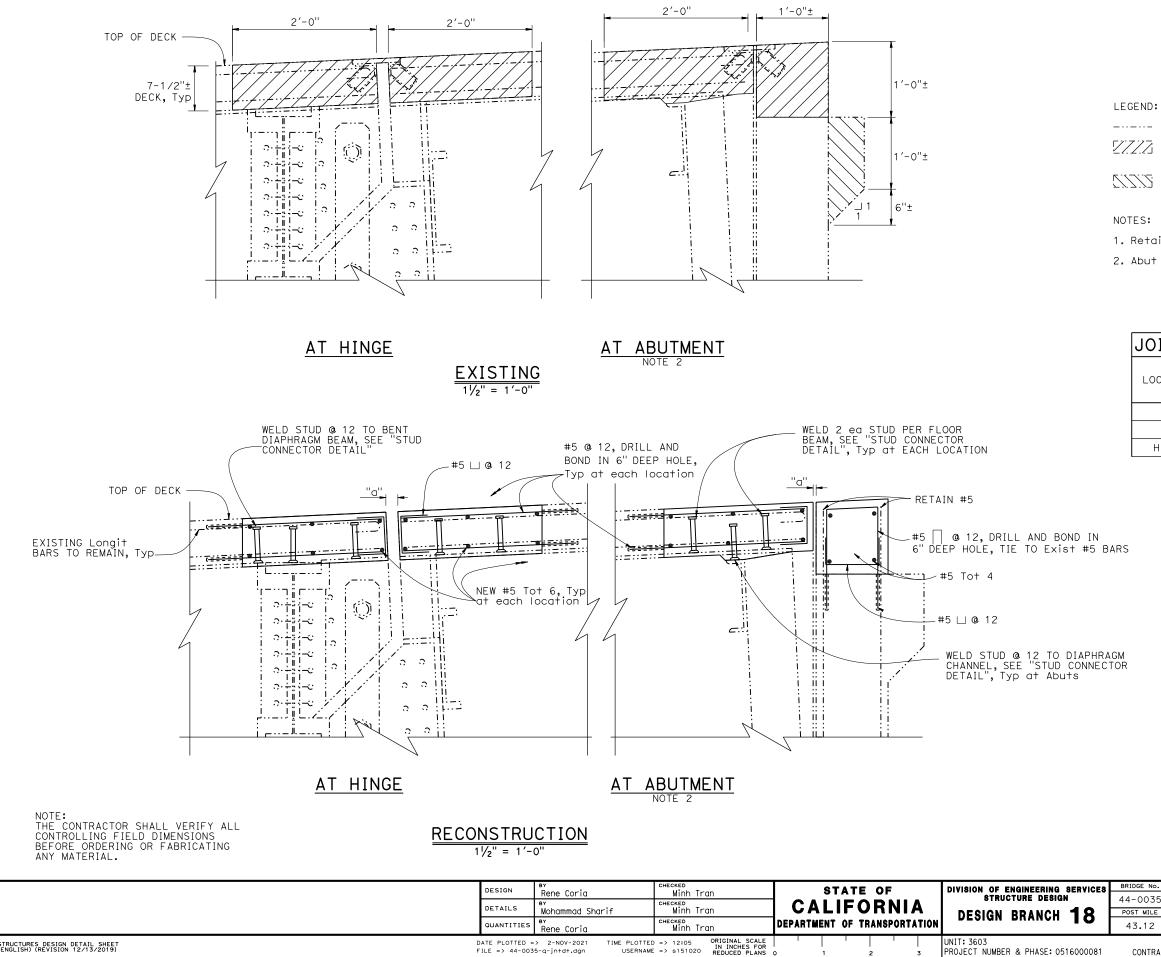

Dis†	COUNTY	ROUTE	POST MILES TOTAL PROJECT	SHEET No.	TOTAL SHEETS
05	Mon	1	43.12	????	####
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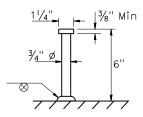
----- Indicates Existing


- ZZZZ Limits of Bridge Removal (Portion), remove Exist concrete, joint armor and transverse steel
- Limits of Bridge Removal (Portion) of backwall at Secant Wall at Abut 6, W= 3'-6"±

1. Retain all longitudinal steel not show.


2. Abut 6 shown, Abut 1 similar.

IOINT I	NFORM	ATION	"a" DIME	ENSIONS	(IN)
LOCATION	MOVEMENT RATING (MR)	LENGTH (FT)	WINTER	SPRING & FALL	SUMMER
BB	1/2"	35′-6"	3⁄4''	3⁄4''	1/2"
EB	1/2"	34'-3"	3⁄4''	3⁄4''	1/2"
HINGE	2"	46'-3"	1 1/2"	11/4"	3⁄4''




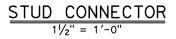



GE No.			<u> </u>					
0035		CASTRO	CANYON	I R	KII	DGI		
MILE					_		 	
.12	JOIN	T REPL	ACEME	NT	D	E	LS	
		DISREGARD PRINTS	BEARING		REVISIO	N DATES	SHEET	OF
ONTRACT	No.: 05-1H490	EARLIER REVISION		10/30/21			12	17

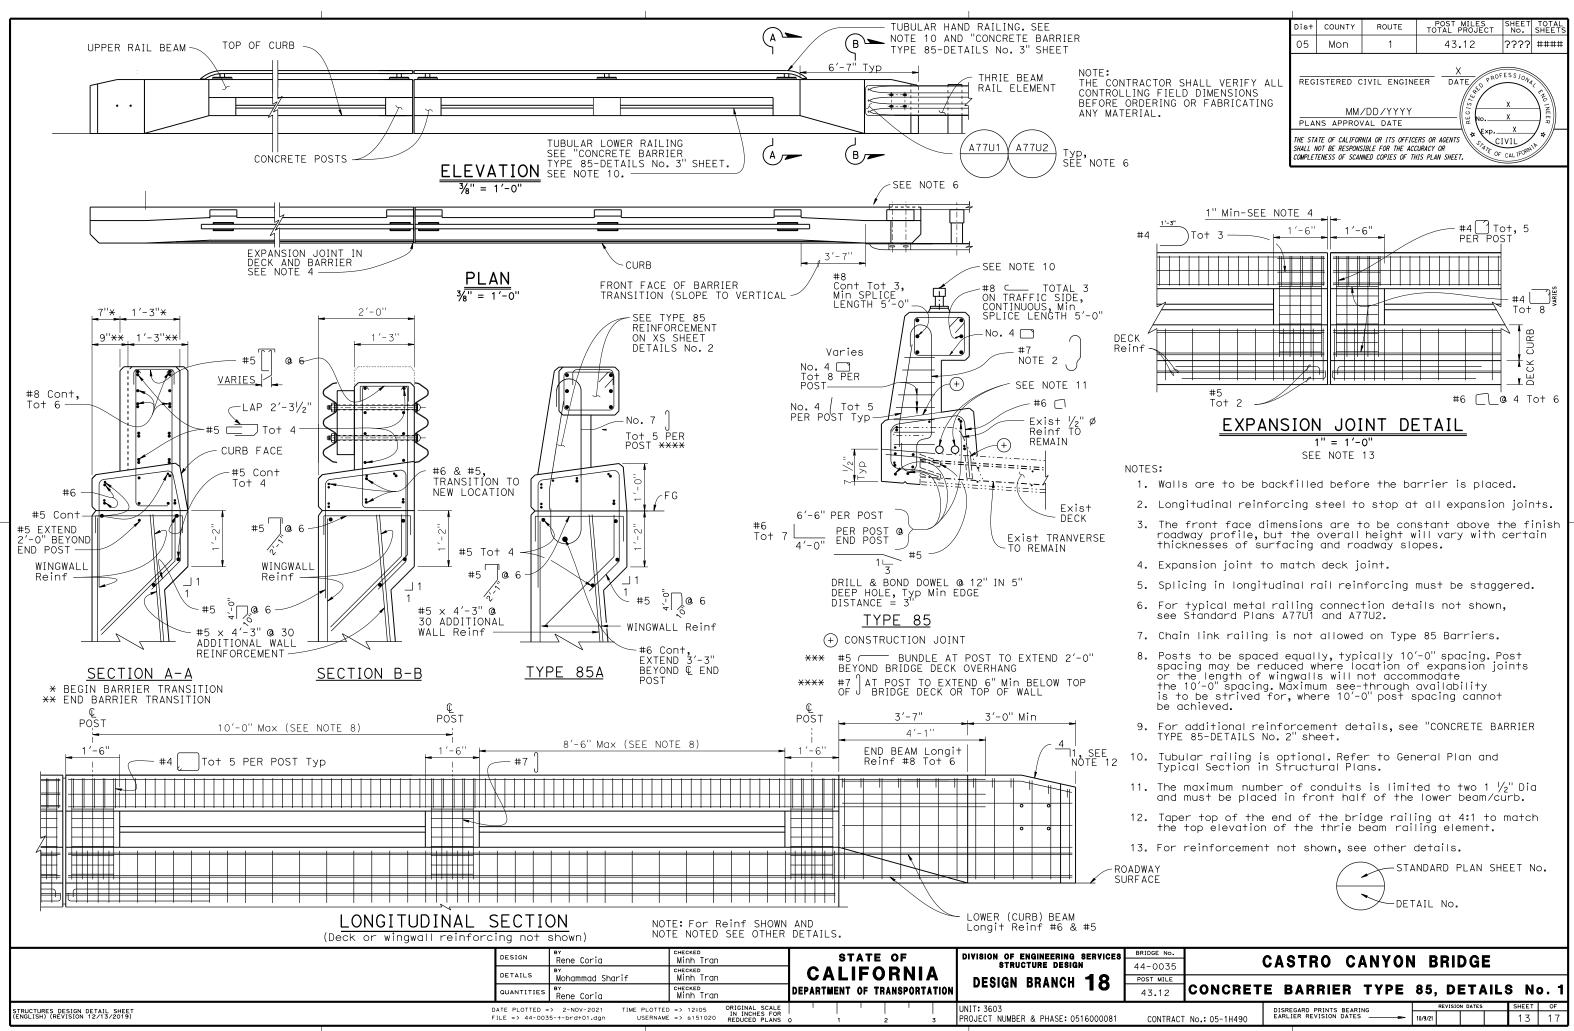

E No.		0 4 0 T D 0	<u> </u>			-		
0035		CASTRO	CANYOR	A RI	RIDGE			
MILE								
.12	CONCRET	E BARRIEI	R TYPE	85.	DETA	\IL §	5 N (	o. 1
					EVISION DATES		SHEET	OF
ONTRACT	No.: 05-1H490	DISREGARD PRINTS E EARLIER REVISION D	BEARING					

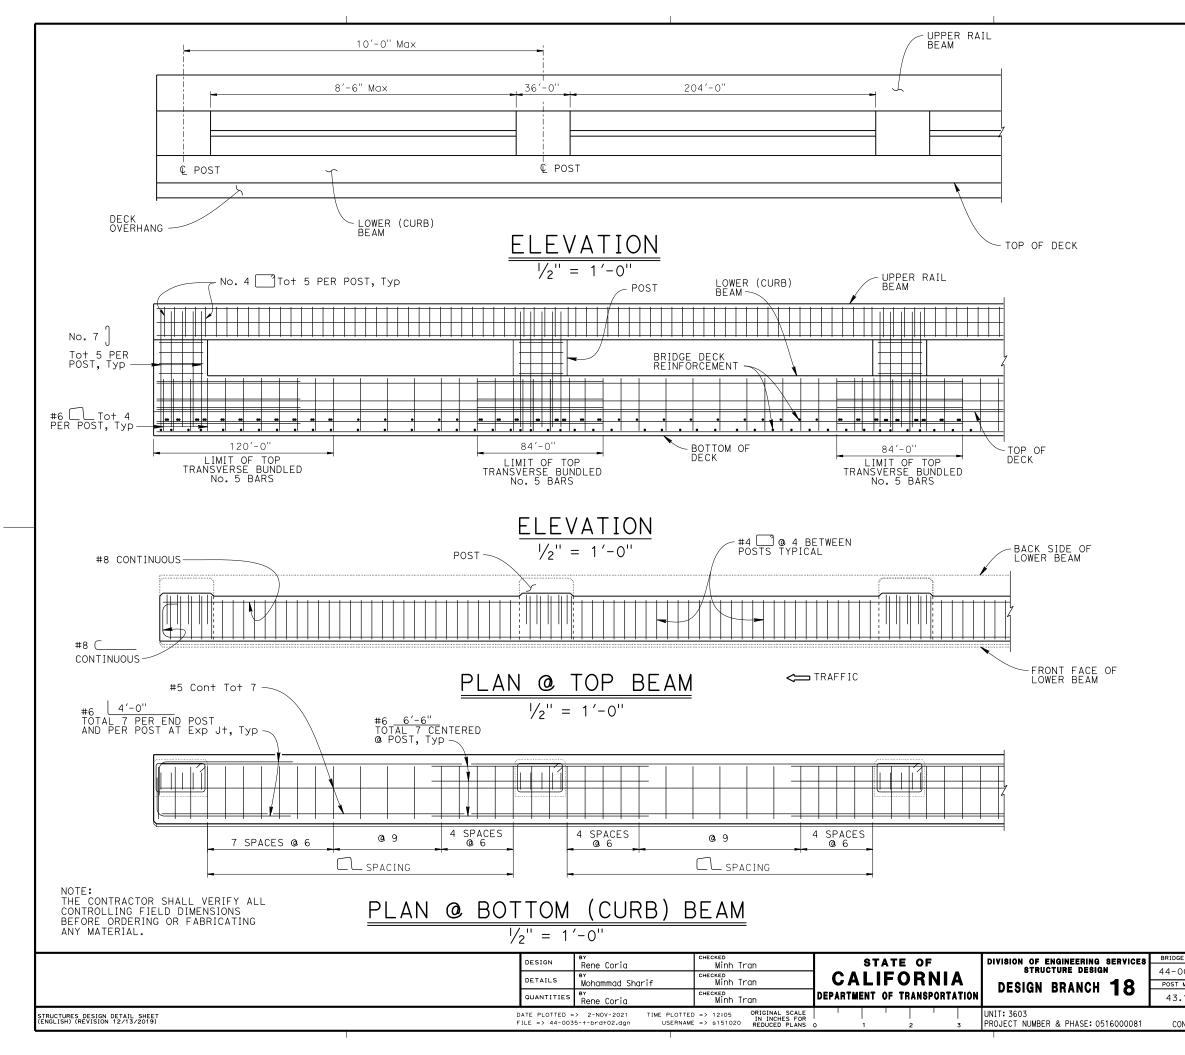


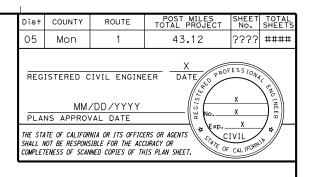

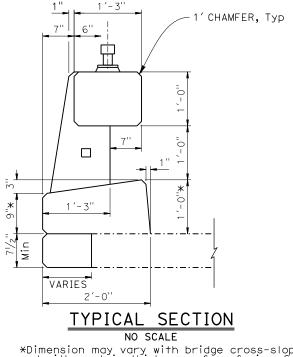

\*Dimension may vary with bridge cross-slope and with certain thickness of surfacing. See Structural Plans.

E No.		~ ~ ~ =								
0035		CASI	RO C	ANYON		KI	DGI			
MILE										
.12	CONCRET	E BA	RRIER	TYPE	85,	D	ETA	ILS	S No	<b>).</b> 2
DNTRACT No.: 05-1H490		DISREGARD PRINTS BEARING			REVISION DATES			SHEET	OF	
			EARLIER REVISION DATES		10/9/21				14	17

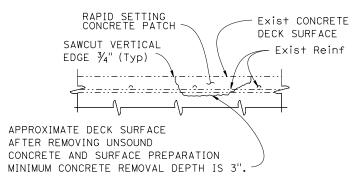

# DECK REPAIR DETAIL


LOCATIONS TO BE DETERMINED BY THE ENGINEER. REINFORCEMENT MAY BE ENCOUNTERED DURING DECK CONCRETE REMOVAL. NO SCALE

DECK REPAIR TABLE REMOVE UNSOUND CONCRETE AND PLACE RAPID SETTING CONCRETE (PATCH)									
BRIDGE NAME	BRIDGE NUMBER	APPROXIMATE AREA DAMAGE (SQUARE FEET)	APPROXIMATE DEPTH (INCHES)						
CASTRO CANYON BRIDGE	44-0035	2%	3						


NOTE: THE CONTRACTOR SHALL VERIFY ALL CONTROLLING FIELD DIMENSIONS BEFORE ORDERING OR FABRICATING ANY MATERIAL.

	DESIGN	By Rene Coria	снескер Minh Tran	STATE OF	DIVISION OF ENGINEERING SERVICES Structure design	BRIDGE No.	
	DETAILS	<sup>₿</sup> Y Mohammad Sharif	снескер Minh Tran		DESIGN REANCH 19	POST MILE	F
	QUANTITIES	ву Rene Coria	снескер Minh Tran	DEPARTMENT OF TRANSPORTATION		43.12	MISCELLANEOUS DETAILS 1
STRUCTURES DESIGN DETAIL SHEET (ENGLISH) (REVISION 12/13/2019)		=> 2-NOV-2021 TIME PLOTTED 35-u-miscd+01.dgn USERNAME	D => 12:05 E => s151020 CRIGINAL SCALE IN INCHES FOR REDUCED PLANS	0 1 2 3	UNIT: 3603 PROJECT NUMBER & PHASE: 0516000081	CONTRAC	RACT No.: 05-1H490

Dist	COUNTY	ROUTE	POST MILES TOTAL PROJECT	SHEET No.	TOTAL SHEETS				
05	Mon	1	43.12 ????						
05     Mon     1     43.12     ????     ####################################									

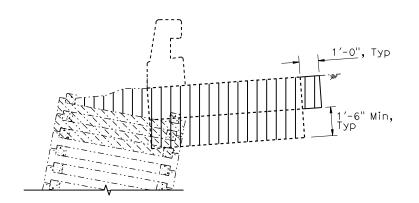

LIMITS OF EXCAVATION

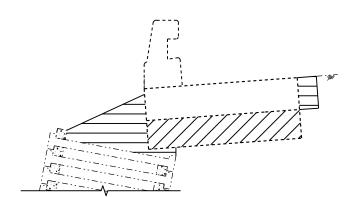

# LIMITS OF BACKFILL


### LEGEND:

----- Indicates Existing

EXCAVATION & BACKFILL LEGEND:

- Limits of Structure Excavation
- Limits of Structure Backfill
- Limits of Structure Backfill (95% Relative Compation)
- Limits of Existing Crib Wall Removal



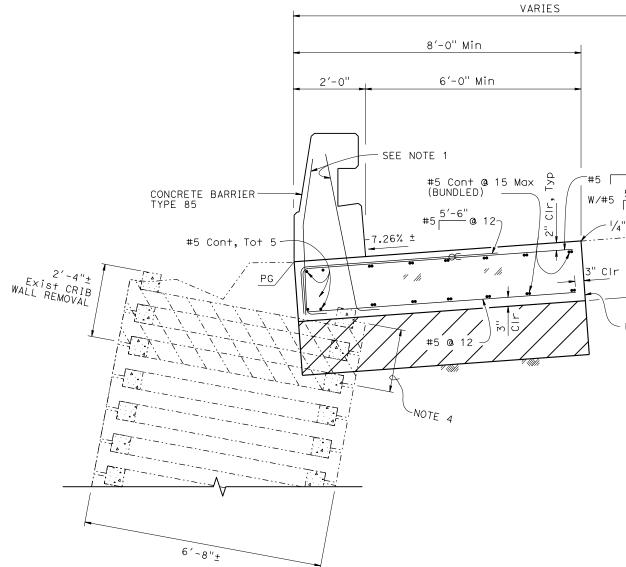



# CONCRETE BARRIER SLAB

**¾**" = 1′−0"


NOTE: THE CONTRACTOR SHALL VERIFY ALL CONTROLLING FIELD DIMENSIONS BEFORE ORDERING OR FABRICATING ANY MATERIAL.

	DESIGN	ву Rene Coria	снескер Minh Tran	STATE OF	DIVISION OF ENGINEERING SERVICES	BRIDGE No.	C	ASTRO CAN	TRO CANYON BRIDGE		
	DETAILS	ву Mohammad Sharif	checked Minh Tran	CALIFORNIA	STRUCTURE DESIGN DESIGN BRANCH <b>18</b>	44-0035 POST MILE				-	
	QUANTITIES	PY.		DEPARTMENT OF TRANSPORTATION	DESIGN BRANCH IO	43.12	ADDITIO	ONAL SLAB	REINFORCEME	MENT	
STRUCTURES DESIGN DETAIL SHEET (ENGLISH) (REVISION 12/13/2019)	DATE PLOTTED = FILE => 44-003		ED => 12:05 ME => s151020 ORIGINAL SCALE IN INCHES FOR REDUCED PLANS		UNIT: 3603 PROJECT NUMBER & PHASE: 0516000081	CONTRACT	No.: 05-1H490	DISREGARD PRINTS BEARING	REVISION DATES SHEE	<i>Е</i> ЕТ ОF 16 17	

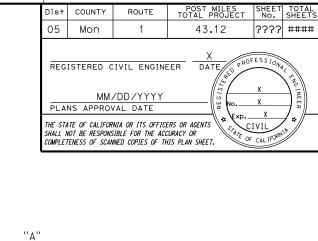

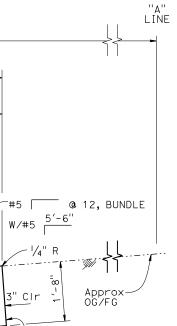

NOTE 3

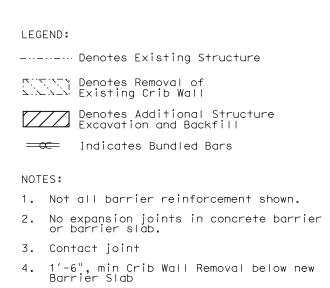

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