Exhibit A



EXHIBIT A DRAFT RESOLUTION

Before the Housing and Community Development Chief of Planning in and for the County of Monterey, State of California

In the matter of the application of:

CTI TOWERS ASSETS I LLC (T-MOBILE) (PLN250267) RESOLUTION NO. 25-063

Resolution by the County of Monterey Chief of Planning:

- 1) Finding that the project qualifies for a Class 1 Categorical Exemption pursuant to CEQA Guidelines Section 15301 and there are no exceptions pursuant to section 15300.2; and
- 1. Approving a Minor and Trivial Amendment to a previously approved Coastal Administrative Permit (PLN010094) for 3 satellite radio antennas to co-locate on an existing tower and install ground equipment within an existing compound. This Amendment is to allow collocation for T-Mobile on the previously approved wireless telecommunications facility, which includes installation of a 25-foot-high tower extension, three antennas, three radios, on an existing tower with three swivel and sector mounts, as well as the installation of ground equipment within an existing compound.

[PLN250267 CTI TOWERS ASSETS I LLC, 4040 Sunset Lane, Pebble Beach, Del Monte Forest Land Use Plan (APN: 008-112-009-000)]

The CTI TOWERS ASSETS I LLC application (PLN250267) came on for an administrative decision hearing before the County of Monterey Chief of Planning on December 3rd, 2025. Having considered all the written and documentary evidence, the administrative record, the staff report, oral testimony, and other evidence presented the County of Monterey Chief of Planning finds and decides as follows:

FINDINGS

1. **FINDING: CONSISTENCY** – The Project, as conditioned, is consistent with the

applicable plans and policies which designate this area as appropriate

for development.

EVIDENCE: a) During the course of review of this application, the project has been reviewed for consistency with the text, policies, and regulations in:

- the 1982 Monterey County General Plan;

- Del Monte Forest Land Use Plan;

- Del Monte Forest Coastal Implementation Plan (DMF CIP); and

- Monterey County Zoning Ordinance (Title 20). No conflicts were found to exist. No communications were received during the course of review of the project indicating any inconsistencies with the text, policies, and regulations in these documents.
- Project Description. On February 21, 2001, the Monterey County HCD-Planning department approved a permit (PLN010094) for a permit consisting of a satellite radio to co-locate on an existing tower. On September 10th, 2025, an application for a Minor and Trivial Amendment was submitted to HCD-Planning staff. The Amendment will allow collocation for T-Mobile on the previously approved wireless telecommunications facility, which includes installation of a 25-foothigh tower extension, three antennas, three radios, on an existing tower with three swivel and sector mounts, as well as the installation of ground equipment within an existing compound. The ground equipment consists of a 15-foot concrete pad, 3 enclosure cabinets including a Hoffman box, 12 batteries, an ice bridge, one GPS antennae, one meter, and underground conduits in joint trench.
- c) Allowed Use. The property is located at 4040 Sunset Lane, Pebble Beach, within the Del Monte Forst Land Use Plan (Assessor's Parcel Number 008-112-009-000). The parcel is zoned Medium Density Residential, 4 acres per unit, with a Design Overlay, or "MDR/4-D(CZ)" which allows for additions to existing approved wireless telecommunication facilities as a principally allowed use pursuant to Title 20 section 20.14.040.R. Therefore, the project is an allowed land use for this site.
- d) Lot Legality. The subject property is located in an American Tower Corporation Site No. 207954, which the owner has granted authorization to T-Mobile to co-locate on a tower ground lease agreement dated October 1st, 2013, between Comcast of California IX Inc., Comcast, and CTI Towers Assets I LLC. The subject property APN:008-112-009-000, is identified in its current configuration as a portion of Lot 9 in Block 204 of Track No. 169 in the Final Map for the City of Pebble Beach, recorded on October 27, 2016 (Volume 5, Page 21). Therefore, the County recognizes the subject property as a legal lot of record.
- e) Design and Visual Resources. The subject area includes a Design Control Overlay, which is intended to regulate the location, size, configuration, materials, and colors of structures and fences to assure the protection of the public viewshed and neighborhood character pursuant to Title 20 Chapter 20.44. The proposed colocation and additions to the existing WCF will utilize the existing utility pole, which is silver metal. The development is surrounded by existing vegetation and will blend with the surrounding environment. Pursuant to Title 20 section 20.64.310.H.1, wireless communication facilities should not be sited to create visual clutter or negatively affect specific views. The proposed development will be sited on an existing utility pole with materials and colors to not create a negative visual effect or visual clutter within the area. DMF LUP Policy 48 indicates that new development within visually prominent settings, shall be sited and designed in such a manner that will not take away the scenic value of

- the area. Although there will be an increase in height from the top of the existing tower from 80 feet to 105 feet, it is still subordinate to the surrounding environment, similar to the existing height of the adjacent vegetation. Therefore, as proposed and designed, the project is consistent with the design control regulations and is subordinate to the surrounding environment.
- f) Cultural Resources. According to Monterey County Geographic Information System (GIS) records identifies the subject property to be within a moderate archaeological sensitivity area and is not within a known or potential archaeological resource area. Therefore, an archaeological report is not required under the DMF CIP section 20.147.080.B.1. There is no evidence that any cultural resources would be disturbed, and the potential for inadvertent impacts to cultural resources is limited. This will be controlled by application of the County's standard project condition (Condition No. 3), which requires the contractor to stop work if previously unidentified resources are discovered during construction.
- g) <u>Wireless Telecommunication Facility.</u> As demonstrated in Finding 6, the project is consistent with the regulations for siting and design of WCF contained in Title 20 Section 20.64.310.
- h) <u>Land Use Advisory Committee (LUAC) Review</u>. Based on the LUAC guidelines, the project was not referred to the Del Monte Forest Advisory Committee (LUAC) for review because it does not involve a public hearing Design Approval, a Lot Line Adjustment, preparation of an Initial study, or a Variance.
- i) The project planner conducted a site inspection on November 25th, 2025, to verify that the project on the subject parcel conforms to the plans listed above.
- j) The application, project plans, and related support materials submitted by the project applicant to County of Monterey HCD-Planning found in Project File PLN250267.

2. FINDING:

SITE SUITABILITY – The site is physically suitable for the proposed development and/or use.

EVIDENCE:

- a) The project has been reviewed for site suitability by the following departments and agencies: HCD-Planning, HCD-Engineering Services, HCD-Environmental Services, Environmental Health Bureau, and Pebble Beach Community Services District. County staff reviewed the application materials and plans to verify that the project on the subject site conforms to the applicable plans and regulations, and there has been no indication from these departments/agencies that the site is not suitable for the development. Conditions recommended have been incorporated.
- b) Staff conducted a site inspection on November 25th, 2025, to verify that the site is suitable for this use.
- c) The application, project plans, and related support materials submitted by the project applicant to County of Monterey HCD-Planning found in Project File PLN250267.

3. FINDING:

HEALTH AND SAFETY – The establishment, maintenance, or operation of the project applied for will not under the circumstances of this particular case be detrimental to the health, safety, peace, morals, comfort, and general welfare of persons residing or working in the neighborhood of such proposed use or be detrimental or injurious to property and improvements in the neighborhood or to the general welfare of the County.

EVIDENCE:

- The project was reviewed by HCD-Planning, HCD- Engineering Services, HCD-Environmental Services, Environmental Health Bureau, and Pebble Beach Community Services District. The respective agencies have recommended conditions, where appropriate, to ensure that the project will not have an adverse effect on the health, safety, and welfare of persons either residing or working in the neighborhood.
- b) Necessary public facilities are available. The existing power pole will continue to provide electricity. The proposed project will not require the use of water or sewer.
- c) Staff conducted a site inspection on November 25th, 2025, to verify that the site is suitable for this use.
- d) The application, project plans, and related support materials submitted by the project applicant to County of Monterey HCD-Planning found in Project File PLN250267.

4. FINDING:

NO VIOLATIONS – The subject property is in compliance with all rules and regulations pertaining to zoning uses, subdivision, and any other applicable provisions of the County's zoning ordinance. No violations exist on the property.

EVIDENCE:

- a) Staff reviewed County of Monterey HCD-Planning and HCD-Building Services records and is not aware of any violations existing on subject property.
- b) Staff conducted a site inspection on November 25th, 2025, and researched County records to assess if any violation exists on the subject property.
- c) The application, project plans, and related support materials submitted by the project applicant to County of Monterey HCD-Planning found in Project File PLN250267.

5. FINDING:

CEQA (Exempt) – The project is categorically exempt from environmental review and no unusual circumstances were identified to exist for the proposed project.

EVIDENCE: a)

- a) California Environmental Quality Act (CEQA) Guidelines section 15301 categorically exempts maintenance or minor alterations of an existing structure.
- b) The Amendment will install a 25-foot-high tower extension, three antennas, three radios, on an existing tower with three swivel and sector mounts, as well as the installation of ground equipment within an existing compound. Due to the installation of equipment being a collocation on an existing facility, being considered a facility used to provide electrical power for public utility services, they qualify for a Class 1 categorical exemption as described in §15301 of the CEQA Guidelines.

- None of the exceptions under CEQA Guidelines Section 15300.2 apply to this project. The project does not involve a designated historical resource, a hazardous waste site, unusual circumstances that would result in a significant effect, or development that would result in a cumulative significant impact. The project site does not contain environmentally sensitive habitat. Additionally, no scenic resources, such as trees, rock outcroppings, and historical buildings, within the scenic highway will be impacted by the proposed project. The development will neither create nor significantly contribute to geologic instability or geologic hazards. There is no substantial evidence that would support a fair argument that the project has a reasonable possibility of having a significant effect on the environment or that it would result in a cumulative significant impact.
- d) No adverse environmental effects were identified during staff review of the development application during a site visit on November 25th, 2025.
- e) See supporting Finding Nos. 1 and 2. The application, project plans, and related support materials submitted by the project applicant to County of Monterey HCD-Planning found in Project File PLN250267.

6. FINDING:

WIRELESS COMMUNICATION FACILITIES – The development of the proposed wireless communications facility will not significantly affect any designated public viewing area, scenic corridor, or any identified environmentally sensitive area or resources. The site is adequate for the proposed development of the wireless communications facility, and the applicant has demonstrated that it is the most adequate for the provision of services as required by the Federal Communications Commission (FCC). The proposed wireless communications facility complies with all applicable requirements of Monterey County Code (MCC) Section 20.64.310. The subject property on which the wireless communication facility is to be built is in compliance with all rules and regulations pertaining to zoning uses, subdivisions, and any other applicable provisions of MCC, and that all zoning violation abatement costs, if any, have been paid. The proposed telecommunication facility will not create a hazard for aircraft in flight.

EVIDENCE: a)

- Pursuant to the requirements in Title 20 section 20.64.310.C.7, co-location on pre-existing wireless communication facilities should be pursued to the maximum extent feasible and are allowed on any lot or parcel in any zoning district subject to the General Development Standards that is encouraged when it will decrease visual impact and discouraged in cases when it will increase visual impact. The proposed addition to the existing WCF tower by T-Mobile does not change the use of the existing CTI Towers Assets transmission tower by installing additional equipment and therefore is subject to a Minor and Trivial Amendment as identified in Title 20 section 20.76.115 as a conditional use for the proposed amendments to any coastal administrative permit issued (see evidence "b" in Finding 1).
- b) <u>Site Location and Analysis</u> Site analysis confirms that the proposed additions to the existing wireless communication facility (WCF) will not substantially alter the visual impact when viewed from Huckleberry Hill or nearby scenic viewpoints, as it is not within the visually sensitive area. The

WCF will continue to match the existing pole's metal finish and blend with its surroundings, consistent with DMF LUP Policy 48.

c) <u>Co-location</u>. Title 20 section 20.64.310(H)(b) encourages co-location of facilities. While the existing pole will be raised in height with minor additions and will not be replaced, this addition will not substantially alter the visual impact of the existing metal tower as it is a co-location, when viewed from Sunset Lane.

Title 20 section 20.64.310 encourages co-location of wireless facilities when possible. Co-location opportunities were analyzed for the proposed project, which is the existing WCF on the subject property is proposed to be used for co-location, meeting the coverage objectives identified in the plan provided. Photographic simulations provided by the applicant illustrate that there is not a significant increase to the visually perceived bulk or height of the existing tower. The project includes a condition to encourage future co-location by other wireless carriers (Condition No. 7).

- d) The project is consistent with Monterey County Code Chapter 20.92, Airport Approach Zoning, and does not require review by the Monterey County Airport Land Use Commission. This project does not affect any aircraft zones identified in Monterey County Code section 20.92.050 and therefore need not comply with the heights outlined in Monterey County Code section 20.92.060. The proposed collocation on an existing telecommunication facility will not create a hazard for airport approaches or departures.
- e) The project does not penetrate a Federal Aviation Regulation (FAR) Part 77 Imaginary Surface. The project site is located approximately 4.3 miles from Monterey Regional Airport, the nearest public use airport. If deemed necessary by the FCC, warning lights would be located on top of the structure to prevent conflict with any aircraft when visibility is limited. The proposed telecommunication facility will not create a hazard for aircraft in flight.
- f) The project planner reviewed the project application materials and plans and the County GIS database to verify that the project on the subject parcel conforms to the plans listed above and that the site is suitable for this use. The application, plans and supporting materials submitted by the project applicant to Monterey County HCD-Planning for the proposed development are found in Project File PLN250267.
- 7. FINDING:

PUBLIC ACCESS – The project is in conformance with the public access and recreation policies of the Coastal Act (specifically Chapter 3 of the Coastal Act of 1976, commencing with Section 30200 of the Public Resources Code) and Local Coastal Program, and does not interfere with any form of historic public use or trust rights.

- **EVIDENCE:** a) No access is required as part of the project as no substantial adverse impact on access, either individually or cumulatively, as described in Section 20.147.130 of the Del Monte Forest Coastal Implementation Plan can be demonstrated.
 - b) The subject property is not described as an area where the Local Coastal Program requires public access (Figure 8 in the Del Monte Forest Coastal Land Use Plan).
 - c) No evidence or documentation has been submitted or found showing the existence of historic public use or trust rights over this property.
 - d) The application, plans and supporting materials submitted by the project applicant to County of Monterey HCD-Planning for the proposed development are found in Project File PLN250267.
 - e) The project planner conducted a site inspection on November 25th, 2025.
- **8. FINDING: APPEALABILITY** The decision on this project may be appealed to the Board of Supervisors and the California Coastal Commission.
 - **EVIDENCE:** a) Board of Supervisors. In accordance with Title 20 Section 20.86.030, an appeal may be made to the Board of Supervisors by any public agency or person aggrieved by a decision of an Appropriate Authority other than the Board of Supervisors.
 - b) <u>California Coastal Commission.</u> In accordance with Title 20 Section 20.86.080.A, this project is appealable to the California Coastal Commission as it is between the sea and the first through public road paralleling the sea. For the Del Monte Forest, this would be Highway 68.

DECISION

NOW, THEREFORE, based on the above findings and evidence, the HCD Chief of Planning does hereby:

- 1. Find the project qualifies for a Class 1 Categorical Exemption pursuant to CEQA Guidelines Section 15301;
- 2. Approve the Minor and Trivial Amendment to a previously approved Coastal Administrative Permit (PLN010094) for 3 satelline radio antennas to co-locate on an existing tower and install ground equipment within an existing compound. This Amendment is to allow collocation for T-Mobile on the previously approved wireless telecommunications facility, which includes installation of a 25-foot-high tower extension, three antennas, three radios, on an existing tower with three swivel and sector mounts, as well as the installation of ground equipment within an existing compound.

All of which are in general conformance with the attached sketch and subject to the attached conditions, all being attached hereto and incorporated herein by reference.

PASSED AND ADOPTED this 3rd day of December 2025.

Melanie Beretti, AICP
HCD Chief of Planning

COPY OF THIS DECISION MAILED TO APPLICANT ON DATE

THIS APPLICATION IS APPEALABLE TO THE PLANNING COMMISSION.

IF ANYONE WISHES TO APPEAL THIS DECISION, AN APPEAL FORM MUST BE COMPLETED AND SUBMITTED TO THE SECRETARY OF THE PLANNING ALONG WITH THE APPROPRIATE FILING FEE ON OR BEFORE ______.

This decision, if this is the final administrative decision, is subject to judicial review pursuant to California Code of Civil Procedure Sections 1094.5 and 1094.6. Any Petition for Writ of Mandate must be filed with the Court no later than the 90th day following the date on which this decision becomes final.

NOTES

1. You will need a building permit and must comply with the Monterey County Building Ordinance in every respect.

Additionally, the Zoning Ordinance provides that no building permit shall be issued, nor any use conducted, otherwise than in accordance with the conditions and terms of the permit granted or until ten days after the mailing of notice of the granting of the permit by the appropriate authority, or after granting of the permit by the Board of Supervisors in the event of appeal.

Do not start any construction or occupy any building until you have obtained the necessary permits and use clearances from Monterey County HCD-Planning and HCD-Building Services Department office in Salinas.

2. This permit expires 3 years after the above date of granting thereof unless construction or use is started within this period.

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County of Monterey HCD Planning

DRAFT Conditions of Approval/Implementation Plan/Mitigation Monitoring and Reporting Plan

PLN250267

1. PD001 - SPECIFIC USES ONLY

Responsible Department:

Planning

Condition/Mitigation
Monitoring Measure:

This Minor and Trivial Amendment (PLN250267) to a previously approved Coastal Administrative Permit (PLN010094) allows for 3 satelline radio antennas to co-locate on an existing tower and install ground equipment within an existing compound. This Amendment is to allow collocation for T-Mobile on the previously approved wireless facility, which includes installation of 25-foot-high telecommunications а extension, three antennas, three radios, on an existing tower with three swivel and sector mounts, as well as the installation of ground equipment within an existing compound. The property is located at 4040 Sunset Lane, Pebble Beach (Assessor's Parcel Number 008-112-009-000), Del Monte Forest Land Use Plan. This permit was approved in accordance with County ordinances and land use regulations subject to the terms and conditions described in the project file. Neither the uses nor the construction allowed by this permit shall commence unless and until all of the conditions of this permit are met to the satisfaction of the Director of HCD - Planning. Any use or construction not in substantial conformance with the terms and conditions of this permit is a violation of County regulations and may result in modification or revocation of this permit and subsequent legal action. No use or construction other than that specified by this permit is allowed unless additional permits are approved by the appropriate authorities. To the extent that the County has delegated any condition compliance or mitigation monitoring to the Monterey County Water Resources Agency, the Water Resources Agency shall provide all information requested by the County and the County shall bear ultimate responsibility to ensure that conditions and mitigation measures are properly fulfilled. (HCD - Planning)

Compliance or Monitoring Action to be Performed:

The Owner/Applicant shall adhere to conditions and uses specified in the permit on an on-going basis unless otherwise stated.

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2. PD002 - NOTICE PERMIT APPROVAL

Responsible Department:

Planning

Condition/Mitigation Monitoring Measure:

The applicant shall record a Permit Approval Notice. This notice shall state:

"A Minor and Trivial Amendment (Resolution Number ______) was approved by the Chief of Planning for Assessor's Parcel Number 008-112-009-000 on December 3rd, 2025. The permit was granted subject to 8 conditions of approval which run with the land. A copy of the permit is on file with Monterey County HCD - Planning."

Proof of recordation of this notice shall be furnished to the Director of HCD - Planning prior to issuance of grading and building permits, Certificates of Compliance, or commencement of use, whichever occurs first and as applicable. (HCD - Planning)

Compliance or Monitoring Action to be Performed:

Prior to the issuance of grading and building permits, certificates of compliance, or commencement of use, whichever occurs first and as applicable, the Owner/Applicant shall provide proof of recordation of this notice to the HCD - Planning.

3. PD003(A) - CULTURAL RESOURCES NEGATIVE ARCHAEOLOGICAL REPORT

Responsible Department:

Planning

Condition/Mitigation Monitoring Measure:

archaeological, during the course of construction, cultural, historical paleontological resources are uncovered at the site (surface or subsurface resources) work shall be halted immediately within 50 meters (165 feet) of the find until a qualified professional archaeologist can evaluate it. Monterey County HCD - Planning and a archaeologist archaeologist registered qualified (i.e., an with the Register Professional Archaeologists) immediately shall be contacted by the responsible individual present on-site. When contacted, the project planner and the archaeologist shall immediately visit the site to determine the extent of the resources and to develop proper mitigation measures required for recovery. (HCD - Planning)

Compliance or Monitoring Action to be Performed:

The Owner/Applicant shall adhere to this condition on an on-going basis.

Prior to the issuance of grading or building permits and/or prior to the recordation of the final/parcel map, whichever occurs first, the Owner/Applicant shall include requirements of this condition as a note on all grading and building plans. The note shall state "Stop work within 50 meters (165 feet) of uncovered resource and contact Monterey County HCD - Planning and a qualified archaeologist immediately if cultural, archaeological, historical or paleontological resources are uncovered."

When contacted, the project planner and the archaeologist shall immediately visit the site to determine the extent of the resources and to develop proper mitigation measures required for the discovery.

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4. EHSP01 - HAZARDOUS MATERIALS BUSINESS PLAN (Non-Standard)

Responsible Department: Health Department

Condition/Mitigation Monitoring Measure:

The facility is anticipated to store hazardous materials in excess of threshold quantities that require registration with the California Environmental Protection Agency's California Environmental Reporting System (CERS) and an up-to-date Hazardous Materials Business Plan that meets the standards found in the California Code of Regulations, Title 19, Division 2, Chapter 4 (Hazardous Material Release Reporting, Inventory, and Response Plans) and the California Health and Safety Code, Division 20, Chapter 6.95 (Hazardous Material Release Response Plans and Inventory), and the Monterey County Code Chapter 10.65.

Compliance or Monitoring Action to be Performed: Prior to issuance of construction permit, the owner/applicant shall submit a completed Business Plan – Memorandum of Understanding (form available from EHB) that specifies the facility will be registered with CERS and that a Hazardous Materials Business Plan must be on file prior to bringing hazardous materials on site and/or commencement of operations.

5. PD039(B) - WIRELESS REDUCE VISUAL IMPACTS

Responsible Department: Planning

Condition/Mitigation Monitoring Measure:

The applicant shall agree in writing that if future technological advances allow for reducing the visual impacts of the telecommunication facility, the applicant shall make modifications to the facility accordingly to reduce the visual impact as part of the facility's normal replacement schedule. (HCD - Planning)

Compliance or Monitoring Action to be Performed: Prior to the issuance of grading or building permits, the Owner/Applicant shall submit, in writing, a declaration agreeing to comply with the terms of this condition HCD - Planning for review and approval.

6. PD039(C) - WIRELESS CO-LOCATION

Responsible Department: Planning

Condition/Mitigation Monitoring Measure:

applicant and/or successors assigns shall encourage co-location wireless carriers on this tower assuming appropriate permits are approved Any expansion or additions of microwave dishes, antennas and/or similar appurtenances located on the monopole, which are not approved pursuant to this permit, are not allowed unless the appropriate authority approves additional permits or In any case, the overall height of the pole shall not exceed the specified height. (HCD - Planning)

Compliance or Monitoring Action to be Performed:

On an on-going basis, the Owner/Applicant shall encourage co-location by other wireless carriers on this tower assuming appropriate permits are approved for co-location. The overall height of the pole shall not exceed the approved height in accordance with the attached plans.

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7. PD039(D) - WIRELESS REMOVAL

Responsible Department:

Planning

Condition/Mitigation Monitoring Measure:

If the applicant abandons the facility or terminates the use, the applicant shall remove the monopole, panel antennas, and equipment shelter. Upon such termination or abandonment, the applicant shall enter into a site restoration agreement subject to the approval of the Director of HCD - Planning and County Counsel. The site shall be restored to its natural state within six (6) months of the termination of use or abandonment of the site.

(HCD - Planning)

Compliance or Monitoring Action to be Performed:

Prior to abandoning the facility or terminating the use, the Owner/Applicant shall submit a site restoration agreement to HCD - Planning subject to the approval of the HCD - Director of Planning and County Counsel.

Within 6 months of termination of use or abandonment of the site, the Owner Applicant shall restore the site to its natural state.

8. PD039(E) - WIRELESS EMISSION

Responsible Department:

Planning

Condition/Mitigation Monitoring Measure:


The facility must comply with Federal Communications Commission (FCC) emission standards. If the facility is in violation of FCC emission standards, the Director of HCD - Planning shall set a public hearing before the Appropriate Authority whereupon the appropriate authority may, upon a finding based on substantial evidence that the facility is in violation of the then existing FCC emission standards, revoke the permit or modify the conditions of the permit. (HCD - Planning)

Compliance or Monitoring Action to be Performed:

Prior to commencement of use and on an on-going basis, the Owner/Applicant shall submit documentation demonstrating compliance with the FCC emission standards to the Director of HCD-Planning for review and approval.

On an on-going basis, if the facility is in violation of FCC emission standards, the Director of HCD-Planning shall set a public hearing before the Appropriate Authority to consider revocation or modification of the permit.

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COMPLIANCE CODE

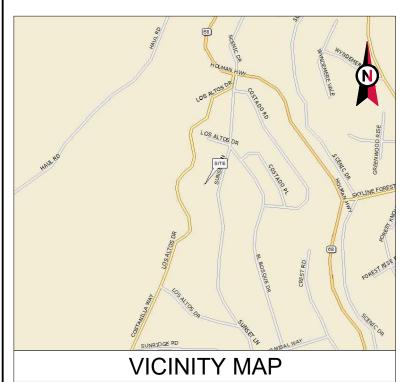

ATC SITE NAME: PEBBLE BEACH

ATC SITE NUMBER: 207954

PROJECT SUMMARY

T-MOBILE SITE NAME: ATC: PEBBLE BEACH

T-MOBILE SITE NUMBER: SF95723A SITE ADDRESS: 4040 SUNSET LN

DEL MONTE FOREST, CA 93953



LOCATION MAP

SHEET INDEX

T-MOBILE REPLACEMENT COLLOCATION PLAN 67E59998E_1xAIR+1OP_(EXCAL) CONFIGURATION

PROJECT DESCRIPTION

ALL WORK SHALL BE PERFORMED AND MATERIALS INSTALLED IN ACCORDANCE WITH THE CURRENT EDITIONS OF THE	SITE	E ADDRESS:	THE PROPOSED PROJECT INCLUDES MODIFYING GROUND BASED AND TOWER MOUNTED EQUIPMENT AS INDICATED PER BELOW:	SHEET NO:	DESCRIPTION:	REV:	DATE:	BY:	Ш
FOLLOWING CODES AS ADOPTED BY THE LOCAL GOVERNMENT AUTHORITIES. NOTHING IN THESE PLANS IS	4040	SUNSET LN	TOWER WORK:	G-001	TITLE SHEET	0	04/07/25	SRZ	1 F
TO BE CONSTRUED TO PERMIT WORK NOT CONFORMING TO	DEL MONTE	FOREST, CA 93953	INSTALL (3) VFA8-NPNH SECTOR MOUNT(S), (3) RRU DUAL SWIVEL	G-002	GENERAL NOTES	0	04/07/25	SRZ	$\ \cdot\ $
THESE CODES.	COUNT	Y: MONTEREY	MOUNT(S), (3) AIR 6419 B41 ANTENNA(S), (3) APXVAALL24M-U-J20 ANTENNA(S), (3) RADIO 4480 B71+B85A RRU(s), (3) RADIO 4460			-			$\{ \mid \mid$
2022 CALIFORNIA ADMINISTRATIVE CODE COORDINATE OF THE PROPERTY OF THE	GEOGRAPI	HIC COORDINATES:	B25+B66 RRU(s), (9) PIPE MOUNT(S), (9) CROSSOVER PLATE KIT(S), AND (2) 6/24 4AWG (2.00" / 50.8mm) HYBRID TRUNK(S)	C-001	OVERALL SITE PLAN	0	04/07/25	SRZ	11
2. 2022 CALIFORNIA BUILDING CODE 3. 2022 CALIFORNIA RESIDENTIAL CODE	LATIT	UDE: 36.58617	(LENGTH: ± 70m).	C-101	DETAILED SITE PLAN	0	04/07/25	SRZ	Ш
4. 2022 CALIFORNIA ELECTRICAL CODE	LONGIT	UDE: -121.92296	PROPOSED TOWER EXTENSION TO BE PERMITTED AND INSTALLED	C-102	DETAILED EQUIPMENT LAYOUT	0	04/07/25	SRZ	Ш
2022 CALIFORNIA PLUMBING CODE 2022 CALIFORNIA ENERGY CODE	GROUND EL	EVATION: 785' AMSL	BY OTHERS.	C-201	TOWER ELEVATION	0	04/07/25	SRZ	
7. 2022 CALIFORNIA FIRE CODE 8. 2022 CALIFORNIA EXISTING BUILDING CODE	ZONING	INFORMATION:	GROUND WORK: INSTALL (1) 10' X 15' CONCRETE PAD(S), (1) ENCLOSURE 6160 V2 AC	C-401	ANTENNA INFORMATION & SCHEDULE	0	04/07/25	SRZ	Ш
9. 2021 INTERNATIONAL BUILDING CODE (IBC) 10. LOCAL BUILDING CODE	JURISDICTION	: MONTEREY COUNTY	CABINET(S), (1) ENCLOSURE B160 CABINET(S), (12) NORTHSTAR NSB 190FT BATTER(IES), (2) H-FRAME(S), (1) 200A PPC(s), (1) HOFFMAN	C-501	CONSTRUCTION DETAILS	0	04/07/25	SRZ	
11. CITY/COUNTY ORDINANCES	PARCEL	ID: 008112009000	BOX(ES), (1) ICE BRIDGE(S), (1) GPS ANTENNA(S), (1) METER(S), (1) DISCONNECT(S), (2) RP 6651(s), (1) CSR IXRE V2(s), (1) LED	C-502	CONSTRUCTION DETAILS	0	04/07/25	SRZ	Ш
			LUMINARE(s), AND UNDERGROUND CONDUIT(S) IN JOINT TRENCH.	C-503	CONSTRUCTION DETAILS	0	04/07/25	SRZ	ΙL
PROJECT LOCATION DIRECTIONS	PROJ	ECT TEAM		C-504	CONSTRUCTION DETAILS	0	04/07/25	SRZ	Ш
TROUEST ESOMMON BIRESTIONS	TOWER OWNER:	APPLICANT:		E-101	GROUNDING DETAILS & ELECTRICAL SCHEMATIC	0	04/07/25	SRZ	Ш
DIRECTION FORM LOCAL T-MOBILE OFFICE (1755 CREEKSIDE OAKS DR#190 SACRAMENTO, CA 95833): GET ON I-80 W FROM	AMERICAN TOWER 10 PRESIDENTIAL WAY	T-MOBILE 1200 CONCORD AVENUE, SUITE 500	RFDS VERSION: 1 PROJECT TYPE: REPLACEMENT	E-501	GROUNDING DETAILS	0	04/07/25	SRZ	Ш
GATEWAY PARK BLVD AND TRUXEL RD AND CONTINUE ON I-80 W. TAKE I-680 S AND US-101 S TO 17 MILE DR IN	WOBURN, MA 01801	CONCORD, CA 94520	APPROVED: 10/16/2024 10:17:44 AM	E-601	PANEL SCHEDULE & ONE-LINE DIAGRAM	0	04/07/25	SRZ	11
MONTEREY. TAKE EXIT 399A FROM CA-1 S AND TAKE SUNRIDGE RD TO SUNSET LN IN DEL MONTE FOREST.	ENGINEER:	T-MOBILE NSD PM:	PROJECT NOTES	R-601 - R-610	SUPPLEMENTAL				[
UTILITY COMPANIES	TEP 326 TRYON ROAD	VANESSA MEYER CROOKS VANESSA.MEYERCROOKS1	THE FACILITY IS UNMANNED. A TECHNICIAN WILL VISIT THE SITE APPROXIMATELY ONCE A						1
UTILITY COMPANIES	RALEIGH, NC 27603-3530	@T-MOBILE.COM	MONTH FOR ROUTINE INSPECTION AND MAINTENANCE. 3. THE PROJECT WILL NOT RESULT IN ANY SIGNIFICANT LAND						
POWER COMPANY: PACIFIC GAS & ELECTRIC PHONE: (800) 743-5000	PLANNING APPLICANT:	PROPERTY OWNER:	THE PROJECT WILL NOT RESULT IN ANY SIGNIFICANT LAND DISTURBANCE OR EFFECT OF STORM WATER DRAINAGE. NO SANITARY SEWER. POTABLE WATER OR TRASH DISPOSAL					+	1
TELEPHONE COMPANY: VERIZON PHONE: (800) 922-0204	DERNA GROUP RACHEL BRUIN	CTI TOWER ASSETS I LLC 38 POND ST UNIT 305	NO SAMITARY SEWER, POTABLE WATER OR TRASH DISPOSAL IS REQUIRED. HANDICAP ACCESS IS NOT REQUIRED. THE PROJECT DEPICTED IN THESE PLANS QUALIFIES AS AN						
Know what a below. Call before you dig.	RBRUIN@DERNAGRP.COM	FRANKLIN, MA 02038	REVIEW UNDER 47 U.S.C. § 1455(A) AS A MODIFICATION OF AN EXISTING WIRELESS TOWER THAT INVOLVES THE COLLOCATION, REMOVAL, AND/OR REPLACEMENT OF TRANSMISSION EQUIPMENT THAT IS NOT A SUBSTANTIAL CHANGE UNDER CFR § 1.61000 (B)(7).						



PLANS PREPARED BY:



326 TRYON ROAD RALEIGH, NC 27603-3530 OFFICE: (919) 661-6351 www.tepgroup.net

TEP IS A FAMILY OF COMPANIES LICENSED TO PROVIDE DIFFERENT SERVICES IN DIFFERENT JURISDICTIONS. DEPENDING ON THE JURISDICTION, PROFESSIONAL INFERENCE AND LAND SURVEYING SERVICES ARE PROVIDED BY TEP OPCO. LC, A DELWAMSE LUMITED LIABILITY COMPANY. THE PENGINEERING, LLC, A NORTH CAPOLINA PROFESSIONAL LIMITED LIABILITY COMPANY. OR MAH ENGINEERING, LC, A NEW YORK PROFESSIONAL LIMITED LIABILITY COMPANY. GRAPH OF COMPANY. GENERAL CONTRACTOR SERVICES ARE PROVIDED BY TEP OPCO LLC, A DELWAMSE IMITED LIABILITY COMPANY. WE ACQUIRE THE REQUISITE LICENSESS IN EACH

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ATC SITE NUMBER: 207954

ATC SITE NAME:

PEBBLE BEACH

T-MOBILE SITE NAME:

ATC: PEBBLE BEACH

SITE ADDRESS: 4040 SUNSET LN DEL MONTE FOREST, CA 93953

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04/07

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DATE DRAWN:	04/07/25
ATC JOB NO:	14921636
CUSTOMER NAME:	ATC: PEBBLE BEACH
CUSTOMER ID:	SF95723A

TITLE SHEET

SHEET NUMBER:

G-001

GENERAL CONSTRUCTION NOTES:

- OWNER FURNISHED MATERIALS, T-MOBILE "THE COMPANY" WILL PROVIDE AND THE CONTRACTOR WILL INSTALL
- A. BTS EQUIPMENT FRAME (PLATFORM) AND ICEBRIDGE SHELTER (GROUND
- BUILD/CO-LOCATE ONLY) AC/TELCO INTERFACE BOX (PPC)
- ICE BRIDGE (CABLE TRAY WITH COVER) (GROUND BUILD/CO-LOCATE ONLY, GC TO FURNISH AND INSTALL FOR ROOFTOP INSTALLATION)
- D. TOWERS, MONOPOLES
- TOWER LIGHTING
- GENERATORS & LIQUID PROPANE TANK
- G. ANTENNA STANDARD BRACKETS, FRAMES AND PIPES FOR MOUNTING
- ANTENNAS (INSTALLED BY OTHERS)
- TRANSMISSION LINE
- TRANSMISSION LINE JUMPERS
- TRANSMISSION LINE CONNECTORS WITH WEATHERPROOFING KITS
- TRANSMISSION LINE GROUND KITS
- HANGERS
- HOISTING GRIPS
- O. BTS EQUIPMENT
- THE CONTRACTOR IS RESPONSIBLE TO PROVIDE ALL OTHER MATERIALS FOR THE COMPLETE INSTALLATION OF THE SITE INCLUDING, BUT NOT LIMITED TO, SUCH MATERIALS AS FENCING, STRUCTURAL STEEL SUPPORTING SUB-FRAME FOR PLATFORM, ROOFING LABOR AND MATERIALS GROUNDING RINGS GROUNDING WIRES COPPER-CLAD OR XIT CHEMICAL GROUND ROD(S), BUSS BARS, TRANSFORMERS AND DISCONNECT SWITCHES WHERE APPLICABLE, TEMPORARY ELECTRICAL POWER CONDUIT, LANDSCAPING COMPOUND STONE, CRANES, CORE DRILLING, SLEEPERS AND RUBBER MATTING, REBAR, CONCRETE CAISSONS, PADS AND/OR AUGER MOUNTS, MISCELLANEOUS FASTENERS, CABLE TRAYS, NON-STANDARD ANTENNA FRAMES AND ALL OTHER MATERIAL AND LABOR REQUIRED TO COMPLETE THE JOB ACCORDING TO THE DRAWINGS AND SPECIFICATIONS. IT IS THE POSITION OF T-MOBILE TO APPLY FOR PERMITTING AND CONTRACTOR RESPONSIBLE FOR PICKUP AND PAYMENT OF REQUIRED
- ALL WORK SHALL CONFORM TO ALL CURRENT APPLICABLE FEDERAL, STATE, AND LOCAL CODES, INCLUDING ANSI/EIA/TIA-222, AND COMPLY WITH ATC CONSTRUCTION **SPECIFICATIONS**
- CONTRACTOR SHALL CONTACT LOCAL 811 FOR IDENTIFICATION OF UNDERGROUND UTILITIES PRIOR TO START OF CONSTRUCTION.
- CONTRACTOR SHALL BE RESPONSIBLE FOR COORDINATING ALL REQUIRED INSPECTIONS.
- ALL DIMENSIONS TO, OF, AND ON EXISTING BUILDINGS, DRAINAGE STRUCTURES, AND SITE IMPROVEMENTS SHALL BE VERIFIED IN FIELD BY CONTRACTOR WITH ALL DISCREPANCIES REPORTED TO THE ENGINEER.
- DO NOT CHANGE SIZE OR SPACING OF STRUCTURAL ELEMENTS
- DETAILS SHOWN ARE TYPICAL: SIMILAR DETAILS APPLY TO SIMILAR CONDITIONS UNLESS
- THESE DRAWINGS DO NOT INCLUDE NECESSARY COMPONENTS FOR CONSTRUCTION SAFETY WHICH SHALL BE THE SOLE RESPONSIBILITY OF THE CONTRACTOR
- CONTRACTOR SHALL BRACE STRUCTURES UNTIL ALL STRUCTURAL ELEMENTS NEEDED FOR STABILITY ARE INSTALLED. THESE ELEMENTS ARE AS FOLLOWS: LATERAL BRACING,
- CONTRACTOR SHALL DETERMINE EXACT LOCATION OF EXISTING UTILITIES, GROUNDS DRAINS, DRAIN PIPES, VENTS, ETC, BEFORE COMMENCING WORK,
- INCORRECTLY FABRICATED, DAMAGED, OR OTHERWISE MISFITTING OR NONCONFORMING MATERIALS OR CONDITIONS SHALL BE REPORTED TO THE T-MOBILE REP PRIOR TO REMEDIAL OR CORRECTIVE ACTION, ANY SUCH REMEDIAL ACTION SHALL REQUIRE WRITTEN APPROVAL BY THE T-MOBILE REP PRIOR TO PROCEEDING.
- EACH CONTRACTOR SHALL COOPERATE WITH THE T-MOBILE REP, AND COORDINATE HIS WORK WITH THE WORK OF OTHERS.
- CONTRACTOR SHALL REPAIR ANY DAMAGE CAUSED BY CONSTRUCTION OF THIS PROJECT TO MATCH EXISTING PRE-CONSTRUCTION CONDITIONS TO THE SATISFACTION
- ALL CABLE/CONDUIT ENTRY/EXIT PORTS SHALL BE WEATHERPROOFED DURING 15. INSTALLATION LISING A SILICONE SEALANT
- WHERE EXISTING CONDITIONS DO NOT MATCH THOSE SHOWN IN THIS PLAN SET. CONTRACTOR SHALL NOTIFY THE T-MOBILE REP AND ENGINEER OF RECORD
- CONTRACTOR SHALL ENSURE ALL SUBCONTRACTORS ARE PROVIDED WITH A COMPLETE C. ASTM A-500, GRADE B HSS SECTION (SQUARE, RECTANGULAR, AND ROUND) AND CURRENT SET OF DRAWINGS AND SPECIFICATIONS FOR THIS PROJECT.
- CONTRACTOR SHALL REMOVE ALL RUBBISH AND DEBRIS FROM THE SITE AT THE END OF **EACH DAY**
- CONTRACTOR SHALL COORDINATE WORK SCHEDULE WITH AMERICAN TOWER CORPORATION (ATC) AND TAKE PRECAUTIONS TO MINIMIZE IMPACT AND DISRUPTION OF OTHER OCCUPANTS OF THE FACILITY.
- CONTRACTOR SHALL FURNISH T-MOBILE AND AMERICAN TOWER CORPORATION (ATC) WITH A PDF MARKED UP AS-BUILT SET OF DRAWINGS UPON COMPLETION OF WOR
- PRIOR TO SUBMISSION OF BID CONTRACTOR SHALL COORDINATE WITH T-MOBILE REP. TO DETERMINE WHAT, IF ANY, ITEMS WILL BE PROVIDED. ALL ITEMS NOT PROVIDED SHALL BE PROVIDED AND INSTALLED BY THE CONTRACTOR. CONTRACTOR WILL INSTALL

- 22. PRIOR TO SUBMISSION OF BID, CONTRACTOR SHALL COORDINATE WITH T-MOBIL F REP DETAILED ON STRUCTURAL DRAWINGS. TO DETERMINE IF ANY PERMITS WILL BE OBTAINED BY CONTRACTOR. ALL REQUIRED PERMITS NOT OBTAINED BY T-MOBILE MUST BE OBTAINED, AND PAID FOR, BY THE CONTRACTOR,
- 23. CONTRACTOR SHALL INSTALL ALL SITE SIGNAGE IN ACCORDANCE WITH T-MOBILE
- CONTRACTOR SHALL SUBMIT ALL SHOP DRAWINGS TO T-MOBILE FOR REVIEW AND APPROVAL PRIOR TO FABRICATION.
- ALL EQUIPMENT SHALL BE INSTALLED ACCORDING TO MANUFACTURER'S SPECIFICATIONS AND LOCATED ACCORDING TO T-MOBILE SPECIFICATIONS, AND AS SHOWN IN
- THE CONTRACTOR SHALL SUPERVISE AND DIRECT THE PROJECT DESCRIBED HEREIN THE CONTRACTOR SHALL BE SOLELY RESPONSIBLE FOR ALL THE CONSTRUCTION MEANS, METHODS, TECHNIQUES, SEQUENCES AND PROCEDURES AND FOR COORDINATING ALL PORTIONS OF THE WORK UNDER THE CONTRACT
- 27. CONTRACTOR SHALL NOTIFY T-MOBILE REP A MINIMUM OF 48 HOURS IN ADVANCE OF POURING CONCRETE OR BACKFILLING ANY UNDERGROUND UTILITIES, FOUNDATIONS OR SEALING ANY WALL, FLOOR OR ROOF PENETRATIONS FOR ENGINEERING REVIEW AND
- 28 WHEN THE PROJECT SCOPE REQUIRES THE USE OF THE SAFETY CLIMB. THE GENERAL CONTRACTOR SHALL ENSURE THE SAFETY CLIMB IS FREE OF OBSTRUCTIONS, NOT RUBBING ON OR TRAPPED BY ANY INSTALLED CUSTOMER EQUIPMENT, IS VISUALLY TAUT, MEETS MANUFACTURER INSTALLATION SPECIFICATIONS, AND IS FIRMLY SECURED AT ALL CABLE GUIDE LOCATIONS UPON PROJECT COMPLETION.
- COMPLETION OF PROJECT SHALL NOT OBSTRUCT, TRAP, LOOSEN, OR OTHERWISE CAUSE FAILURE TO MEET MANUFACTURER INSTALLATION REQUIREMENTS FOR THE SAFETY CLIMB
- CONTRACTOR SHALL BE RESPONSIBLE FOR SITE SAFETY INCLUDING COMPLIANCE WITH ALL APPLICABLE OSHA STANDARDS AND RECOMMENDATIONS AND SHALL PROVIDE ALL NECESSARY SAFETY DEVICES INCLUDING PPE AND PPM AND CONSTRUCTION DEVICES SUCH AS WELDING AND FIRE PREVENTION, TEMPORARY SHORING, SCAFFOLDING, TRENCH BOXES/SLOPING, BARRIERS, ETC.
- THE CONTRACTOR SHALL PROTECT AT HIS OWN EXPENSE, ALL EXISTING FACILITIES AND ANTENNA INSTALLATION NOTES: SUCH OF HIS NEW WORK LIABLE TO INJURY DURING THE CONSTRUCTION PERIOD. ANY DAMAGE CAUSED BY NEGLECT ON THE PART OF THIS CONTRACTOR OR HIS REPRESENTATIVES OR BY THE FLEMENTS DUE TO NEGLECT ON THE PART OF THIS CONTRACTOR OR HIS REPRESENTATIVES, EITHER TO THE EXISTING WORK, OR TO HIS WORK OR THE WORK OF ANY OTHER CONTRACTOR, SHALL BE REPAIRED AT HIS EXPENSE TO THE OWNER'S SATISFACTION.
- ALL WORK SHALL BE INSTALLED IN A FIRST CLASS. NEAT AND WORKMANLIKE MANNER BY MECHANICS SKILLED IN THE TRADE INVOLVED. THE QUALITY OF WORKMANSHIP SHALL BE SUBJECT TO THE APPROVAL OF THE T-MOBILE REP. ANY WORK FOUND BY THE T-MOBILE REP. TO BE OF INFERIOR QUALITY AND/OR WORKMANSHIP SHALL BE REPLACED AND/OR REWORKED
- IN ORDER TO ESTABLISH STANDARDS OF QUALITY AND PERFORMANCE, ALL TYPES OF MATERIALS LISTED HEREINAFTER BY MANUFACTURER'S NAMES AND/OR MANUFACTURER'S CATALOG NUMBER SHALL BE PROVIDED BY THESE MANUFACTURERS AS SPECIFIED.
- T-MOBILE FURNISHED EQUIPMENT SHALL BE PICKED-UP AT THE T-MOBILE WAREHOUSE, NO LATER THAN 48HR AFTER BEING NOTIFIED INSURED. STORED, UNCRATE, PROTECTED AND INSTALLED BY THE CONTRACTOR WITH ALL APPLIETENANCES REQUIRED TO PLACE THE EQUIPMENT IN OPERATION, READY FOR USE. THE CONTRACTOR SHALL BE RESPONSIBLE FOR THE EQUIPMENT AFTER PICKING IT UP
- T-MOBILE OR HIS ARCHITECT/ENGINEER RESERVES THE RIGHT TO REJECT ANY EQUIPMENT OR MATERIALS WHICH, IN HIS OWN OPINION ARE NOT IN COMPLIANCE WITH THE CONTRACT DOCUMENTS, EITHER BEFORE OR AFTER INSTALLATION AND THE EQUIPMENT SHALL BE REPLACED WITH EQUIPMENT CONFORMING TO THE REQUIREMENTS OF THE CONTRACT DOCUMENTS BY THE CONTRACTOR AT NO COST TO T-MOBILE OR THEIR

STRUCTURAL STEEL NOTES:

- STRUCTURAL STEEL SHALL CONFORM TO THE LATEST EDITION OF THE AISC SPECIFICATION FOR THE DESIGN, FABRICATION AND ERECTION OF STRUCTURAL STEEL FOR
- STRUCTURAL STEEL ROLLED SHAPES, PLATES AND BARS SHALL CONFORM TO THE FOLLOWING ASTM DESIGNATIONS
- A. ASTM A-572, GRADE 50 ALL W SHAPES, UNLESS NOTED OR A992 OTHERWISE
- ASTM A-36 ALL OTHER ROLLED SHAPES, PLATES AND BARS UNLESS NOTED
- ASTM A-325, TYPE SC OR N ALL BOLTS FOR CONNECTING STRUCTURAL MEMBERS
- E. ASTM F-1554 07 ALL ANCHOR BOLTS, UNLESS NOTED OTHERWISE
- ALL EXPOSED STRUCTURAL STEEL MEMBERS SHALL BE HOT-DIPPED GALVANIZED AFTER FABRICATION PER ASTM A123. EXPOSED STEEL HARDWARE AND ANCHOR BOLTS SHALL BE GALVANIZED PER ASTM A153 OR B695.
- ALL FIELD CUT SURFACES. FIELD DRILLED HOLES AND GROUND SURFACES WHERE EXISTING PAINT OR GALVANIZATION REMOVAL WAS REQUIRED SHALL BE REPAIRED WITH (2) BRUSHED COATS OF ZRC GALVILITE COLD GALVANIZING COMPOUND PER ASTM A780 AND MANUFACTURER'S RECOMMENDATIONS
- 5 DO NOT DRILL HOLES THROUGH STRUCTURAL STEEL MEMBERS EXCEPT AS SHOWN AND

- 6 CONNECTIONS:
- A. ALL WELDING TO BE PERFORMED BY AWS CERTIFIED WELDERS AND CONDUCTED IN ACCORDANCE WITH THE LATEST EDITION OF THE AWS WELDING CODE D1.1
- ALL WELDS SHALL BE INSPECTED VISUALLY. 25% OF WELDS SHALL BE INSPECTED WITH DYE PENETRANT OR MAGNETIC PARTICLE TO MEET THE ACCEPTANCE CRITERIA OF AWS D1.1. REPAIR ALL WELDS AS NECESSARY
- C. INSPECTION SHALL BE PERFORMED BY AN AWS CERTIFIED WELD INSPECTOR.
- IT IS THE CONTRACTORS RESPONSIBILITY TO PROVIDE BURNING/WELDING PERMITS AS REQUIRED BY LOCAL GOVERNING AUTHORITY AND IF REQUIRED SHALL HAVE FIRE DEPARTMENT DETAIL FOR ANY WELDING ACTIVITY.
- E ALL ELECTRODES TO BE LOW HYDROGEN MATCHING FILLER METAL PER AWS D1.1 UNLESS NOTED OTHERWISE
- MINIMUM WELD SIZE TO BE 0.1875 INCH FILLET WELDS, UNLESS NOTED OTHERWISE.
- PRIOR TO FIELD WELDING GALVANIZING MATERIAL, CONTRACTOR SHALL GRIND OFF GALVANIZING 1/2" BEYOND ALL FIELD WELD SURFACES. AFTER WELD AND WELD INSPECTION IS COMPLETE, REPAIR ALL GROUND AND WELDED SURFACES WITH ZRC GALVILITE COLD GALVANIZING COMPOUND PER ASTM A780 AND MANUFACTURERS RECOMMENDATIONS
- THE CONTRACTOR SHALL PROVIDE ADEQUATE SHORING AND/OR BRACING WHERE REQUIRED DURING CONSTRUCTION UNTIL ALL CONNECTIONS ARE COMPLETE.
- ANY FIELD CHANGES OR SUBSTITUTIONS SHALL HAVE PRIOR APPROVAL FROM THE ENGINEER, AND T-MOBILE PROJECT MANAGER IN WRITING

SPECIAL CONSTRUCTION

- WORK INCLUDED:
- ANTENNA AND COAXIAL CABLES ARE FURNISHED BY T-MOBILE UNDER A SEPARATE CONTRACT. THE CONTRACTOR SHALL ASSIST ANTENNA INSTALLATION CONTRACTOR IN TERMS OF COORDINATION AND SITE ACCESS. ERECTION SUBCONTRACTOR SHALL BE RESPONSIBLE FOR THE PROTECTION OF PERSONNEL
- INSTALL ANTENNAS AS INDICATED ON DRAWINGS AND T-MOBILE SPECIFICATIONS.
- C. INSTALL GALVANIZED STEEL ANTENNA MOUNTS AS INDICATED ON DRAWINGS.
- INSTALL FURNISHED GALVANIZED STEEL OR ALUMINUM WAVEGUIDE AND PROVIDE PRINTOUT OF THAT TEST.
- CONTRACTOR SHALL PROVIDE FOUR (4) SETS OF SWEEP TESTS USING ANRITZU-PACKARD 8713B RF SCALAR NETWORK ANALYZER. SUBMIT FREQUENCY DOMAIN REFLECTOMETER(FDR) TESTS RESULTS TO THE PROJECT MANAGER. SWEEP TESTS SHALL BE AS PER ATTACHED RFS "MINIMUM FIELD TESTING RECOMMENDED FOR ANTENNA AND HELIAX COAXIAL CABLE SYSTEMS" DATED 10/5/93. TESTING SHALL BE PERFORMED BY AN INDEPENDENT TESTING SERVICE AND BE BOUND AND SUBMITTED WITHIN ONE WEEK OF WORK COMPLETION.
- F. INSTALL COAXIAL CABLES AND TERMINATING BETWEEN ANTENNAS AND EQUIPMENT PER MANUFACTURER'S RECOMMENDATIONS WEATHERPROOF ALL CONNECTIONS BETWEEN THE ANTENNA AND FOLIPMENT PER MANUFACTURER'S REQUIREMENTS. TERMINATE ALL COAXIAL CABLE THREE (3) FEET IN EXCESS OF ENTRY PORT LOCATION UNLESS OTHERWISE STATED.
- G. ANTENNA AND COAXIAL CABLE GROUNDING:
- ALL EXTERIOR #6 GREEN GROUND WIRE "DAISY CHAIN" CONNECTIONS ARE TO BE WEATHER SEALED WITH RFS CONNECTORS/SPLICE WEATHERPROOFING KIT #221213 OR
- ALL COAXIAL CABLE GROUNDING KITS ARE TO BE INSTALLED ON STRAIGHT RUNS OF

CONCRETE AND REINFORCING STEEL NOTES:

- DESIGN AND CONSTRUCTION OF ALL CONCRETE FLEMENTS SHALL CONFORM TO THE LATEST EDITIONS OF ALL APPLICABLE CODES INCLUDING: ACI 301 "SPECIFICATIONS FOR STRUCTURAL CONCRETE FOR BUILDINGS", ACI 117 "SPECIFICATIONS FOR TOLERANCES FOR CONCRETE CONSTRUCTION AND MATERIALS", AND ACI 318 "BUILDING CODE REQUIREMENTS
- 2. MIX DESIGN SHALL BE APPROVED BY T-MOBILE REP PRIOR TO PLACING CONCRETE
- CONCRETE SHALL BE NORMAL WEIGHT, 6 % AIR ENTRAINED (+/- 1.5%) WITH A SLUMF RANGE OF 3-6" AND HAVE A MINIMUM 28-DAY COMPRESSIVE STRENGTH OF 4500 PSI UNLESS
- THE FOLLOWING MATERIALS SHALL BE USED:

PORTLAND CEMENT:

REINFORCEMENT ASTM A185, PLAIN STEEL WELDED WIRE FABRIC REINFORCEMENT BARS: ASTM A615, GRADE 60, DEFORMED NORMAL WEIGHT AGGREGATE: ASTM C33

WATER: WELDED WIRE FABRIC:

ADMIXTURES: -WATER-REDUCING AGENT:

-RETARDING:

ASTM C 494/C 494M, TYPE A -AIR-ENTERING AGENT: ASTM C 260/C 260M -SUPERPLASTICIZER

ASTM C 94/C 94M

ASTM A185

ASTM C494. TYPE F OR TYPE G ASTM C 494/C 494M, TYPE B

- MINIMUM CONCRETE COVER FOR REINFORCING STEEL SHALL BE NO LESS THAN 3".
- A 3/4" CHAMEER SHALL BE PROVIDED AT ALL EXPOSED EDGES OF CONCRETE IN ACCORDANCE WITH ACI 301 SECTION 4.2.4, UNLESS NOTED OTHERWISE
- INSTALLATION OF CONCRETE EXPANSION/WEDGE ANCHOR SHALL BE PER MANUFACTURER'S WRITTEN RECOMMENDED PROCEDURE. THE ANCHOR BOLT, DOWEL OR ROD SHALL CONFORM TO MANUFACTURER'S RECOMMENDATION FOR EMBEDMENT DEPTH OR AS SHOWN ON THE DRAWINGS. NO REBAR SHALL BE CUT WITHOUT PRIOR APPROVAL FROM AN ATC ENGINEER WHEN DRILLING HOLES IN CONCRETE
- ADMIXTURES SHALL CONFORM TO THE APPROPRIATE ASTM STANDARD AS REFERENCED
- DO NOT WELD OR TACK WELD REINFORCING STEEL.
- ALL DOWELS, ANCHOR BOLTS, EMBEDDED STEEL, ELECTRICAL CONDUITS, PIPE SLEEVES, GROUNDS AND ALL OTHER EMBEDDED ITEMS AND FORMED DETAILS SHALL BE IN PLACE BEFORE START OF CONCRETE PLACEMENT.
- 11. REINFORCEMENT SHALL BE COLD BENT WHENEVER BENDING IS REQUIRED.
- 12. DO NOT PLACE CONCRETE IN WATER, ICE, OR ON FROZEN GROUND.
- FOR COLD-WEATHER (ACI 306) AND HOT-WEATHER (ACI 301M) CONCRETE PLACEMENT CONFORM TO APPLICABLE ACI CODES AND RECOMMENDATIONS. IN EITHER CASE, MATERIALS CONTAINING CHLORIDE, CALCIUM, SALTS, ETC. SHALL NOT BE USED. PROTECT FRESH CONCRETE FROM WEATHER FOR 7 DAYS, MINIMUM,
- 14 ALL CONCRETE SHALL HAVE A "SMOOTH FORM FINISH."
- SPLICING OF REINFORCEMENT IS PERMITTED ONLY AT LOCATIONS SHOWN IN THE CONTRACT DRAWINGS OR AS ACCEPTED BY THE ENGINEER. UNLESS OTHER SHOWN OR NOTED REINFORCING STEEL SHALL BE SPLICED TO DEVELOP ITS FULL TENSILE CAPACITY (CLASS A) IN ACCORDANCE WITH ACI 318.
- DETAILING OF REINFORCING STEEL SHALL CONFORM TO "ACI MANUAL OF STANDARD PRACTICE FOR DETAILING REINFORCED CONCRETE STRUCTURES" (ACI 315).
- ALL SLAB CONSTRUCTION SHALL BE CAST MONOLITHICALLY WITHOUT HORIZONTAL CONSTRUCTION JOINTS, UNLESS SHOWN IN THE CONTRACT DRAWINGS
- LOCATION OF ALL CONSTRUCTION JOINTS ARE SUBJECT TO THE REQUIREMENTS OF THE CONTRACT DOCUMENTS, CONFORMANCE WITH ACI 318, AND ACCEPTANCE OF THE ENGINEER, DRAWINGS SHOWING LOCATION OF DETAILS OF THE PROPOSED CONSTRUCTION JOINTS SHALL BE SUBMITTED WITH REINFORCING STEEL PLACEMENT
- SPLICES OF WWF, AT ALL SPLICED EDGES, SHALL BE SUCH THAT THE OVERLAP MEASURED BETWEEN OUTERMOST CROSS WIRES OF EACH FARRIC SHEET IS NOT LESS THAN THE SPACING OF THE CROSS WIRE PLUS 2 INCHES, NOR LESS THAN 6".
- BAR SUPPORTS SHALL BE ALL-GALVANIZED METAL WITH PLASTIC TIPS.
- ALL REINFORCEMENT SHALL BE SECURELY TIED IN PLACE TO PREVENT DISPLACEMENT BY CONSTRUCTION TRAFFIC OR CONCRETE. TIE WIRE SHALL BE OF SUFFICIENT STRENGTH FOR INTENDED PURPOSE, BUT NOT LESS THAN NO. 18 GAUGE
- SLAB ON GROUND: COMPACT STRUCTURAL FILL TO 95% DENSITY AND THEN PLACE 6" GRAVEL BENEATH SLAB.

ELECTRICAL NOTES:

- ELECTRICAL WORK SHALL BE PERFORMED BY ELECTRICAL CONTRACTOR. ELECTRICAL CONTRACTOR SHALL ENSURE THAT ALL WORK COMPLIES WITH ALL APPLICABLE LOCAL AND STATE CODES AND NATIONAL ELECTRICAL CODE.
- ALL SLIGGESTED ELECTRICAL ELEMENTS (SLICH AS BREAKER SIZES, WIRE SIZES THE ELECTRICAL CONTRACTOR TO CONFIRM COMPLIANCE WITH LOCAL ELECTRICAL CODES AND PASS ALL APPLICABLE AND NECESSARY INSPECTIONS, IN SOME EVENTS, IT MAY BE NECESSARY TO PERFORM AN ELECTRICAL LOAD STUDY TO VERIFY THE CAPACITY OF THE EXISTING SERVICE. THIS IS NOT THE RESPONSIBILITY OF ATC. IT IS THE RESPONSIBILITY OF THE ELECTRICAL CONTRACTOR
- CONTRACTOR SHALL FIELD LOCATE ALL BELOW GRADE GROUNDING CABLES AND UTILITY LINES PRIOR TO CONSTRUCTION. CONTRACTOR IS RESPONSIBLE FOR RELOCATION OF ALL UTILITIES AND GROUNDING LINES THAT MAY BECOME DISTURBED OR CONFLICTING IN THE COURSE OF CONSTRUCTION.

ALL DISCREPANCIES FROM WHAT IS SHOWN ON THESE CONSTRUCTION DRAWINGS SHALL BE COMMUNICATED TO ATC ENGINEERING IMMEDIATELY FOR CORRECTION OR RE-DESIGN FAILURE TO COMMUNICATE DIRECTLY WITH ATC ENGINEERING OR ANY CHANGES FROM THE DESIGN CONDUCTED WITHOUT PRIOR APPROVAL FROM ATC ENGINEERING SHALL BE THE SOLE RESPONSIBILITY OF THE GENERAL CONTRACTOR.



PLANS PREPARED BY



RALEIGH, NC 27603-3530 OFFICE: (919) 661-6351 www.tepgroup.net

EP IS A FAMILY OF COMPANIES LICENSED TO PROVIDE DIFFERENT SERVICES IN IFFERENT JURISDICTIONS. DEPENDING ON THE JURISDICTION, PROFESSIONAI NOINEERING AND LAND SURVEYING SERVICES ARE PROVIDED BY TEP OPC-C. A DELAWARE LIMITED LIABILITY COMPANY, TEP ENGINEERING, LLC, A NORTH AROLINA PROFESSIONAL LIMITED LIABILITY COMPANY, OR MAIR HENGINEERING C. A NEW YORK PROFESSIONAL LIMITED LIABILITY COMPANY GENERAL ONTRACTOR SERVICES ARE PROVIDED BY TEP OPCO LLC, A DELAWARE MITED LIABILITY COMPANY, WE ACQUIRE THE REQUISITE LICENSES IN EACH STATE, ADDITIONAL INFORMATION CAN BE OBTAINED FROM THE COMPAN

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ATC SITE NUMBER: 207954

ATC SITE NAME:

PEBBLE BEACH T-MOBILE SITE NAME:

ATC: PEBBLE BEACH

SITE ADDRESS 4040 SUNSET LN DEL MONTE FOREST, CA 93953



04/07/25

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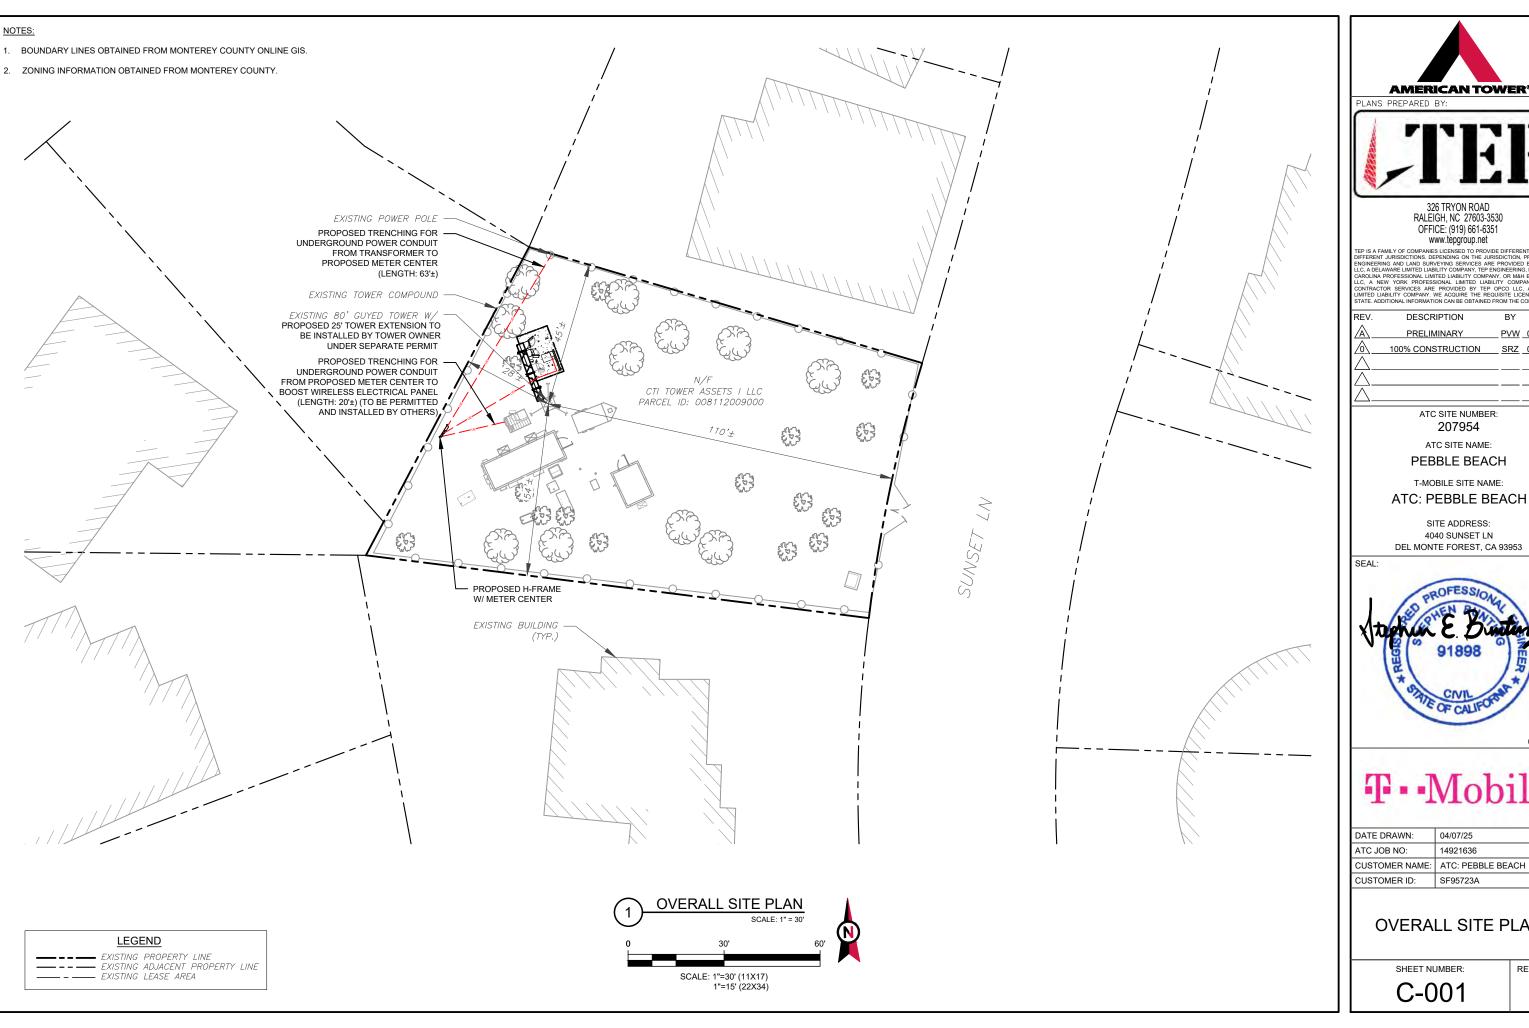
DATE DRAWN: 04/07/25 ATC JOB NO: 14921636 CUSTOMER NAME: ATC: PEBBLE BEACH CUSTOMER ID: SF95723A

GENERAL NOTES

SHEET NUMBER:

G-002

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OFFICE: (919) 661-6351

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T·Mobile

DATE DRAWN:	04/07/25
ATC JOB NO:	14921636
CUSTOMER NAME:	ATC: PEBBLE BEACH
CUSTOMER ID:	SF95723A

OVERALL SITE PLAN

REVISION:

0

SITE PLAN NOTES:


- THIS SITE PLAN REPRESENTS THE BEST PRESENT KNOWLEDGE AVAILABLE TO THE ENGINEER AT THE TIME OF THIS DESIGN. THE CONTRACTOR SHALL VISIT THE SITE PRIOR TO CONSTRUCTION AND VERIFY ALL EXISTING CONDITIONS RELATED TO THE SCOPE OF WORK FOR THIS PROJECT.
- 2. ICE BRIDGE, CABLE LADDER, COAX PORT, AND COAX CABLE ARE SHOWN FOR REFERENCE ONLY. CONTRACTOR SHALL CONFIRM THE EXACT LOCATION OF ALL PROPOSED AND EXISTING EQUIPMENT AND STRUCTURES DEPICTED ON THIS PLAN. BEFORE UTILIZING EXISTING CABLE SUPPORTS, COAX PORTS, INSTALLING NEW PORTS OR ANY OTHER EQUIPMENT, CONTRACTOR SHALL VERIFY ALL ASPECTS OF THE COMPONENTS MEET THE ATC SPECIFICATIONS.
- 3. IT IS THE RESPONSIBILITY OF THE CONTRACTOR TO COORDINATE WITH THE T-MOBILE REPRESENTATIVE AND LOCAL UTILITY COMPANY FOR THE INSTALLATION OF CONDUITS, CONDUCTORS, BREAKERS, DISCONNECTS, OR ANY OTHER EQUIPMENT REQUIRED FOR ELECTRICAL SERVICE. ALL ELECTRICAL WORK SHALL BE PERFORMED IN ACCORDANCE WITH LATEST EDITION OF THE STATE AND NATIONAL CODES, ORDINANCES AND REGULATIONS APPLICABLE TO THIS PROJECT.
- SEE ELECTRICAL INSTALLATION PLAN BY AMERICAN TOWER CORPORATION DATED MARCH 19, 2025 FOR FURTHER PROPOSED ELECTRICAL DETAILS.

LEGEND GROUNDING TEST WELL ATS AUTOMATIC TRANSFER SWITCH BOLLARD CSC **CELL SITE CABINET** D DISCONNECT **ELECTRICAL** FIBER GEN **GENERATOR** GENERATOR RECEPTACLE HH. V HAND HOLE, VAULT ICE BRIDGE KENTROX BOX LC LIGHTING CONTROL METER PB PULL BOX PΡ POWER POLE TELCO TRN TRANSFORMER

WOODEN FENCE

PROPOSED CABLE NOTES:

- ESTIMATED LENGTH OF PROPOSED CABLE IS <u>70m</u>.
 ESTIMATED LENGTH OF CABLE WAS PROVIDED BY
 CUSTOMER OR CALCULATED BY ADDING THE RAD
 CENTER AND THE DISTANCE FROM THE SHELTER
 ENTRY PLATE TO THE TOWER (ALONG THE ICE
 BRIDGE) AND A SAFETY FACTOR MEASUREMENT OF
 15% (OF THE TWO PREVIOUS VALUES), CDS DEFER
 TO GREATEST CABLE LENGTH.
- 2. ROUTE PROPOSED CABLES ALONG SAME PATH AS EXISTING CABLES AND IN ACCORDANCE WITH STRUCTURAL ANALYSIS. WHERE POSSIBLE UTILIZE EXISTING CABLE SUPPORT STRUCTURES AS PROVIDED FOR CARRIER TO ADEQUATELY SECURE CABLES, USING EITHER APPROPRIATELY SIZED STAINLESS STEEL SNAP-INS OR MOUNTING HARDWARE AND BRACKETS AS SPECIFIED BY CABLE MANUFACTURER. OTHERWISE, ATTACH CABLES TO HORIZONTAL OR DIAGONAL TOWER MEMBERS USING PROPOSED STAINLESS STEEL ADAPTERS (DO NOT ATTACH TO TOWER LEG).

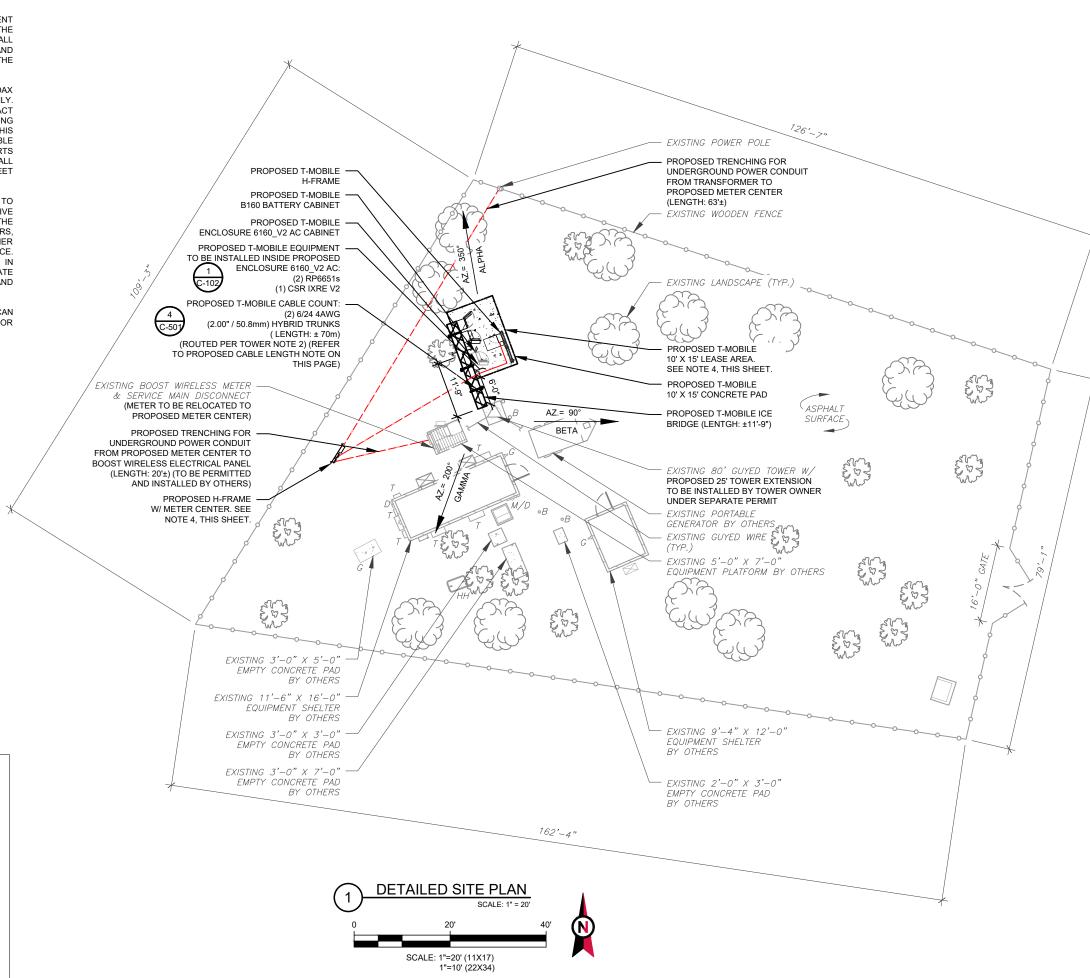



PLANS PREPARED BY:



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	\triangle	100% CONSTRUCTION	SRZ	04/07/25
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ATC SITE NUMBER: 207954

ATC SITE NAME:

PEBBLE BEACH

T-MOBILE SITE NAME:

ATC: PEBBLE BEACH

SITE ADDRESS: 4040 SUNSET LN DEL MONTE FOREST, CA 93953

SEAL:



04/07


T·Mobile

DATE DRAWN:	04/07/25
ATC JOB NO:	14921636
CUSTOMER NAME:	ATC: PEBBLE BEACH
CUSTOMER ID:	SF95723A

DETAILED SITE PLAN

SHEET NUMBER:


C-101

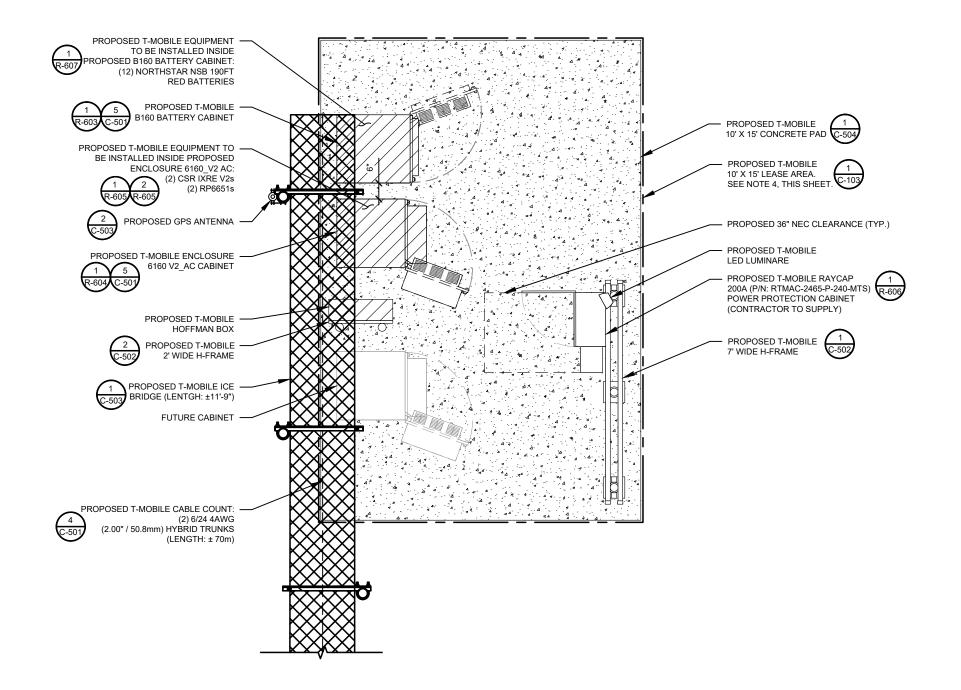

PROPOSED GROUND EQUIPMENT LAYOUT

SCALE: 1"=3' (11X17)

1"=1.5' (22X34)

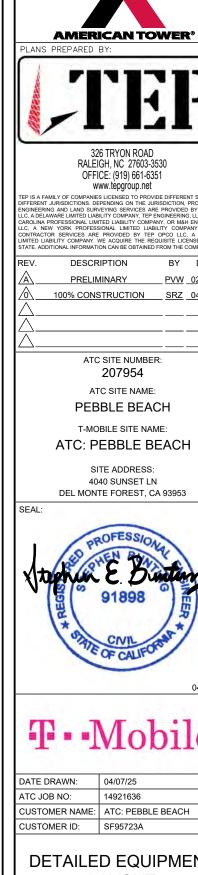

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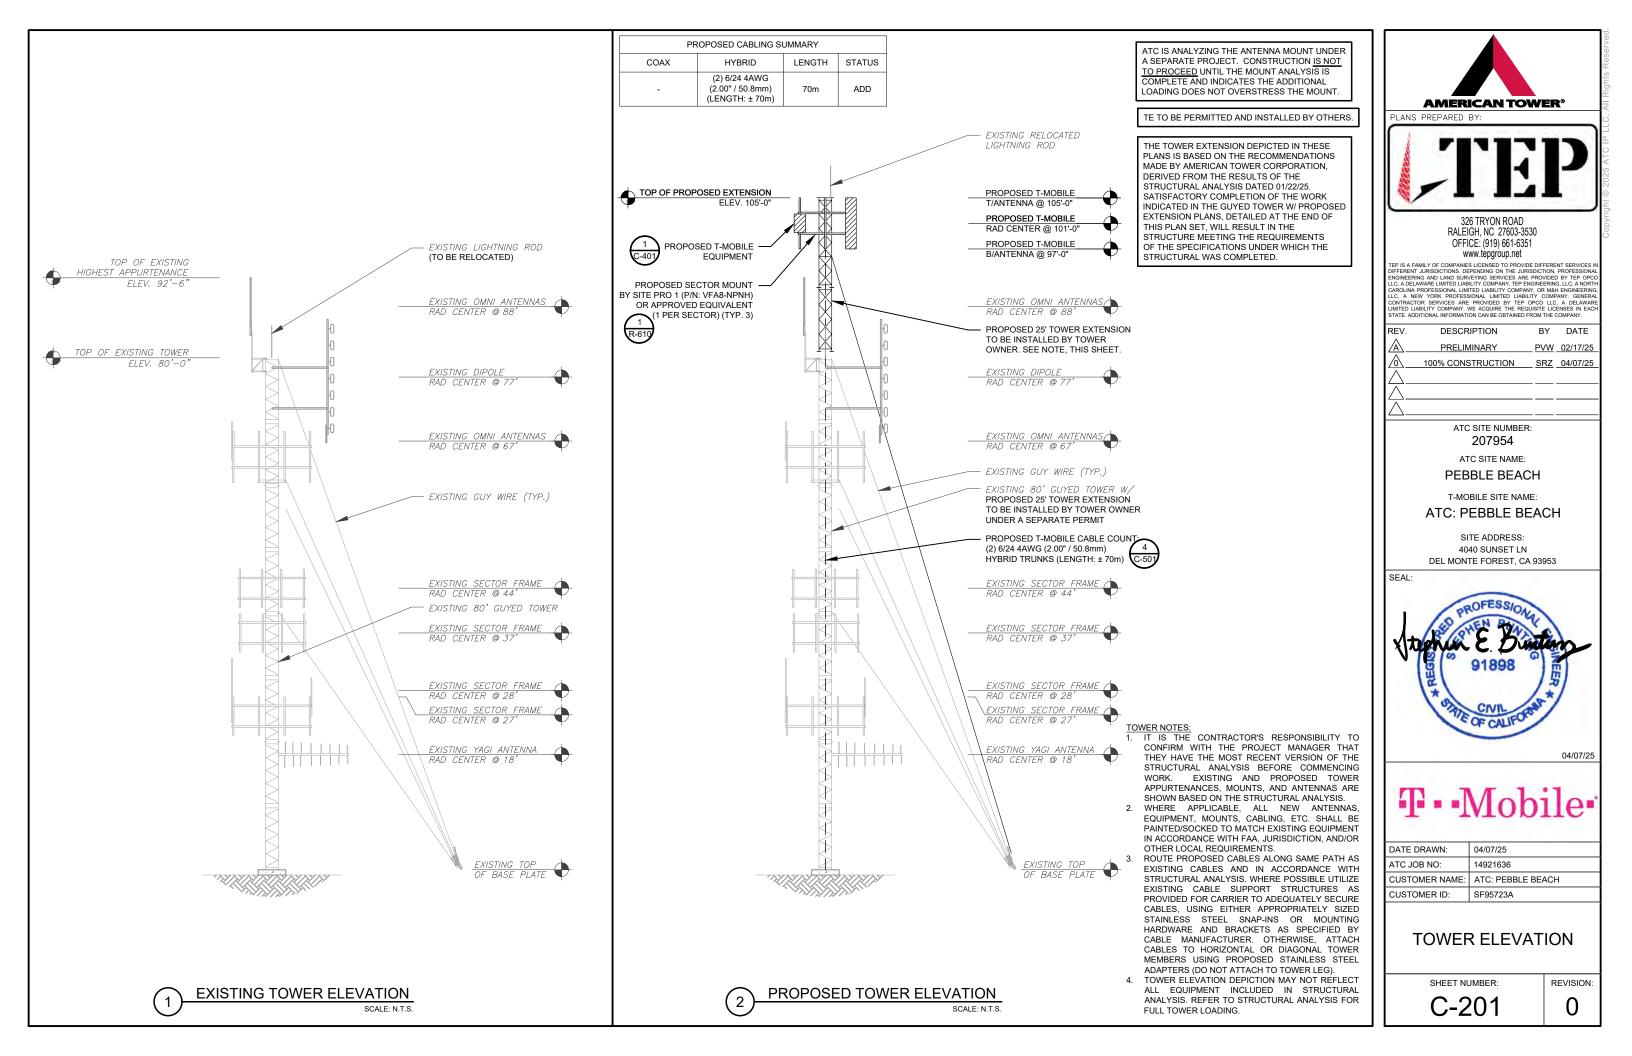


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	CUSTOMER ID:	SF95723A

DETAILED EQUIPMENT LAYOUT

SHEET NUMBER:

C-102



NOTES:

- MATERIALS IN FRONT AND SIDE OF ANTENNAS MUST BE RF TRANSPARENT TO MINIMIZE PIM ISSUES.
- PLEASE MAKE SURE NO RUST ON COMPONENTS AND NO LOOSE CONNECTIONS
- ENSURE THERE ARE NO PIM ISSUES DURING INSTALLATION.
- ANTENNAS CAN'T SHOOT INTO METAL, OTHER OPERATOR ANTENNAS, ANYTHING THAT CAN CAUSE PIM, ETC.
- NO ANTENNA SHADOWING. ALL ANTENNAS ARE TO BE CO-PLANAR.
- RADIOS CANNOT TOUCH ANTENNAS. CALL OUT THE USE OF THE CONCEAL FAB PIM SHIELD KIT.

PROPOSED
RADIO 4460 B25+B66 RRU
C-501 PROPOSED (1 PER SECTOR) (TYP. 3) PROPOSED (TYP.) APXVAALL24M-U-J20 ANTENNA (1 PER SECTOR) (TYP. 3) AZ.= 90° BETA EXISTING 80' GUYED TOWER W/ PROPOSED 25' TOWER EXTENSION TO BE INSTALLED BY TOWER OWNER UNDER A SEPARATE PERMIT PROPOSED PROPOSED 2.875"X10'-0" MOUNT PIPE -RADIO 4480 B71+B85A RRU BY SITEPRO (P/N: P120) (1 PER SECTOR) (TYP. 3) APPROVED EQUIVALENT (3 PER SECTOR) (TYP. 9) PROPOSED SECTOR MOUNT BY SITE PRO 1 (P/N: VFA8-NPNH) OR APPROVED EQUIVALENT (1 PER SECTOR) (TYP. 3) AZ.= 90° PROPOSED -BETA AIR 6419 B41 ANTENNA (1 PER SECTOR) (TYP. 3) PROPOSED DUAL SWIVEL RRU MOUNT BY SITE PRO (P/N: RRUDSM) OR APPROVED EQUIVALENT



	FINAL ANTENNA SCHEDULE											
LOCATION ANTENNA SUMMARY					NON ANTENNA SUMMA	NON ANTENNA SUMMARY		CABLE SUMMARY				
SECTOR	RAD	AZ	POS	ANTENNA	BAND	MECH/ELEC D-TILT	STATUS	ADDITIONAL TOWER MOUNTED EQUIPMENT	STATUS	JUMPERS LENGT		STATUS
			A1	APXVAALL24M-U-J20	L700/N600/N1900/ L2100/ L1900/N2100	0°/-	ADD	(1) RADIO 4480 B71+B85 (1) RADIO 4460 B25+B66	ADD ADD	(8) JUMPER 8 FT SUREFLEX 4.3 - 10 TO 4.3 - 10 (6) FIBER JUMPER - 2F SM OUTDOORCON- LCD W COVER	10FT 5m	ADD ADD
ALPHA	101'	350°	A2	-	-	-	-	-	-	-	-	-
			A3	AIR 6419 B41	N2500	0°/-	ADD	-	-	(3) FIBER JUMPER - 2F SM OUTDOORCON- LCD W COVER	5m	ADD
			B1	APXVAALL24M-U-J20	L700/N600/N1900/ L2100/ L1900/N2100	0°/-	ADD	(1) RADIO 4480 B71+B85 (1) RADIO 4460 B25+B66	ADD ADD	(8) JUMPER 8 FT SUREFLEX 4.3 - 10 TO 4.3 - 10 (6) FIBER JUMPER - 2F SM OUTDOORCON- LCD W COVER	10FT 5m	ADD ADD
BETA	101'	90°	B2	-	-	-	-	-	-	-	-	-
			В3	AIR 6419 B41	N2500	0°/-	ADD	-	-	(3) FIBER JUMPER - 2F SM OUTDOORCON- LCD W COVER	5m	ADD
			C1	APXVAALL24M-U-J20	L700/N600/N1900/ L2100/ L1900/N2100	0°/-	ADD	(1) RADIO 4480 B71+B85 (1) RADIO 4460 B25+B66	ADD ADD	(8) JUMPER 8 FT SUREFLEX 4.3 - 10 TO 4.3 - 10 (6) FIBER JUMPER - 2F SM OUTDOORCON- LCD W COVER	10FT 5m	ADD ADD
GAMMA	101'	200°	C2	-	=	-	-	=	-	-	-	-
			C3	AIR 6419 B41	N2500	0°/-	ADD	=	-	(3) FIBER JUMPER - 2F SM OUTDOORCON- LCD W COVER	5m	ADD

1. BASED ON APPROVED ATC APPLICATION 14921636, DATED UNKNOWN. CONFIRM WITH T-MOBILE REP FOR APPLICABLE UPDATES/REVISIONS AND MOST RECENT RFDS FOR NSN CONFIGURATION (CONFIG). GC TO CAP ALL UNUSED PORTS.

2. CONFIRM SPACING OF PROPOSED EQUIPMENT DOES NOT CAUSE TOWER CONFLICTS NOR IMPEDE TOWER CLIMBING PEGS

CABLE LENGTHS FOR JUMPERS FIBER DISTRIBUTION/OVP TO RRU: 15' RRU TO COMBINER: 10' COMBINER TO ANTENNA: 10'

(1 PER SECTOR) (TYP. 3)

ANTENNA SCHEDULE

PROPOSED FIBER PROPOSED CABLING SUMMARY DISTRIBUTION/OVP BOX STATUS MODEL NUMBER STATUS COAX HYBRID/FIBER LENGTH (2) 6/24 4AWG 70m (2.00" / 50.8MM) ADD (LENGTH: ± 70m)

ATC IS ANALYZING THE ANTENNA MOUNT UNDER A SEPARATE PROJECT. CONSTRUCTION IS NOT TO PROCEED UNTIL THE MOUNT ANALYSIS IS COMPLETE AND INDICATES THE ADDITIONAL LOADING DOES NOT OVERSTRESS THE MOUNT.



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ATC: PEBBLE BEACH

SITE ADDRESS: 4040 SUNSET LN DEL MONTE FOREST, CA 93953




	DATE DRAWN:	04/07/25
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	CUSTOMER ID:	SF95723A

ANTENNA INFORMATION & SCHEDULE

SHEET NUMBER:


C-401

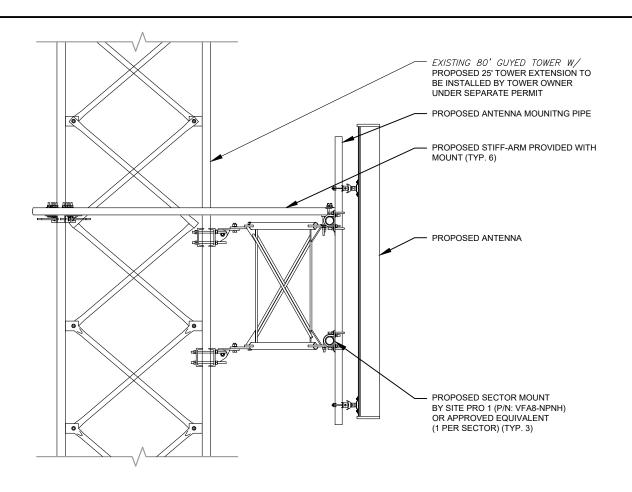


EXISTING 80' GUYED TOWER W/ PROPOSED 25' TOWER EXTENSION TO BE INSTALLED BY TOWER OWNER UNDER SEPARATE PERMIT PROPOSED ANTENNA MOUNITNG PIPE PROPOSED STIFF-ARM PROVIDED WITH MOUNT (TYP. 6) PROPOSED 5G ANTENNA PROPOSED SECTOR MOUNT BY SITE PRO 1 (P/N: VFA8-NPNH) OR APPROVED EQUIVALENT (1 PER SECTOR) (TYP. 3)

PROPOSED ANTENNA MOUNTING DETAIL

PROPOSED 5G ANTENNA MOUNTING DETAIL

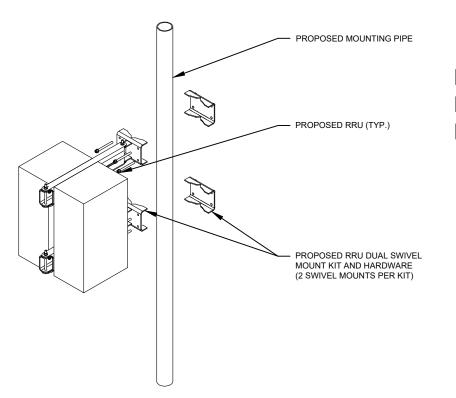

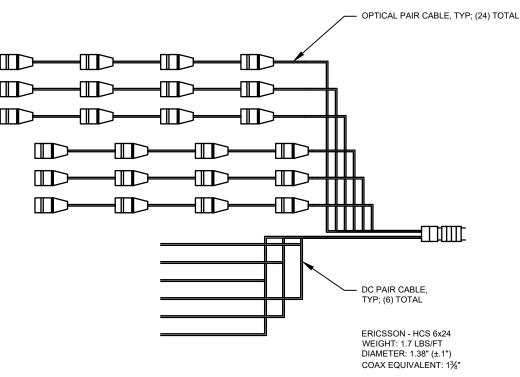

PROPOSED CABINET PROPOSED 1/2" STAINLESS STEEL HILTI KWIK BOLT TZ ADHESIVE ANCHORED BOLT (TYP. 4 PER SIDE) PROPOSED CONCRETE PAD

INSTALL HILTI KWIK BOLT ANCHORS STRICTLY PER INSTALLATION INSTRUCTIONS INCLUDED WITH PRODUCT OR FOUND ONLINE AT WWW.US.HILTI.COM. PROPER INSTALLATION IS CRITICAL FOR FULL PERFORMANCE. SPECIAL INSPECTION IS REQUIRED.

PROPOSED RRU MOUNTING DETAIL

PROPOSED HCS DETAIL

CABINET ATTACHMENT DETAIL





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ATC: PEBBLE BEACH

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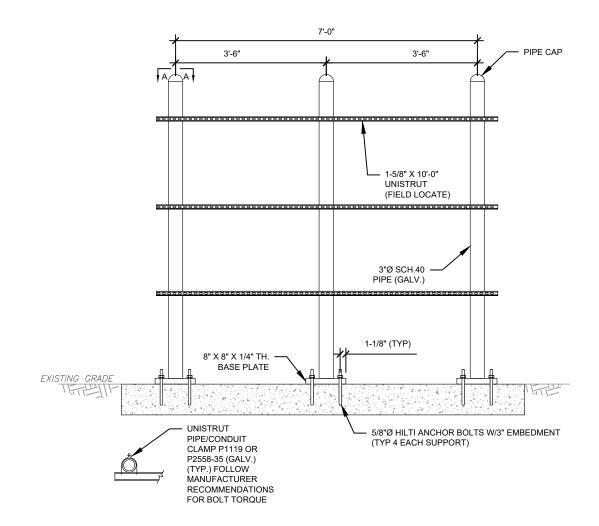
CONSTRUCTION **DETAILS**


SHEET NUMBER:

C-501

H-FRAME NOTES:

- IF IT IS NECESSARY TO EXTEND THE H-FRAME, AN ADDITIONAL POST WILL ALWAYS BE REQUIRED.
- PROPOSED UNISTRUTS TO BE FIELD CUT AND SHOULD NOT EXTEND MORE THAN 6 INCHES BEYOND THE LAST POST.
- SPRAY ENDS OF UNISTRUT WITH COLD GALVANIZING SPRAY PAINT, ALLOW TO DRY, THEN COVER WITH RUBBER PROTECTIVE CAPS FOR SAFETY.
- I. UNISTRUT TO BE CUT FLUSH WITH NO SHARP OR JAGGED EDGES.
- 5. ALL PROPOSED HARDWARE TO BE MOUNTED PER MANUFACTURERS SPECS.



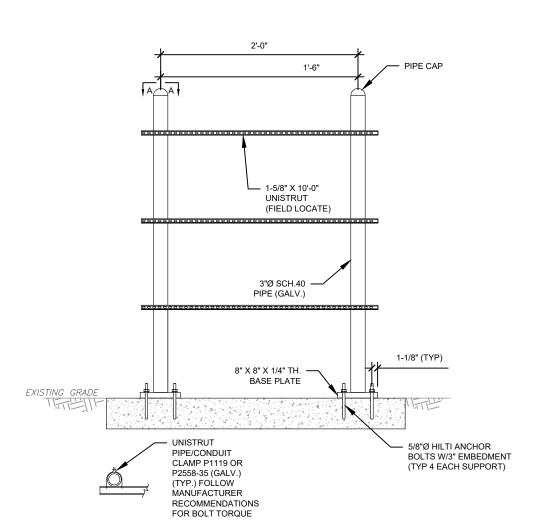

1 PROPOSED 7' WIDE H-FRAME DETAIL
SCALE: NOT TO SCALE

PROPOSED 2' WIDE H-FRAME DETAIL
SCALE: NOT TO SCALE



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SEAL:



04/07

T. Mobile


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CONSTRUCTION DETAILS

SHEET NUMBER:

C-502


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CONSTRUCTION NOTES:


- INSTALL ICE BRIDGE TO ALLOW 7 FEET CLEARANCE ABOVE GRADE TO LOWEST APPURTENANCE.
- 2. INSTALL PER MANUFACTURES SPECIFICATION.

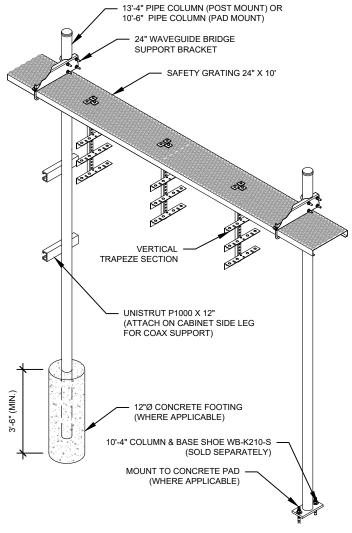



- IF FREE OF ORGANIC OR OTHER DELETERIOUS MATERIAL, EXCAVATED MATERIAL MAY BE USED FOR BACKFILL.
- IF NOT, PROVIDE CLEAN, COMPACTIBLE MATERIAL. COMPACT IN 8" LIFTS. REMOVE ANY LARGE ROCKS PRIOR TO BACKFILLING. CONTRACTOR TO VERIFY LOCATION OF EXISTING U/G UTILITIES PRIOR TO DIGGING.
- 3. IF CURRENT AS-BUILT DRAWINGS ARE NOT AVAILABLE CONTRACTOR SHALL HAND DIG U/G TRENCHING.
- 4. CONCRETE ENCASE CONDUIT WHEN TRENCHING UNDER SITE ACCESS ROAD.

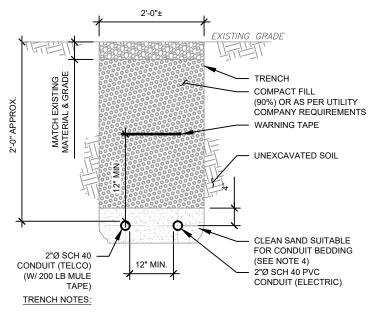2 TELCO AND POWER CONDUIT JOINT TRENCH
SCALE: N.T.S.

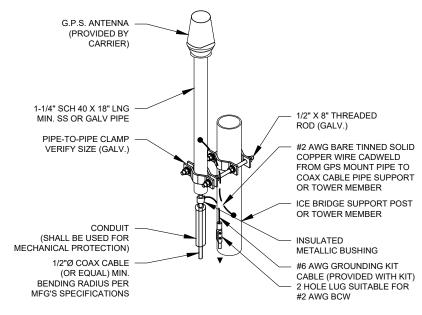

NOTES:

- 1. GPS SHALL BE PLACED WITH CLEAR SIGHT LINE TO THE SOUTHERN SKY.
- 2. CONTRACTOR TO SUPPLY COAX FOR GPS UNIT.

GPS ANTENNA ATTACHMENT DETAIL



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CUSTOMER ID:	SF95723A
	ATC JOB NO: CUSTOMER NAME:

CONSTRUCTION DETAILS

SHEET NUMBER:

C-503

FOUNDATION NOTES:


- 1. FOUNDATION BASED ON 2,000 PSF SOIL BEARING CAPACITY.
- 2. CONCRETE SHALL BE MIN. 4,000 PSI AFTER 28 DAYS.
- REINFORCING STEEL F_y = 60,000 PSI.
- 4. ALL BACKFILL SHALL BE THOROUGHLY COMPACTED TO A MINIMUM OF 95% DENSITY USING THE MODIFIED PROCTOR METHOD.
- 5. SURFACE OF FINISHED SLAB SHALL BE LEVEL AND FLAT WITHIN 1/4".
- 6. CONTRACTOR SHALL VERIFY MANUFACTURER ACTUAL DIMENSIONS OF CABINET PRIOR TO LAYING OUT FOUNDATION.
- MAXIMUM SIZE OF CONCRETE AGGREGATE SHALL NOT EXCEED 1 INCH; SIZE SUITABLE FOR INSTALLATION METHOD UTILIZED; OR ONE-THIRD CLEAR DISTANCE BEHIND OR BETWEEN REINFORCING.
- 8. REINFORCEMENT SHALL BE DEFORMED AND CONFORM TO THE REQUIREMENTS OF ASTM A615 GRADE 60 UNLESS OTHERWISE NOTED.
- 9. WELDING IS PROHIBITED ON REINFORCING STEEL AND EMBEDMENTS.
- 10. MINIMUM CONCRETE COVER FOR REINFORCEMENT SHALL BE 3 INCHES UNLESS OTHERWISE NOTED.
- 11. CONCRETE COVER FROM TOP OF FOUNDATION TO ENDS OF VERTICAL REINFORCEMENT SHALL BE 3 INCHES MINIMUM.
- 12. FOUNDATION DESIGN ASSUMES FIELD INSPECTIONS WILL BE PERFORMED TO VERIFY THAT CONSTRUCTION MATERIALS, INSTALLATION METHODS, AND ASSUMED DESIGN PARAMETERS ARE ACCEPTABLE BASED ON CONDITIONS EXISTING AT THE SITE.
- 13. FOUNDATION DESIGN ASSUMED CONTINUOUS CONCRETE PLACEMENT WITHOUT CONSTRUCTION JOINTS
- 14. WELDED WIRE FABRIC SHALL BE SUPPLIED IN FLAT SHEETS, (NOT ROLLED).
- 15. TEST CYLINDERS SHALL BE MOLDED AND LABORATORY CURED IN ACCORDANCE WITH ASTM C31. THREE CYLINDERS SHALL BE TAKEN FOR EACH DAYS CONCRETE PLACEMENT. CYLINDERS SHALL BE TESTED IN ACCORDANCE WITH ASTM C39.
- 16. TOPS OF CONCRETE FOUNDATION MUST BE WITHIN 0.02" OF ELEVATION SPECIFIED BY THE CUSTOMER.

GENERAL STRUCTURAL NOTES:


- 1. ALL CONCRETE WORK SHALL BE PERFORMED IN ACCORDANCE WITH ACI 318-14.
- 2. REINFORCING STEEL SHALL BE PLACED IN ACCORDANCE WITH THE CONCRETE REINFORCING STEEL INSTITUTE (CRSI) "MANUAL OF STANDARD PRACTICE"

NOTES:

- 1. FROST DEPTH FOR MONTEREY COUNTY IS 5 INCHES.
- 2. APPLICATION RATE OF FIBERS SHALL BE DETERMINED BY THE READY MIX CONCRETE SUPPLIER.
- 3. THE CONCRETE SUPPLIER SHALL FOLLOW ALL MANUFACTURER RECOMMENDATIONS FOR FIBERMESH APPLICATION INCLUDING MINIMUM APPLICATION RATE OF 3LBS/YD³.

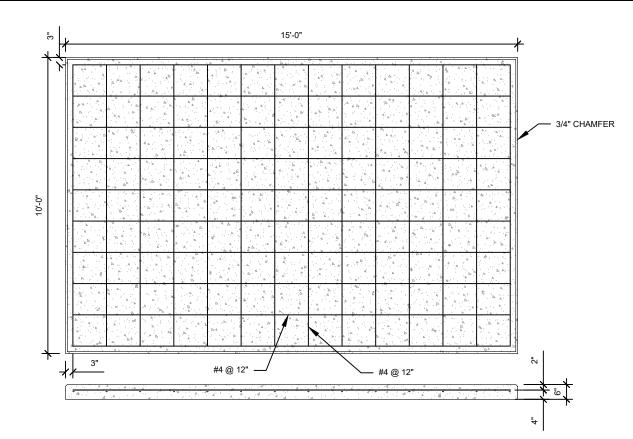



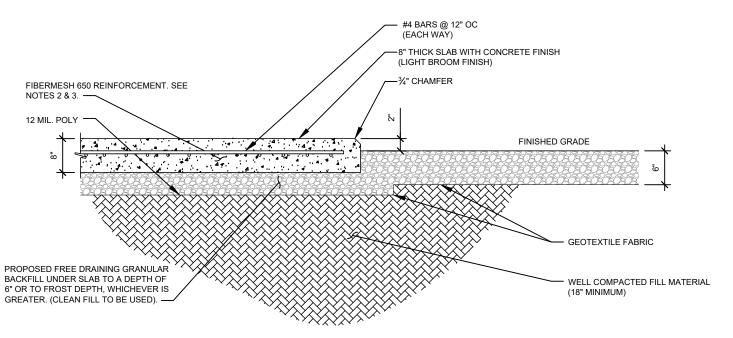

POUNDATION SECTION VIEW SCALE: N.T.S.



TEP

326 TRYON ROAD RALEIGH, NC 27603-3530 OFFICE: (919) 661-6351 www.tepgroup.net

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REV.	DESCRIPTION	BY	DATE
\mathbb{A}_{-}	PRELIMINARY	<u>PVW</u>	02/17/25
<u> </u>	100% CONSTRUCTION	SRZ	04/07/25
\wedge			
$\overline{\square}$			

ATC SITE NUMBER: 207954

ATC SITE NAME:

PEBBLE BEACH

T-MOBILE SITE NAME:

ATC: PEBBLE BEACH

SITE ADDRESS: 4040 SUNSET LN DEL MONTE FOREST, CA 93953

SEAL:

THE PROFESSIONAL STATE OF CALFORNIA CIVIL CIVIL

T·Mobile

DATE DRAWN: 04/07/25
ATC JOB NO: 14921636
CUSTOMER NAME: ATC: PEBBLE BEACH
CUSTOMER ID: SF95723A


CONSTRUCTION DETAILS


SHEET NUMBER:

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REVISION

04/07/25



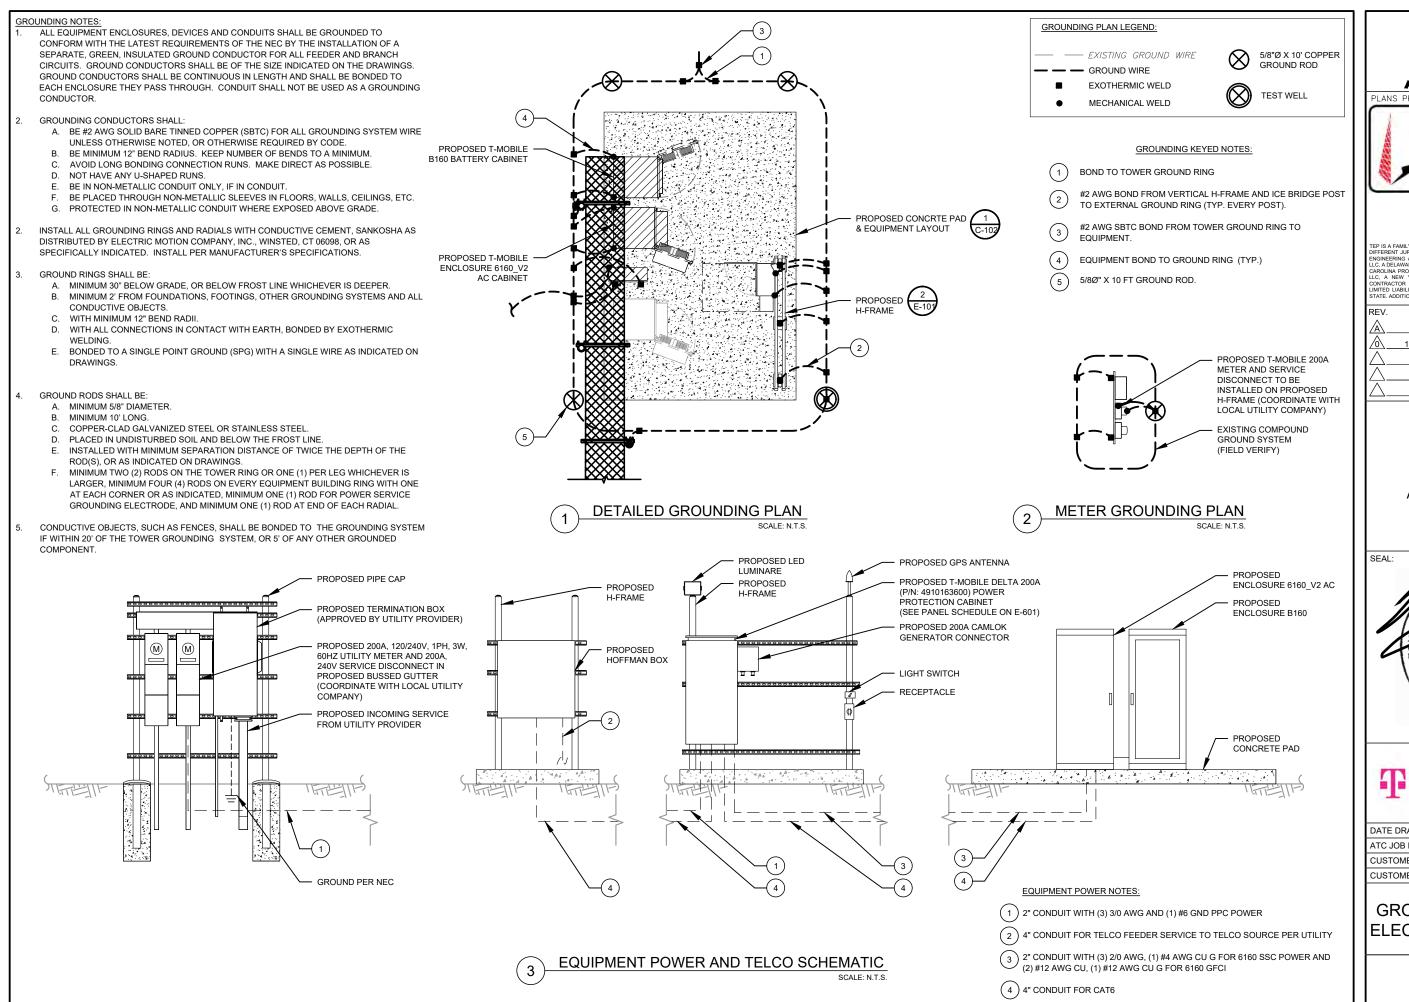

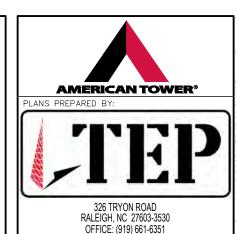www.tepgroup.net P IS A FAMILY OF COMPANIES LICENSED TO PROVIDE DIFFERENT SERVICES FFERENT JURISDICTIONS. DEPENDING ON THE JURISDICTION, PROFESSION. GINEERING AND LAND SURVEYING SERVICES ARE PROVIDED BY TEP OPC. A DELAWARE LIMITED LIABILITY COMPANY, TEP ENGINEERING, LLC, A NOR ROCINA PROFESSIONAL LIMITED LIABILITY COMPANY, OR MAIL HIGHIERING. A NEW YORK PROFESSIONAL LIMITED LIABILITY COMPANY, GENER DITRACTOR SERVICES ARE PROVIDED BY TEP OPC. LIC. A DELAWAR HITED LIABILITY COMPANY, WE ACQUIRE THE REQUISITE LICENSES IN EACH TERM OF THE PROPORTION OF THE PROPORTION

REV.	DESCRIPTION	BY	DATE
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A_	PRELIMINARY	_ PVW	02/17/25
<u> </u>	100% CONSTRUCTION	SRZ	04/07/25
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ATC SITE NUMBER: 207954

ATC SITE NAME:

PEBBLE BEACH

T-MOBILE SITE NAME:

ATC: PEBBLE BEACH

SITE ADDRESS:

4040 SUNSET LN DEL MONTE FOREST, C 23287

T·Mobile


DATE DRAWN:	04/07/25
ATC JOB NO:	14921636
CUSTOMER NAME:	ATC: PEBBLE BEACH
CUSTOMER ID:	SF95723A

GROUNDING DETAILS & ELECTRICAL SCHEMATIC

SHEET NUMBER:


E-101

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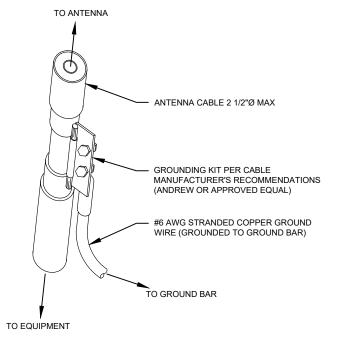
- THIS DETAIL IS INTENDED TO SHOW THE GENERAL GROUNDING REQUIREMENTS. SLIGHT ADJUSTMENTS MAY BE REQUIRED BASED ON EXISTING SITE CONDITIONS. THE CONTRACTOR SHALL MAKE FIELD ADJUSTMENTS AS NEEDED AND INFORM THE CONSTRUCTION MANAGER OF ANY CONFLICTS.
- SITE GROUNDING SHALL COMPLY WITH T-MOBILE GROUNDING STANDARDS, LATEST EDITION, AND COMPLY WITH T-MOBILE GROUNDING CHECKLIST, LATEST VERSION. WHEN NATIONAL AND LOCAL GROUNDING CODES ARE MORE STRINGENT THEY SHALL GOVERN.

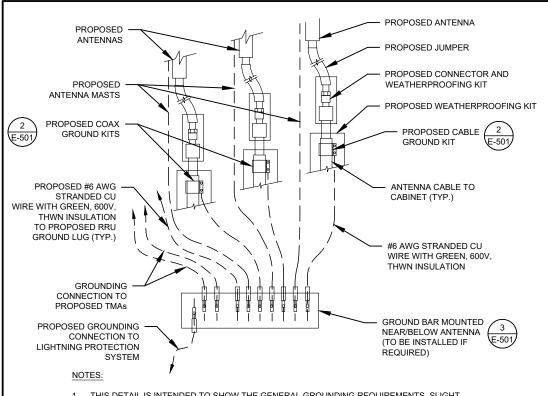



GROUND BAR NOTES

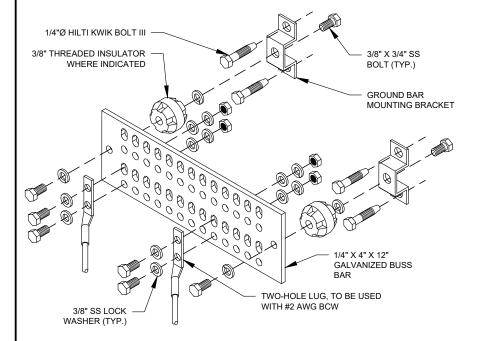
- GROUND KITS COME WITH ALL HARDWARE, NUTS, BOLTS, WASHERS, ETC. EXCEPT THE STRUCTURAL MOUNTING MEMBER(S)
- 2. GROUND BAR SHALL BE BOLTED TO STRUCTURAL MEMBER OR ANCHORED TO CONCRETE SLAB W/ HILTI KWIK BOLT III.



- <u>GROUND KIT NOTES:</u>

 1. DO NOT INSTALL CABLE GROUND KIT AT A BEND AND ALWAYS DIRECT GROUND WIRE DOWN TO GROUND BAR.
- 2. CONTRACTOR SHALL PROVIDE WEATHERPROOFING KIT (ANDREW PART NUMBER 221213) AND INSTALL/TAPE PER MANUFACTURER'S SPECIFICATIONS


CABLE GROUND KIT CONNECTION DETAIL

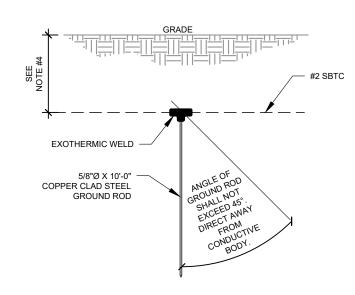

- SEPARATION DIMENSION TO BE VERIFIED WITH LOCAL UTILITY COMPANY
- 2. COORDINATE UTILITY, LOCATE BEFORE DIGGING.
- CONDUIT TRENCHING DEPTHS AT 36" OR 6" BELOW FROST LINE, WHICHEVER IS GREATER.
- ALL RING AND RADIAL DEPTHS AT 30" OR 6" BELOW FROST LINE, WHICHEVER IS GREATER.

GROUND ROD DETAIL SCALE: N.T.S.


TIE CONNECTION DETAIL

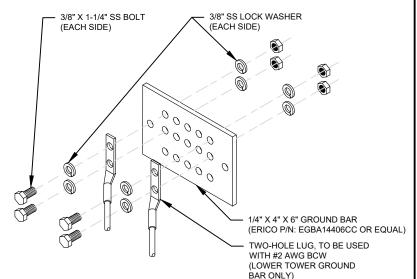

GROUND BAR NOTES:

- GROUND BAR KITS COME WITH ALL HARDWARE, NUTS, BOLTS, WASHERS, ETC. EXCEPT THE STRUCTURAL MOUNTING MEMBER(S).
- 2. GROUND BAR TO BE BONDED DIRECTLY TO TOWER

TOWER GROUND BAR DETAIL

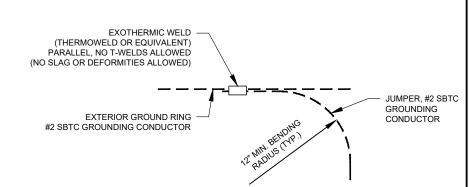



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REV.	DESCRIPTION	BY	DATE
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DATE DRAWN: 04/07/25 ATC JOB NO: 14921636 CUSTOMER NAME: ATC: PEBBLE BEACH CUSTOMER ID: SF95723A

GROUNDING DETAILS


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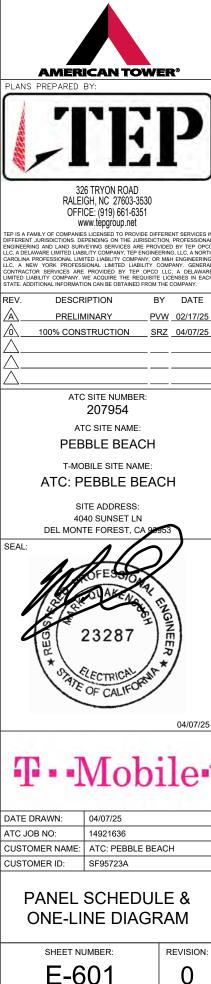
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REVISION

MAIN GROUND BAR DETAIL







04/07/25

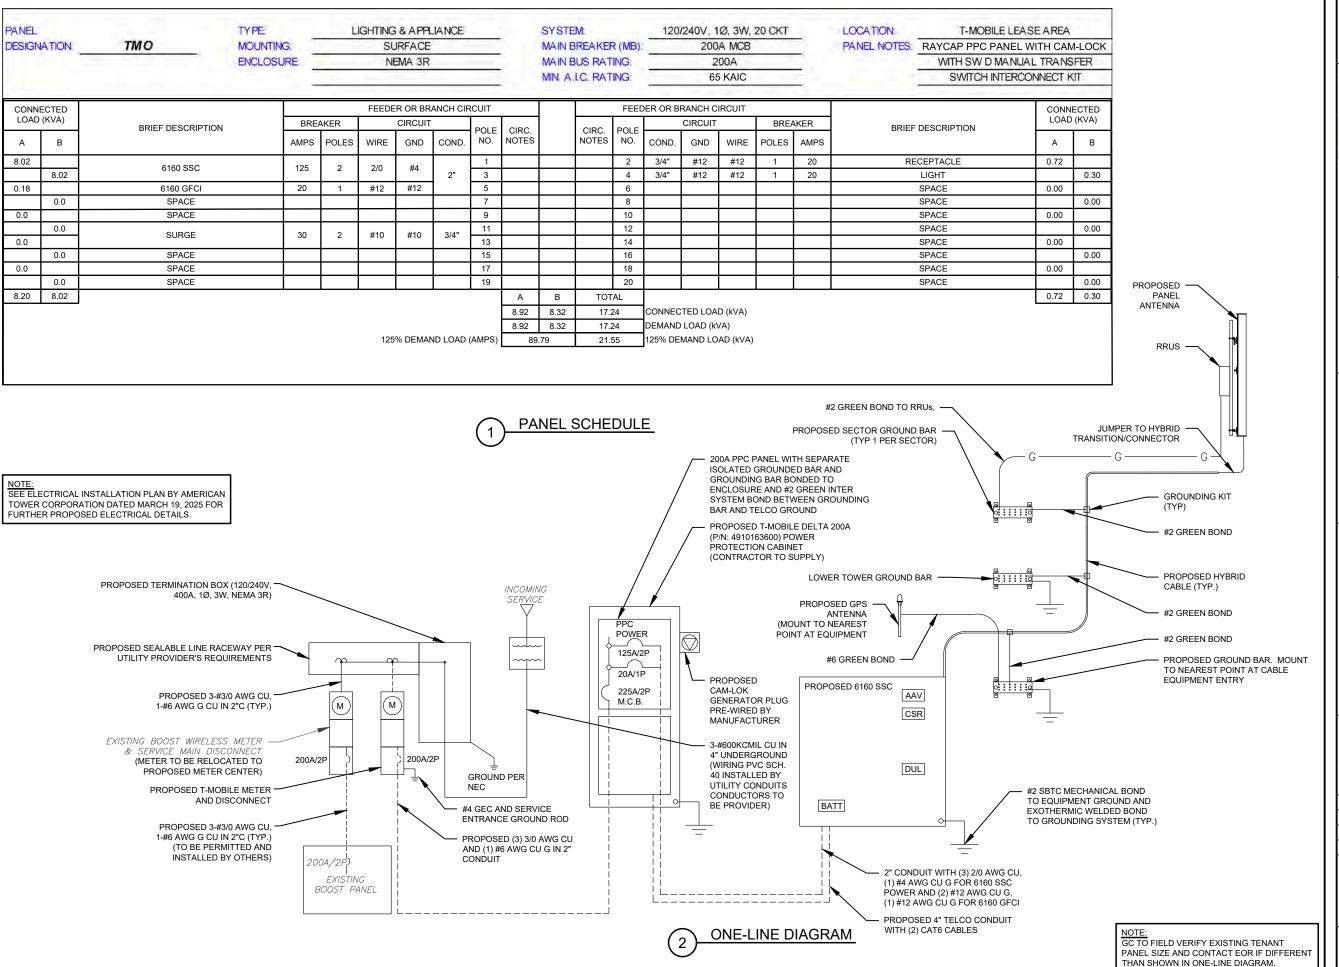REVISION

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ANTENNA SPECIFICATIONS				
ANTENNA SPECIFICATIONS				
ANTENNA MODEL	А	В	С	WEIGHT (LBS)
APXVAALL24M-U-J20	95.7"	19.7"	8.5"	86.0
AIR 6419 B41	35.2"	20.9"	7.0"	83.0

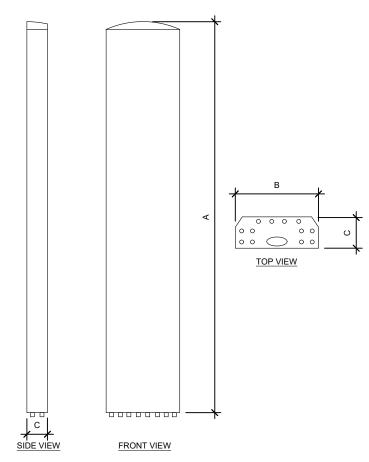

RRU SPECIFICATIONS				
RRU MODEL	А	В	С	WEIGHT (LBS)
RADIO 4460 B25+B66	19.6"	15.7"	12.1"	109.0
RADIO 4480 B71+B85A	21.8"	15.4"	7.5"	93.0

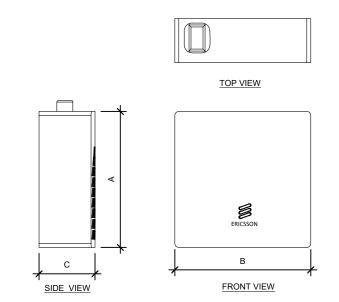- EQUIPMENT SPECIFICATIONS
SCALE: N.T.S.

SUPPLEMENTAL


SHEET NUMBER:

R-601

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	Propos	sed RAN Equipment		
	Templ	late: 67E5D998E 6160		
Enclosure	1		2	
Enclosure Type	Enclosure 6160_v2 AC	(B160)		
Baseband	RP 6651 N2500 N1900 N2100 L700 L1900 L2100			
Transport System	(CSR IXRe V2 (Gen2))			
Hybrid Cable System	Hybrid Trunk 6/24 4AWG 70m (x2)			
RAN Scope of Worl 10/15/2024: RC Up 9/20/2024: RC cha	dated from 60' to 99' as per instruction i.e tower extension.	-		

1. Add (1) RP6651 for L7/N6 + L19/L21/N19/N21 MMBB 2. Add (1) RP6651 for N2500 3. Add (1) iXRe Router 4. Add E6160 and B160 Cabinets 5. Add (2) 6x24 HCS 4 AWG 70M

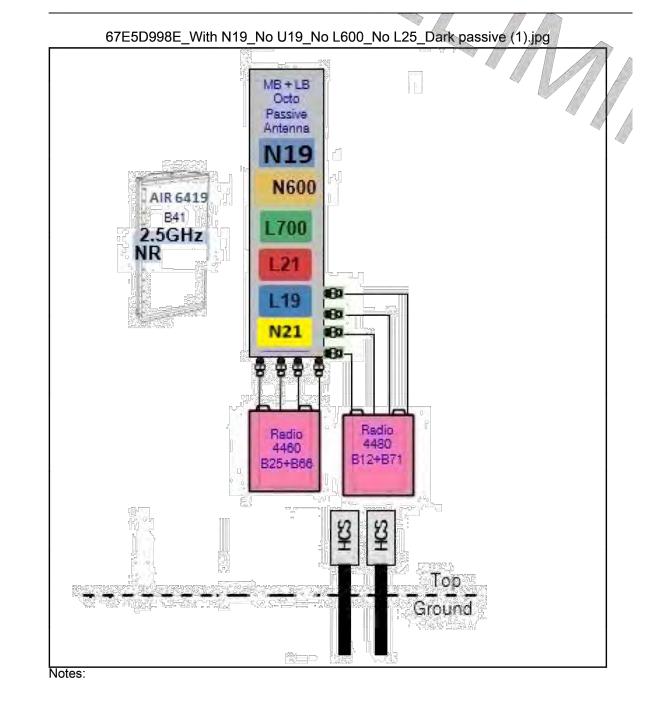

1) PROPOSED CABINET CONFIGURATION
SCALE: NTS.

PROPOSED ANTENNA CONFIGURATION
SCALE: N.T.S.

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SUPPLEMENTAL


R-602

REVISION:

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Enclosure B160





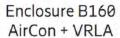

Enclosure B160 AirCon + Li-Ion



1

Enclosure B160 **Convection Cooling** + VRLA

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Enclosure B160

Capacity

— VRLA 12V: 100Ah / 150Ah / 170Ah / 190Ah / 210Ah

- Li-Ion: 24U 19" / 23" — Sodium-Nickel: 3x FIAMM

Electrical specification

— DC Output: -48VDC/200A Battery breakers: 2x 125/2p

— Alarms: Door open, Climate failure, MCB Connection

Mechanical specification

— Weight:

- Dimensions: 63 x 26 x 26 in. (incl. Base frame)

Base frame height: 6 in.

Galvanized steel (180g/m²) Material: Powder paint NCS 2002-B - Color:

- Door: Front access Locking type: Pad lock / cylinder

- Ingress protection:

Relative humidity:

Climate system - Air Conditioner

— Fan type:

 Cooling capacity: Convection cooling

Emergency fan

Environmental specification

VRLA/Sodium IP44 Li-Ion IP55

15-100%

500W @L35/L35

PA1 | 2019-02-03 | Ericsson Confidential | Page 2

PROPOSED ENCLOSURE B160 DETAIL

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SUPPLEMENTAL

SHEET NUMBER:

R-603



Enclosure 6160 AC

The Enclosure 6160 is a multi-purpose site cabinet designed to support a multitude of equipment such as ERS Baseband, Transport, Li-Ion battery and 3PP vendor equipment. It also provides a highly capable power system and battery back-up - all in a streamlined design and minimized footprint to support cost efficient expansion of mobile broadband.

Being an all-in-one enclosure, the Enclosure 6160 is a very fitting choice for all types of sites where the capacity need is large or room for future expansion is needed. It is ideally used for modernizing existing sites or in greenfield scenarios to match both current and future needs.

With a robust design, IP65 compliance and a sealed Heat Exchanger (HEX) climate system the Enclosure 6160 ensures optimal environmental protection of the active equipment - enabling them for a long-lasting service. The complete system is also integrated and verified for the entire Ericsson Radio System and ensures best-in-class service.

The power system offers 31,5kW of power in total and provides 24kW of -48V DC power for both internal and external consumers.

The equipment space allows 19U of rack space ensuring well enough capacity for existing need and future expansion.

One of the main advantages of the Enclosure 6160 is its default integration with ENM - allowing for advanced remote monitoring and control such a fault management (alarms), inventory management and performance measurements. The cabinet also provides an open O&M interface for integration to 3PP O&M systems.




CAPACITY		
Rack space user equipment	19U (19" rack)	
Hardware capabilities	Power and CPRI support for multi-standard remote radios (RRU or AIR)	
	ERS Baseband and Transport units	
	Li-Ion batteries	
	3PP equipment	
	Additional power feed available as option	
MECHANICAL SPECIFICATION		
Weight	145 kg (excluding active equipment) 320 lbs (excluding active equipment)	
Dimension (H x W x D)	1600 x 650 x 650 mm (incl. Base frame) 63 x 26 x 26 in. (incl. Base frame)	
Base frame height	150 mm 6 in.	
Mounting position	Ground	
Enclosure material	Aluminum	
Color	Power paint NCS 2002-B	
Door	Front access	
Rack type	19" (IEC 60297-3-100)	
Locking type	Pad lock or Cylinder	
POWER SYSTEM		
Input voltage	3P+N+PE: 346/200-415/240 VAC 2P+N+PE: 208/120-220/127 VAC 1P+N+PE: 200-250 VAC	
Input power	<33kW	
Output load (-48VDC)	24kW	
Total capacity (-48VDC)	31.5kW	
AC SPD	Class 2/Type 2	
DC SPD	Class 2/Type 2	
PSU Slots	9x	
Service outlet	Optional	
Priority load	8x Circuit Breaker	
LLVD 1	6x Circuit Breaker	
LLVD 2	6x Circuit Breaker	
CB ratings	3A / 5A / 10A / 15A / 20A / 25A / 30A / 40A / 50A / 60A / 80A / 100A	
Battery Interface	2x Circuit Breaker	
Battery Circuit Breaker rating	125A 2pol (200A)	
PSU capacity	3500W	

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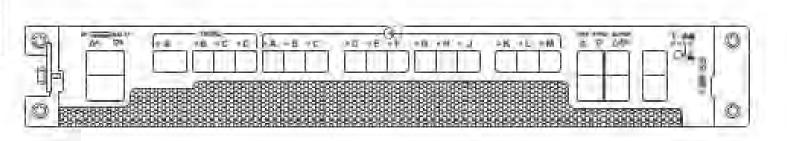
SHEET NUMBER:



NOKIA — CSR IXRE V2 ROUTER WEIGHT: 11.2 LBS. SIZE (HxWxD): 1.75x17.25x10.0 IN.

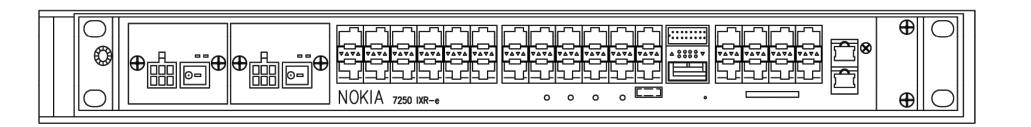PROPOSED CSR IXRE V2 DETAIL
SCALE: N.T.S.

MANUFACTURER	ERICSON	
MODEL NO:	RJP 6651	
DIMENSIONS:	TOTAL WEIGHT	
1.75*	TOTAL WEIGHT	
197	16.53 LBS (7.5 KG)	
13.85	(630 CB3 (7.3 N/s)	



PROPOSED RP 6651 DETAIL
SCALE: N.T.S.

SUPPLEMENTAL

SHEET NUMBER:

R-605



Power Protection Cabinet (PPC) 225A with Generator Input and AC Alarm

Product Features

- Single wall Aluminum enclosure
- Powder coated finish
- Pad lockable 3-point door latch
- Type 3R & IP55 rated
- Metal oxide varistor surge protection
- Camlok generator connection
- Main AC Input Detection Alarm





Specifications

Model / Part Number	4910163600	
1. General		
Construction	Single layer Aluminum enclosure, Type 3R	
Dimensions (W x H x D)	20.2 x 39 x 11.2 inch excludes generator connections 29.7 x 39 x 11.2 inch including RH Camlok generator box	
Weight	71 lbs (without packaging)	
Finish	Polyester Powder Paint	
Door Latch	3-Point latching, pad lockable	
Safety	UL50 (Cabinet) UL891 Dead Front Switchboard Listed Suitable for Use as Service Equipment (N-G Bonding kit included)	
2. Environment	The state of the s	
Operating temperature	-40°C to +46°C (-40°F to 115°F)	
Humidity (relative)	95%, non-condensing (Max.)	
Protection class	Type 3R	
3. AC Section		
Voltage	240/120 Single Phase (3 wire + Ground)	
Current	225A	
AIC Rating	Utility 65,000 Amps	
Otherstand	Generator Interface: Camlok Connections (Right Mount) Service Disconnect: Square D 225 Amp (65kAlC) Mechanica Slide Bar Interlock Load Center: Square D 225 Amp, QO Series, 24 Position Surge Protection Device (SPD) - 1 ea. AC2080M-02	
Other features	Square D 30 Amp, 2-Pole Breaker for SPD Ground Bar Silkscreen Dead-Front Lift Off Style Captive Dead-Front Fasteners Loss of AC Input Alarm	





www.deltapowersolutions.com

Delta Group Website: www.deltaww.com

Product Website:



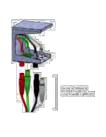

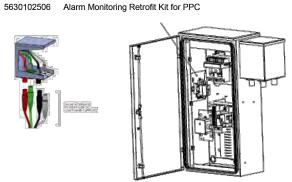



*Male Receptacle Twist Lock Panel Mount connectors (not included)

*All specifications are subject to change without prior notice.

EN_z23n2P17/ FH

www.deltaww.com

PROPOSED 225A PPC DETAIL

SUPPLEMENTAL

R-606



The NSB RED Battery® delivers long life for reliable and unreliable grid conditions.

- Pure lead electrochemistry greatly increases temp and State-of-the-art automated manufacturing ensures corrosion resistance, while reducing component aging
- Thin plates deliver large surface area, high power density and low resistance
- Design life 15+ years at 20°C (68°F)
- EUROBAT design life definition: Very Long Life (12+ years)
- Fast recharging
- Operating temperature range -40°C to +65°C (-40°F to
- consistency and reliability
- Shelf life of up to 24 months
- Advanced 3 stage terminal design to ensure leak-free operation - brass terminals provide maximum performance
- High modulus Polyphenylene Oxide (PPO) plastic materials designed to withstand extended elevated operating temperatures and maintain high battery compression essential for reliable operation
- Non-halogenated, thermally sealed plastic casing
- Flame retardant (UL 94 VO) and LOI of at least 28%
- Approved as non-hazardous cargo for ground, sea, and air transport - DOT 49CFR173.159(d), (i) and (ii)



NSB 190FT RED

Technical Specifications


Dimensions (Nominal)

Height	12.6 in	Width	4,9 in
Length	22 in	Weight	123 lbs

Electrical

Terminal	Female M8 x 1.25
Terminal torque	8.0 Nm (71 in-lbs)
1 hr capacity to 1.70VPC @ 20/25°C (68/77°F)	123 / 129 Ah
3 hr capacity to 1.75VPC @ 20/25°C (68/77°F)	160 / 164 Ah
8 hr capacity to 1.75VPC @ 20/25°C (68/77°F)	183 / 186 Ah
10 hr capacity to 1.80VPC @ 20/25°C (68/77°F)	187 / 190 Ah
Float voltage @ 20/25°C (68/77°F)	2.28 / 2.27 VPC
Impedance (1Khz)	2.8 mΩ @ 25°C (77°F)
Conductance	1900 S
Short arouit current	5000 A
Operation temperature range	-40°C to +65°C
Nominal Voltage	12 V

Technical Drawing

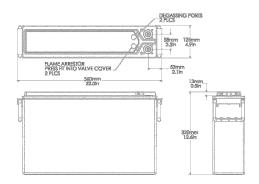

- Approved as non-hazardous cargo for ground, sea, and air transportation in accordance with US DOT Regulation 49 and ICAO & IATA Packing Instruction 806. Please see our SDS for complete details at www.enersys.com
- Complies with Telcordia® SR-4228, Network Equipment Building System (NEBS™) Criteria Levels
- The management systems governing the manufacture of this product are ISO 9001 and ISO 14001 certified

EnerSys World Headquarters 2366 Bernville Road Reading, PA 19605, USA Tel:+1-610-208-1991/+1-800-538-3627

Release date: 2021-09-05

Release date: 2021-09-05

SUPPLEMENTAL

REVISION:

PROPOSED NSB 190FT BATTERY DETAIL

Pxxx: Bulk Pipe



Part #	Length	OD x Length (in)
Schedule 40		
P260	5'-0"	2-3/8" x 60"
P263	5'-3"	2-3/8" x 63"
P272	6'-0"	2-3/8" x 72"
P284	7'-0"	2-3/8" x 84"
P296	8'-0"	2-3/8" x 96"
P2108	9'-0"	2-3/8" x 108"
P2120	10'-0"	2-3/8" x 120"
P2126	10'-6"	2-3/8" x 126"
P2150	12'-6"	2-3/8" x 150"
P2174	14'-6"	2-3/8" x 174"
P2252	21'-0"	2-3/8" x 252"
P3072	6'-0"	2-7/8" x 72"
P3084	7'-0"	2-7/8" x 84"
P3096	8'-0"	2-7/8" x 96"
P30108	9'-0"	2-7/8" x 108"
P30120	10'-0"	2-7/8" x 120"
P30126	10'-6"	2-7/8" x 126"
P30150	12'-6"	2-7/8" x 150"
P30174	14'-6"	2-7/8" x 174"
P30252	21'-0"	2-7/8" x 252"
P360	5'-0"	3-1/2" x 60"
P372	6'-0"	3-1/2" x 72"
2384	7'-0"	3-1/2" x 84"
P396	8'-0"	3-1/2" x 96"
P3150	12'-6"	3-1/2" x 150"
P3160	13'-4"	3-1/2" x 160"
P3174	14'-6"	3-1/2" x 174"
P3216	18'-0"	3-1/2" x 216"
P3252	21'-0"	3-1/2" x 252"
P472	6'-0"	4-1/2" x 72"
P4126	10'-6"	4-1/2" x 126"
P4252	21'-0"	4-1/2" x 252"



Features:

Factory cut end, hot-dip galvanized pipe

Construction:

- ASTM A53 Grade B
- Schedule 40 or Schedule 80

Design Criteria:


- ASTM A53 Grade B (Yield Fy = 35 ksi [240 MPa]/
- Tensile Fu = 60 ksi [415 MPa])
- Hot dip galvanized in accordance with ASTM A123 requirements

Part#	Length	OD x Length (in)	
Schedule 80			
P2252-80	21'	2-1/2" x 252"	
P30126-80	10'-6"	2-7/8" x 126"	
P30252-80	21'	2-7/8" x 252"	
P3252-80	21'	3-1/2" x 252"	

SitePro1.com 888-438-7761

1 PROPOSED 10' PIPE MOUNT DETAIL

SCALE: N.T.S.

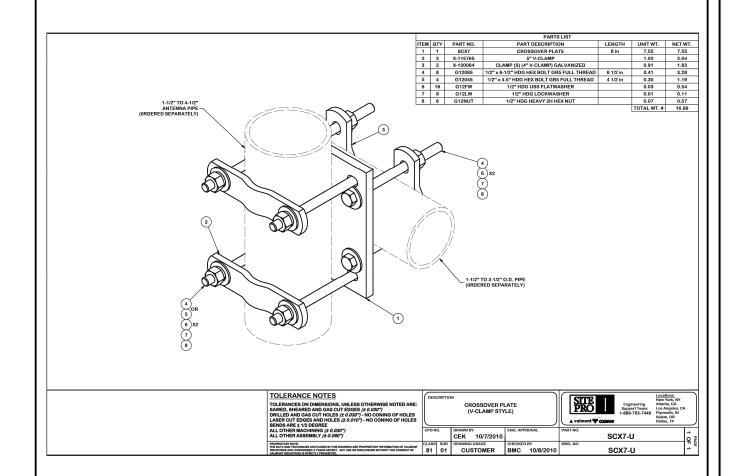

PROPOSED CROSSOVER PLATE KIT DETAIL

CALE: N.T.S.


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SUPPLEMENTAL

SHEET NUMBER:

R-608


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SUPPLEMENTAL

SHEET NUMBER:

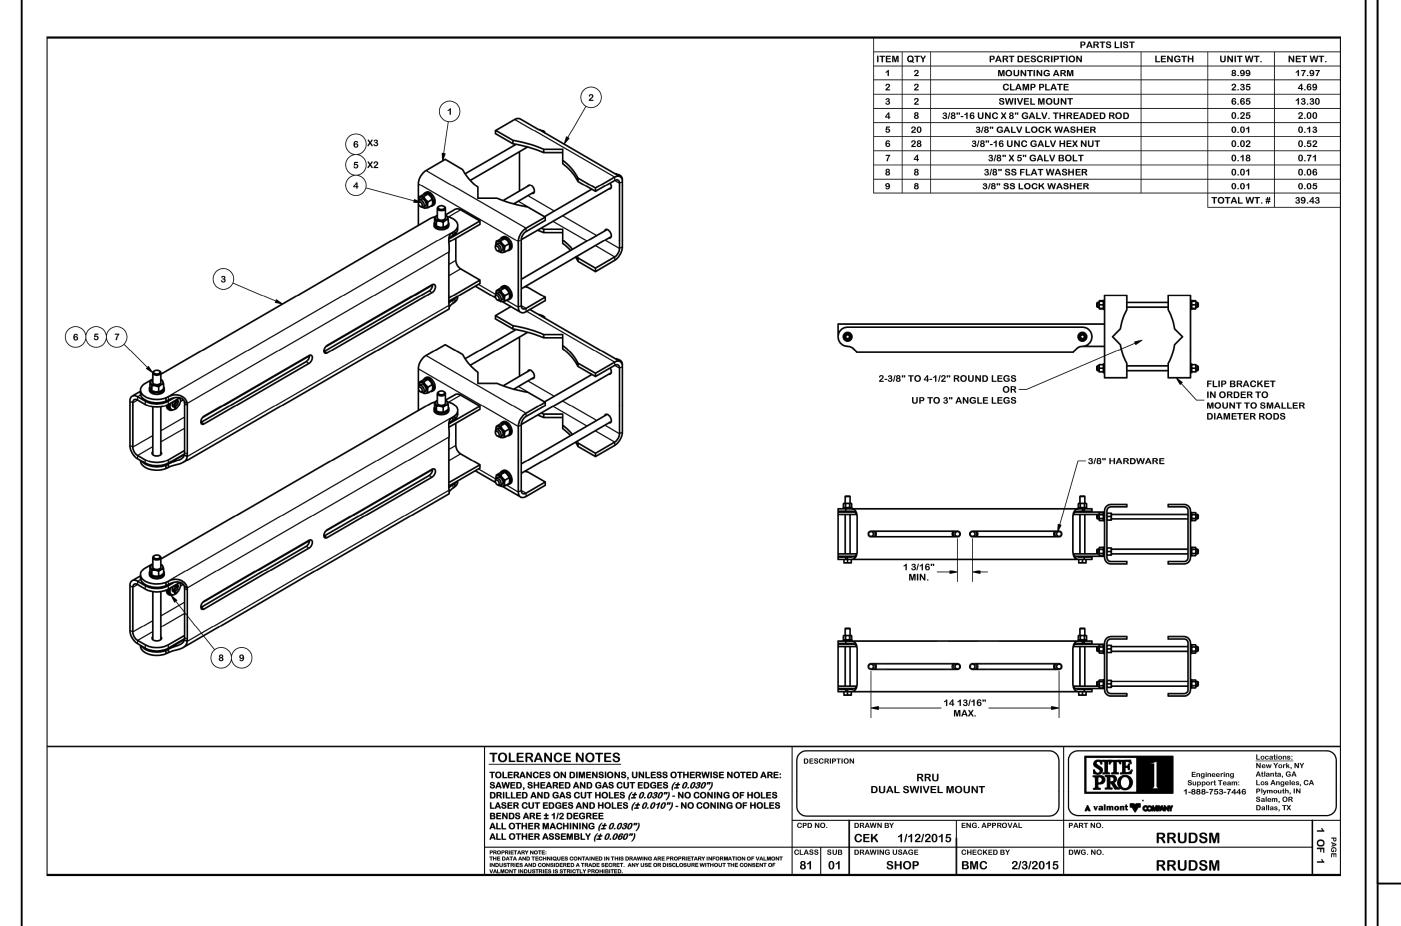R-609



SUPPLEMENTAL

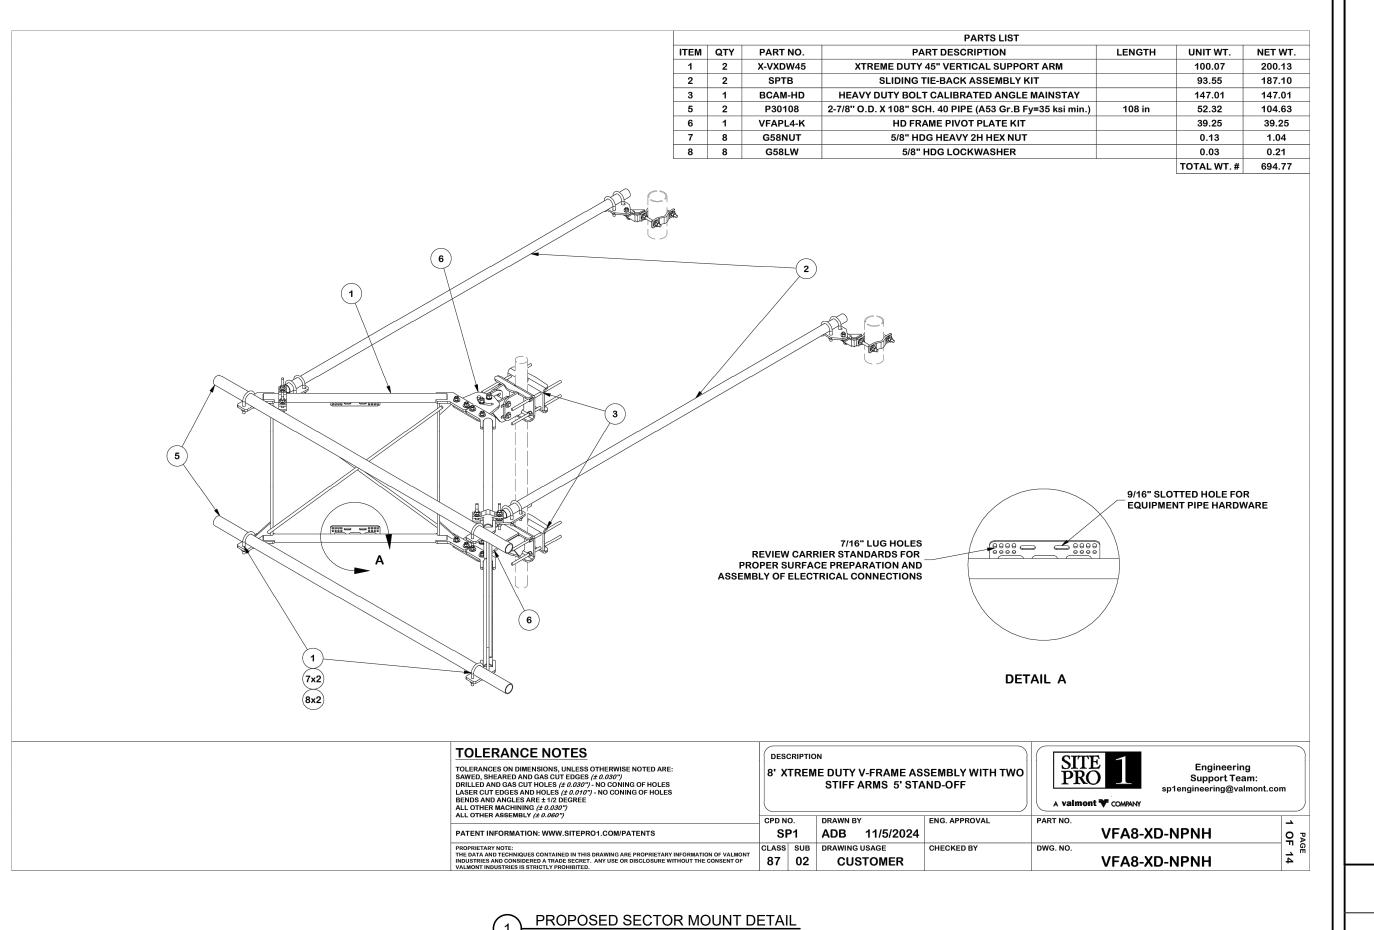SHEET NUMBER:

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R-610

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