
## Exhibit A

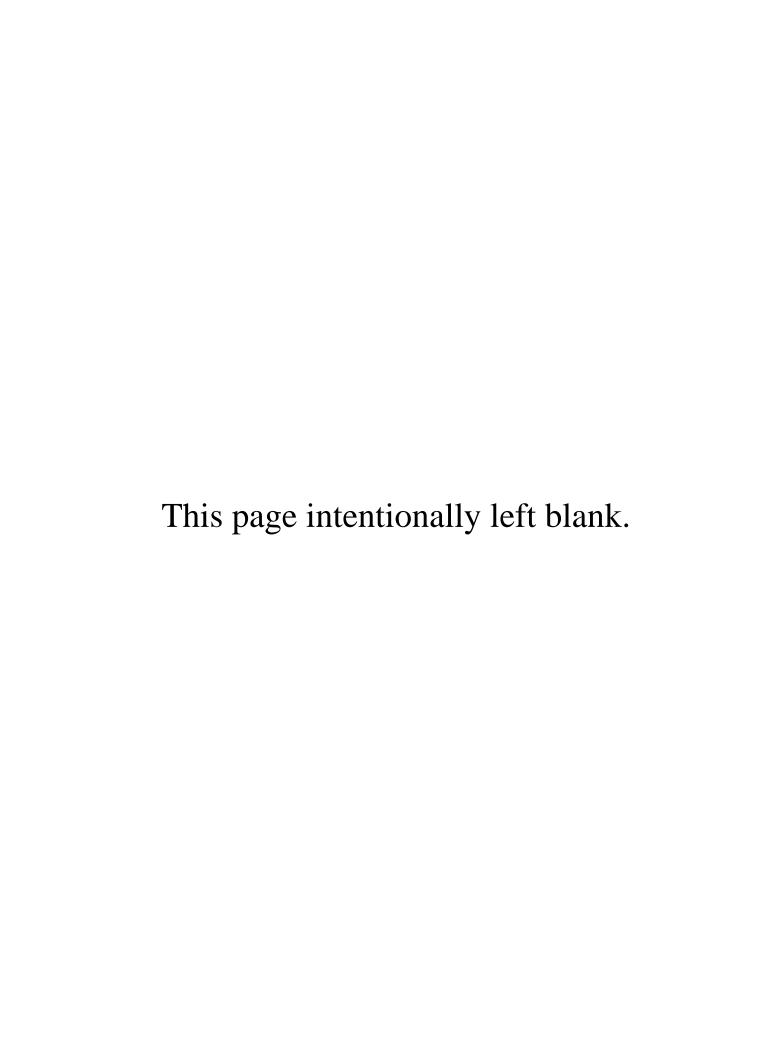

## **DRAFT RESOLUTION**

# Before the Zoning Administrator in and for the County of Monterey, State of California

In the matter of the application of:

CASTLEMAN MICHAEL S JR & CAROL K ET AL (PLN250071) RESOLUTION NO. 25-

Resolution by the County of Monterey Zoning Administrator:

- Find that the project qualifies as a Class 2
   Categorical Exemption pursuant to Section
   15302 of the CEQA Guidelines and there are no exceptions pursuant to Section 15300.2; and
- 2) Approve a Design Approval to allow demolition of a 1,870 square foot single-family dwelling and construction of a 4,705 square foot two-story single-family dwelling with attached garage, and associated site improvements.

1012 San Carlos Road, Pebble Beach, Greater Monterey Peninsula Area Plan (APN: 007-282-004-000)

The CASTLEMAN MICHAEL S JR & CAROL K ET AL application (PLN250071) came on for a public hearing before the County of Monterey Zoning Administrator on August 28, 2025. Having considered all the written and documentary evidence, the administrative record, the staff report, oral testimony, and other evidence presented, the Zoning Administrator finds and decides as follows:

## **RECITALS:**

**WHEREAS**, the proposed project PLN250071, located at 1012 San Carlos Road, Pebble Beach, Greater Monterey Peninsula Area Plan (APN: 007-282-004-000), is consistent with the policies of the Monterey County 2010 General Plan, Greater Monterey Peninsula Area Plan, and the Monterey County Zoning Ordinance (Title 21);

**WHEREAS**, the subject parcel is zoned Medium Density Residential, with Building Site – 6, Design Control, and Recreational Equipment Storage zoning overlays ("MDR/B-6-D-RES") which allows for the construction of the first single family dwelling on a legal lot of record subject to the granting of a Design Approval;

**WHERERAS**, as the proposed, the project consists of the demolition of a 1,870 square foot single-family dwelling and construction of a 4,705 square foot two-story single-family dwelling with attached garage, and associated site improvements. Site improvements include an 85 square foot covered entry, 305 square foot covered terrace, rear fire pit/patio area, walkways, internal fences, replacement paver driveway, roof-mounted photovoltaic system, and grading consisting of 75 cubic yards cut and 140 cubic yards of fill.;

WHEREAS, as detailed in the attached plans, the proposed project meets all requirement development standards established in Monterey County Code (MCC) Section 21.12.060 and 2010 General Plan Policy LU-2.33(a);

**WHEREAS**, the proposed colors and materials, and bulk and mass blend with the surrounding environment, are consistent with the surrounding residential neighborhood character, and other dwellings in the neighborhood;

**WHEREAS**, as sited, designed, and conditioned, the proposed project is not located in an area of high visual sensitivity, will not result in adverse visual impacts, and the project is consistent with the applicable scenic resource policies of the 2010 General Plan and the Greater Monterey Peninsula Area Plan;

WHEREAS, in accordance with 2010 General Plan Policy and MCC Section 21.66.050, a Phase I Archaeological Report was prepared by Susan Morley, dated February 2022 and January 2023 (County of Monterey Library No. LIB2500057). The developed site has undergone moderate to high use, resulting in moderate to high ground disturbance from at least 1955 to the present. No precontact site indicators were observed within the project area. The project Archaeologist found that "[p]ursuant to public resources code 15064.5(c)(4), the results of the Phase I assessment indicate the proposed Project will have no effect on archaeological resources, resulting in no impact on the environment." Therefore, the potential for inadvertent impacts to cultural resources is limited and will be controlled by application of the County's standard project condition (Condition No. 3), which requires the contractor to stop work if previously unidentified resources are discovered during demolition or construction;

WHEREAS, the prepared Phase I Historical Report (County of Monterey Library No. LIB250059) found that the existing 1955-circa residence, slated for demolition, does not retain any historical significance;

WHEREAS, the subject property (0.31 acres) is identified as Lot 16 of Block 216 of the Monterey Peninsula Country Club #2, as shown on Page 29, Volume 3 of Cities and Towns, and is therefore recognized by the Country as a legal lot of record;

**WHEREAS**, Monterey County HCD-Planning and HCD-Building Services records were reviewed, and the County is not aware of any violations existing on the subject property;

**WHEREAS**, the project was referred to the Del Monte Forest Land Use Advisory Committee pursuant to Board of Supervisors' adopted LUAC Guidelines, at which the LUAC on August 21, 2025 voted unanimously to support the project as proposed;

WHEREAS, California Environmental Quality Act (CEQA) Guidelines Section 15302 categorically exempts replacement or reconstruction of existing structures where the new structure(s) will be located on the same site as the structure(s) replaced and will have substantially the same purpose and capacity as the structure(s) replaced. The project involves the construction of a replacement single family dwelling (same capacity and purpose), and therefore, the proposed development is consistent with CEQA Guidelines Section 15302, and none of the exceptions under CEQA Guidelines Section 15300.2 apply to this project; and

**WHEREAS**, pursuant to MCC Section 21.80.040.B, the Planning Commission shall consider appeals from the discretionary decisions of the Zoning Administrator and the decision of the Planning Commission would be final and may not be appealed.

**NOW, THEREFORE BE IT RESOLVED**, based on the above recitals, the County of Monterey Zoning Administrator does hereby:

- 3) Find that the project qualifies as a Class 2 Categorical Exemption pursuant to Section 15302 of the CEQA Guidelines and there are no exceptions pursuant to Section 15300.2; and
- 4) Approve a Design Approval to allow demolition of a 1,870 square foot single-family dwelling and construction of a 4,705 square foot two-story single-family dwelling with attached garage, and associated site improvements.

**PASSED AND ADOPTED** this 28<sup>th</sup> day of August 2023.

	Mike Novo, Zoning Administrator
COPY OF THIS DECISION MAILED TO APPLICA	NT ON
THIS APPLICATION IS APPEALABLE TO THE PL WISHES TO APPEAL THIS DECISION, AN APPEA SUBMITTED TO THE SECRETARY OF THE PLAN APPROPRIATE FILING FEE ON OR BEFORE	AL FORM MUST BE COMPLETED AND NNING COMMISSION ALONG WITH THE
This decision, if this is the final administrative decision	n, is subject to judicial review pursuant to California

## **NOTES**

1. You will need a building permit and must comply with the Monterey County Building Ordinance in every respect.

Code of Civil Procedure Sections 1094.5 and 1094.6. Any Petition for Writ of Mandate must be filed with

the Court no later than the 90th day following the date on which this decision becomes final.

2. Additionally, the Zoning Ordinance provides that no building permit shall be issued, nor any use conducted, otherwise than in accordance with the conditions and terms of the permit granted or until ten days after the mailing of notice of the granting of the permit by the appropriate authority, or after granting of the permit by the Board of Supervisors in the event of appeal.



## **County of Monterey HCD Planning**

# DRAFT Conditions of Approval/Implementation Plan/Mitigation Monitoring and Reporting Plan

PLN250071

#### 1. PD001 - SPECIFIC USES ONLY

**Responsible Department:** 

**Planning** 

Condition/Mitigation Monitoring Measure: This Design Approval allows demolition of a 1,870 square foot single family dwelling and construction of a 4,705 square foot two-story single family dwelling with attached garage, and associated site improvements. The property is located at 1012 San Carlos Road, Pebble Beach (Assessor's Parcel Number 007-282-004-000), Greater Monterey Peninsula Area Plan. This permit was approved in accordance with County ordinances and land use regulations subject to the terms and conditions described in the project file. Neither the uses nor the construction allowed by this permit shall commence unless and until all of the conditions of this permit are met to the satisfaction of the Director of HCD - Planning. Any use or construction not in substantial conformance with the terms and conditions of this permit is a violation of County regulations and may result in modification or revocation of this permit and subsequent legal action. or construction other than that specified by this permit is allowed unless additional permits are approved by the appropriate authorities. To the extent that the County has delegated any condition compliance or mitigation monitoring to the Monterey County Water Resources Agency, the Water Resources Agency shall provide all information requested by the County and the County shall bear ultimate responsibility to ensure that conditions and mitigation measures are properly fulfilled. (HCD - Planning)

Compliance or Monitoring Action to be Performed:

The Owner/Applicant shall adhere to conditions and uses specified in the permit on an on-going basis unless otherwise stated.

### 2. PD002 - NOTICE PERMIT APPROVAL

Responsible Department:

**Planning** 

Condition/Mitigation
Monitoring Measure:

The applicant shall record a Permit Approval Notice. This notice shall state:

"A Design Approval (Resolution Number \_\_\_\_\_\_) was approved by County of Monterey Zoning Administrator for Assessor's Parcel Number 007-282-004-000 on August 28, 2025. The permit was granted subject to 7 conditions of approval which run with the land. A copy of the permit is on file with Monterey County HCD - Planning."

3.

Proof of recordation of this notice shall be furnished to the Director of HCD - Planning prior to issuance of grading and building permits, Certificates of Compliance, or commencement of use, whichever occurs first and as applicable. (HCD - Planning)

Compliance or Monitoring Action to be Performed: Prior to the issuance of grading and building permits, certificates of compliance, or commencement of use, whichever occurs first and as applicable, the Owner/Applicant shall provide proof of recordation of this notice to the HCD - Planning.

Print Date: 8/4/2025 7:35:41PM Page 1 of 4

#### 3. PD003(A) - CULTURAL RESOURCES NEGATIVE ARCHAEOLOGICAL REPORT

#### **Responsible Department:**

Planning

#### Condition/Mitigation Monitoring Measure:

during course of construction, cultural, archaeological, paleontological resources are uncovered at the site (surface or subsurface resources) work shall be halted immediately within 50 meters (165 feet) of the find until a qualified professional archaeologist can evaluate it. Monterey County HCD - Planning and a archaeologist (i.e., archaeologist registered qualified an with the Register immediately Professional Archaeologists) shall be contacted by the responsible individual present on-site. When contacted, the project planner and the archaeologist shall immediately visit the site to determine the extent of the resources and to develop proper mitigation measures required for recovery. (HCD - Planning)

#### Compliance or Monitoring Action to be

Performed:

The Owner/Applicant shall adhere to this condition on an on-going basis.

Prior to the issuance of grading or building permits and/or prior to the recordation of the final/parcel map, whichever occurs first, the Owner/Applicant shall include requirements of this condition as a note on all grading and building plans. The note shall state "Stop work within 50 meters (165 feet) of uncovered resource and contact Monterey County HCD - Planning and a qualified archaeologist immediately if cultural, archaeological, historical or paleontological resources are uncovered."

When contacted, the project planner and the archaeologist shall immediately visit the site to determine the extent of the resources and to develop proper mitigation measures required for the discovery.

#### 4. PD011 - TREE AND ROOT PROTECTION

#### Responsible Department:

**Planning** 

#### Condition/Mitigation Monitoring Measure:

Trees which are located close to construction site(s) shall be protected from inadvertent damage from construction equipment by fencing off the canopy driplines and/or critical root zones (whichever is greater) with protective materials, wrapping trunks with protective materials, avoiding fill of any type against the base of the trunks and avoiding an increase in soil depth at the feeding zone or drip-line of the retained trees. Said protection, approved by certified arborist, shall be demonstrated prior to issuance of building permits subject to the approval of HCD - Director of Planning. If there is any potential for damage, all work must stop in the area and a report, with mitigation measures, shall be submitted by certified arborist. Should any additional trees not included in this permit be harmed, during grading or construction activities, in such a way where removal is required, the owner/applicant shall obtain required permits. (HCD - Planning)

#### Compliance or Monitoring Action to be Performed:

Prior to issuance of grading and/or building permits, the Owner/Applicant shall submit evidence of tree protection to HCD - Planning for review and approval.

During construction, the Owner/Applicant/Arborist shall submit on-going evidence that tree protection measures are in place through out grading and construction phases. If damage is possible, submit an interim report prepared by a certified arborist.

Prior to final inspection, the Owner/Applicant shall submit photos of the trees on the property to HCD-Planning after construction to document that tree protection has been successful or if follow-up remediation or additional permits are required.

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#### 5. PD012(D) - LANDSCAPE PLAN & MAINTENANCE (MPWMD-SFD ONLY)

#### **Responsible Department:**

Planning

Condition/Mitigation Monitoring Measure:

The site shall be landscaped. Prior to the issuance of building permits, three (3) copies of a landscaping plan shall be submitted to the Director of HCD - Planning . A landscape plan review fee is required for this project. Fees shall be paid at the time of landscape plan submittal. The landscaping plan shall be in sufficient detail to identify the location, species, and size of the proposed landscaping materials and shall include an irrigation plan. The plan shall be accompanied by a nursery or contractor's estimate of the cost of installation of the plan. Before occupancy, landscaping shall be either installed or a certificate of deposit or other form of surety made payable to Monterey County for that cost estimate shall be submitted to the Monterey County HCD - Planning. All landscaped areas and fences shall be continuously maintained by the applicant; all plant material shall be continuously maintained in a litter-free, weed-free, healthy, growing condition. (HCD - Planning)

Compliance or Monitoring Action to be Performed:

Owner/Applicant/Licensed Prior to issuance of building permits, Landscape the Contractor/Licensed Landscape Architect shall submit landscape plans and contractor's estimate to HCD - Planning for review and approval. Landscaping plans shall include the recommendations from the Forest Management Plan or Biological Survey as applicable. All landscape plans shall be signed and stamped by licensed professional under the following statement, "I certify that this landscaping and irrigation plan complies with all Monterey County landscaping requirements including use of non-invasive species; drought-tolerant, limited turf; and low-flow. conserving irrigation fixtures."

Prior to issuance of building permits, the Owner/Applicant/Licensed Landscape Contractor/Licensed Landscape Architect shall submit one (1) set landscape plans of approved by HCD-Planning, a Maximum Applied Water Allowance (MAWA) calculation, and a completed "Residential Water Release Form and Water Permit Application" to the Monterey Peninsula Water Management District for review and approval.

Prior to issuance of building permits, the Owner/Applicant/Licensed Landscape Contractor/ shall submit an approved water permit from the MPWMD to HCD-Building Services.

Prior to occupancy, the Owner/Applicant/Licensed Landscape Contractor/Licensed Landscape Architect shall ensure that the landscaping shall be either installed or a certificate of deposit or other form of surety made payable to Monterey County for that cost estimate shall be submitted to Monterey County HCD - Planning.

On an on-going basis, all landscaped areas and fences shall be continuously maintained by the Owner/Applicant; all plant material shall be continuously maintained in a litter-free, weed-free, healthy, growing condition.

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#### 6. PD014(A) - LIGHTING - EXTERIOR LIGHTING PLAN

#### Responsible Department:

Planning

#### Condition/Mitigation Monitoring Measure:

All exterior lighting shall be unobtrusive, down-lit, harmonious with the local area, and constructed or located so that only the intended area is illuminated and off-site glare is fully controlled. The lighting source shall be shielded and recessed into the fixture. The applicant shall submit three (3) copies of an exterior lighting plan which shall indicate the location, type, and wattage of all light fixtures and include catalog sheets for each fixture. The lighting shall comply with the requirements of the California Energy Code set forth in California Code of Regulations Title 24 Part 6. The exterior lighting plan shall be subject to approval by the Director of HCD - Planning, prior to the issuance of building permits.

(HCD - Planning)

#### Compliance or Monitoring Action to be Performed:

Prior to the issuance of building permits, the Owner/Applicant shall submit three copies of the lighting plans to HCD - Planning for review and approval. Approved lighting plans shall be incorporated into final building plans.

Prior to final/occupancy, the Owner/Applicant/Contractor shall submit written and photographic evidence demonstrating that the lighting has been installed according to the approved plan.

On an on-going basis, the Owner/Applicant shall ensure that the lighting is installed and maintained in accordance with the approved plan.

#### 7. PD041 - HEIGHT VERIFICATION

#### Responsible Department:

**Planning** 

#### Condition/Mitigation Monitoring Measure:

The applicant shall have a benchmark placed upon the property and identify the benchmark on the building plans. The benchmark shall remain visible on-site until final building inspection. The applicant shall provide evidence from a licensed civil engineer or surveyor to the Director of HCD - Building Services for review and approval, that the height of the structure(s) from the benchmark is consistent with what was approved on the building permit associated with this project. (HCD - Planning and HCD - Building Services)

#### Compliance or Monitoring Action to be Performed:

Prior to the issuance of grading or building permits, the Owner/Applicant shall have a benchmark placed upon the property and identify the benchmark on the building plans. The benchmark shall remain visible onsite until final building inspection.

Prior to the foundation pre-pour inspection, the Owner/Applicant shall provide evidence from a licensed civil engineer or surveyor, to the Director of HCD - Building Services for review and approval, that the height of first finished floor from the benchmark is consistent with what was approved on the building permit.

Prior to the final inspection, the Owner/Applicant/Engineer shall provide evidence from a licensed civil engineer or surveyor, to the Director of HCD - Building Services for review and approval, that the height of the structure(s) from the benchmark is consistent with what was approved on the building permit.

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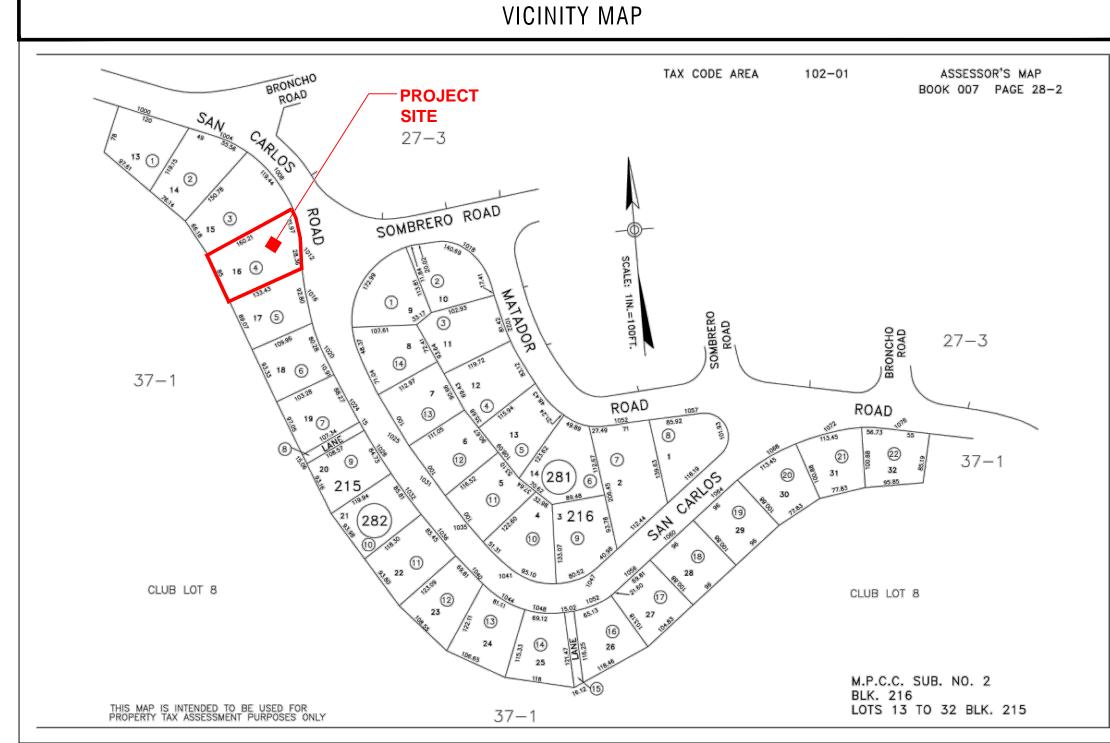
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## GENERAL CONDITIONS

- 1. Examination of the site and portions thereof which will affect this work shall be made immediately by the contractor, who shall compare it with the drawings and satisfy himself to conditions under which work is to be performed. He shall at such time ascertain and check locations of the existing structures and equipment which may affect his work.
- 2. Contractor shall provide a complete cost breakdown and schedule of construction for this project for owner approval prior to commencement of work.
- 3. Contractor shall be responsible to obtain and all necessary permits inspections, certificates, lien releases, final inspections, etc. Contractor to coordinate payment of permits with owner.
- 4. Contractor shall protect owner's area, new and/or existing materials and finishes from damage which may occur from construction, demolition, dust, water, etc., and shall provide and maintain temporary barricades, closure walls, etc., as required to protect the public and owner during the period of construction. Damage to new and existing materials, finishes, structures, and equipment shall be repaired or replaced. Contractor shall coordinate temporary barricades with owner prior to commencement of work as necessary.
- 5. Materials that are specified by their brand names establish standards of quality and performance. any request for substitution shall be submitted to Moore Design llc and owner for review for equal quality and performance and shall not be purchased or installed without their written approval. All non-specified products shall conform to requirements set forth by code compliance or industry standards and contractor shall submit a list of products and manufacturers being used for review by the designer prior to purchase or installation.
- 6. All construction work, architectural, mechanical, plumbing, electrical, etc., as may be required, shall conform to the latest edition of the California Building Code/ California Residential Code and the latest edition of all governing codes and regulations as adopted by the governing jurisdiction. All work shall be done in a thorough, workmanlike manner and equal to the best standards of the practice.
- 7. All dimensions on constructions drawings are face of stud (f.o.s.), face of cmu, unless otherwise noted to be the center line of mullion, partition, or column, etc.
- 8. All dimensions take precedence over scale. Any discrepancies shall be brought immediately to the attention of Moore Design. Contractors shall not scale drawings. Questions regarding dimensions shall be brought to the designer or
- 9. All construction documents are complementary, and what is called for by any will be binding as if called for by all. Any work shown or referred to on any construction documents shall be provided as though on all related documents. Discrepancies shall be brought immediately to the attention of the designer for clarification.
- 10. All work listed, shown or implied on any construction document shall be supplied and installed by the contractor except where noted. The contractor shall closely coordinate his work with that of other contractors or vendors to assure that all schedules are met and that all work is done in conformance with manufacturer's requirements. Work required under this contract shall include all labor, materials, equipment, etc. necessary to complete this project. All materials shall be new and unused, unless specifically noted and be a quality acceptable by industry standards.
- 11. The use of the word "provide" in connection with any item specified is intended to mean that such shall be furnished, installed, and connected where so required, except as noted.
- 12. The contractor shall submit shop drawings for fabricated items, cut sheets of all fixtures and equipment, and samples of all finishes called for by the designer and owner for approval prior to construction and/or installation.
- 13. The contractor shall maintain a current and complete set of construction documents on the job site during all phases of construction for use of all trades and shall provide all subcontractors with current construction documents as required. The contractor, in assuming responsibility for the work indicated, shall comply with the spirit as well as with the letter in which they were drawn.
- 14. The contractor shall remove all rubbish and waste materials of all subcontractors and trades on a regular basis, and shall exercise strict control over job cleaning to prevent any dirt, debris or dust from affecting, in any way, finished
- 15. The construction documents are provided to illustrate the design and general type of construction desired and imply the finest quality of construction, material and workmanship throughout.
- 16. All electrical, mechanical, and plumbing work and materials shall be in full accordance with the latest rules and regulations of the national board of fire underwriters, the state fire marshall, the safety orders of the division of industrial safety, and any applicable state or local laws and ordinances. Nothing on these drawings is to be construed to permit work not conforming to these codes.
- 17. Work which is obviously required to be performed in order to provide a completely operable installation within the limits and scope of work, but which may not be specifically included in the plans, shall be performed by contractor
- 18. All work shall be guaranteed against defects in design, installation and material for a minimum period of one year from date of completion.
- 19. Contractor shall personally supervise and direct the work or shall keep a competent employee, authorized to receive instructions and act on the contractor's behalf, continuously on site during working hours.
- 20. Trees adjacent to structures and over driveways shall be trimmed to clear structures and provide 15' clearance over drives. Protect other trees during construction (see forest mgt. plan). No tree shall be removed unless called for in the plans and a permit is first issued by the local jurisdiction.

## ABBREVIATIONS AND SYMBOLS

			ADDIT	L V 1/ \ 1 1	ONO AND OTHERE		
APPROX.	APPROXIMATE	0.C.	ON CENTER	1		A	ODCEMON.
BLK.	BLOCK	0.D.	OUTSIDE DIAMETER	(A)—	WALL LINE	$\longleftrightarrow$	SECTION
CLO.	CLOSET	PLYWD	PLYWOOD	$\cup$	NUMBERS VERTICAL	$\bigcirc$	SECTION IDENTIFICATION
CONC.	CONCRETE	REF	REFRIGERATOR		LETTERS HORIZONTAL		SHEET WHERE SECTION IS DRAWN
CONT.	CONTINUOUS	R.O.	ROUGH OPENING				
OS	DOWNSPOUT	SHWR	SHOWER		DOODE CYMDOL NUMBERC	$\triangle$	
OW	DISHWASHER	SIM	SIMILAR	(1)	DOORS SYMBOL NUMBERS	$\leftarrow$	<u>ELEVATION</u>
E)	EXISTING	SL	SKYLIGHT	^		$\bigcirc$	ELEVATION IDENTIFICATION
7.0.C.	FACE OF CONCRETE	T&G	TONGUE AND GROOVE	<b>\(1\)</b>	WINDOW TYPE-NUMBERS		SHEET WHERE ELEVATION IS DRAWN
7.0.S.	FACE OF STUD	T.O.P.	TOP OF PLATE	~			
GALV.	GALVANIZED	TYP.	TYPICAL		DETAIL NUMBER	^ /	LAMONTA AMONTO
GYP.	GYPSUM	U.O.N.	UNLESS OTHERWISE	$\bigcup$	SHEET WHERE DETAIL IS LOCATED	$\triangle$ (	REVISIONS-NUMBERS
G.W.B.	GYPSUM WALLBOARD	NOTED				(	CLOUD AROUND REVISION OPTIONAL
FLR	FLOOR	WP	WATERPROOF			`	www
łDWD	HARDWOOD	W/	WITH	$\langle 1 \rangle$	SHEET NOTE		-
V.I.C.	NOT IN CONTRACT	W/O	WITHOUT	\'		+8'-0"	CEILING HEIGHT
V.T.S.	NOT TO SCALE	W.LC.	WALK IN CLOSET				



# THE CASTLEMAN RESIDENCE

PEBBLE BEACH,



MIKE & CAROL CASTLEMAN

1012 SAN CARLOS ROAD PEBBLE BEACH, CA 93953

EMAIL: john@mooredesign.org

EMAIL: KRISTEN@KINTERIORS.COM

NINA CAPRIOLA LANDSCAPE DESIGN CONTACT: NINA CAPRIOLA

KRISTEN PENA INTERIORS CONTACT: KRISTEN PENA 4071 24TH STREET SAN FRANCISCO, CA. 94114 OFFICE (415) 896-4204 CELL (415) 244-1411

TEL (831) 595-7053 EMAIL: ninacapriola@gmail.com

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MONTERRACONSTRUCTION@COMCAST.NET

BUTANO GEOTECHNICAL ENGINEERING, INC.

EMAIL: GREG@BUTANOGEOTECH.COM

MONTEREY, CA 93940

CONTACT: GREG BLOOM

WATSONVILLE, CA 95076

LANDSET ENGINEERS, INC.

CONTACT: GUY GIRAUDO

520 CRAZY HORSE RD.

SALINAS, CA 93907

TEL (831) 443-6970

FAX (831) 443-3801

MONTEREY ENERGY GROUP

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CARMEL, CA. 93923

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404 WESTRIDGE DRIVE

TEL (831) 724-2612

TEL (831) 760-0218 LIC. # 772807

512-699-7581

MOORE DESIGN INC. CONTACT: JOHN MOORE 550 FIGUEROA STREET, SUITE B MONTEREY, CA. 93940 OFFICE (831) 642-9732 CELL (831) 238-6868

### SHEET INDEX PROJECT DIRECTORY

**DESIGNER:** 

■ INTERIOR DESIGNER:

■ LANDSCAPE DESIGNER:

■ GENERAL CONTRACTOR:

■ GEOTECHNICAL ENGINEER:

■ STRUCTURAL ENGINEER

■ TITLE 24 CONSULTANT:

ARCHITECTURAL	
A0.1	COVER SHEET
A1.1	SITE PLAN
L.1	LANDSCAPE PLAN
L.2	FUEL MANAGEMENT PLAN
C1	GRADING DRAINAGE & UTILITY PLAN
C2	GRADING SECTIONS
C3	EROSION & SEDIMENT CONTROL PLAN
C4	CONSTRUCTION MANAGEMENT PLAN
A2.1	MAIN FLOOR PLAN
A2.2	UPPER FLOOR PLAN
A2.3	ROOF PLAN
A4.0	COLOR RENDERINGS
A4.1	EXTERIOR ELEVATIONS
A4.2	EXTERIOR ELEVATIONS

## CAL GREEN NOTES

- 1. Irrigation Controllers- Automatic irrigation controllers installed at the time of final inspection shall be weathered-based.
- 2. Rodent Proofing- Protect annular spaces around pipes, electrical cables, conduits or other openings at exterior walls against passage of rodents. CGBC 4.406.1
- 3. Construction Waste Management- Recycle and/or salvage for reuse a minimum of 65% of the nonhazardous construction and demolition waste in accordance with the CGBC Sec. 4.408.1
- 4. Covering of Mechanical Equipment & Ducts- Cover duct openings and other air related air distribution component openings during storage, construction and until final start up with tape, plastic, or other acceptable method. CGBC
- Adhesives, sealants and caulks- Adhesives, sealants and caulks used on the project shall be compliant with VOC and other toxic compound limits. CGBC 4.504.2.1
- Paint and Coatings- Paint, stains and other coatings used on the project shall be compliant with VOC limits. CGBC
- Aerosol paints and coatings- Aerosol paints and coatings used on the project shall be compliant with product weighted MIR limits for ROC and other toxic compounds. Documentation shall be provided to verify compliant VOC limit finish materials have been used. CGBC 4.504.2.3. Verification of compliance shall be provided.
- Carpet Systems- All carpet and carpet systems installed shall be compliant with VOC limits. CGBC 4.504.3 Resilient Floor Systems- 80% of the floor area receiving resilient floorings shall comply with the VOC emission limits defined in the Collaborative for High Performance Schools (CHPS) low-emitting materials list or be certified under the Resilient Floor Covering Institute (RFCI) FloorScore program. CGBC 4.504.4
- 10. Composite Wood Products- Particleboard, Medium density fiberboard (MDF) and hardwood plywood used in interior finish systems shall comply with low formaldehyde emission standards. CGBC 4.504.5
- 11. Foundation: Capillary Break- A 4" thick of 1/2" or larger clean aggregate shall be installed with a vapor retarder in direct contact with concrete. CGBC 4.505.2.1
- 12. Moisture Content of Building Materials- Building materials with visible signs of water damage shall not be installed. Wall and floor framing shall not be enclosed when the framing members exceed 19% moisture content. CGBC 4.505.3
- 13. Bathroom Exhaust Fans- Each bathroom shall be mechanically ventilated with an Energy Star exhaust fan and the fan must be controlled by a humidstat capable of adjustment between a relative humidity range of < 50% to a maximum of
- 14. Heating and Air-Conditioning System Design- HVAC systems shall be sized, designed and their equipment sized per CGBC 4.507.2. HVAC system installer must be trained and certified and special inspectors employed by the enforcing

## PLANNING CONDITIONS

## PD003(A) - CULTURAL RESOURCES NEGATIVE ARCHAEOLOGICAL REPORT

If, during the course of construction, cultural, archaeological, historical or paleontological resources are uncovered at the site (surface or subsurface resources) work shall be halted immediately within 50 meters (165 feet) of the find until a qualified professional archaeologist can evaluate it. Monterey County RMA - planning and a qualified archaeologist (i.e., an archaeologist registered with the register of professional archaeologists) shall be immediately contacted by the responsible individual present on-site. When contacted, the project planner and the archaeologist shall immediately visit the site to determine the extent of the resources and to develop proper mitigation measures required for recovery.

## PD014(A) - LIGHTING - EXTERIOR LIGHTING PLAN

All exterior lighting shall be unobtrusive, down-lit, harmonious with the local area, and constructed or located so that only the intended area is illuminated and off-site glare is fully controlled. The lighting source shall be shielded and recessed into the fixture. The applicant shall submit three (3) copies of an exterior lighting plan which shall indicate the location, type, and wattage of all light fixtures and include catalog sheets for each fixture. The lighting shall comply with the requirements of the California Energy Code set forth in California Code of Regulations Title 24 part 6. The exterior lighting plan shall be subject to approval by the director of RMA - Planning, prior to the issuance of building permits.

# BUILDING DEPARTMENT NOTES

- No person may tap into any fire hydrant other than fire suppression or emergency aid, without first obtaining written approval from the water purveyor supplying water to the hydrant and from the monterey county health department.
- All hoses used in connection with any construction activities shall be equipped with a nozzle shut-off. when an automatic shut-off nozzle can be purchased or otherwise obtained for the size or type of hose in use, the nozzle shall be an automatic shut-off nozzle.
- 3. No potable water may be used for compaction or dust control purposes in construction activities where there is a reasonably available source of reclaimed or other sub-potable water approved by the monterey county health department and appropriate
- The use of solders containing more than 2/10ths of 1% lead in making joints on private or public water supply systems is
- 5. Provide non-removable backflow devices at all hosebibs.

## PROJECT INFORMATION

	PROJECT ADDRESS:		1012 SAN CARLOS ROAD PEBBLE BEACH, CA 93953			
	A.P.N.	007-282-00	04-000			
	PROJECT SCOPE:	STORY RES	DEMOLISH EXISTING RESIDENCE & GARAGE (1,870 SF), NEW 2 STORY RESIDENCE WITH ATTACHED 2-CAR GARAGE (4,705 SF), NEW COVERED ENTRY (85 SF) AND REAR COVERED TERRACE (305 SF), NEW PHOTOVOLTAIC SYSTEM, NEW FENCES			
	PROJECT VALUATION:	\$1,850,000				
	RELATED PERMIT	NONE				
-	PROJECT CODE COMPLIANCE:	Building Co California P California E Standards (	2022 - Title 24, California Residential Code (CRC), California Building Code (CBC), California Mechanical Code (CMC), California Plumbing Code (CPC), California Electrical Code (CEC) California Energy Code (CEnC), California Green Building Standards Code (CALGREEN), California Fire Code (CFC), Monterey Co. Code Local Amendments			
	ZONE:	MDR/B-6-D	MDR/B-6-D			
	YEAR CONSTRUCTED:	1955	1955			
	MAX BLDG. HT:	26'-7" (27'-0	26'-7" (27'-0" ALLOWED)			
	CONSTR. TYPE:	TYPE V-B	TYPE V-B			
	OCCUPANCY:	R-3 (RESID)	R-3 (RESIDENTIAL), U			
	FIRE SPRINKLERS	REQUIRED 1	REQUIRED NFPA-13D			
	WATER SYSTEM:	CAL AM				
	SEWER SYSTEM:	PBCSD				
	TREE REMOVAL:	NONE				
	TOPOGRAPHY:	FLAT				
	GRADING:	T.B.D				
	LOT SIZE:	.31 ACRES	.31 ACRES / 13,529 SF			
	LOT COVERAGE	EXISTING	DEMO	NEW	PROPOSED	
	RESIDENCE	1,383	-1,383	2,703	2,703	
	GARAGE	487	-487	779	779	
	SECOND FLOOR VIEWING DECK	0	0	310	310	
	SUB-TOTAL	1,870 SF	-1,870 SF	3,792 SF	3.792 SF	

1,870 SF | -1,870 SF |

■ FLOOR AREA CALCS:

MAIN FLOOR

UPPER FLOOR

GARAGE

## AMERICAN INSTITUTE of BUILDING DESIGN All ideas, designs, arrangements and plans indicated ALLOWED 35% = 4,735 SF PROPOSED 28% = 3,792 SF ALLOWED (35%) = 4,735 SFPROPOSED (34.8%) 4,705 SF EXISTING DEMO ADDITIONS 1,383 -1,383 2,703 1,223 1,223 0 0 487 -487 779 779

PROJECT NAME:

CASTLEMAN RESIDENCE

1012 SAN CARLOS PEBBLE BEACH, CA APN: 007-282-004-000



550 FIGUEROA STREET, SUITE B MONTEREY CA. 93940 831.642.9732 FAX 831.401.3292 john@mooredesign.org

DRAWING RECORD		
DESCRIPTION	ISSUED	
PLN SUBMIT	3/12/2025	
PLN RE-SUBMIT	5/14/2025	
PRINT DATE:	5/14/2025	




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Drawings are not to be scaled. Written dimensions on these drawings shall have precedence over scale

SHEET TITLE:

COVER SHEET / PROJECT INFO

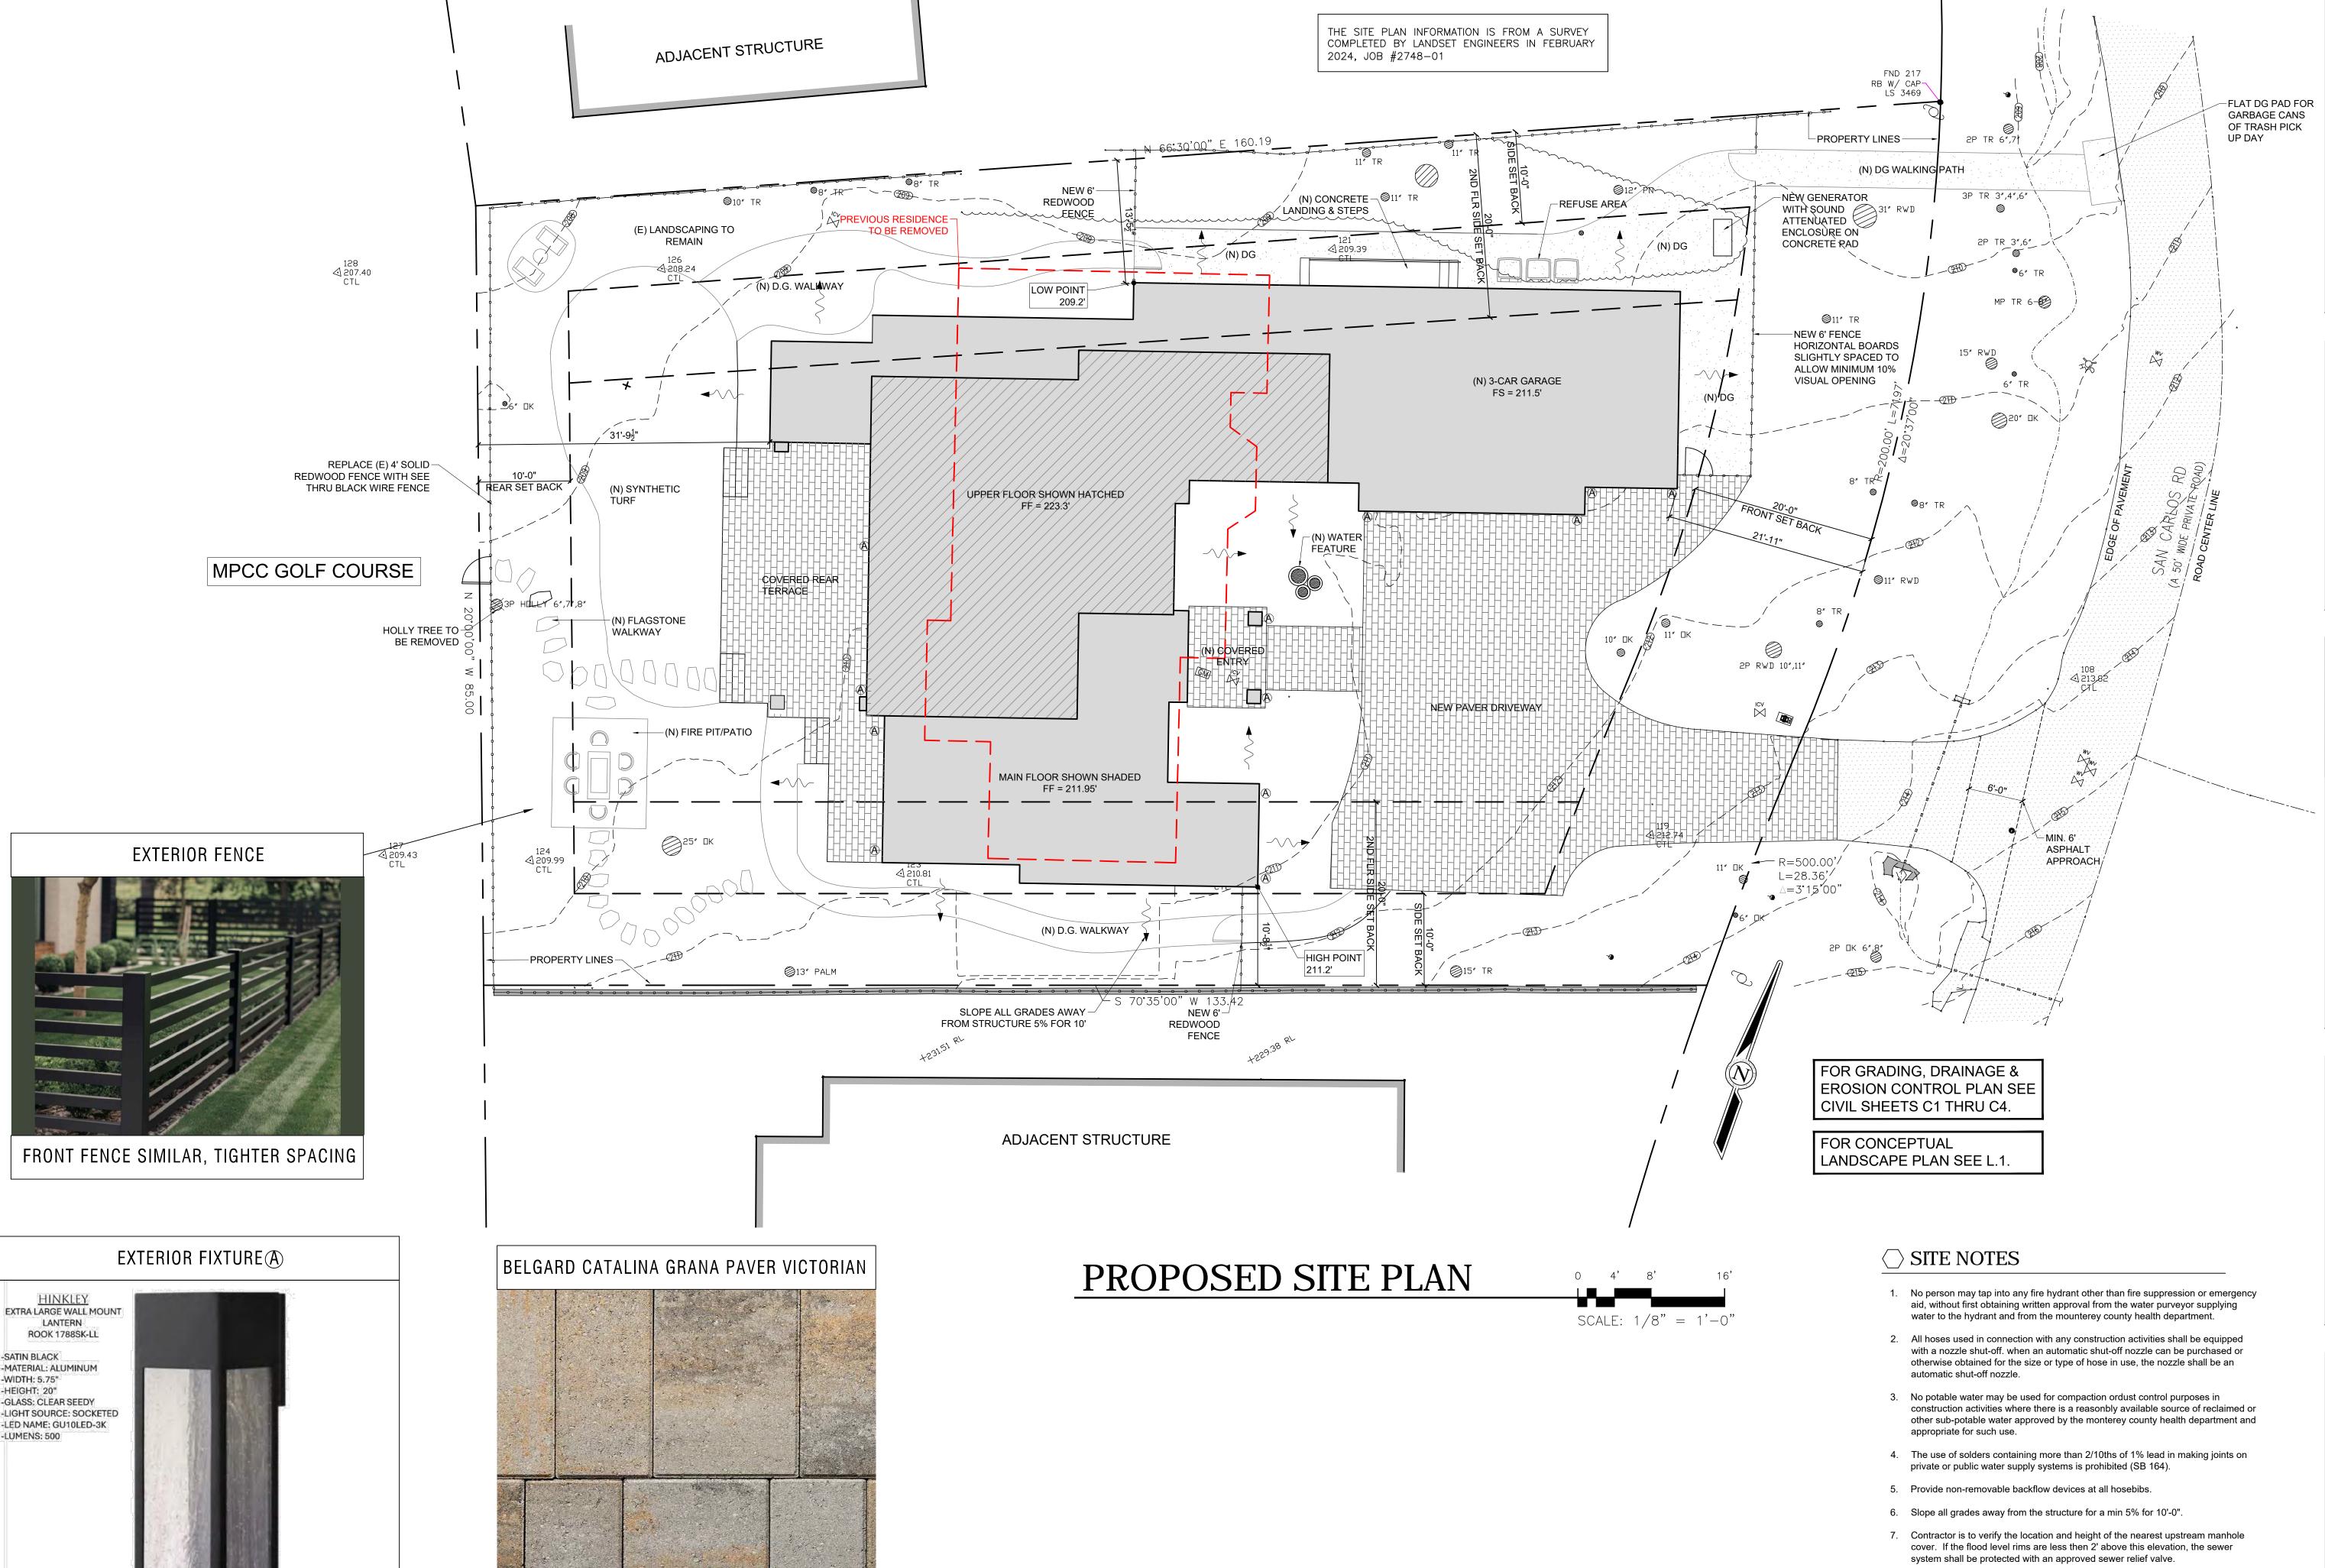

CASTLEMAN RESIDENCE

1012 SAN CARLOS ROAD PEBBLE BEACH, CA 93953

93953 APN: 007-282-004-000

MOORE DESIGN Inc.

MOORE DESIGN Inc.

RESIDENTIAL PLANNING &

CONSTRUCTION ADMINISTRATION

550 FIGUEROA STREET, SUITE B MONTEREY CA. 93940 831.642.9732 FAX 831.401.3292 john@mooredesign.org

DRAWING RECORD			
DESCRIPTION	ISSUED		
PLN SUBMIT	3/12/2025		
PLN RE-SUBMIT	5/14/2025		

PRINT DATE: 5/14/2025



BUILDING DESIGN

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Drawings are not to be scaled. Written dimensions on these drawings shall have precedence over scale dimensions.


the acceptance of the restrictions.

SHEET TITLE:

SITE PLAN

SHEET NUMBER:

A1.1

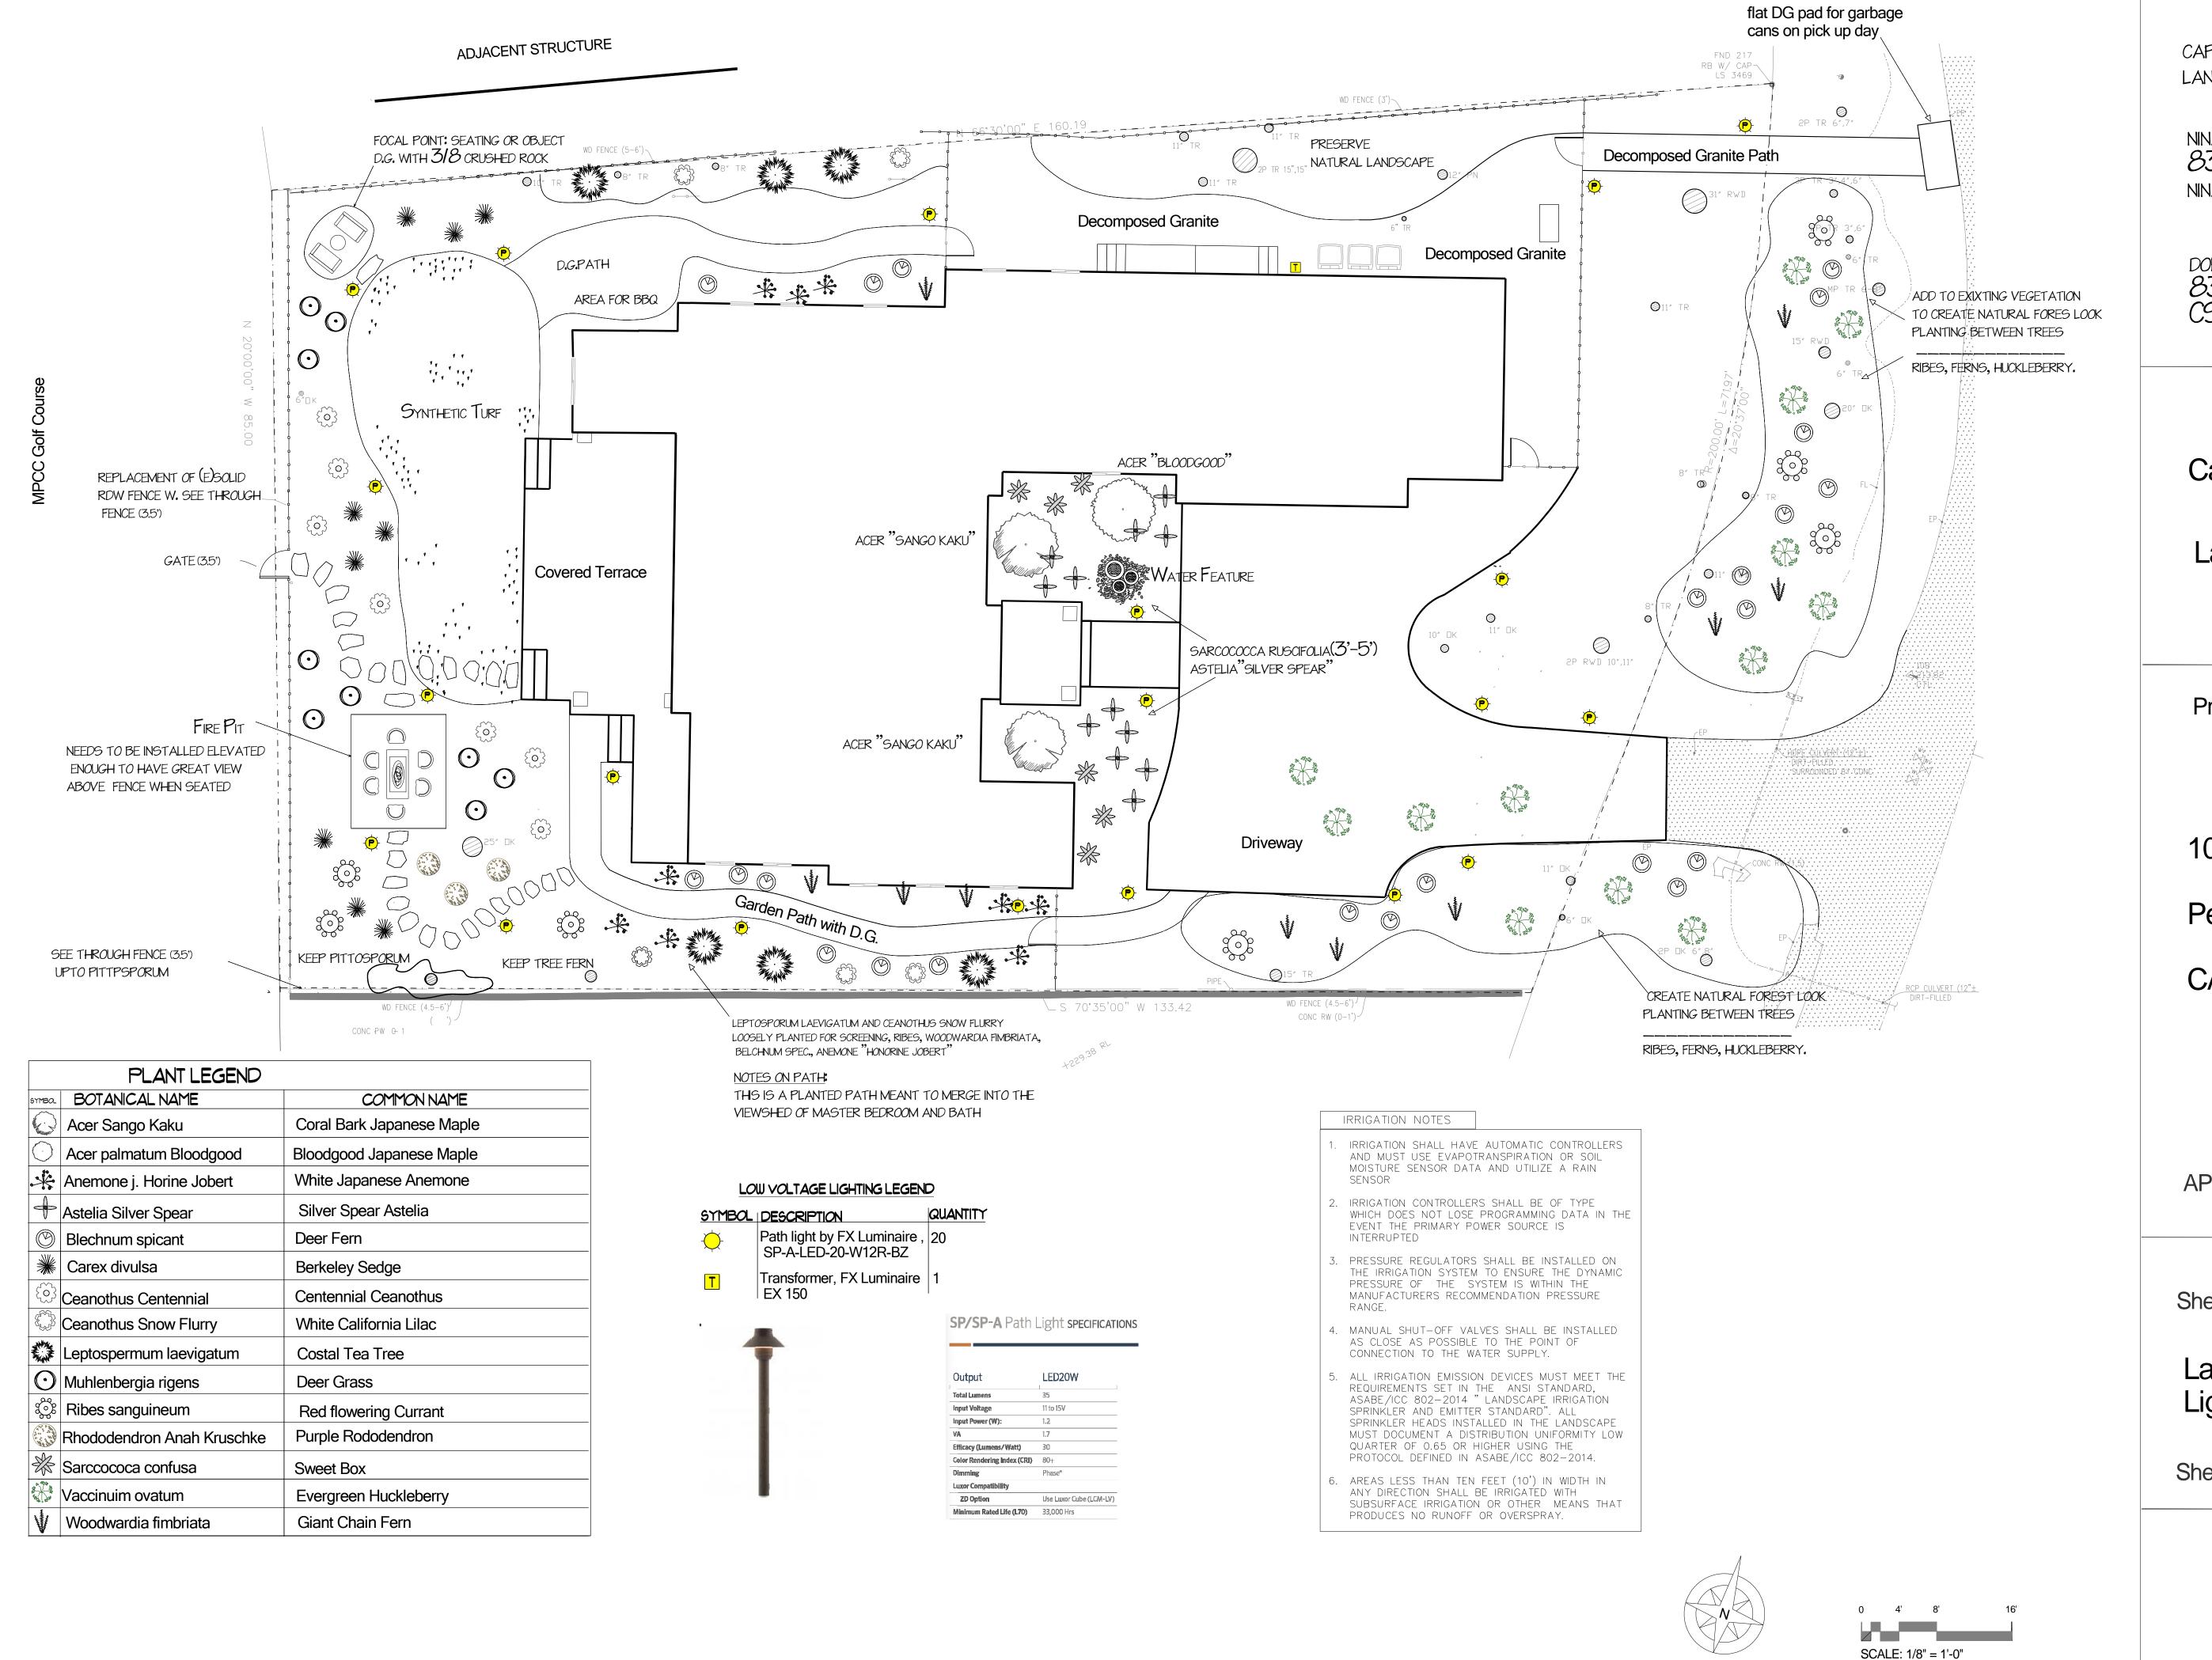



NINA CAPRIOLA 831.595.7053 NINACAPRIOLADESIGN.COM

DORIS MITCHELL 831.595.5205 CSCL # 1117798

Client/Project:

Castleman Residence

Landscaping

Project address:

1012 San Carlos Road
Pebble Beach
CA, 93953

APN: 007-282-004-000

Sheet Title:


Landscape/ Lighting Plan


Sheet Number: L.1

Date: 05/12/2025

Scale: 1/8"= 1'-0"

Drawn by: NC, DM

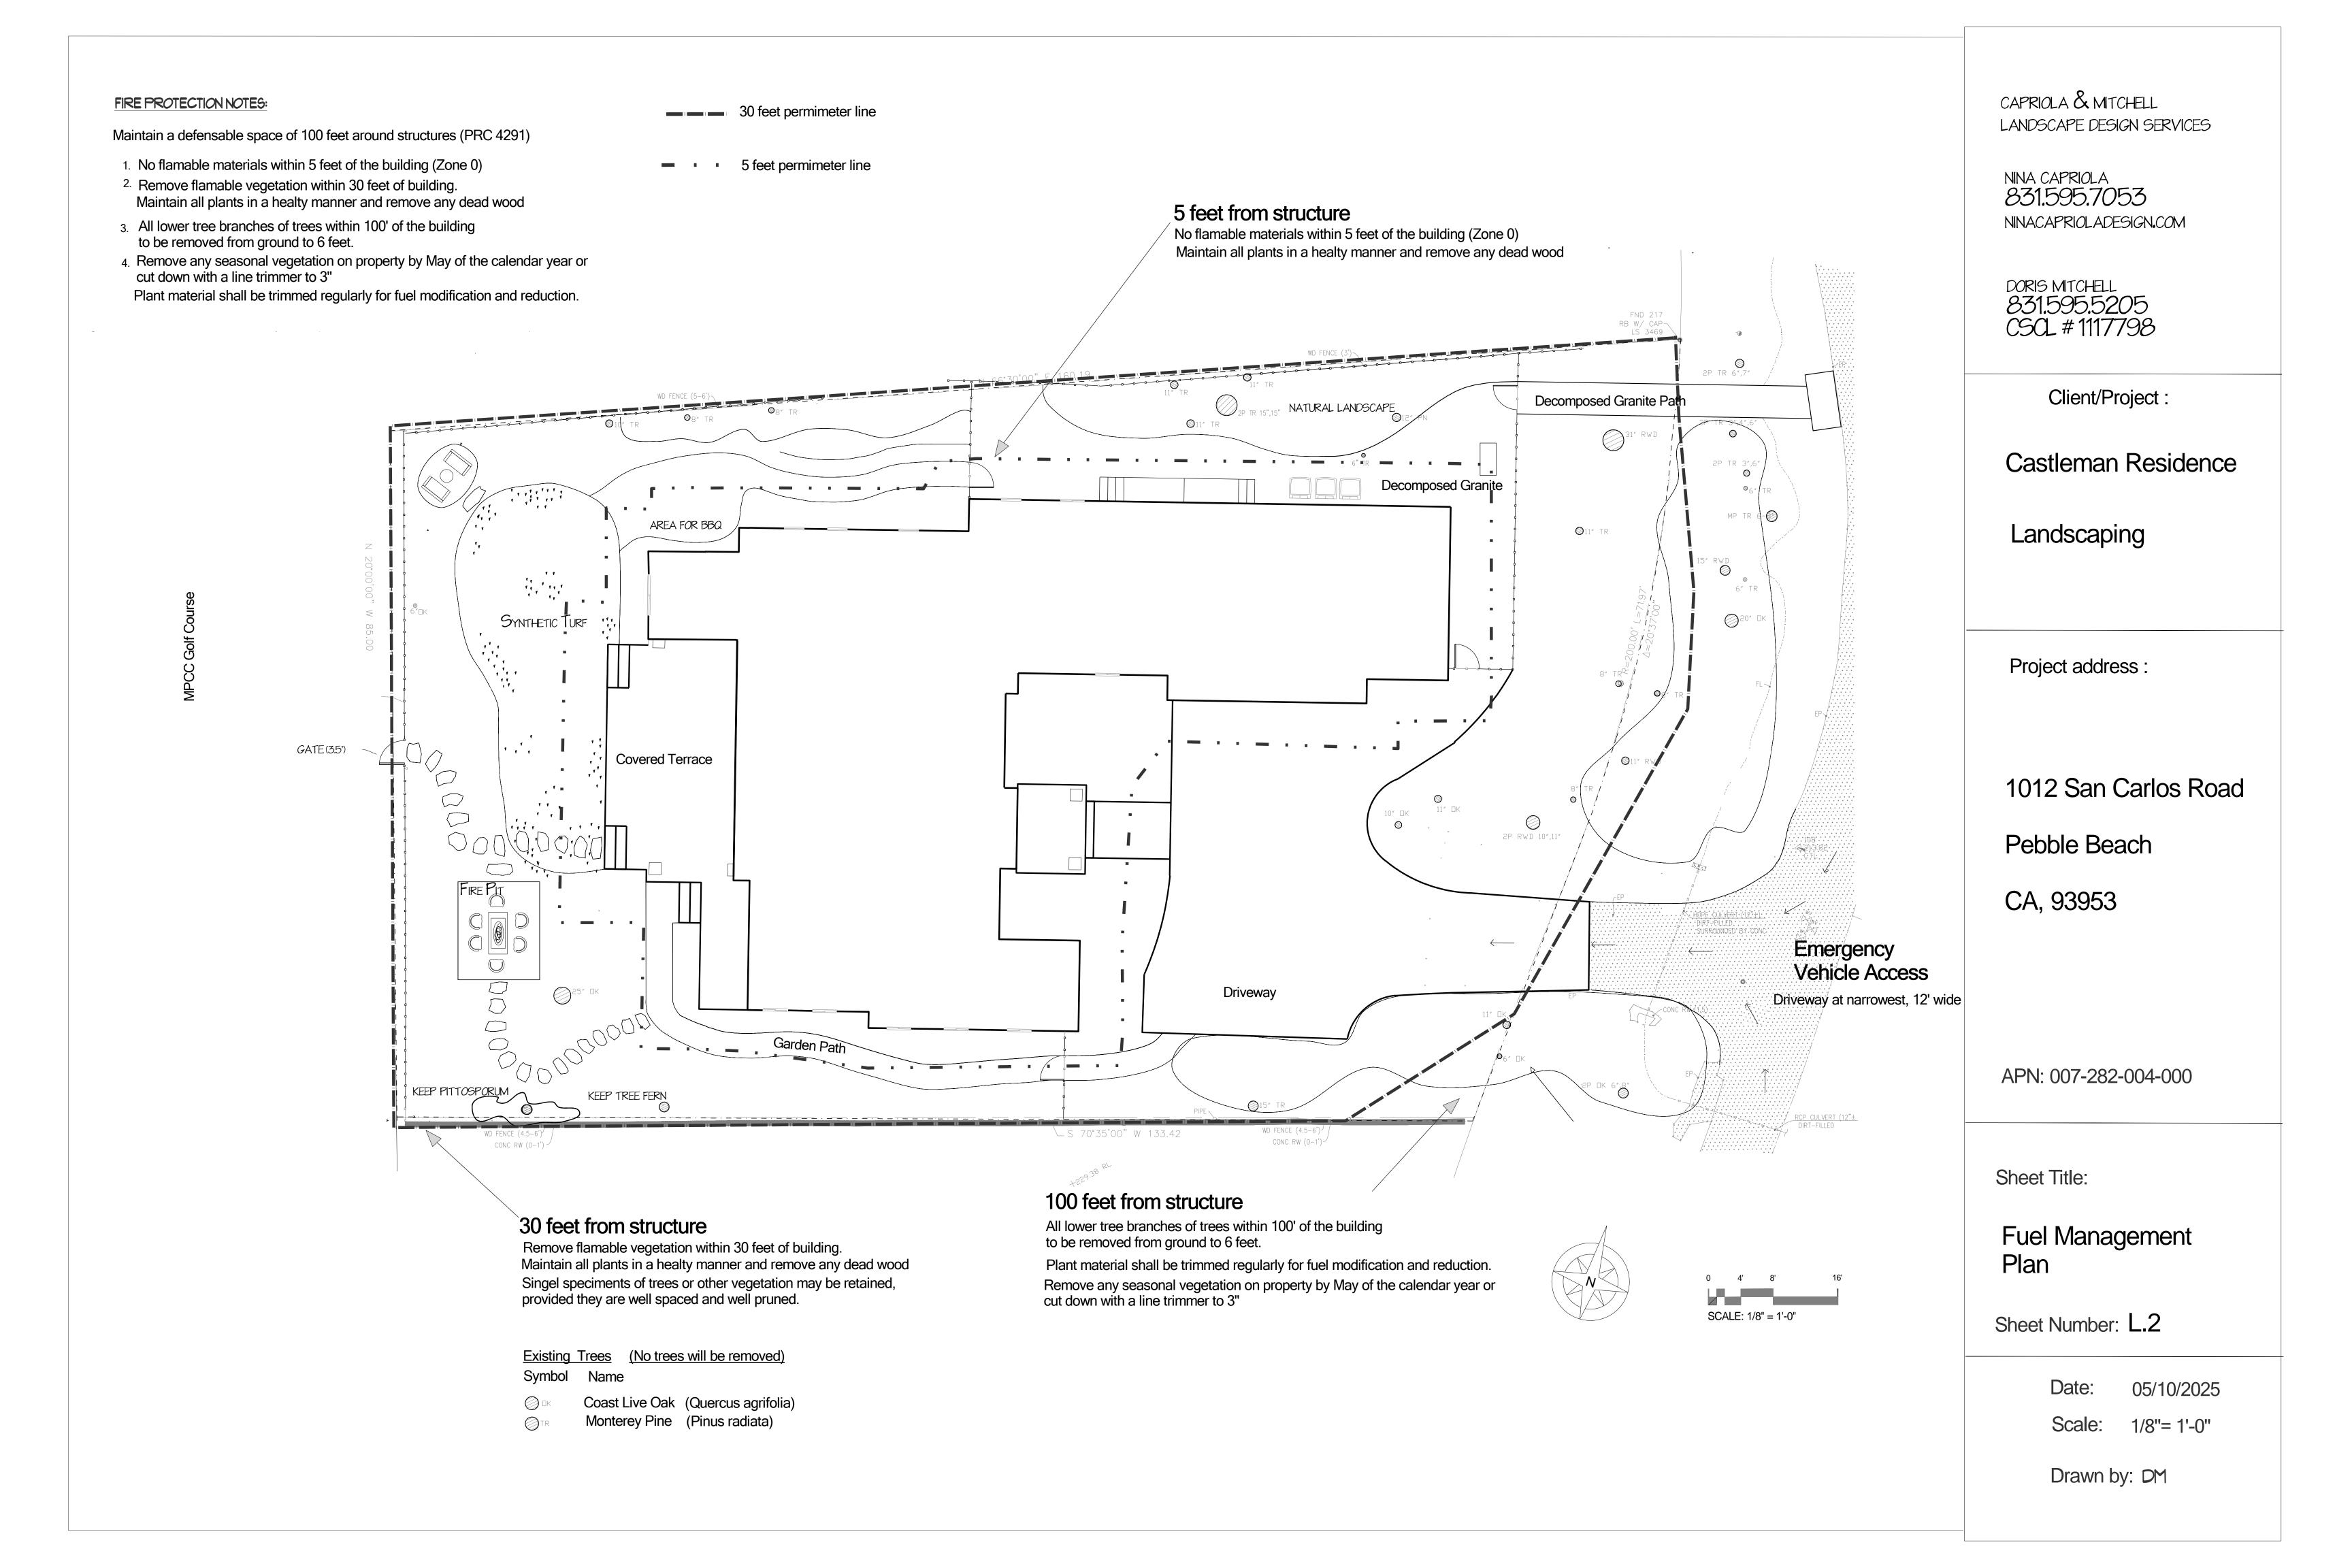

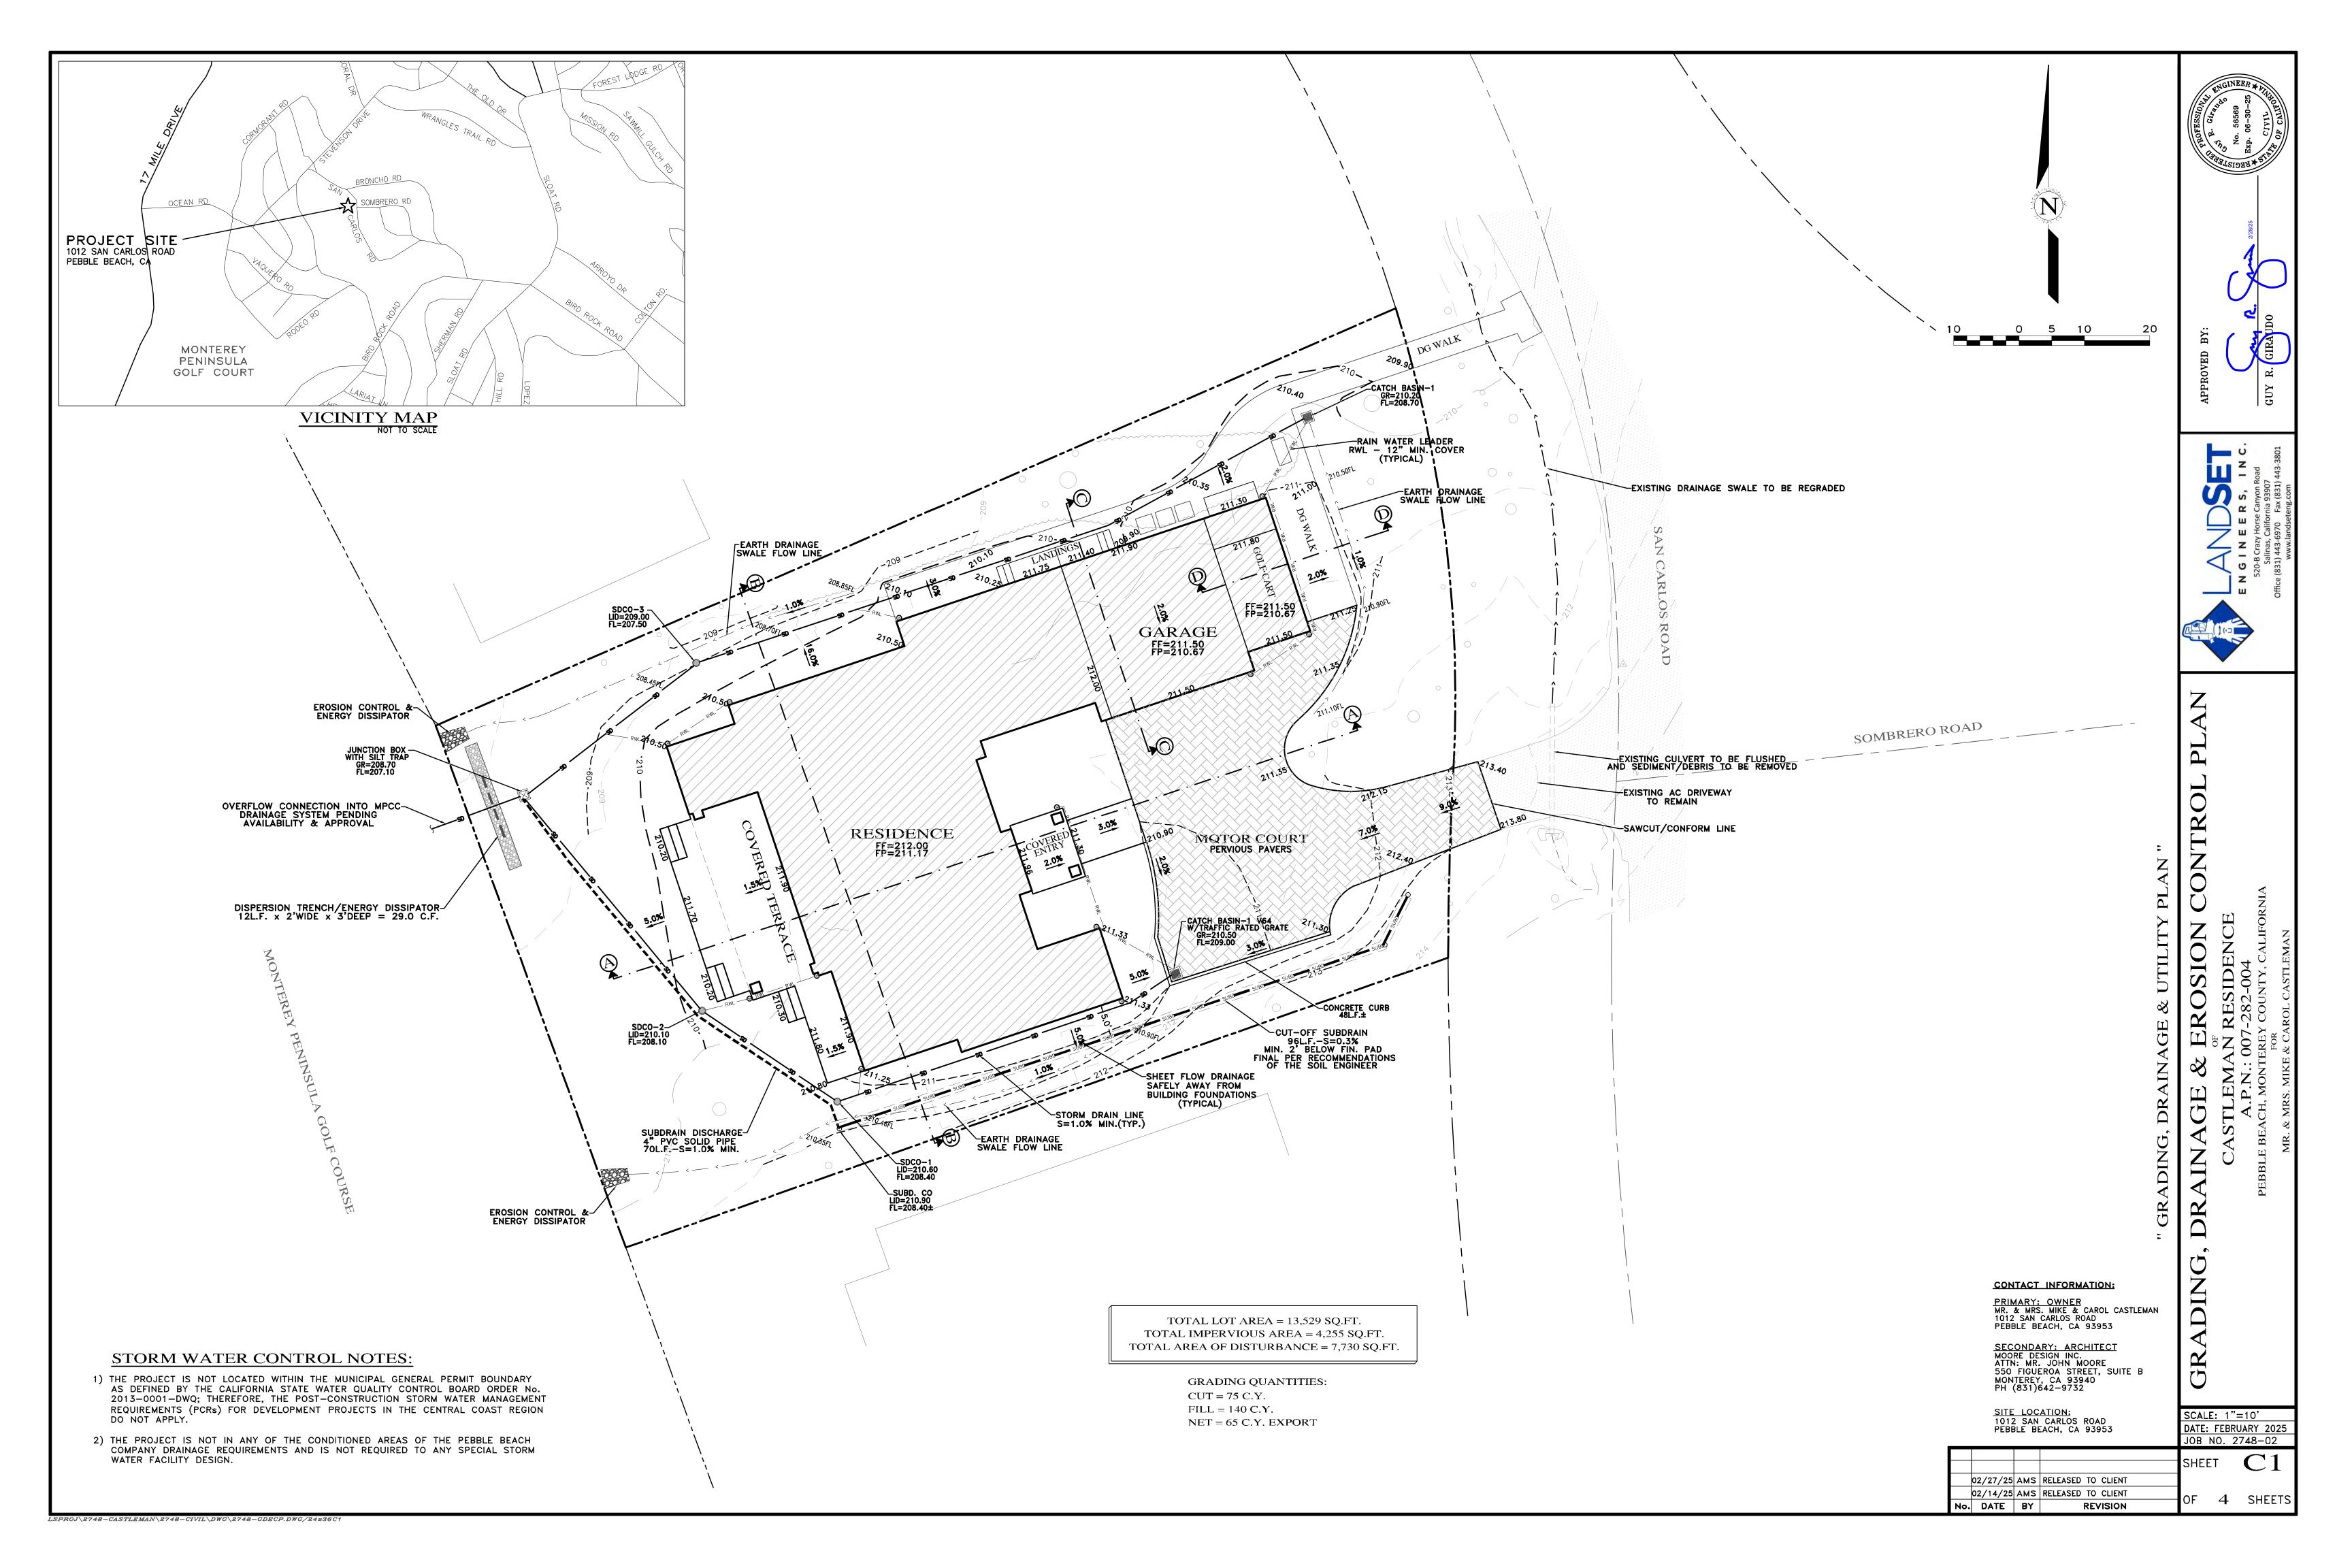

FF=212.00 FP=211.17 DRAINAGE SWALE<sub>7</sub> CUT-OFF-SUBDRAIN EXISTING GROUND 0+10 0+20 0+30 0+40 0+50 0+60 0+70 0+80 0+90

FINISH GRADE-COVERED TERRACE COVERED ENTRY RESIDENCE WALK MOTOR COURT FF=212.00 FP=211.17 LEXISTING GROUND 0+20 0+50 1+00 0+30 1+10

SECTION A-A
SCALE: 1"=10' H&V

FINISH GRADE GARAGE FF=211.50 FP=210.67 2.0% STAIRS LANDING ∥\ MOTOR LEXISTING GROUND 0+00 0+10 0+20 0+30 0+40

SECTION C-C
SCALE: 1"=10' H&V

 $LSPROJ \setminus 2748 - CASTLEMAN \setminus 2748 - CIVIL \setminus DWG \setminus 2748 - GDECP.DWG / 24x36C4$ 

GARAGE GOLF CART DG WALK FF=211.50 2.0% 0+00 0+10 0+20 0+30 SECTION D-D
SCALE: 1"=10' H&V

# NOTES:

- ALL FILL MATERIAL SHALL BE STRUCTURAL FILL PER SOIL'S ENGINEERING INVESTIGATION REPORT
   SEE ARCHITECTURAL AND STRUCTURAL PLANS FOR LAYOUT OF FOUNDATION COMPONENTS.

   OVEREXCAVATION ON BUILDING AREAS PER SOILS ENGINEERING INVESTIGATION REPORT

FOR SECTION LOCATIONS, SEE SHEET C3 "GRADING, DRAINAGE & UTILITY PLAN".


				DATE:	FEB	RUARY 2025
				JOB	NO.	2748-02
						$\overline{C}$
				SHEE	<u>.</u> I	CZ
	02/27/25	AMS	RELEASED TO CLIENT			
	02/14/25	AMS	RELEASED TO CLIENT	OF	1	SHEET
No.	DATE	BY	REVISION	Or .	4	SHEEL


SCALE: 1"=10' H&V

SECTION B-B
SCALE: 1"=10' H&V

## **EROSION & SEDIMENT CONTROL NOTES:**

- 1) ALL EROSION CONTROL MEASURES SHALL CONFORM WITH THE COUNTY OF MONTEREY EROSION
- 2) EROSION AND SEDIMENT CONTROL MEASURES SHALL BE IN EFFECT FOR ANY CONSTRUCTION DURING THE RAINY SEASON, APPROX. OCTOBER 15 TO APRIL 15. EROSION CONTROL PLAN SHALL BE PREPARED AND SUBMITTED FOR APPROVAL BY SEPT. 15 OF ANY OR EACH CALENDAR YEAR THAT CONSTRUCTION MAY EXTEND BEYOND OCTOBER 15.
- 3) ALL SLOPES SHALL BE PROTECTED WITH STRAW MULCH OR SIMILAR MEASURES TO PROTECT AGAINST EROSION UNTIL SUCH SLOPES ARE PERMANENTLY STABILIZED.
- 4) RUNOFF SHALL BE DETAINED OR FILTERED BY BERMS, VEGETATED FILTER STRIPS, AND/OR CATCH BASINS TO PREVENT THE ESCAPE OF SEDIMENT FROM THE SITE.
- 5) EROSION AND SEDIMENT CONTROL MEASURES SHALL BE IN PLACE AT THE END OF EACH DAY'S
- 6) EROSION CONTROL PLANTINGS AND MULCH SHALL BE CLOSELY MONITORED THROUGHOUT THE WINTER AND ANY RUNOFF PROBLEMS CORRECTED PROMPTLY. SEE LANDSCAPE ARCHITECT'S PLAN FOR PERMANENT PLANTINGS AND TREE SCHEDULES.
- 7) DISTURBED SURFACES NOT INVOLVED IN THE IMMEDIATE GRADING OPERATIONS MUST BE PROTECTED BY MULCHING AND/OR OTHER EFFECTIVE MEANS OF SOIL PROTECTION.
- 8) ALL ROADS AND DRIVEWAYS SHALL HAVE DRAINAGE FACILITIES SUFFICIENT TO PREVENT EROSION ON OR ADJACENT TO THE ROADWAY OR ON THE DOWNHILL PROPERTIES.
- 9) DRAINAGE CONTROL MEASURES SHALL BE MAINTAINED AND IN PLACE AT THE END OF EACH DAY AND CONTINUOUSLY THROUGHOUT THE LIFE OF THE PROJECT DURING WINTER OPERATIONS.
- 10) REVEGETATION SHALL CONSIST OF A MECHANICALLY APPLIED HYDROMULCH SLURRY OR HAND SEEDED WITH A STRAW MULCH COVER. MULCH SHALL BE ANCHORED BY AN APPROVED METHOD SUCH AS PUNCHING, TACKING, OR THE USE OF JUTE NETTING, AS DEEMED NECESSARY FOR THE SITE CONDITIONS TO ALLOW FOR GERMINATION AND ENABLE ADEQUATE GROWTH TO BE
- 11) CHECK DAMS, SILT FENCES, FIBER ROLLS OR OTHER DESIGNS SHALL BE INCORPORATED TO CATCH ANY SEDIMENT UNTIL AFTER THE NEWLY EXPOSED AREAS ARE REVEGETATED SUFFICIENTLY TO CONTROL EROSION. EROSION CONTROL PLANTINGS AND MULCH SHALL BE CLOSELY MONITORED THROUGHOUT THE WINTER AND ANY RUNOFF PROBLEMS SHALL BE CORRECTED PROMPTLY. ALL EROSION AND/OR SLIPPAGE OF THE NEWLY EXPOSED AREAS SHALL BE REPAIRED BY THE PERMITTEE AT THEIR EXPENSE.
- 12) THE GRASS SEED SHALL BE PROPERLY IRRIGATED UNTIL ADEQUATE GROWTH IS ESTABLISHED AND MAINTAINED TO PROTECT THE SITE FROM FUTURE EROSION DAMAGE. ALL NEWLY EXPOSED (DISTURBED) AREAS SHALL BE SEEDED WITH THE FOLLOWING EROSION CONTROL MIX: BROMUS CARINATUS (CALIFORNIA BROME), VULPIA MICROSTACHYS (NUTTALL'S FESCUE), ELYMUS GLAUCUS (BLUE WILD RYE), HORDEUM BRACHYANTHERUM (MEADOW BARLEY), FESTUCA RUNRA'MOLATE BLUE AND A MIXTURE OF LOCALLY NATIVE WILDFLOWERS.
- 13) THE DIRECTOR OF BUILDING INSPECTION (BUILDING OFFICIAL) SHALL STOP OPERATIONS DURING PERIODS OF INCLEMENT WEATHER IF HE OR SHE DETERMINES THAT EROSION PROBLEMS ARE NOT BEING CONTROLLED ADEQUATELY.
- 14) GENERAL CONTRACTOR SHALL BE RESPONSIBLE FOR EROSION AND SEDIMENT CONTROL BMP INSTALLATION AND MAINTENANCE AND SHALL PROVIDE FULL PARTICULARS TO COUNTY RMA-ENVIRONMENTAL SERVICES PRIOR TO BEG. WORK.

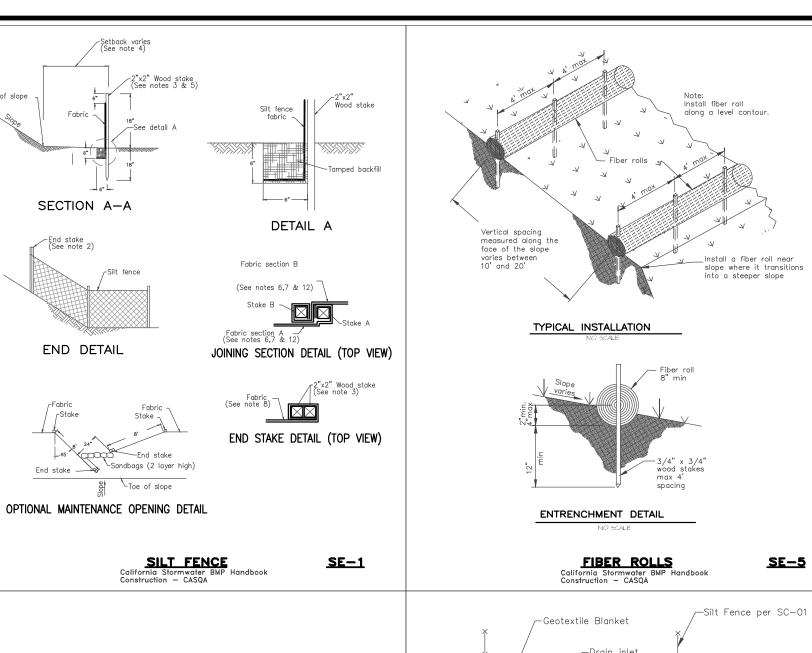


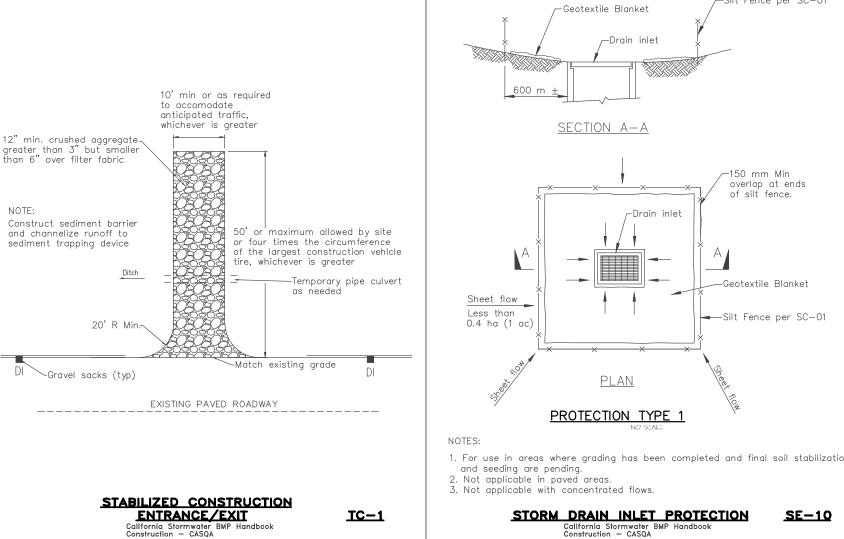

## LEGEND:

**~~~~~** 

FIBER ROLLS: THE CONTRACTOR SHALL MAINTAIN A STOCKPILE OF FIBER ROLLS ONSITE, AS THEY CAN BE USED ALONG ERODIBLE SLOPES, ALONG STOCKPILE PERIMETERS, DOWNSLOPE OF EXPOSED SOIL AREAS, AND TO DELINEATE/PROTECT STAGING AREAS. FIBER ROLLS MUST BE TRENCHED INTO THE SOIL AND STAKED (STAKES SPACED MAX. 4' ON CENTER). SEE DETAIL. INSTALL FIBER ROLLS ALONG LEVEL CONTOURS, AND TURN THE ENDS UPHILL. INSPECT WEEKLY AND REMOVE ACCUMULATED SEDIMENT REGULARLY.

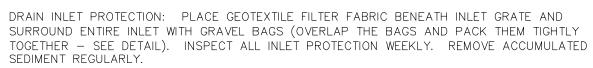

STABILIZED CONSTRUCTION ACCESS: INSTALL STABILIZED CONSTRUCTION ACCESS PRIOR TO COMMENCEMENT OF EARTH MOVING OPERATIONS (SEE DETAIL). INSPECT ENTRANCE DAILY, AND ADD ADDITIONAL STONE AS TOP-DRESSING WHEN REQUIRED. USE FENCING OR BARRICADES TO PREVENT VEHICLE TRAFFIC FROM DRIVING AROUND THE STABILIZED ACCESS

CONCRETE WASHOUT: WASHOUT MUST BE LOCATED A MINIMUM OF 50 FEET FROM STORM DRAINS, OPEN DITCHES, OR WATER BODIES. DISCONTINUE USE WHEN WASHOUT WASTES REACH 75% OF THE WASHOUT CAPACITY. ALLOW WASHOUT WASTES TO HARDEN, BE BROKEN UP,

AND THEN DISPOSED OF PROPERLY. SANITARY/SEPTIC WASTE MANAGEMENT: PORTABLE TOILETS WILL BE PROVIDED AND MAINTAINÉD ONSITE FOR THE DURATION OF THE PROJECT. ALL PORTABLE TOILETS WILL BE EQUIPPED WITH A SECONDARY CONTAINMENT TRAY, AND SHALL BE LOCATED A MINIMUM OF 50' FROM ALL OPERATIONAL STORM DRAIN INLETS. WEEKLY MAINTENANCE SHALL BE PROVIDED

STOCKPILE MANAGEMENT: SOIL STOCKPILES MUST BE COVERED OR STABILIZED (I.E. WITH SOIL BINDERS) IMMEDIATELY IF THEY ARE NOT SCHEDULED TO BE USED WITHIN 14 DAYS. ACTIVE SOIL STOCKPILES SHALL BE WATERED TWICE DAILY TO AVOID WIND EROSION. SURROUND ALL STOCKPILES WITH FIBER ROLLS OR SILT FENCE. STOCKPILES OF "COLD MIX", TREATED WOOD, AND BASIC CONSTRUCTION MATERIALS SHOULD BE PLACED ON AND COVERED

WITH PLASTIC SHEETING OR COMPARABLE MATERIAL AND SURROUNDED BY A BERM..

CONTRACTOR'S STAGING AREA: THE CONTRACTOR'S STAGING AREA SHALL BE SURROUNDED BY FIBER ROLLS. THE STAGING AREA WILL BE USED TO STORE DELIVERED MATERIALS, AND FOR OVERNIGHT EQUIPMENT PARKING/FUELING. STORED CONSTRUCTION MATERIALS SHALL BE MAINTAINED IN THEIR ORIGINAL CONTAINERS, AND COVERED AT ALL TIMES. PETROLEUM PRODUCTS AND HAZARDOUS MATERIALS SHALL BE STORED WITHIN SECONDARY CONTAINMENT OCCUR WITHIN THE DESIGNATED STAGING AREA. DRIP PANS OR ABSORBENT PADS MUST BE

DUMPSTERS AND/OR TRASH BINS SHALL BE COVERED AT THE END OF EACH WORK DAY.

HAZARDOUS WASTES SHALL NOT BE STORED ONSITE. CONSTRUCTION DEBRIS AND GENERAL LITTER WILL BE COLLECTED DAILY AND WILL NOT BE ALLOWED NEAR DRAINAGE INLETS OR

STRUCTURES OR A STORAGE SHED. EQUIPMENT FUELING AND MAINTENANCE WILL ONLY USED DURING ALL FUELING OR MAINTENANCE ACTIVITIES. AN AMPLE SUPPLY OF SPILL CLEANUP MATERIALS SHALL BE MAINTAINED IN THE STAGING AREA AT ALL TIMES. WASTE MANAGEMENT: SOLID WASTES WILL BE LOADED DIRECTLY ONTO TRUCKS FOR TRASH OFF-SITE DISPOSAL. WHEN ON-SITE STORAGE IS NECESSARY, SOLID WASTES WILL BE STORED RECYCLE IN WATERTIGHT DUMPSTERS IN THE GENERAL STORAGE AREA OF THE CONTRACTOR'S YARD.

AND WASTES LEGALLY DISPOSED OF OFF-SITE

GRAVEL BAG CHECK DAM: GRAVEL BAGS SHALL CONSIST OF WOVEN POLYPROPYLENE, POLYETHYLENE OR POLYAMIDE FABRIC, MIN. UNIT WEIGHT OF 40Z/SY. BAGS SHALL BE A MINIMUM OF 18" LONG X 12" WIDE X 3" THICK, FILLED WITH 1/2" - 1" CRUSHED ROCK. TIGHTLY ABUT BAGS AND CONSTRUCT CHECK DAM AT LEAST 3 BAGS WIDE X 2 BAGS HIGH.

INSPECT CHECK DAM REGULARLY AND REMOVE ACCUMULATED SEDIMENT.

TREE PROTECTION: TREE PROTECTION SHALL CONSIST OF ORANGE PLASTIC MESH FENCING, AND SHALL BE INSTALLED PRIOR TO COMMENCEMENT OF EARTH-MOVING OPERATIONS (SEE DETAIL). INSTALL FENCING ALONG THE DRIP LINE OF TREES, AND INSTRUCT EMPLOYEES AND SUBCONTRACTORS TO HONOR PROTECTIVE DEVICES. TREE INJURIES SHALL BE ATTENDED TO BE A LICENSED AND CERTIFIED ARBORIST.

SILT FENCE: SILT FENCE SHALL CONSIST OF WOVEN GEOTEXTILE FABRIC WITH A MINIMUM WIDTH OF 36 INCHES. WOOD STAKES SHALL BE COMMERCIAL QUALITY LUMBER, SPACED A MAXIMUM OF 6' APART AND DRIVEN SECURELY INTO THE GROUND (SEE DETAIL). FENCING FABRIC SHALL BE KEYED INTO THE SOIL AS PER MANUFACTURER'S RECOMMENDATIONS. INSTALL SILT FENCE ALONG LEVEL CONTOURS. TURN THE ENDS OF THE SILT FENCE UPHILL TO PREVENT WATER FROM FLOWING AROUND THE FENCE. INSPECT SILT FENCE DAILY, AND MAKE REPAIRS IMMEDIATELY.


## TABLE 1706.6 REQUIRED VERIFICATION AND INSPECTION OF SOILS

VERIFICATION AND INSPECTION TASK	CONTINUOUS DURING TASK LISTED	PERIODICALLY DURING TASK LISTED
<ol> <li>Verify material below shallow foundations are adequate to achieve the design bearing capacity</li> </ol>		×
2. Verify excavations are extended to proper depth and have reached proper material		Х
3. Perform classification and testing of compacted fill materials		Х
4. Verify use of proper materials, densities and lift sicknesses during placement and compaction of compacted fill.	Х	
5. Prior to placement of compacted fill, observe subgrade and verify that site has been prepared properly.		X

## CONSTRUCTION INSPECTION REQUIREMENTS

- A-PRIOR TO COMMENCEMENT OF ANY LAND DISTURBANCE, THE OWNER/APPLICANT SHALL SCHEDULE AN INSPECTION WITH HCD-ENVIRONMENTAL SERVICES TO ENSURE ALL NECESSARY SEDIMENT CONTROLS ARE IN PLACE AND THE PROJECT IS COMPLIANT WITH MONTEREY COUNTY GRADING AND EROSION CONTROL REGULATIONS.
- B-DURING CONSTRUCTION THE OWNER/APPLICANT SHALL SCHEDULE AN INSPECTION WITH HCD-ENVIRONMENTAL SERVICES TO UPDATE COMPACTION TEST RECORDS, INSPECT DRAINAGE DEVICE INSTALLATION, REVIEW THE MAINTENANCE AND EFFECTIVENESS OF BMP's INSTALLED, AS WELL AS, TO VERIFY THAT POLLUTANTS OF CONCERN ARE NOT DISCHARGED FROM THE SITE.
- C-PRIOR TO FINAL INSPECTION, THE OWNER/APPLICANT SHALL SCHEDULE AN INSPECTION WITH HCD-ENVIRONMENTAL SERVICES TO CONDUCT A FINAL GRADING INSPECTION, COLLECT FINAL GEOTECHNICAL LETTER OF CONFORMANCE, ENSURE THAT ALL DISTURBED AREAS HAVE BEEN STABILIZED AND THAT ALL TEMPORARY EROSION AND SEDIMENT CONTROL MEASURES THAT ARE NO LONGER NEEDED HAVE BEEN REMOVED.

## **Material Delivery and Storage**

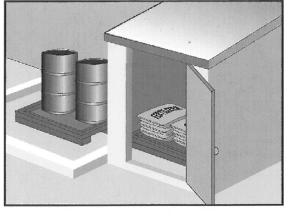

**Description and Purpose** Prevent, reduce, or eliminate the discharge of pollutants from material delivery and storage to the stormwater system or watercourses by minimizing the storage of hazardous materials onsite, storing materials in watertight containers and/or a completely enclosed designated area, installing secondary containment, conducting regular inspections, and training employees and subcontractors.

This best management practice covers only material delivery and storage. For other information on materials, see WM-2, Material Use, or WM-4, Spill Prevention and Control. For information on wastes, see the waste management BMPs in this

Hazardous Waste Management

Prevent or reduce the discharge of pollutants to stormwater from

hazardous waste through proper material use, waste disposal,

and training of employees and subcontractors.

# **Targeted Constituents** Oil and Grease

WM-1

SE Sediment Control

TC Tracking Control

WE Wind Erosion Control

Non-Stormwater

Primary Category

Secondary Category

Management Control

Waste Management and

Materials Pollution Control

**Potential Alternatives** 

EC Erosion Control

SE Sediment Control

C Tracking Control

WE Wind Erosion Control

Non-Stormwater

Secondary Objective

Targeted Constituents

**Potential Alternatives** 


Oil and Grease

Organics

Management Control

Waste Management and

# Stockpile Management

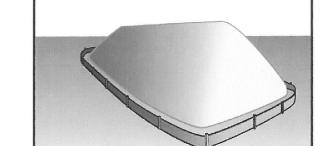

**Description and Purpose** Stockpile management procedures and practices are designed to reduce or eliminate air and stormwater pollution from stockpiles of soil, soil amendments, sand, paving materials such as portland cement concrete (PCC) rubble, asphalt concrete (AC), asphalt concrete rubble, aggregate base, aggregate sub base or pre-mixed aggregate, asphalt minder (so called "cold mix" asphalt), and pressure treated wood.

**Description and Purpose** 

arranging for regular service and disposal.

Proper sanitary and septic waste management prevent the

discharge of pollutants to stormwater from sanitary and septic

waste by providing convenient, well-maintained facilities, and

**Potential Alternatives** 

Oil and Grease

Categories

EC Erosion Control

SE Sediment Control

WE Wind Erosion Control

☑ Primary Category

Bacteria

Organics

Oil and Grease

■ Secondary Category

Targeted Constituents

Potential Alternatives

Non-Stormwater

Management Control

Waste Management and

Materials Pollution Control

TC Tracking Control

WM-3

Categories

EC Erosion Control

SE Sediment Control

TC Tracking Control

WE Wind Erosion Control

☑ Primary Category

■ Secondary Category

**Targeted Constituents** 


Non-Stormwater

Management Control

Waste Management and

Materials Pollution Control

## **Solid Waste Management**

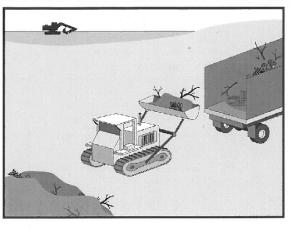

**Description and Purpose** Solid waste management procedures and practices are designed to prevent or reduce the discharge of pollutants to stormwater from solid or construction waste by providing designated waste collection areas and containers, arranging for regular disposal,

Targeted Constituents Nutrients Bacteria Oil and Grease

SE Sediment Control

Tracking Control

WE Wind Erosion Control

☑ Primary Objective

■ Secondary Objective


Non-Stormwater

Management Control

Waste Management and

Materials Pollution Control

#### **Preservation Of Existing Vegetation EC-2** Sanitary/Septic Waste Management WM-9

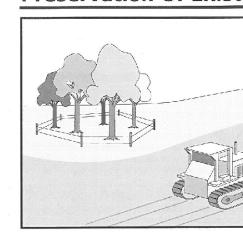

**Description and Purpose** Carefully planned preservation of existing vegetation minimizes

WE Wind Erosion Control Non-Stormwater Management Control ☑ Primary Objective ▼ Secondary Objective

he potential of removing or injuring existing trees, vines, shrubs, and grasses that protect soil from erosion.


**Targeted Constituents** Nutrients


SCALE: AS SHOWN DATE: FEBRUARY 202 OB NO. 2748-02

Oil and Grease

02/27/25 AMS RELEASED TO CLIENT 02/14/25 AMS RELEASED TO CLIENT No. DATE BY REVISION

and training employees and subcontractors. **Potential Alternatives** EC Erosion Control SE Sediment Control TC Tracking Control Waste Management and Materials Pollution Control

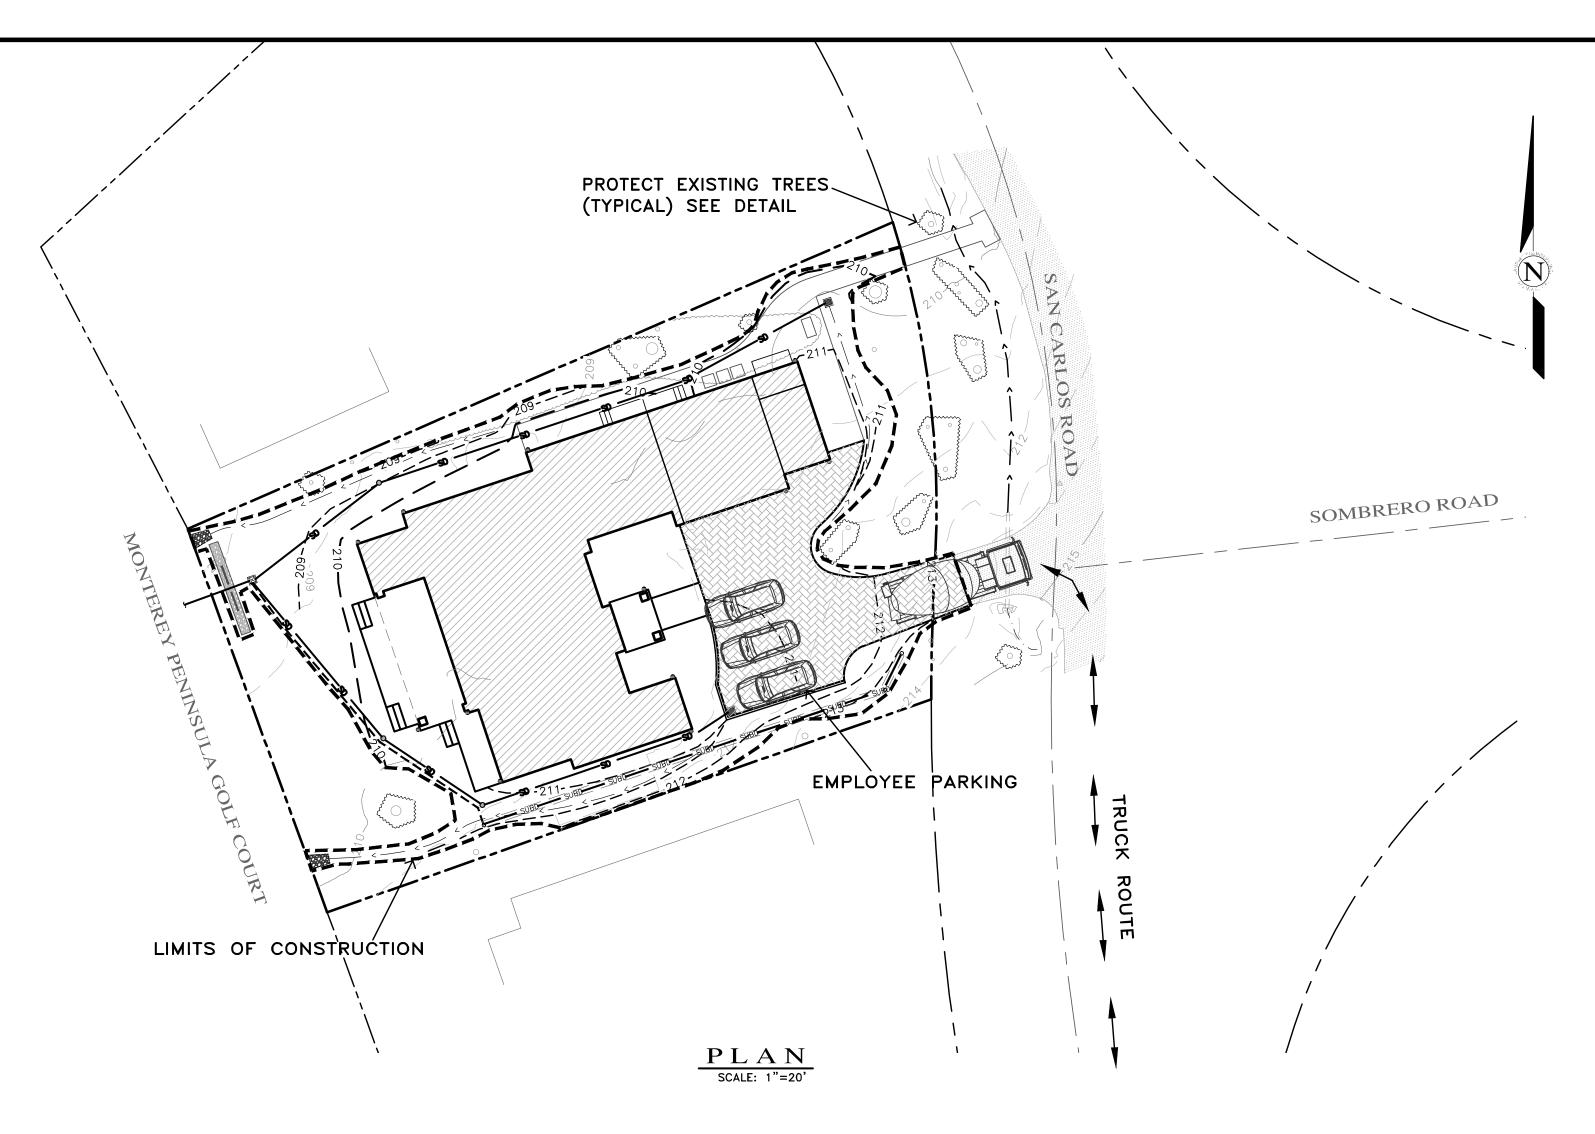

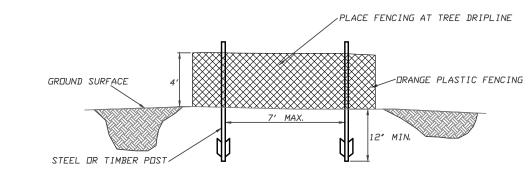

FENCING (ESA) DETAIL

EARTHWORK QUANTITIES PER CIVIL ENGINEERING PLANS BY LANDSET ENGINEERS, INC.:

140 CY FILL

DEMOLISH EXISTING HARDSCAPE AND OFFHAUL DEBRIS: EXISTING DRIVEWAY TO BE USED FOR EQUIPMENT STAGING AND TEMPORARY STOCKPILE AREA.

PERFORM GRADING, CONSTRUCT STRUCTURES, AND INSTALL UNDERGROUND UTILITIES: PROPOSED NEW MOTOR COURT AREA TO BE USED FOR MATERIAL AND EQUIPMENT STAGING.

## INSTALL NEW PERVIOUS PAVERS DRIVEWAY AND LANDSCAPING.

SEE ARCHITECTURAL AND CIVIL PLANS FOR EROSION CONTROL AND DEMOLITION NOTES. CONSTRUCTION EQUIPMENT AND MATERIALS SHALL NOT BE STAGED ON SAN CARLOS ROAD AT ANY TIME DURING CONSTRUCTION. MATERIAL DELIVERIES SHALL BE SCHEDULED SUCH THAT THEY ARE USED PROMPTLY, AND MATERIAL STORAGE IS MINIMIZED. ALL CONSTRUCTION EQUIPMENT AND MATERIALS SHALL BE STORED IN A DESIGNATED AREA ON THE

THE HAUL ROUTE TO THE SITE IS FROM HIGHWAY 68 TO MORSE DRIVE TO CONGRESS ROAD TO BIRD ROCK ROAD TO STEVENSON ROAD TO SAN CARLOS ROAD. (HAUL TRUCKS EXIT IN THE SAME FASHION.) VEHICLES SHALL NOT BE LEFT UNATTENDED WHILE IN QUEUE (IF NECESSARY) ON SAN CARLOS ROAD. CONTRACTOR TO ENSURE THAT HEIGHT RESTRICTIONS WITHIN THE DRIVEWAY AREA SHALL BE ADDRESSED BEFORE CONSTRUCTION VEHICLES ENTER THE SITE. SEE DETAILS B AND C, TRUCK ROUTING PLANS.

IN THE EVENT THAT MATERIAL DELIVERIES CAUSE ANY STREETS ALONG THE HAUL ROUTE TO BE PARTIALLY BLOCKED BY DELIVERY TRUCKS OR LOADING/UNLOADING OPERATIONS, A FLAGMAN SHALL BE PRESENT TO DIRECT TRAFFIC AROUND THE LANE OBSTRUCTION. THE FLAGMAN SHALL BE PRESENT AT ALL TIMES DURING WHICH DELIVERY/ CONSTRUCTION OPERATIONS MAY IMPACT TRAFFIC ON THE HAUL ROUTE AND SURROUNDING STREETS.

LIMITED EMPLOYEE PARKING ON-SITE. EMPLOYEES SHALL USE PUBLIC PARKING LOTS AND CARPOOL TO JOBSITE IF POSSIBLE. ON-SITE PARKING SHALL BE IN PROPOSED NEW MOTOR COURT AREA AND IN LEGAL SPACES ALONG SAN CARLOS ROAD, OBEYING ALL PARKING LAWS. PARKING IS PROHIBITED IN ALL NATURAL AREAS WHICH ARE NOT CURRENTLY PAVED OR GRAVEL.

<u>LIMITS OF CONSTRUCTION:</u> ALL CONSTRUCTION SHALL TAKE PLACE WITHIN THE BORDER AS SHOWN. EXISTING CYPRESS, PINE, AND OAK TREES LOCATED WITHIN THE LIMITS SHOWN SHALL BE SURROUNDED BY ORANGE PROTECTIVE FENCING (SEE DETAIL).

## TRUCK TRIP GENERATION CHART:

CATEGORY	NO. OF TRUCK TRIPS	TOTAL DAYS
DEMOLITION/CLKEARING	3	2
GRADING & SOIL REMOVAL (EXPORT)	1	1
ENGINEERING MATERIALS (IMPORT)	4	2
TOTALS	8	5


## TRUCK TRIP GENERATION NOTES:

- 1. TRUCK TRIPS FOR THE GRADING/SOIL REMOVAL IS BASED UPON 20 CUBIC YARDS PER TRUCKLOAD WITH AN AVERAGE OF 5 TRUCK LOADS PER DAY. 2. THERE ARE 65 C.Y. OF SOIL MATERIAL THAT WILL BE IMPORTED TO THE
- 3. GRADING OPERATIONS SHALL TAKE APPROXIMATELY 5 WORKING DAYS TO
- 4. THE AMOUNT OF GRADING PER DAY WILL VARY, THE AVERAGE BETWEEN 80 & 120 CUBIC YARDS.

## NUMBER OF EMPLOYEES/DAY: 6-10

HOURS OF OPERATION/DAY: 8

PROJECT SCHEDULING: PROJECTED START DATE 18 MARCH 2025, 5 WORKING DAYS TO COMPLETE GRADING, MONDAY THRU FRIDAY, 8:00 A.M. - 4:30 P.M. TOTAL PROJECT DURATION IS APPROXIMATELY 12 MONTHS.

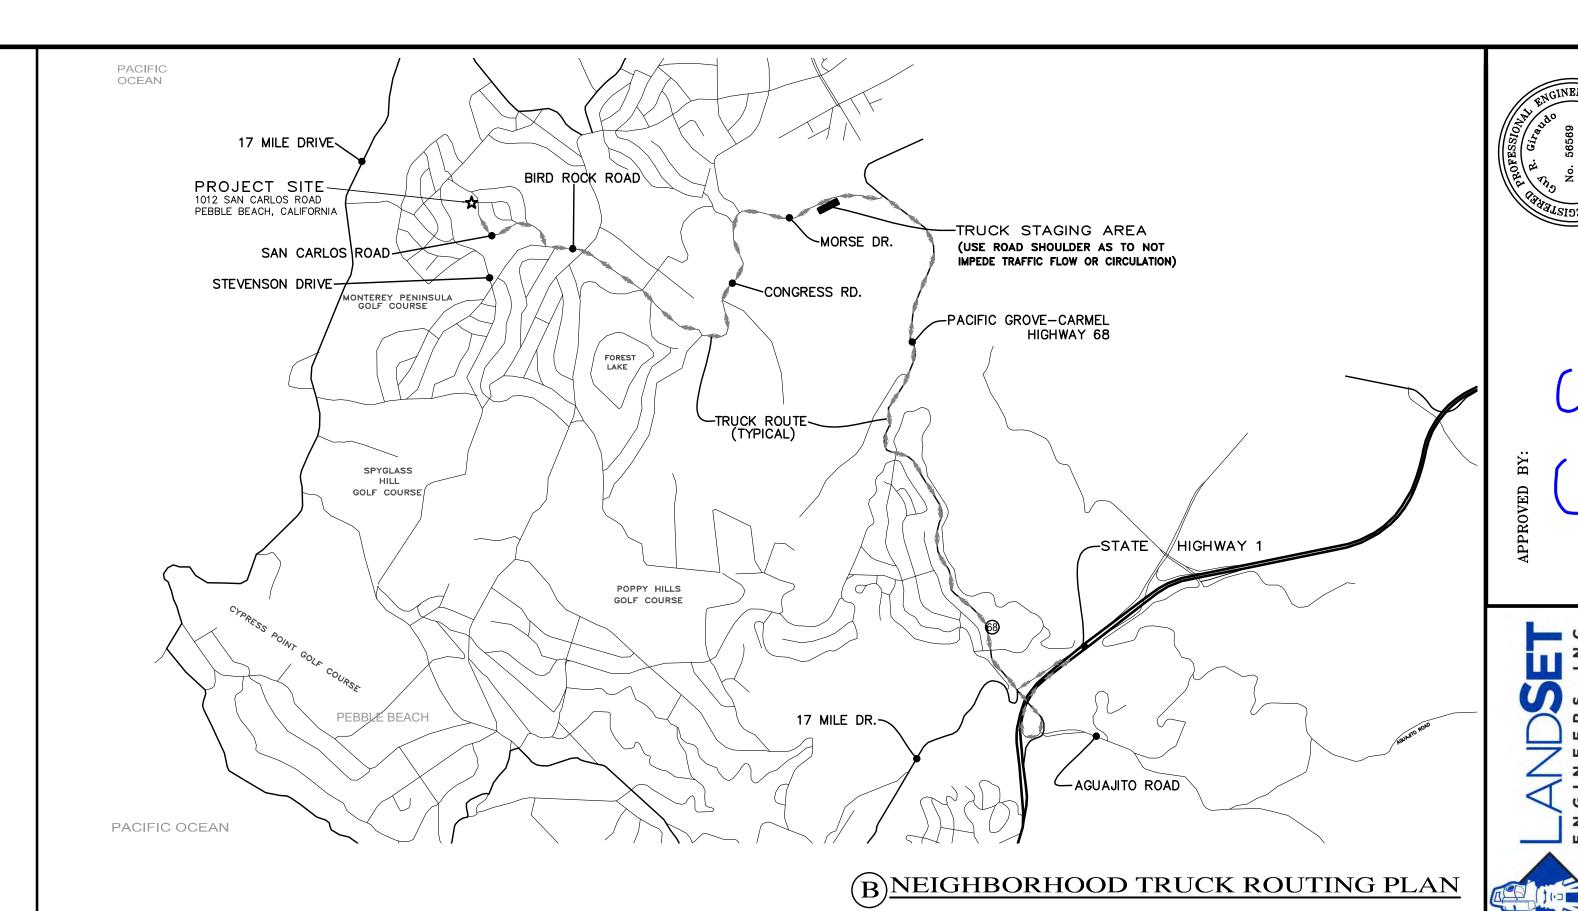



No. DATE BY





## CASTLEMAN RESIDENCE

1012 SAN CARLOS ROAD PEBBLE BEACH, CA

93953 APN: 007-282-004-000

MOORE DESIGN Inc.

RESIDENTIAL PLANNING &

550 FIGUEROA STREET, SUITE B MONTEREY CA. 93940 831.642.9732 FAX 831.401.3292 john@mooredesign.org

CONSTRUCTION ADMINISTRATION

DRAWING RECORD		
DESCRIPTION	ISSUED	
PLN SUBMIT	3/12/2025	
PLN RE-SUBMIT	5/14/2025	

PRINT DATE: 5/14/2025



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SHEET TITLE:

MAIN FLOOR PLAN

SHEET NUMBER:

FLOOR AND NO LESS THAN 15" ABOVE FINISHED FLOOR.

ENTRY LEVEL SHALL PROVIDE A NET CLEAR OPENING OF

NOT LESS THAN 32" MEASURED WITH THE DOOR POSITION

3. AT LEAST ONE BATHROOM AND ONE BEDROOM ON THE

AT AN ANGLE OF 90 DEGREES FROM THE CLOSED

MORE THAN 48" ABOVE THE EXTERIOR FLOOR OR

4. DOORBELL BUTTONS, WHEN INSTALLED, SHALL EXCEED

[R327.1.2]

POSITION.

LANDING. [R327.1.4]

3. SHOWER AND TUB WALLS SHALL HAVE FLOOR TO CEILING

OR NON-ASBESTOS FIBER-CEMENT REINFORCED

5. CONTRACTOR TO SEE ARCHITECTURTAL & STRUCTURAL

WALL DETAILS FOR ADDITIONAL NOTES REGARDING

7. PROVIDE BLOCKING AND/OR BACKING AT ALL TOWEL BAR

4. ALL DIMENSIONS ARE TO FACE OF STUD, UNLESS

6. SEE BUILDING SECTIONS SHEET FOR INSULATION

INSULATION, SHEAR, SOUND, ETC.

OTHERWISE NOTED.

SCHEDULE.

LOCATIONS.


GLASS MAT GYPSUM PANELS, FIBER-REINFORCED GYPSUM

CEMENTITIOUS BACKER UNITS INSTALLED IN ACCORDANCE

WITH MANUFACTURERS' RECOMMENDATIONS[R702.4.2]

PANELS, NON-ASBESTOS FIBER-CEMENT BACKER BOARD,

A2.1

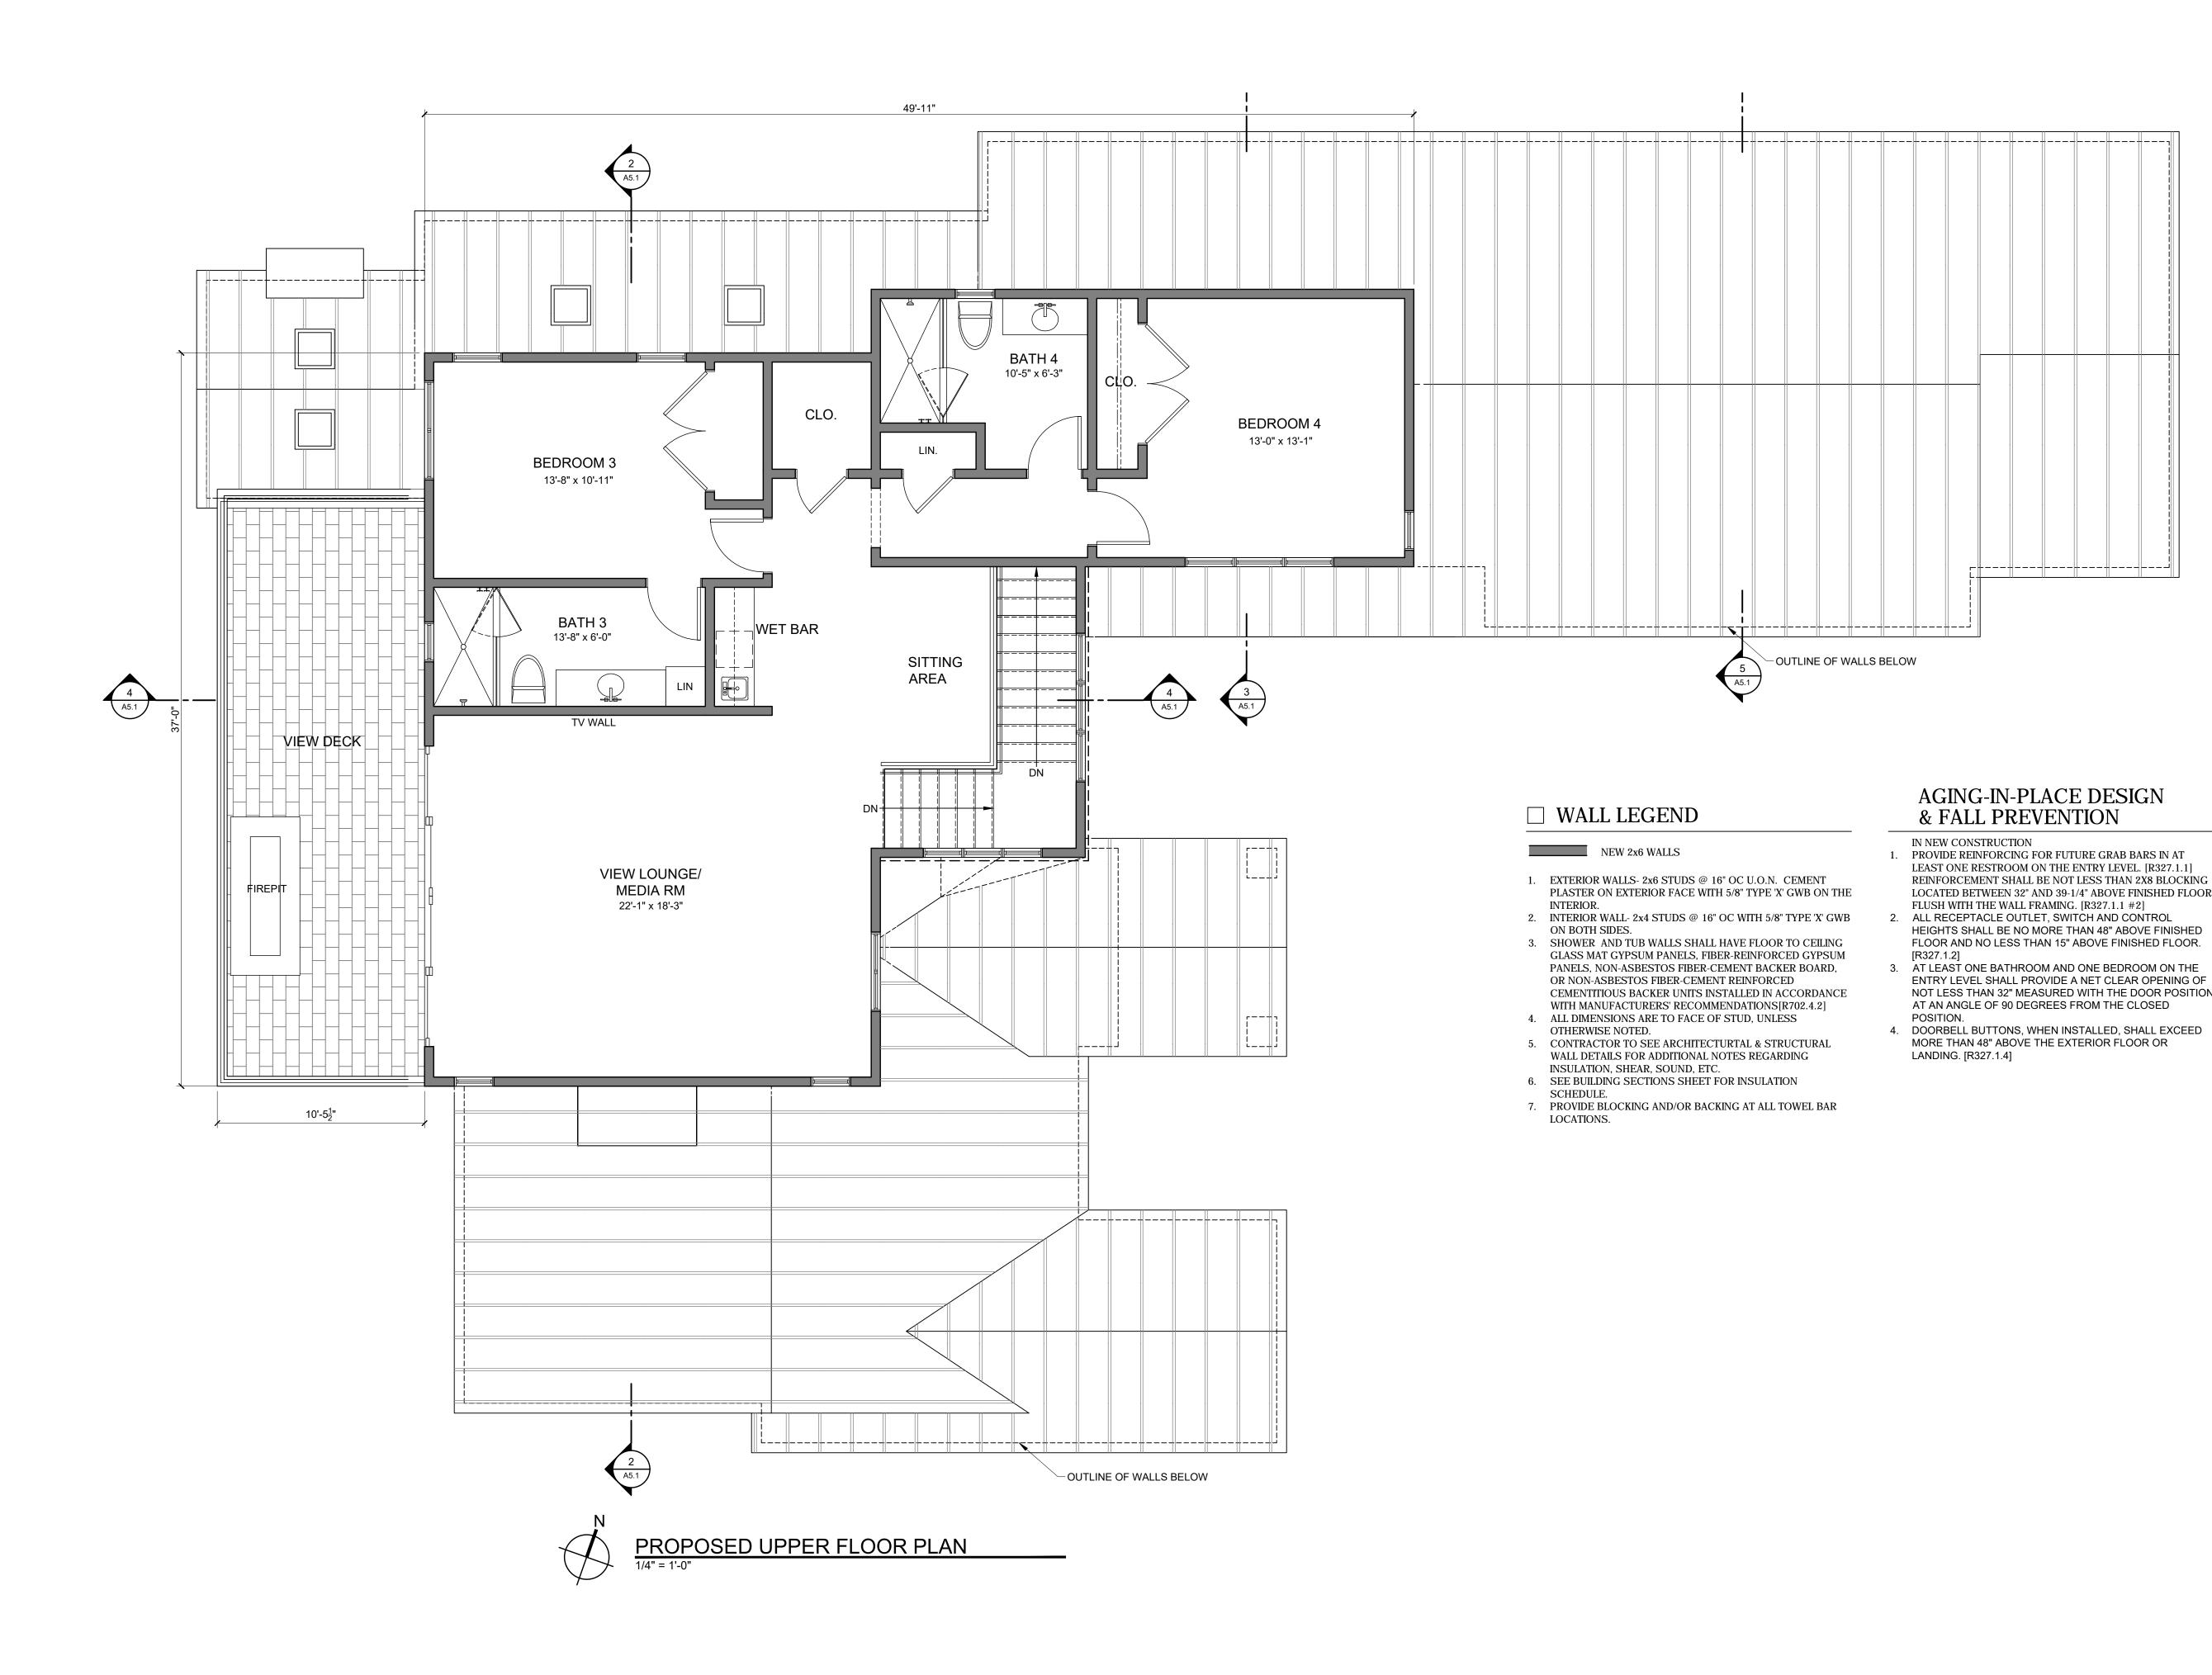

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## DRAWING RECORD

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AGING-IN-PLACE DESIGN & FALL PREVENTION

FLUSH WITH THE WALL FRAMING. [R327.1.1 #2]

LEAST ONE RESTROOM ON THE ENTRY LEVEL. [R327.1.1]

HEIGHTS SHALL BE NO MORE THAN 48" ABOVE FINISHED FLOOR AND NO LESS THAN 15" ABOVE FINISHED FLOOR.

ENTRY LEVEL SHALL PROVIDE A NET CLEAR OPENING OF

AT AN ANGLE OF 90 DEGREES FROM THE CLOSED

MORE THAN 48" ABOVE THE EXTERIOR FLOOR OR

NOT LESS THAN 32" MEASURED WITH THE DOOR POSITION

IN NEW CONSTRUCTION

[R327.1.2]

POSITION.

LANDING. [R327.1.4]

PRINT DATE: 5/14/2025




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SHEET TITLE:

UPPER FLOOR PLAN



## CASTLEMAN RESIDENCE

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DS \_\_10'-4" PLATE HT.

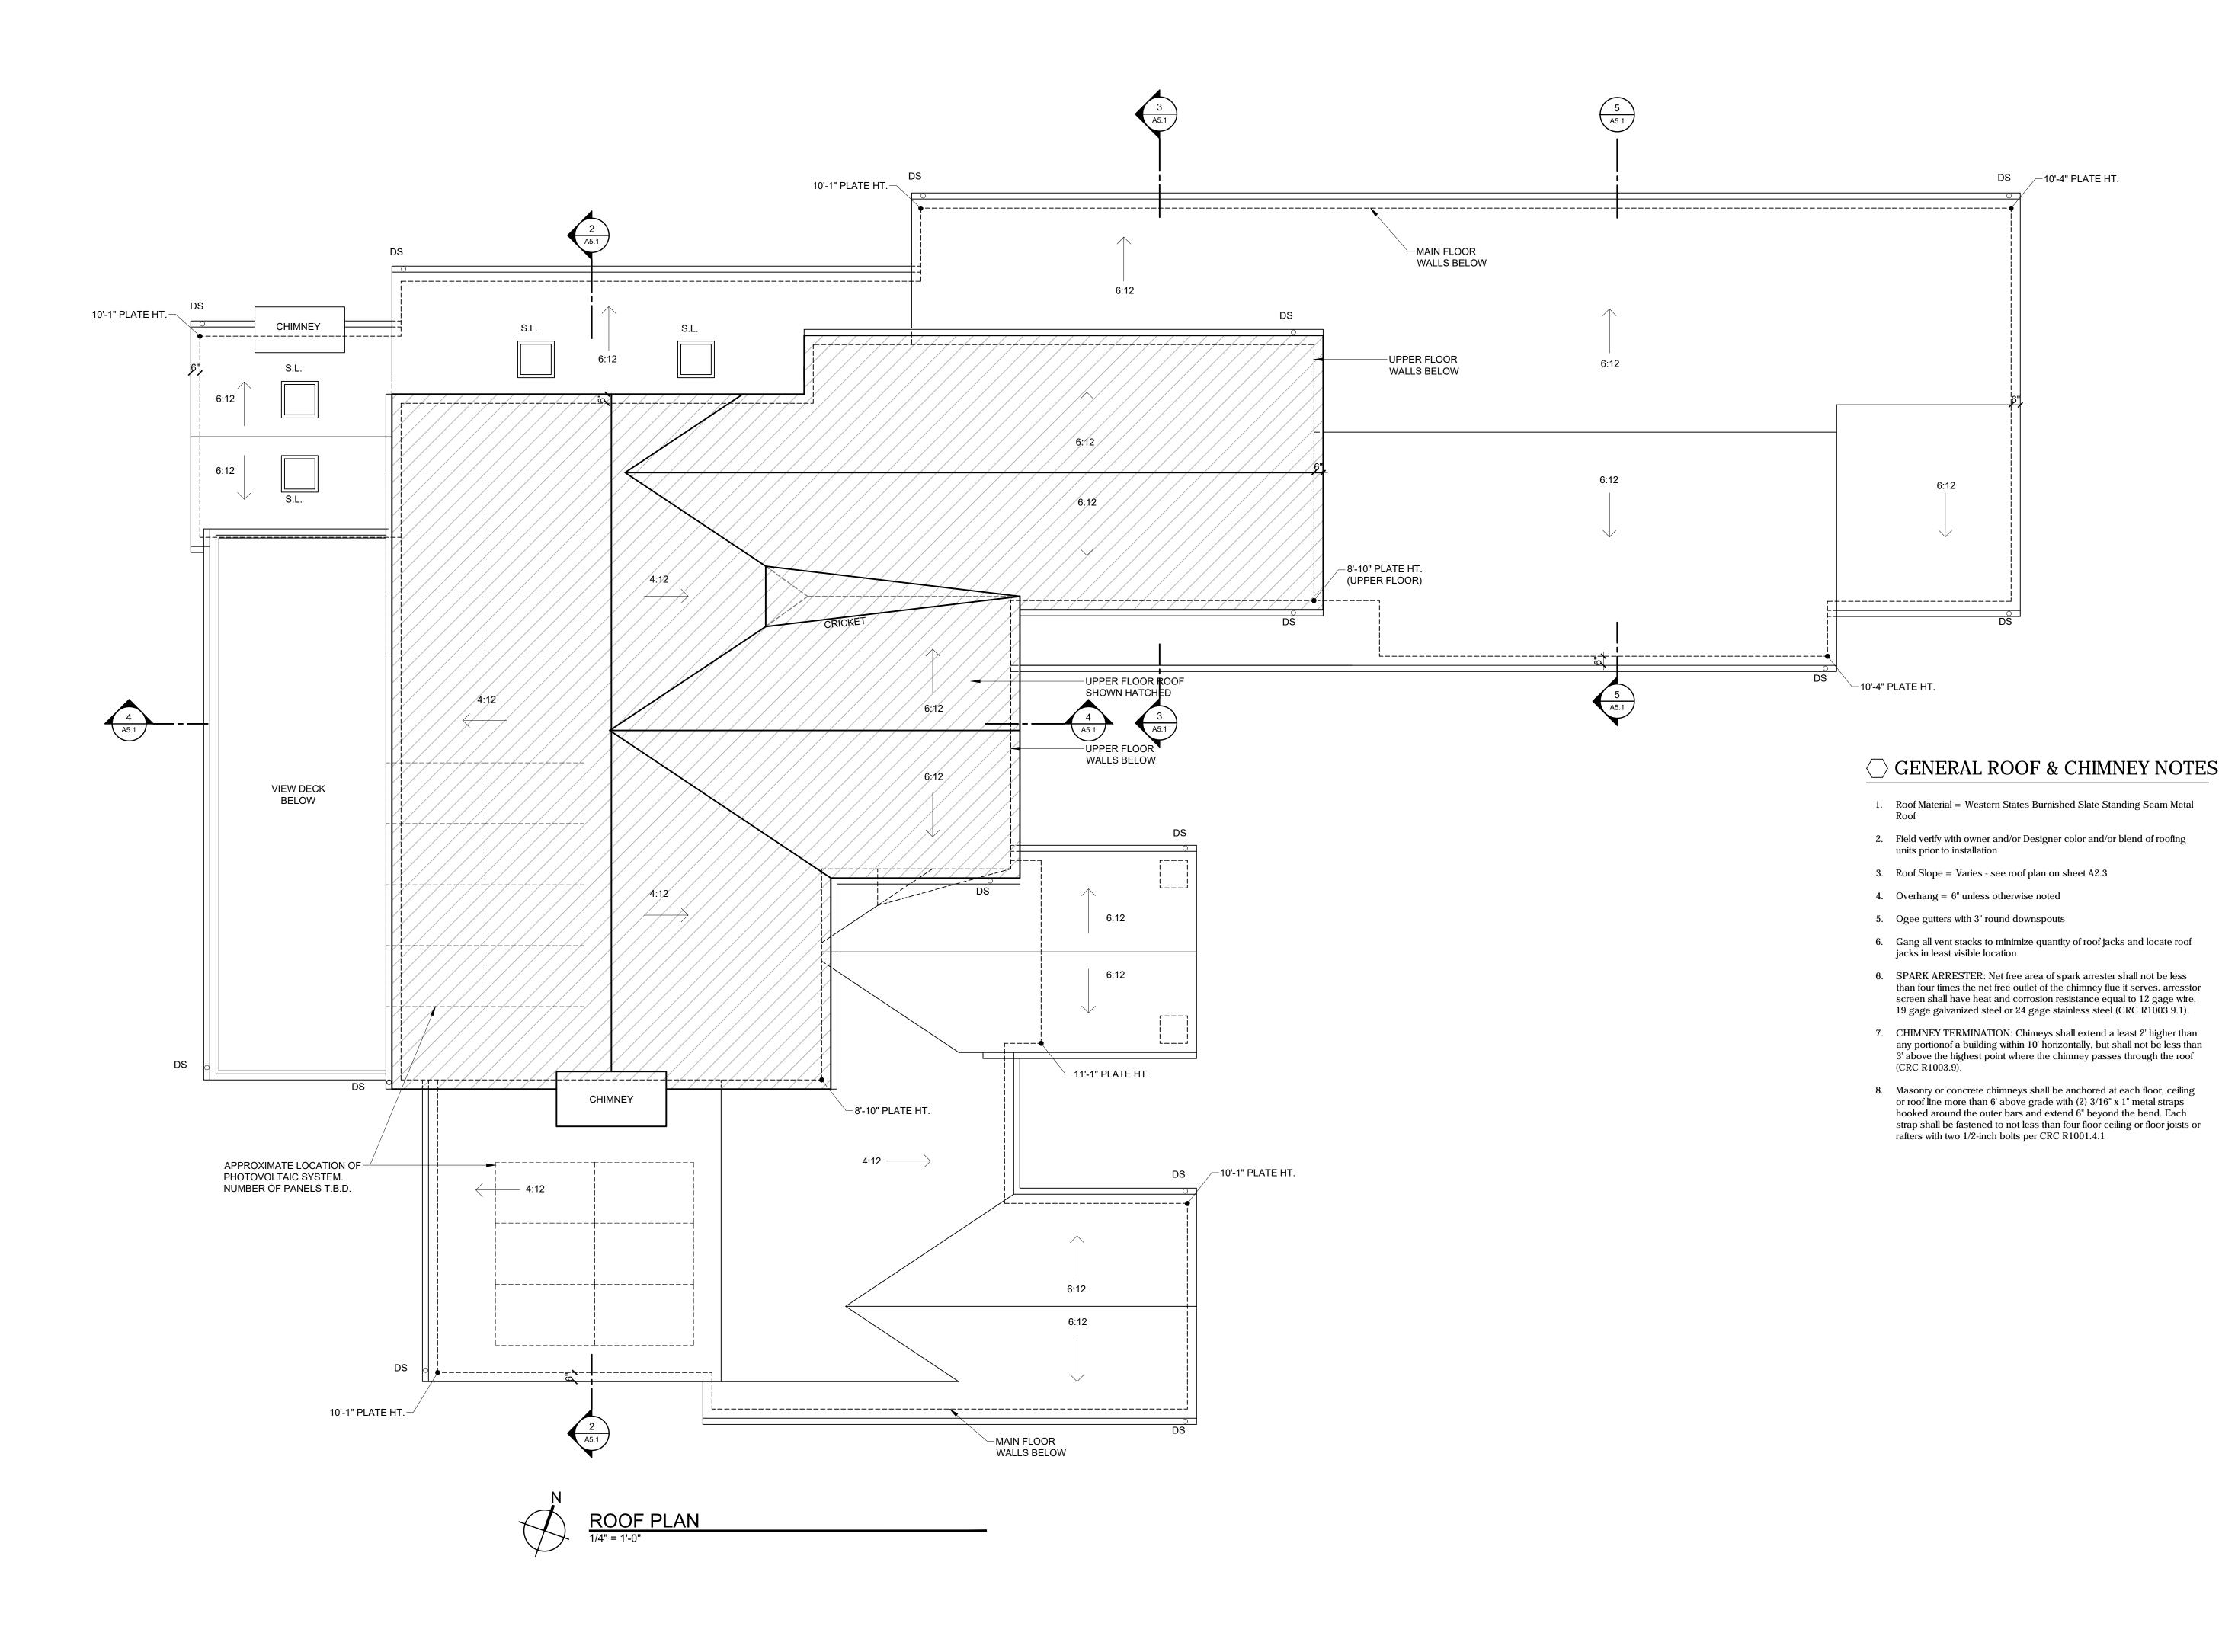APN: 007-282-004-000



CONSTRUCTION ADMINISTRATION 550 FIGUEROA STREET, SUITE B MONTEREY CA. 93940

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DRAWING 1	RECORD
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SHEET TITLE: **ROOF PLAN** 



CONCEPTUAL FRONT ELEVATION



CONCEPTUAL REAR ELEVATION

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	DRAWING RECORD	
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BUILDING DESIGN

5/14/2025

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SHEET TITLE: COLOR

RENDERINGS

SHEET NUMBER:

A4.0



PROPOSED EAST ELEVATION

1/4" = 1'-0"


# $\bigcirc$ SHEET NOTES

- 1. ROOF WESTERN STATES BURNISHED SLATE STANDING SEAM METAL ROOF
- 2. WALLS TWO COATS EXTERIOR PAINT (BODY COLOR SHERWIN WILLIAMS USEFUL GRAY SW7050), (TRIM COLOR - SHERWIN WILLIAMS SEALSKIN SW7675) OVER 7/8" CEM. PLASTER W/ EXP. METAL LATH & PLASTESIZER ADDITIVE ( 3 COAT PER CBC 2508.1) 0/2 LAYERS GRADE 'D' BLDG. PAPER.
- 3. WINDOWS QUARTZ NEW DARK BRONZE WOOD CLAD DOUBLE PANE WINDOWS.



PROPOSED SOUTH ELEVATION

1/4" = 1'-0"

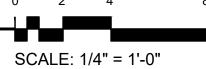

SCALE: 1/4" = 1'-0"

PROJECT NAME:

## CASTLEMAN RESIDENCE

1012 SAN CARLOS ROAD PEBBLE BEACH, CA 93953

APN: 007-282-004-000



MOORE DESIGN Inc. RESIDENTIAL PLANNING & CONSTRUCTION ADMINISTRATION

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PLN RE-SUBMIT	5/14/2025

PRINT DATE: 5/14/2025




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SHEET TITLE:


**ELEVATIONS** 



SCALE: 1/4" = 1'-0"

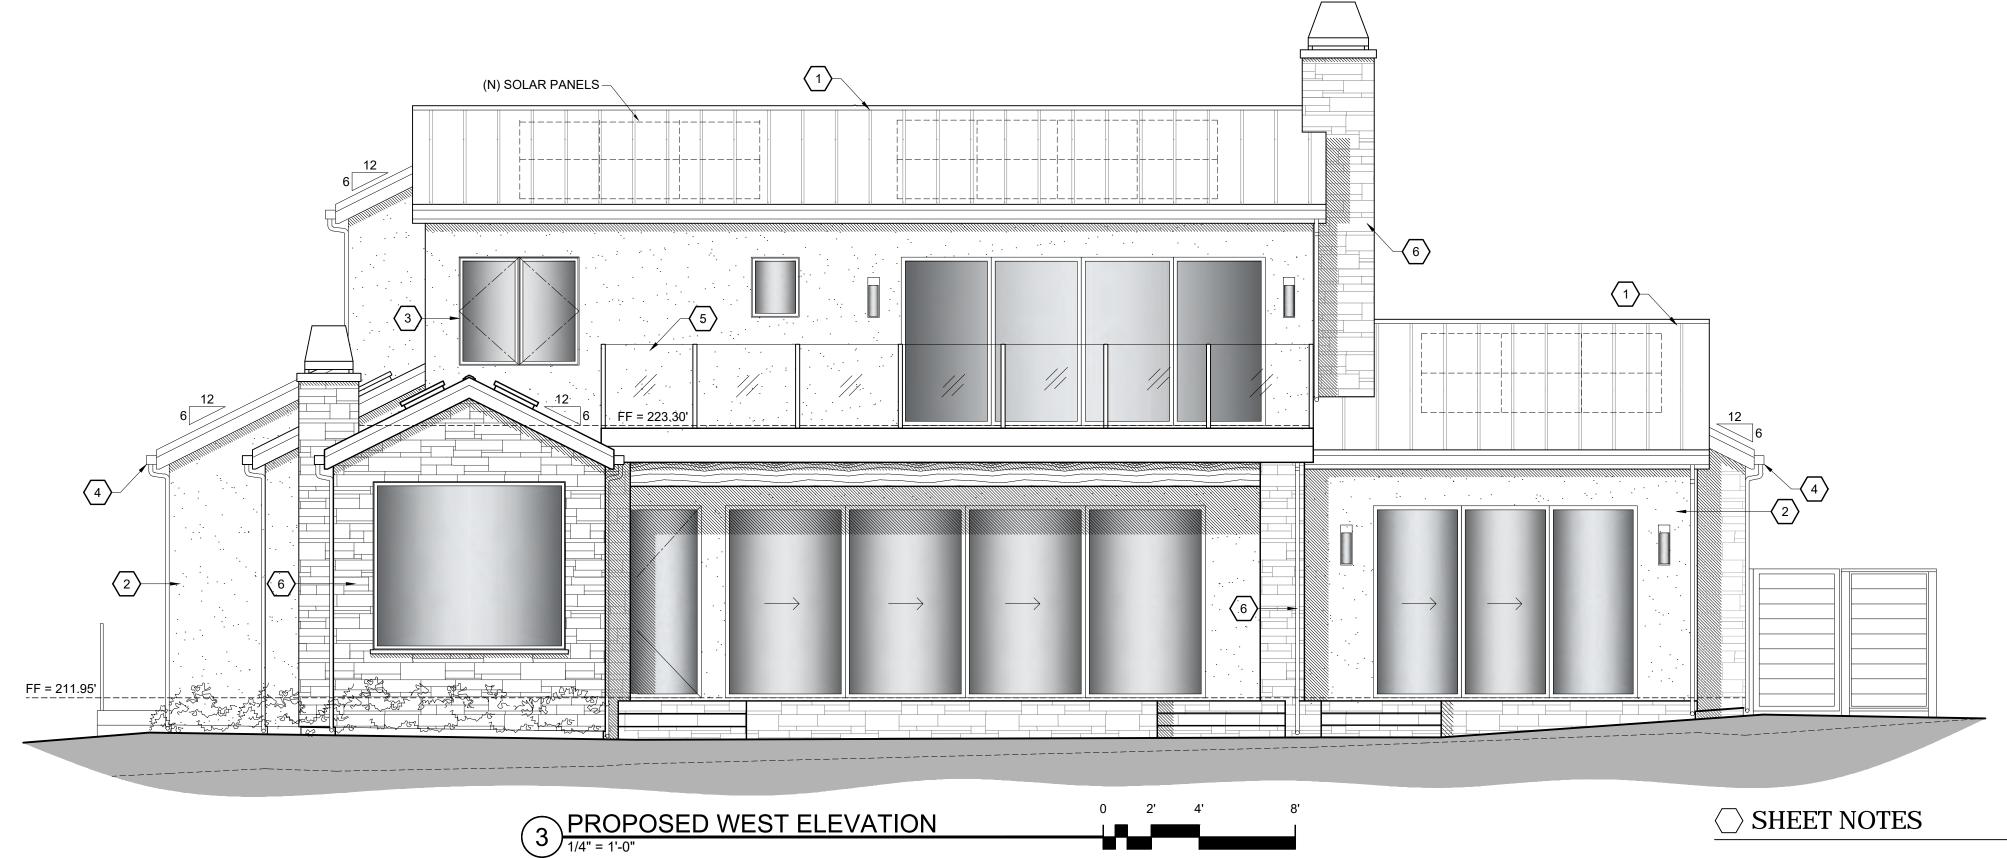SCALE: 1/4" = 1'-0"

- 1. ROOF WESTERN STATES BURNISHED SLATE STANDING SEAM METAL ROOF
- 2. WALLS TWO COATS EXTERIOR PAINT (BODY COLOR SHERWIN WILLIAMS USEFUL GRAY SW7050), (TRIM COLOR - SHERWIN WILLIAMS SEALSKIN SW7675) OVER 7/8" CEM. PLASTER W/ EXP. METAL LATH & PLASTESIZER ADDITIVE ( 3 COAT PER CBC 2508.1) 0/2 LAYERS GRADE 'D' BLDG. PAPER.
- 3. WINDOWS QUARTZ NEW DARK BRONZE WOOD CLAD DOUBLE PANE WINDOWS.
- 4. GUTTERS OGEE GUTTERS WITH 3" ROUND DOWNSPOUTS.
- 5. GUARDRAIL/ WINDSCREEN STARPHIRE ULTRA CLEAR GLASS PANELS.
- 6. STONE VENEER U.S. STONE SAINT CLERE
- 7. SKYLIGHT FLAT DARK ANODIZED
- 8. EXTERIOR LIGHTS HINKLEY ROOK WALL MOUNT BLACK LANTERN (1788SK-LL)

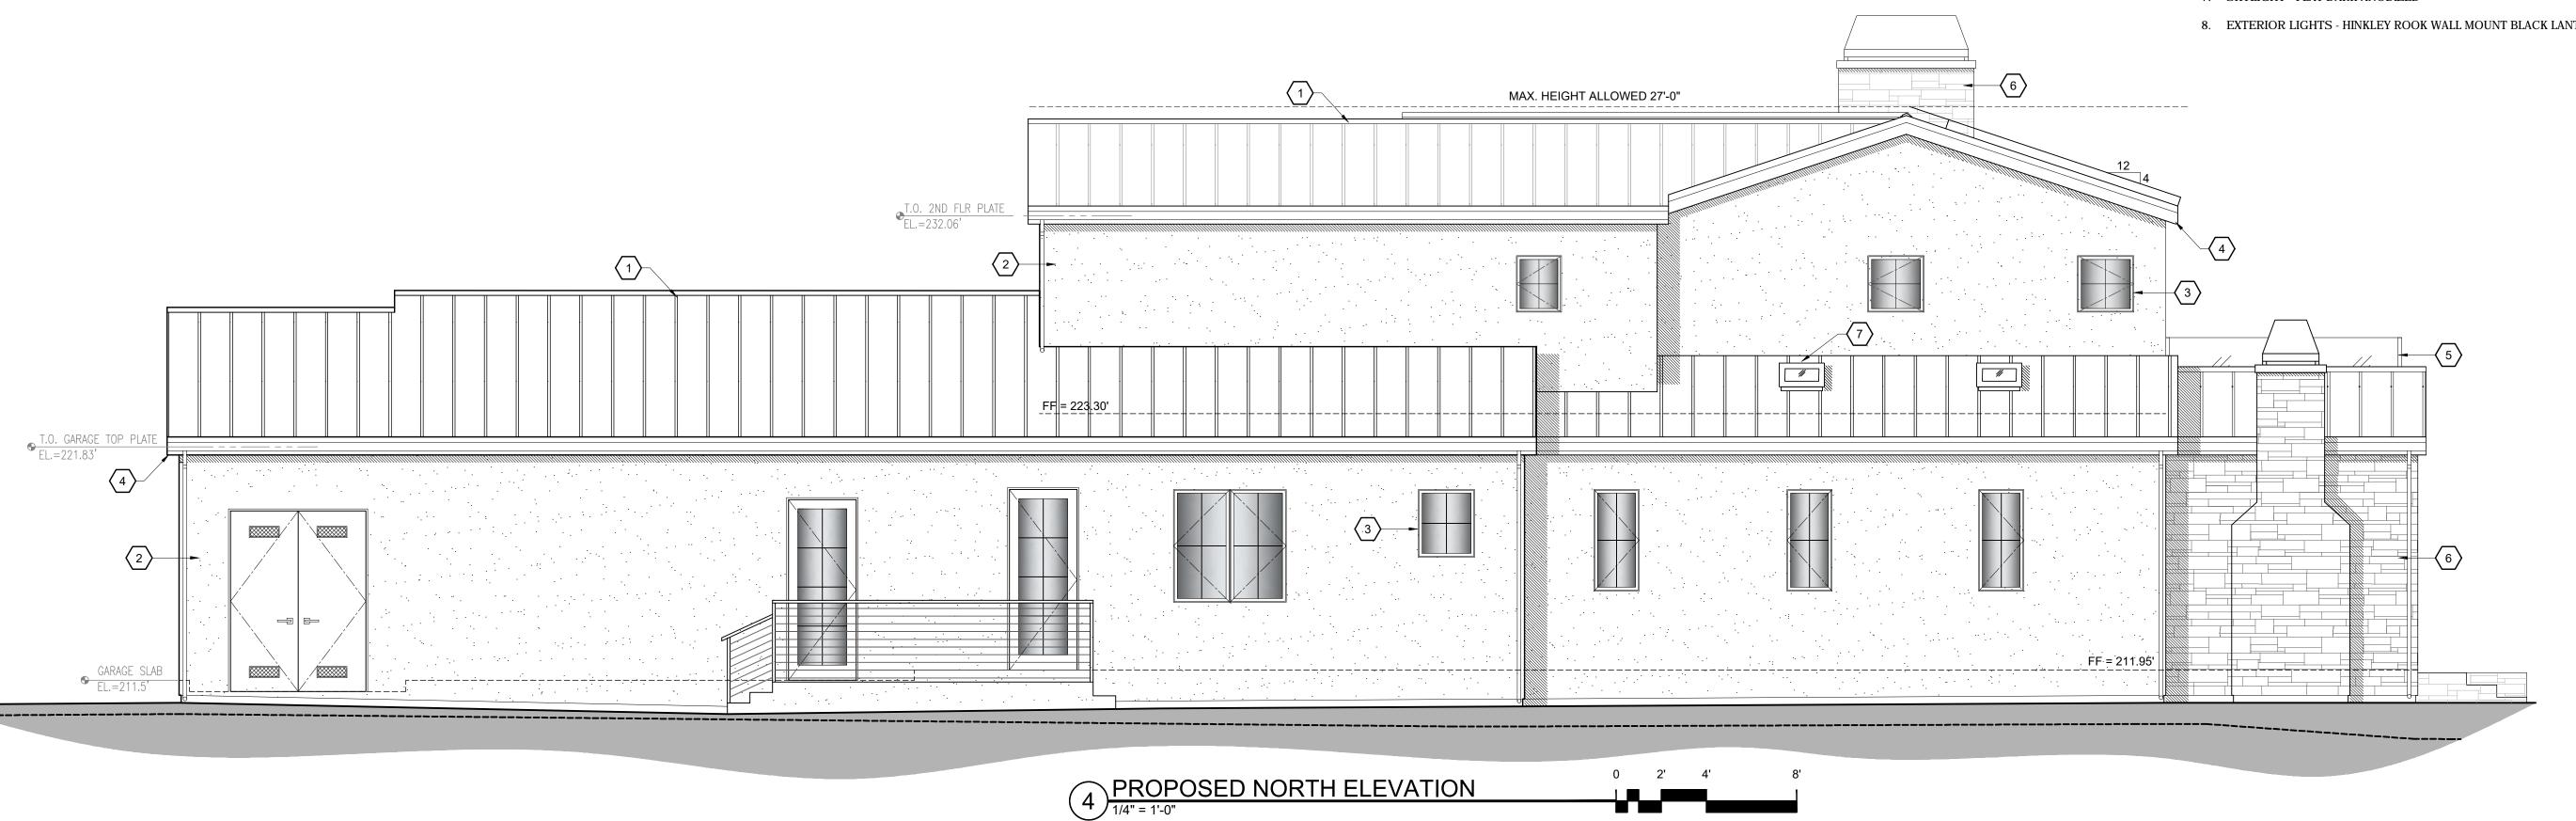

PROJECT NAME:

## CASTLEMAN RESIDENCE

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SHEET TITLE:

**ELEVATIONS** 

SHEET NUMBER:

A4.2