#### GENERAL CONDITIONS

- 1. Examination of the site and portions thereof which will affect this work shall be made immediately by the contractor, who shall compare it with the drawings and satisfy himself to conditions under which work is to be performed. He shall at such time ascertain and check locations of the existing structures and equipment which may affect his work.
- 2. Contractor shall provide a complete cost breakdown and schedule of construction for this project for owner approval prior to commencement of work.
- 3. Contractor shall be responsible to obtain and all necessary permits inspections, certificates, lien releases, final inspections, etc. Contractor to coordinate payment of permits with owner.
- 4. Contractor shall protect owner's area, new and/or existing materials and finishes from damage which may occur from construction, demolition, dust, water, etc., and shall provide and maintain temporary barricades, closure walls, etc., as required to protect the public and owner during the period of construction. Damage to new and existing materials, finishes, structures, and equipment shall be repaired or replaced. Contractor shall coordinate temporary barricades with owner prior to commencement of work as necessary.
- 5. Materials that are specified by their brand names establish standards of quality and performance. any request for substitution shall be submitted to Moore Design llc and owner for review for equal quality and performance and shall not be purchased or installed without their written approval. All non-specified products shall conform to requirements set forth by code compliance or industry standards and contractor shall submit a list of products and manufacturers being used for review by the designer prior to purchase or installation.
- 6. All construction work, architectural, mechanical, plumbing, electrical, etc., as may be required, shall conform to the latest edition of the California Building Code/ California Residential Code and the latest edition of all governing codes and regulations as adopted by the governing jurisdiction. All work shall be done in a thorough, workmanlike manner and equal to the best standards of the practice.
- 7. All dimensions on constructions drawings are face of stud (f.o.s.), face of cmu, unless otherwise noted to be the center line of mullion, partition, or column, etc.
- 8. All dimensions take precedence over scale. Any discrepancies shall be brought immediately to the attention of Moore Design. Contractors shall not scale drawings. Questions regarding dimensions shall be brought to the designer or
- 9. All construction documents are complementary, and what is called for by any will be binding as if called for by all. Any work shown or referred to on any construction documents shall be provided as though on all related documents. Discrepancies shall be brought immediately to the attention of the designer for clarification.
- 10. All work listed, shown or implied on any construction document shall be supplied and installed by the contractor except where noted. The contractor shall closely coordinate his work with that of other contractors or vendors to assure that all schedules are met and that all work is done in conformance with manufacturer's requirements. Work required under this contract shall include all labor, materials, equipment, etc. necessary to complete this project. All materials shall be new and unused, unless specifically noted and be a quality acceptable by industry standards.
- 11. The use of the word "provide" in connection with any item specified is intended to mean that such shall be furnished, installed, and connected where so required, except as noted.
- 12. The contractor shall submit shop drawings for fabricated items, cut sheets of all fixtures and equipment, and samples of all finishes called for by the designer and owner for approval prior to construction and/or installation.
- 13. The contractor shall maintain a current and complete set of construction documents on the job site during all phases of construction for use of all trades and shall provide all subcontractors with current construction documents as required. The contractor, in assuming responsibility for the work indicated, shall comply with the spirit as well as with the letter in which they were drawn.
- 14. The contractor shall remove all rubbish and waste materials of all subcontractors and trades on a regular basis, and shall exercise strict control over job cleaning to prevent any dirt, debris or dust from affecting, in any way, finished
- 15. The construction documents are provided to illustrate the design and general type of construction desired and imply the finest quality of construction, material and workmanship throughout.
- 16. All electrical, mechanical, and plumbing work and materials shall be in full accordance with the latest rules and regulations of the national board of fire underwriters, the state fire marshall, the safety orders of the division of industrial safety, and any applicable state or local laws and ordinances. Nothing on these drawings is to be construed to permit work not conforming to these codes.
- 17. Work which is obviously required to be performed in order to provide a completely operable installation within the limits and scope of work, but which may not be specifically included in the plans, shall be performed by contractor
- 18. All work shall be guaranteed against defects in design, installation and material for a minimum period of one year from date of completion.

TYPICAL

WITH

WITHOUT

WALK IN CLOSET

UNLESS OTHERWISE

U.O.N.

W/0

W.I.C.

BLOCK

F.O.C.

GALV.

G.W.B.

N.LC.

N.T.S.

CLOSET

DOWNSPOUT

DISHWASHER

FACE OF STUD

GALVANIZED

HARDWOOD

NOT TO SCALE

GYPSUM WALLBOARD

NOT IN CONTRACT

**GYPSUM** 

- 19. Contractor shall personally supervise and direct the work or shall keep a competent employee, authorized to receive instructions and act on the contractor's behalf, continuously on site during working hours.
- 20. Trees adjacent to structures and over driveways shall be trimmed to clear structures and provide 15' clearance over drives. Protect other trees during construction (see forest mgt. plan). No tree shall be removed unless called for in the plans and a permit is first issued by the local jurisdiction.

#### ABBREVIATIONS AND SYMBOLS ON CENTER OUTSIDE DIAMETER WALL LINE PLYWD PLYWOOD SECTION IDENTIFICATION SHEET WHERE SECTION IS DRAWN REFRIGERATOR LETTERS HORIZONTAL ROUGH OPENING SHOWER ELEVATION IDENTIFICATION FACE OF CONCRETE SHEET WHERE ELEVATION IS DRAWN TOP OF PLATE

SHEET WHERE DETAIL IS LOCATED

CLOUD AROUND REVISION OPTIONAL

www.

## VICINITY MAP 102-01 TAX CODE AREA ASSESSOR'S MAP BOOK 007 PAGE 28-2 **PROJECT** SOMBRERO ROAD 37 - 1ROAD CLUB LOT 8 CLUB LOT 8 M.P.C.C. SUB. NO. 2 BLK. 216 LOTS 13 TO 32 BLK. 215 THIS MAP IS INTENDED TO BE USED FOR PROPERTY TAX ASSESSMENT PURPOSES ONLY

# THE CASTLEMAN RESIDENCE

PEBBLE BEACH,



MIKE & CAROL CASTLEMAN

1012 SAN CARLOS ROAD PEBBLE BEACH, CA 93953

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KRISTEN PENA INTERIORS CONTACT: KRISTEN PENA

SAN FRANCISCO, CA. 94114

EMAIL: KRISTEN@KINTERIORS.COM

NINA CAPRIOLA LANDSCAPE DESIGN

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CONTACT: NINA CAPRIOLA

MONTERRA CONSTRUCTION

CONTACT: CRAIG FURMAN

MONTERRACONSTRUCTION@COMCAST.NET

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LANDSET ENGINEERS, INC.

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CONTACT: DAVID KNIGHT

CARMEL, CA. 93923

TEL (831) 250-0314 EMAIL: cad@meg4.com

EMAIL: GGIRAUDO@LANDSETENG.COM

26465 CARMEL RANCHO BLVD., SUITE 8

404 WESTRIDGE DRIVE

MONTEREY, CA 93940

TEL (831) 760-0218 LIC. # 772807

EMAIL: ninacapriola@gmail.com

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4071 24TH STREET

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MOORE DESIGN INC. CONTACT: JOHN MOORE 550 FIGUEROA STREET, SUITE B MONTEREY, CA. 93940 OFFICE (831) 642-9732 CELL (831) 238-6868

SHEET INDEX	PROJECT DIRECTORY

**DESIGNER:** 

■ INTERIOR DESIGNER:

■ LANDSCAPE DESIGNER:

■ GENERAL CONTRACTOR:

■ GEOTECHNICAL ENGINEER:

■ STRUCTURAL ENGINEER:

■ TITLE 24 CONSULTANT:

ARCHITECTURAL	
A0.1	COVER SHEET
A1.1	SITE PLAN
L.1	LANDSCAPE PLAN
L.2	FUEL MANAGEMENT PLAN
C1	GRADING DRAINAGE & UTILITY PLAN
C2	GRADING SECTIONS
C3	EROSION & SEDIMENT CONTROL PLAN
C4	CONSTRUCTION MANAGEMENT PLAN
A2.1	MAIN FLOOR PLAN
A2.2	UPPER FLOOR PLAN
A2.3	ROOF PLAN
A4.0	COLOR RENDERINGS
A4.1	EXTERIOR ELEVATIONS
A4.2	EXTERIOR ELEVATIONS

## CAL GREEN NOTES

- Irrigation Controllers- Automatic irrigation controllers installed at the time of final inspection shall be weathered-based.
- 2. Rodent Proofing- Protect annular spaces around pipes, electrical cables, conduits or other openings at exterior walls against passage of rodents. CGBC 4.406.1
- 3. Construction Waste Management- Recycle and/or salvage for reuse a minimum of 65% of the nonhazardous construction and demolition waste in accordance with the CGBC Sec. 4.408.1
- 4. Covering of Mechanical Equipment & Ducts- Cover duct openings and other air related air distribution component openings during storage, construction and until final start up with tape, plastic, or other acceptable method. CGBC
- Adhesives, sealants and caulks- Adhesives, sealants and caulks used on the project shall be compliant with VOC and other toxic compound limits. CGBC 4.504.2.1
- Paint and Coatings- Paint, stains and other coatings used on the project shall be compliant with VOC limits. CGBC
- Aerosol paints and coatings- Aerosol paints and coatings used on the project shall be compliant with product weighted MIR limits for ROC and other toxic compounds. Documentation shall be provided to verify compliant VOC limit finish materials have been used. CGBC 4.504.2.3. Verification of compliance shall be provided. Carpet Systems- All carpet and carpet systems installed shall be compliant with VOC limits. CGBC 4.504.3
- Resilient Floor Systems- 80% of the floor area receiving resilient floorings shall comply with the VOC emission limits defined in the Collaborative for High Performance Schools (CHPS) low-emitting materials list or be certified under the Resilient Floor Covering Institute (RFCI) FloorScore program. CGBC 4.504.4
- 10. Composite Wood Products- Particleboard, Medium density fiberboard (MDF) and hardwood plywood used in interior finish systems shall comply with low formaldehyde emission standards. CGBC 4.504.5
- 11. Foundation: Capillary Break- A 4" thick of 1/2" or larger clean aggregate shall be installed with a vapor retarder in direct contact with concrete. CGBC 4.505.2.1 12. Moisture Content of Building Materials- Building materials with visible signs of water damage shall not be installed.
- Wall and floor framing shall not be enclosed when the framing members exceed 19% moisture content. CGBC 4.505.3 13. Bathroom Exhaust Fans- Each bathroom shall be mechanically ventilated with an Energy Star exhaust fan and the fan
- must be controlled by a humidstat capable of adjustment between a relative humidity range of < 50% to a maximum of
- 14. Heating and Air-Conditioning System Design- HVAC systems shall be sized, designed and their equipment sized per CGBC 4.507.2. HVAC system installer must be trained and certified and special inspectors employed by the enforcing

#### PLANNING CONDITIONS BUILDING DEPARTMENT NOTES

#### PD003(A) - CULTURAL RESOURCES NEGATIVE ARCHAEOLOGICAL REPORT

If, during the course of construction, cultural, archaeological, historical or paleontological resources are uncovered at the site (surface or subsurface resources) work shall be halted immediately within 50 meters (165 feet) of the find until a qualified professional archaeologist can evaluate it. Monterey County RMA - planning and a qualified archaeologist (i.e., an archaeologist registered with the register of professional archaeologists) shall be immediately contacted by the responsible individual present on-site. When contacted, the project planner and the archaeologist shall immediately visit the site to determine the extent of the resources and to develop proper mitigation measures required for recovery.

#### PD014(A) - LIGHTING - EXTERIOR LIGHTING PLAN

All exterior lighting shall be unobtrusive, down-lit, harmonious with the local area, and constructed or located so that only the intended area is illuminated and off-site glare is fully controlled. The lighting source shall be shielded and recessed into the fixture. The applicant shall submit three (3) copies of an exterior lighting plan which shall indicate the location, type, and wattage of all light fixtures and include catalog sheets for each fixture. The lighting shall comply with the requirements of the California Energy Code set forth in California Code of Regulations Title 24 part 6. The exterior lighting plan shall be subject to approval by the director of RMA - Planning, prior to the issuance of building permits.

#### No person may tap into any fire hydrant other than fire suppression or emergency aid, without first obtaining written approval from the water purveyor supplying water to the hydrant and from the monterey county health department.

- All hoses used in connection with any construction activities shall be equipped with a nozzle shut-off. when an automatic shut-off nozzle can be purchased or otherwise obtained for the size or type of hose in use, the nozzle shall be an automatic shut-off nozzle.
- 3. No potable water may be used for compaction or dust control purposes in construction activities where there is a reasonably available source of reclaimed or other sub-potable water approved by the monterey county health department and appropriate
- The use of solders containing more than 2/10ths of 1% lead in making joints on private or public water supply systems is
- 5. Provide non-removable backflow devices at all hosebibs.

### PROJECT INFORMATION

■   I	PROJECT ADDRESS:		1012 SAN CARLOS ROAD PEBBLE BEACH, CA 93953			
	A.P.N.	007-282-00	4-000			
■ I	PROJECT SCOPE:	STORY RES	DEMOLISH EXISTING RESIDENCE & GARAGE (1,870 SF), NEW 2 STORY RESIDENCE WITH ATTACHED 2-CAR GARAGE (4,705 SF), NEW COVERED ENTRY (85 SF) AND REAR COVERED TERRACE (30 SF), NEW PHOTOVOLTAIC SYSTEM, NEW FENCES			
■ I	PROJECT VALUATION:	\$1,850,000				
■ I	RELATED PERMIT	NONE				
■ I	PROJECT CODE COMPLIANCE:	2022 - Title 24, California Residential Code (CRC), California Building Code (CBC), California Mechanical Code (CMC), California Plumbing Code (CPC), California Electrical Code (CEC California Energy Code (CEnC), California Green Building Standards Code (CALGREEN), California Fire Code (CFC), Monterey Co. Code Local Amendments				
<b>=</b> 2	ZONE:	MDR/B-6-D				
<b>1</b>	YEAR CONSTRUCTED:	1955				
<b>I</b>	MAX BLDG. HT:	26'-7" (27'-0	)" ALLOWED)			
<b></b>	CONSTR. TYPE:	TYPE V-B	TYPE V-B			
	OCCUPANCY:	R-3 (RESIDI	ENTIAL), U			
■ I	FIRE SPRINKLERS	REQUIRED N	IFPA-13D			
<b>I</b>	WATER SYSTEM:	CAL AM				
<b>S</b>	SEWER SYSTEM:	PBCSD				
<b>1</b>	TREE REMOVAL:	NONE				
<b>1</b>	TOPOGRAPHY:	FLAT				
<b>1</b> (	GRADING:	T.B.D				
■ I	LOT SIZE:	.31 ACRES / 13,529 SF				
L	OT COVERAGE	EXISTING	DEMO	NEW	PROPOSED	
<u> </u>	RESIDENCE	1,383	-1,383	2,703	2,703	
G	GARAGE	487	-487	779	779	
S	SECOND FLOOR VIEWING DECK	0	0	310	310	
5	SUB-TOTAL	1,870 SF	-1,870 SF	3,792 SF	3,792 SF	

SUB-TOTAL	1,87	0 SF	-1,870 SF	3,792 SF	3,792 SF
 ALLOWED 35% = 4,735 SF PROPOSED 28% = 3,792 SF					
FLOOR AREA CALCS:	ALLOW	ED (35%)	= 4,735 SF	PROPOS	SED (34.8%) 4,705 SF
	EXISTING	DEMO	ADDITI	ONS	TOTAL
MAIN FLOOR	1,383	-1,383	2,70	3	2,703
UPPER FLOOR	0	0	1,22	3	1,223
GARAGE	487	-487	779	)	779
TOTAL	1,870 SF	-1,870 S	F 4,705	SF	4,705 SF

PROJECT NAME:

#### **CASTLEMAN** RESIDENCE

1012 SAN CARLOS PEBBLE BEACH, CA APN: 007-282-004-000



550 FIGUEROA STREET, SUITE B MONTEREY CA. 93940 831.642.9732 FAX 831.401.3292 john@mooredesign.org

DRAWING RECORD		
DESCRIPTION	ISSUED	
PLN SUBMIT	3/12/202	
PLN RE-SUBMIT	5/14/202	
PRINT DATE:	5/14/2025	

MEMBER 


BUILDING DESIGN

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Drawings are not to be scaled. Written dimensions on these drawings shall have precedence over scale

SHEET TITLE:

COVER SHEET / PROJECT INFO

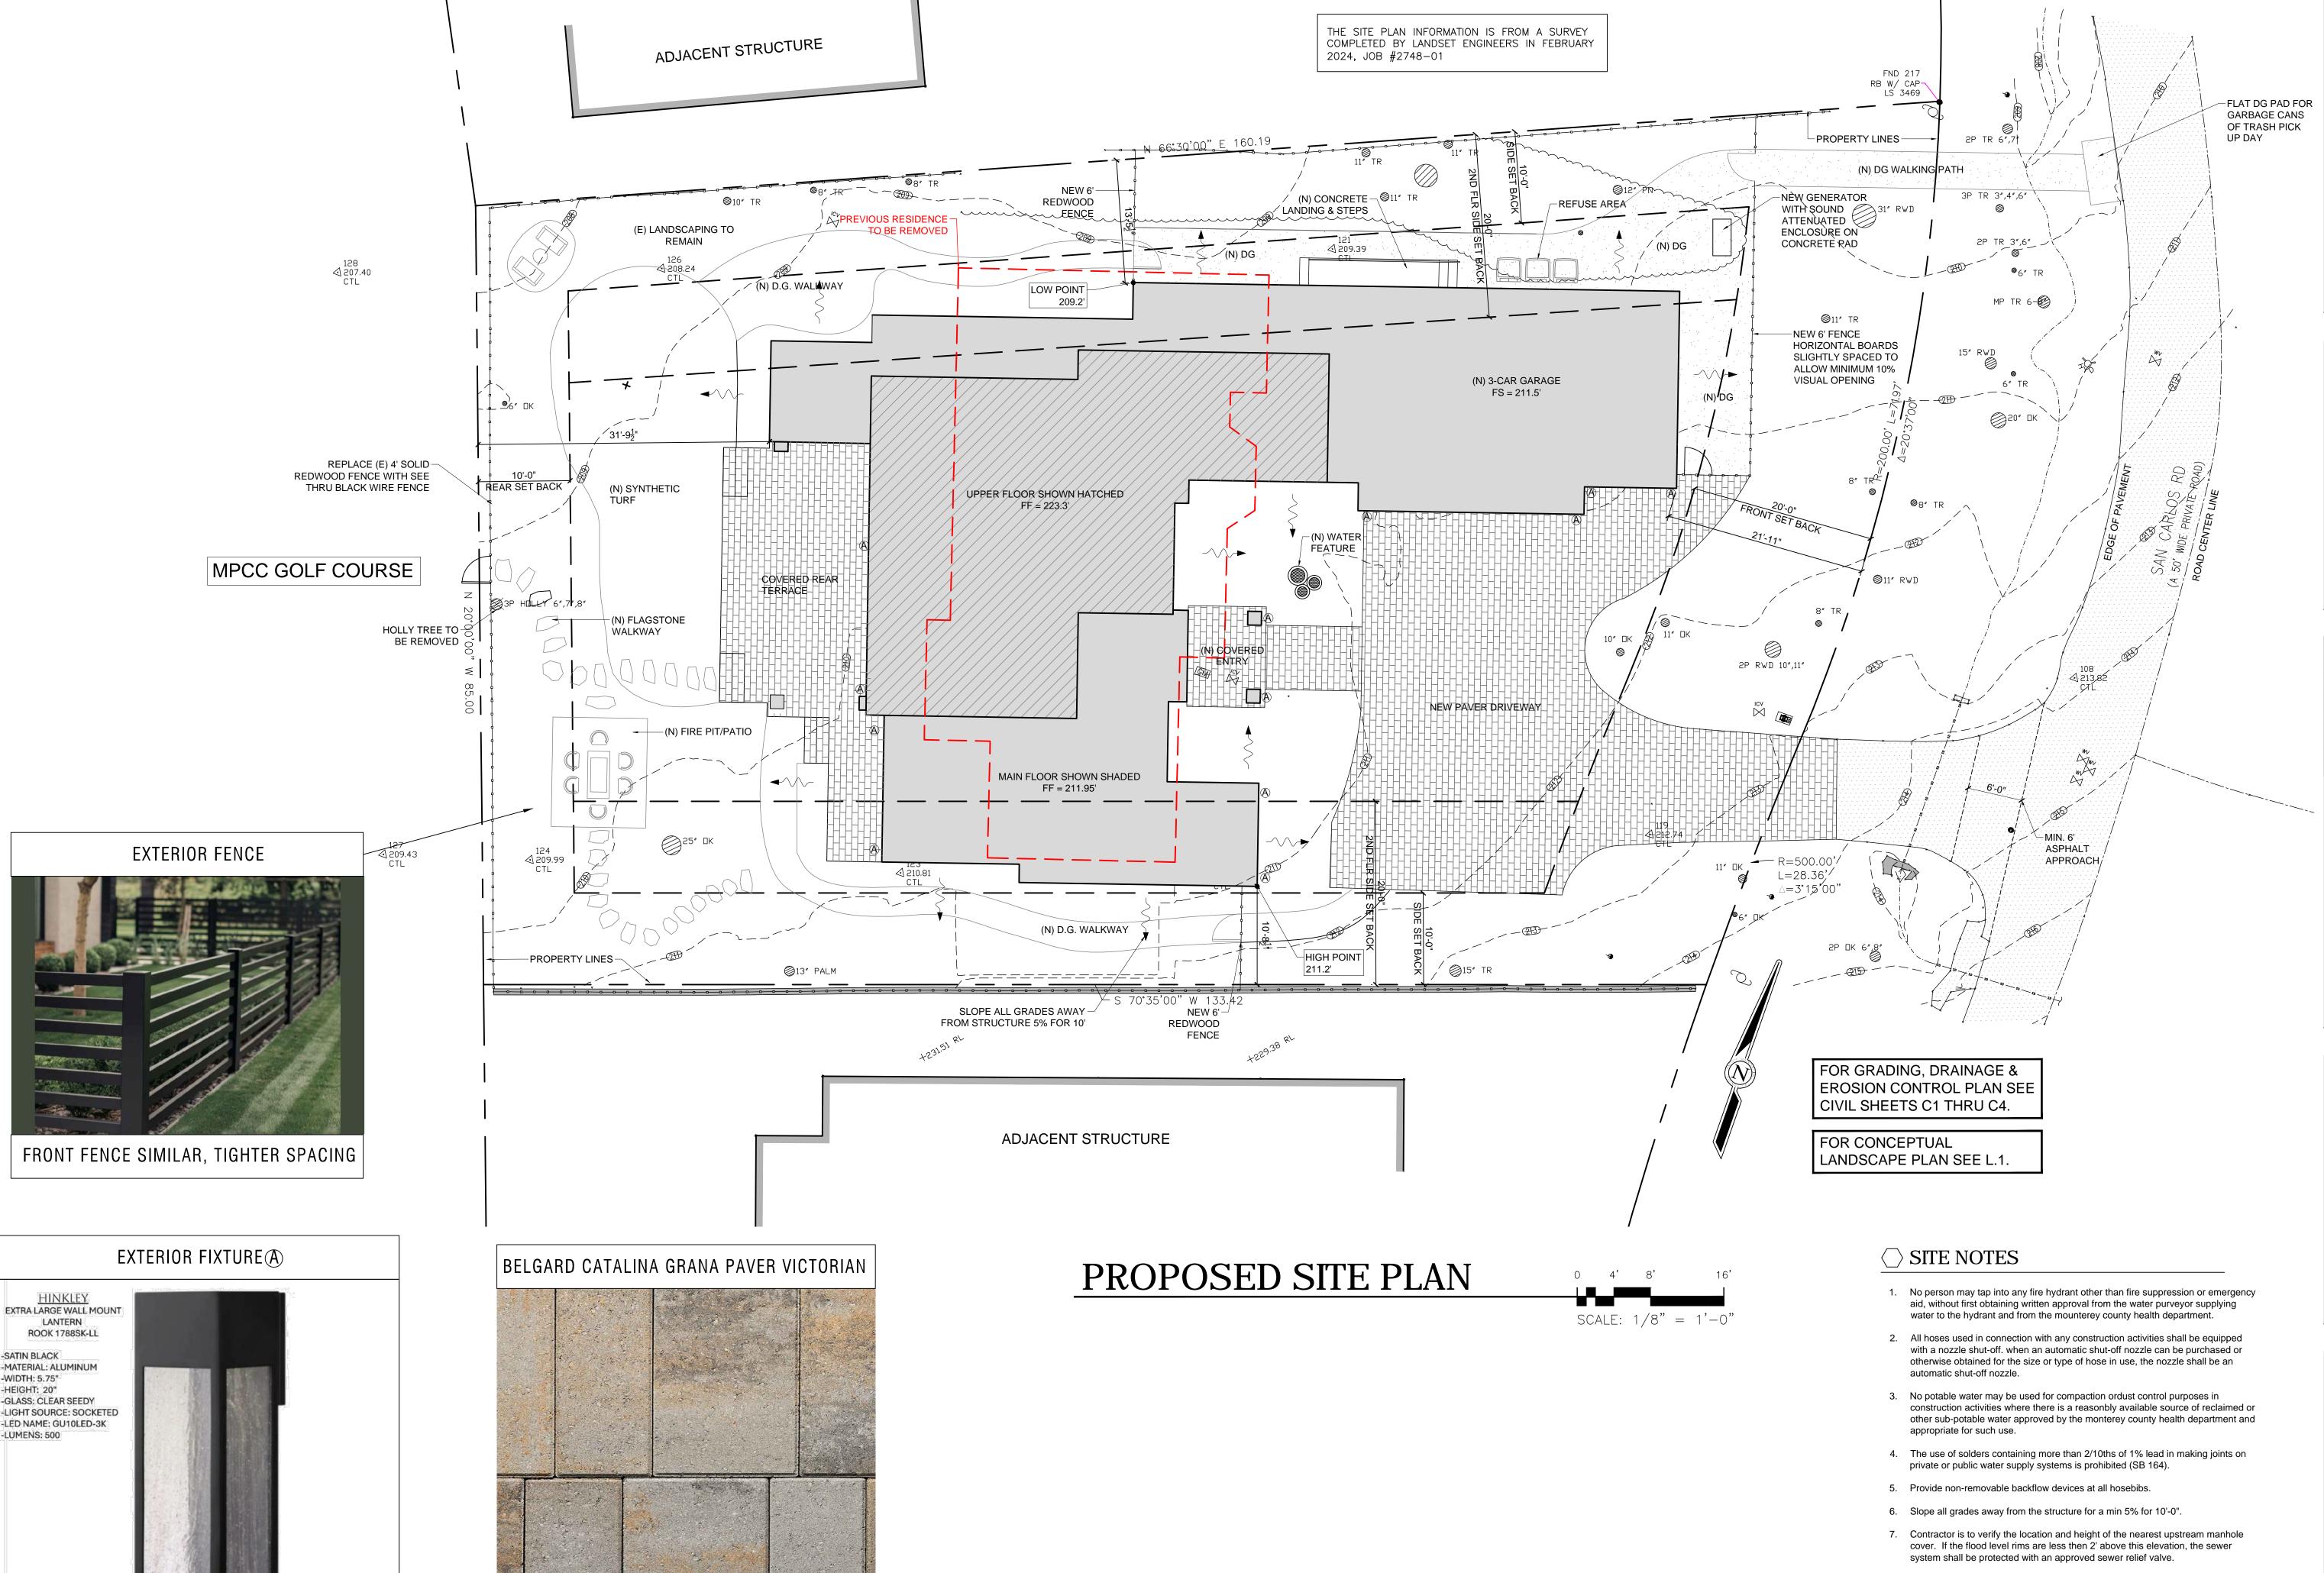

### CASTLEMAN RESIDENCE

1012 SAN CARLOS ROAD PEBBLE BEACH, CA

93953 APN: 007-282-004-000

MOORE DESIGN Inc.

RESIDENTIAL PLANNING & CONSTRUCTION ADMINISTRATION

550 FIGUEROA STREET, SUITE B MONTEREY CA. 93940 831.642.9732 FAX 831.401.3292 john@mooredesign.org

DRAWING RECORD		
DESCRIPTION	ISSUED	
PLN SUBMIT	3/12/2025	
PLN RE-SUBMIT	5/14/2025	

PRINT DATE: 5/14/2025




AMERICAN INSTITUTE of BUILDING DESIGN


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SHEET TITLE:

SITE PLAN



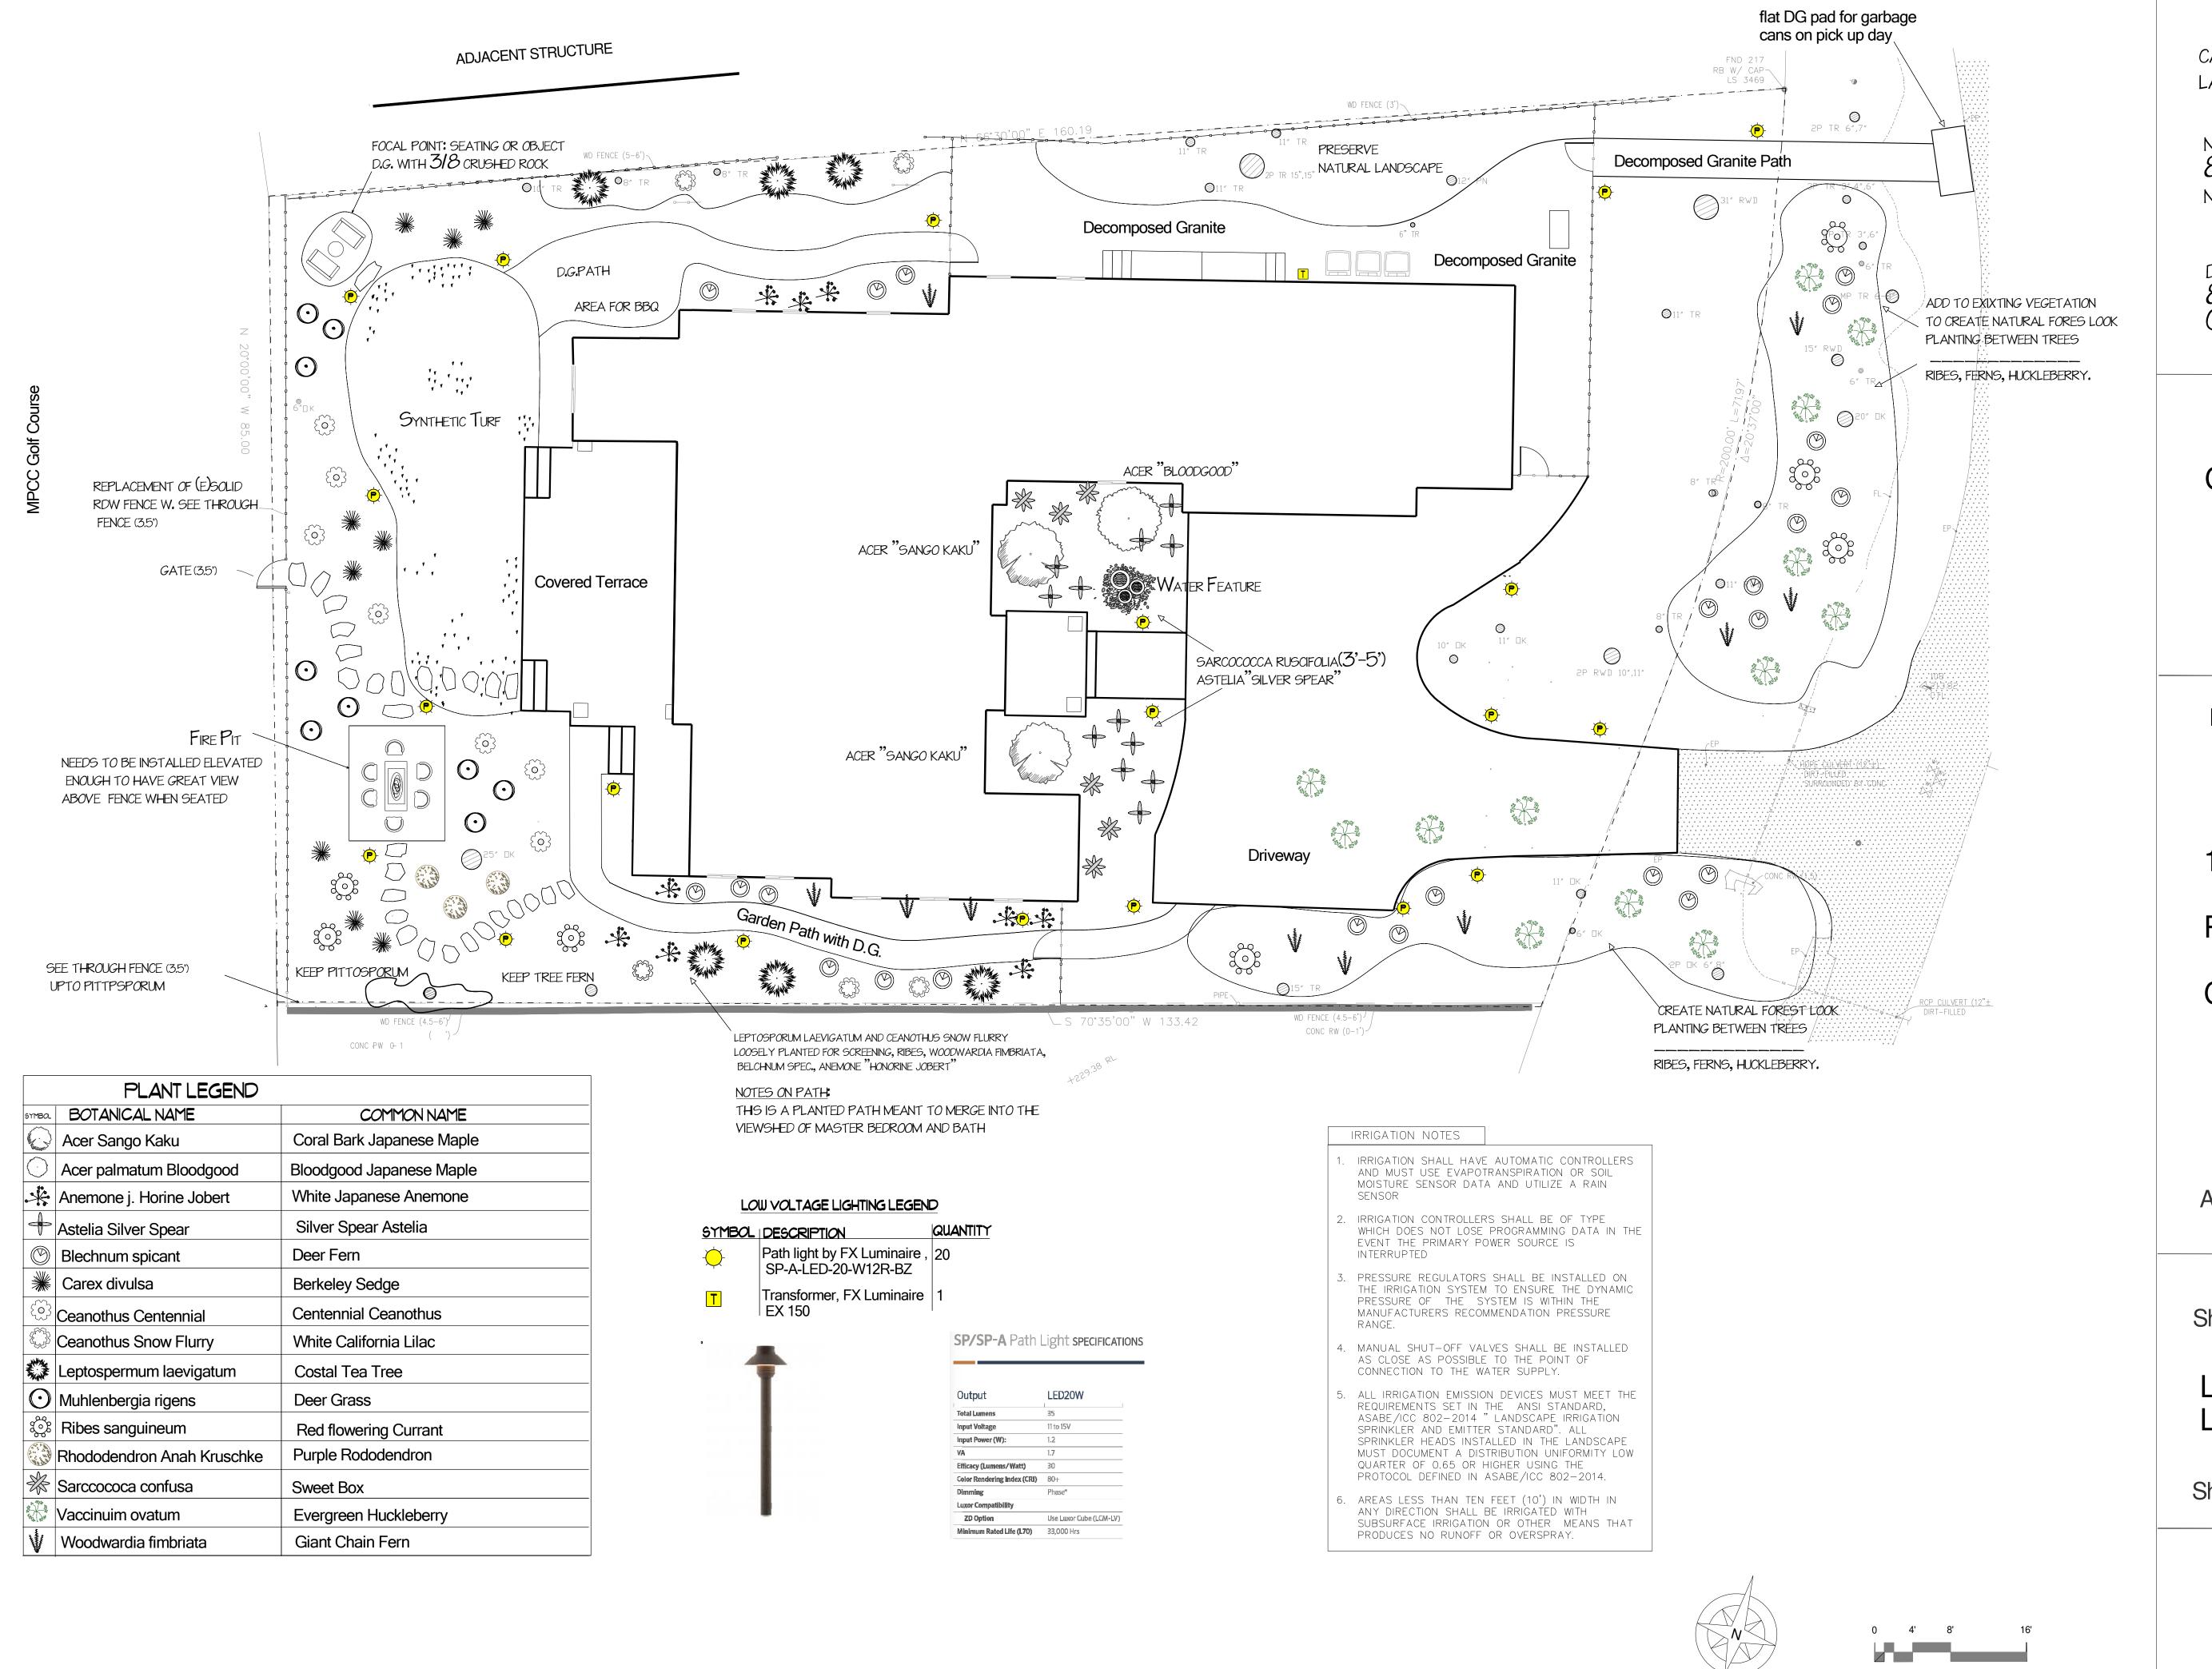

CAPRIOLA & MITCHELL LANDSCAPE DESIGN SERVICES

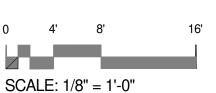NINA CAPRIOLA 831.595.7053 NINACAPRIOLADESIGN.COM

DORIS MITCHELL 831.595.5205 CSCL # 1117798

Client/Project:

Castleman Residence

Landscaping

Project address:

1012 San Carlos Road Pebble Beach CA, 93953

APN: 007-282-004-000

Sheet Title:


Landscape/ Lighting Plan


Sheet Number: L.1

05/12/2025

1/8"= 1'-0"

Drawn by: NC, DM

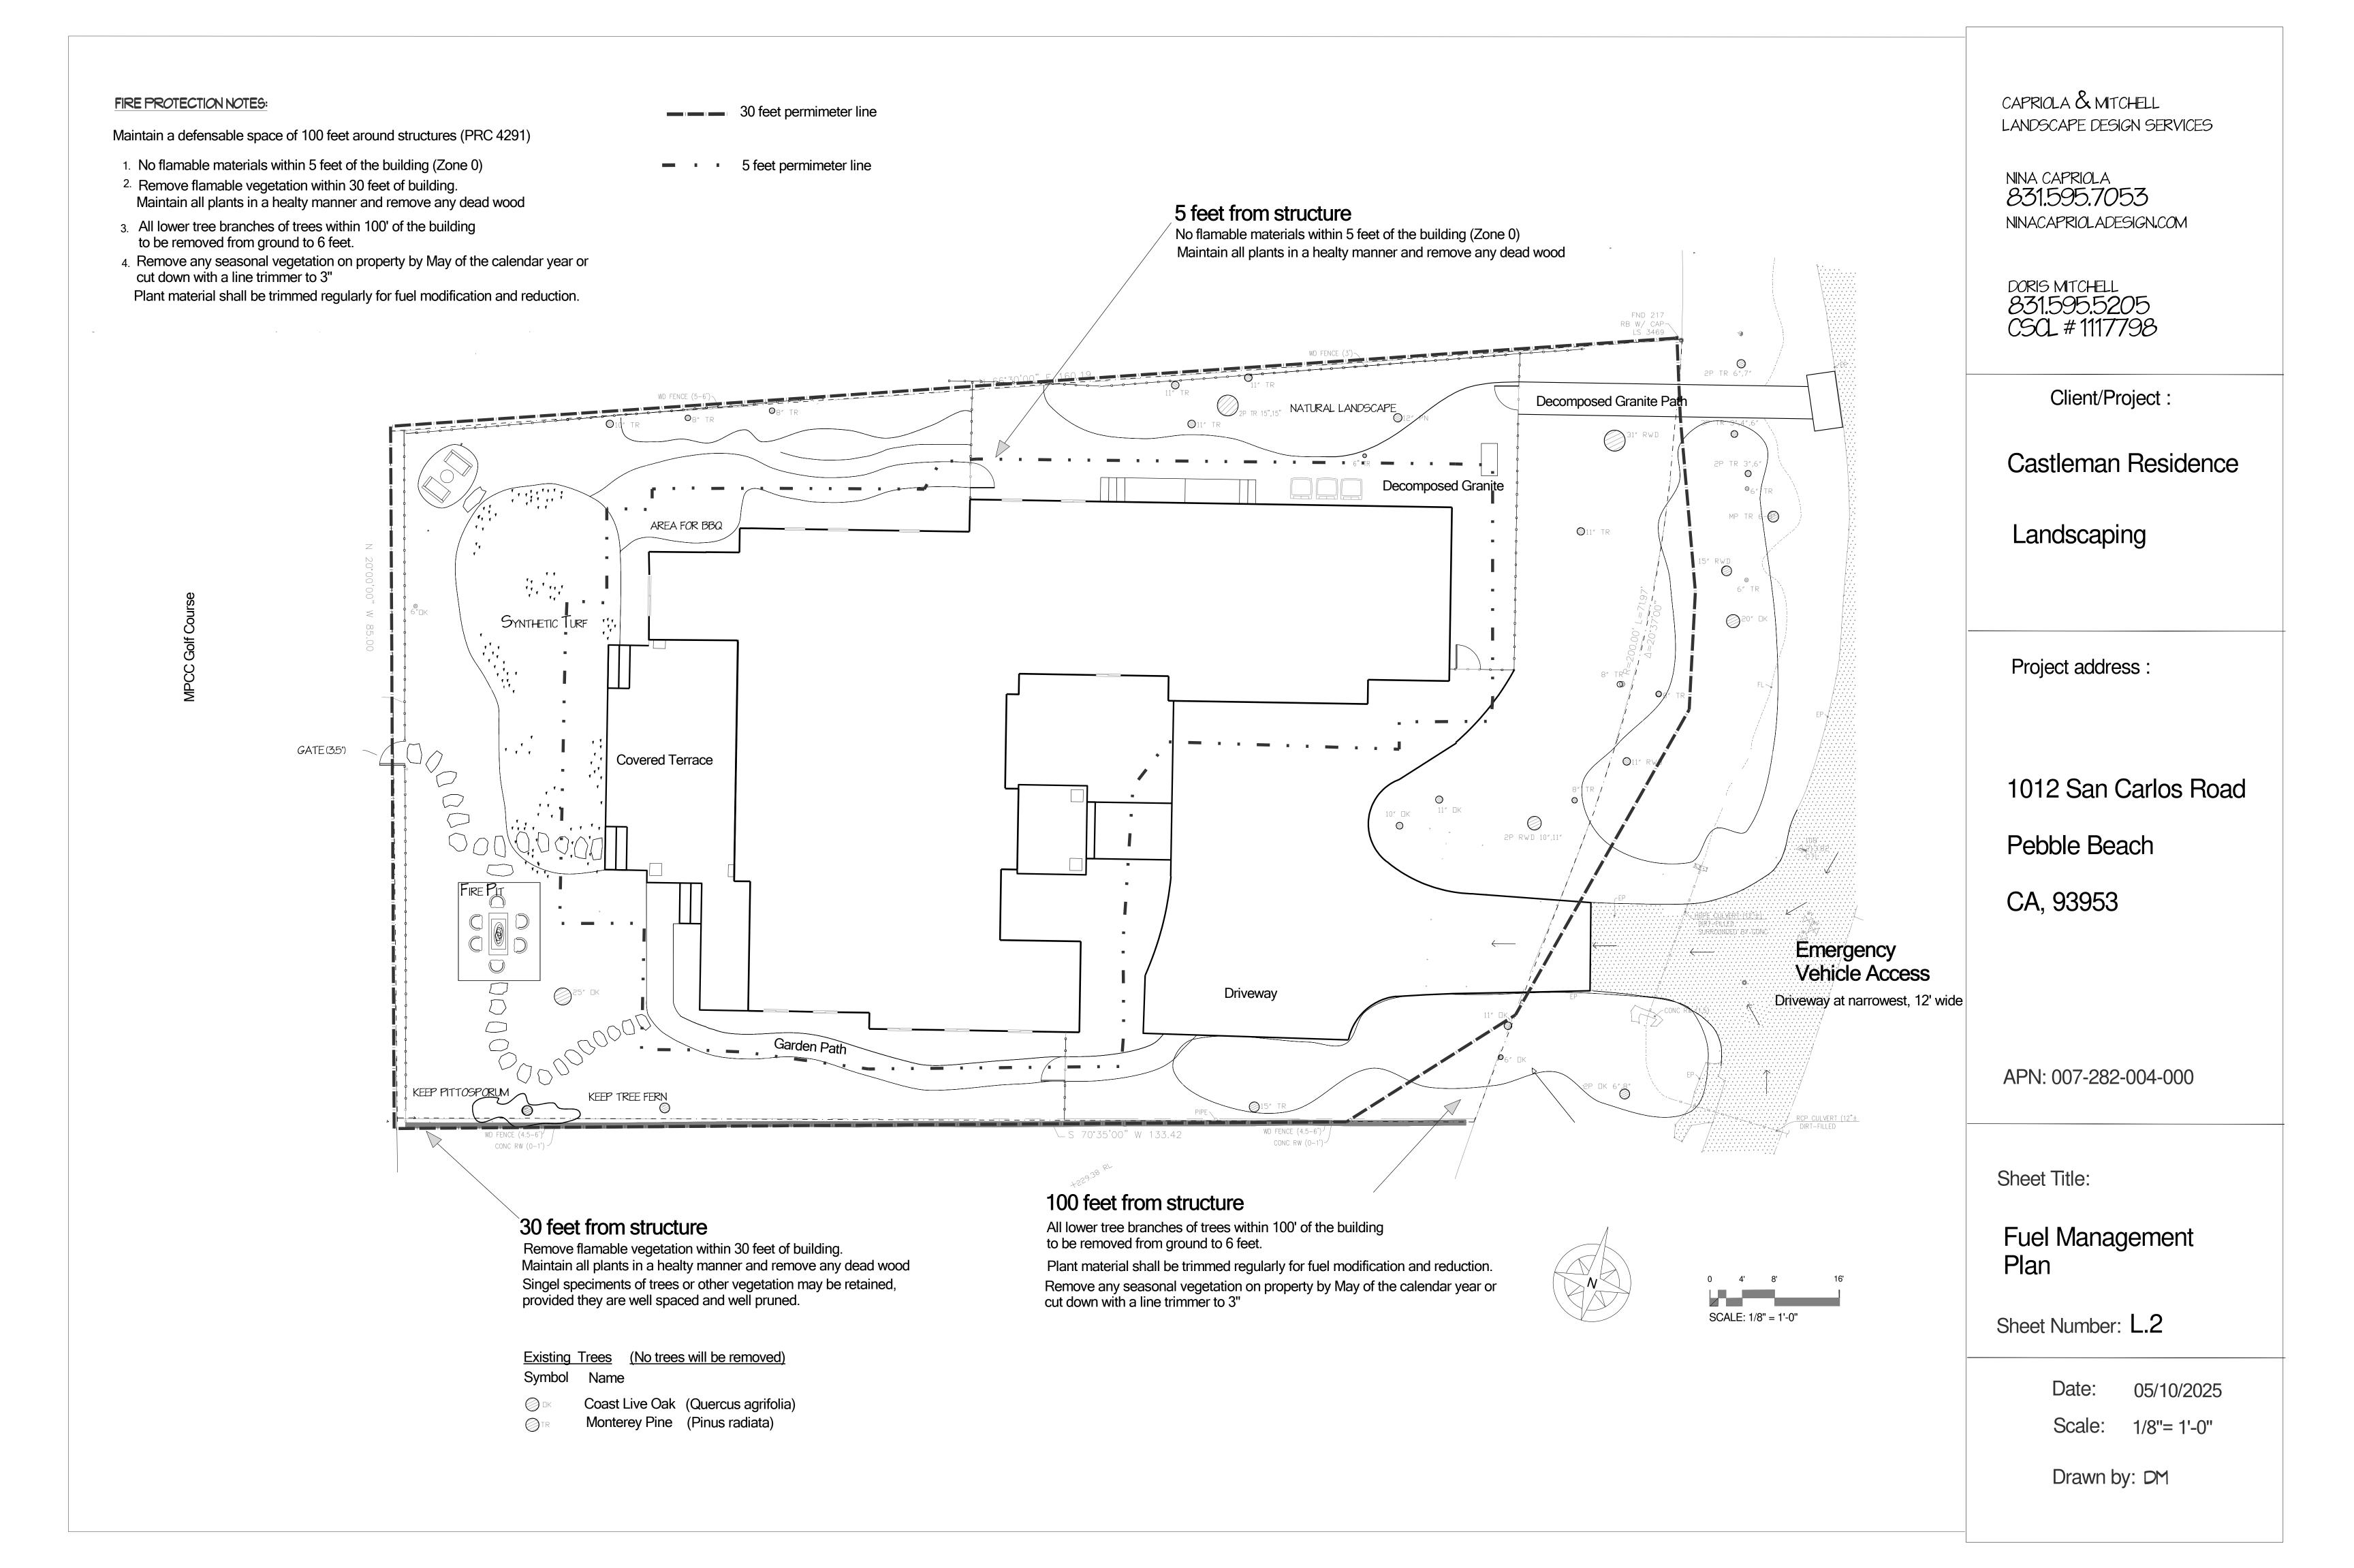

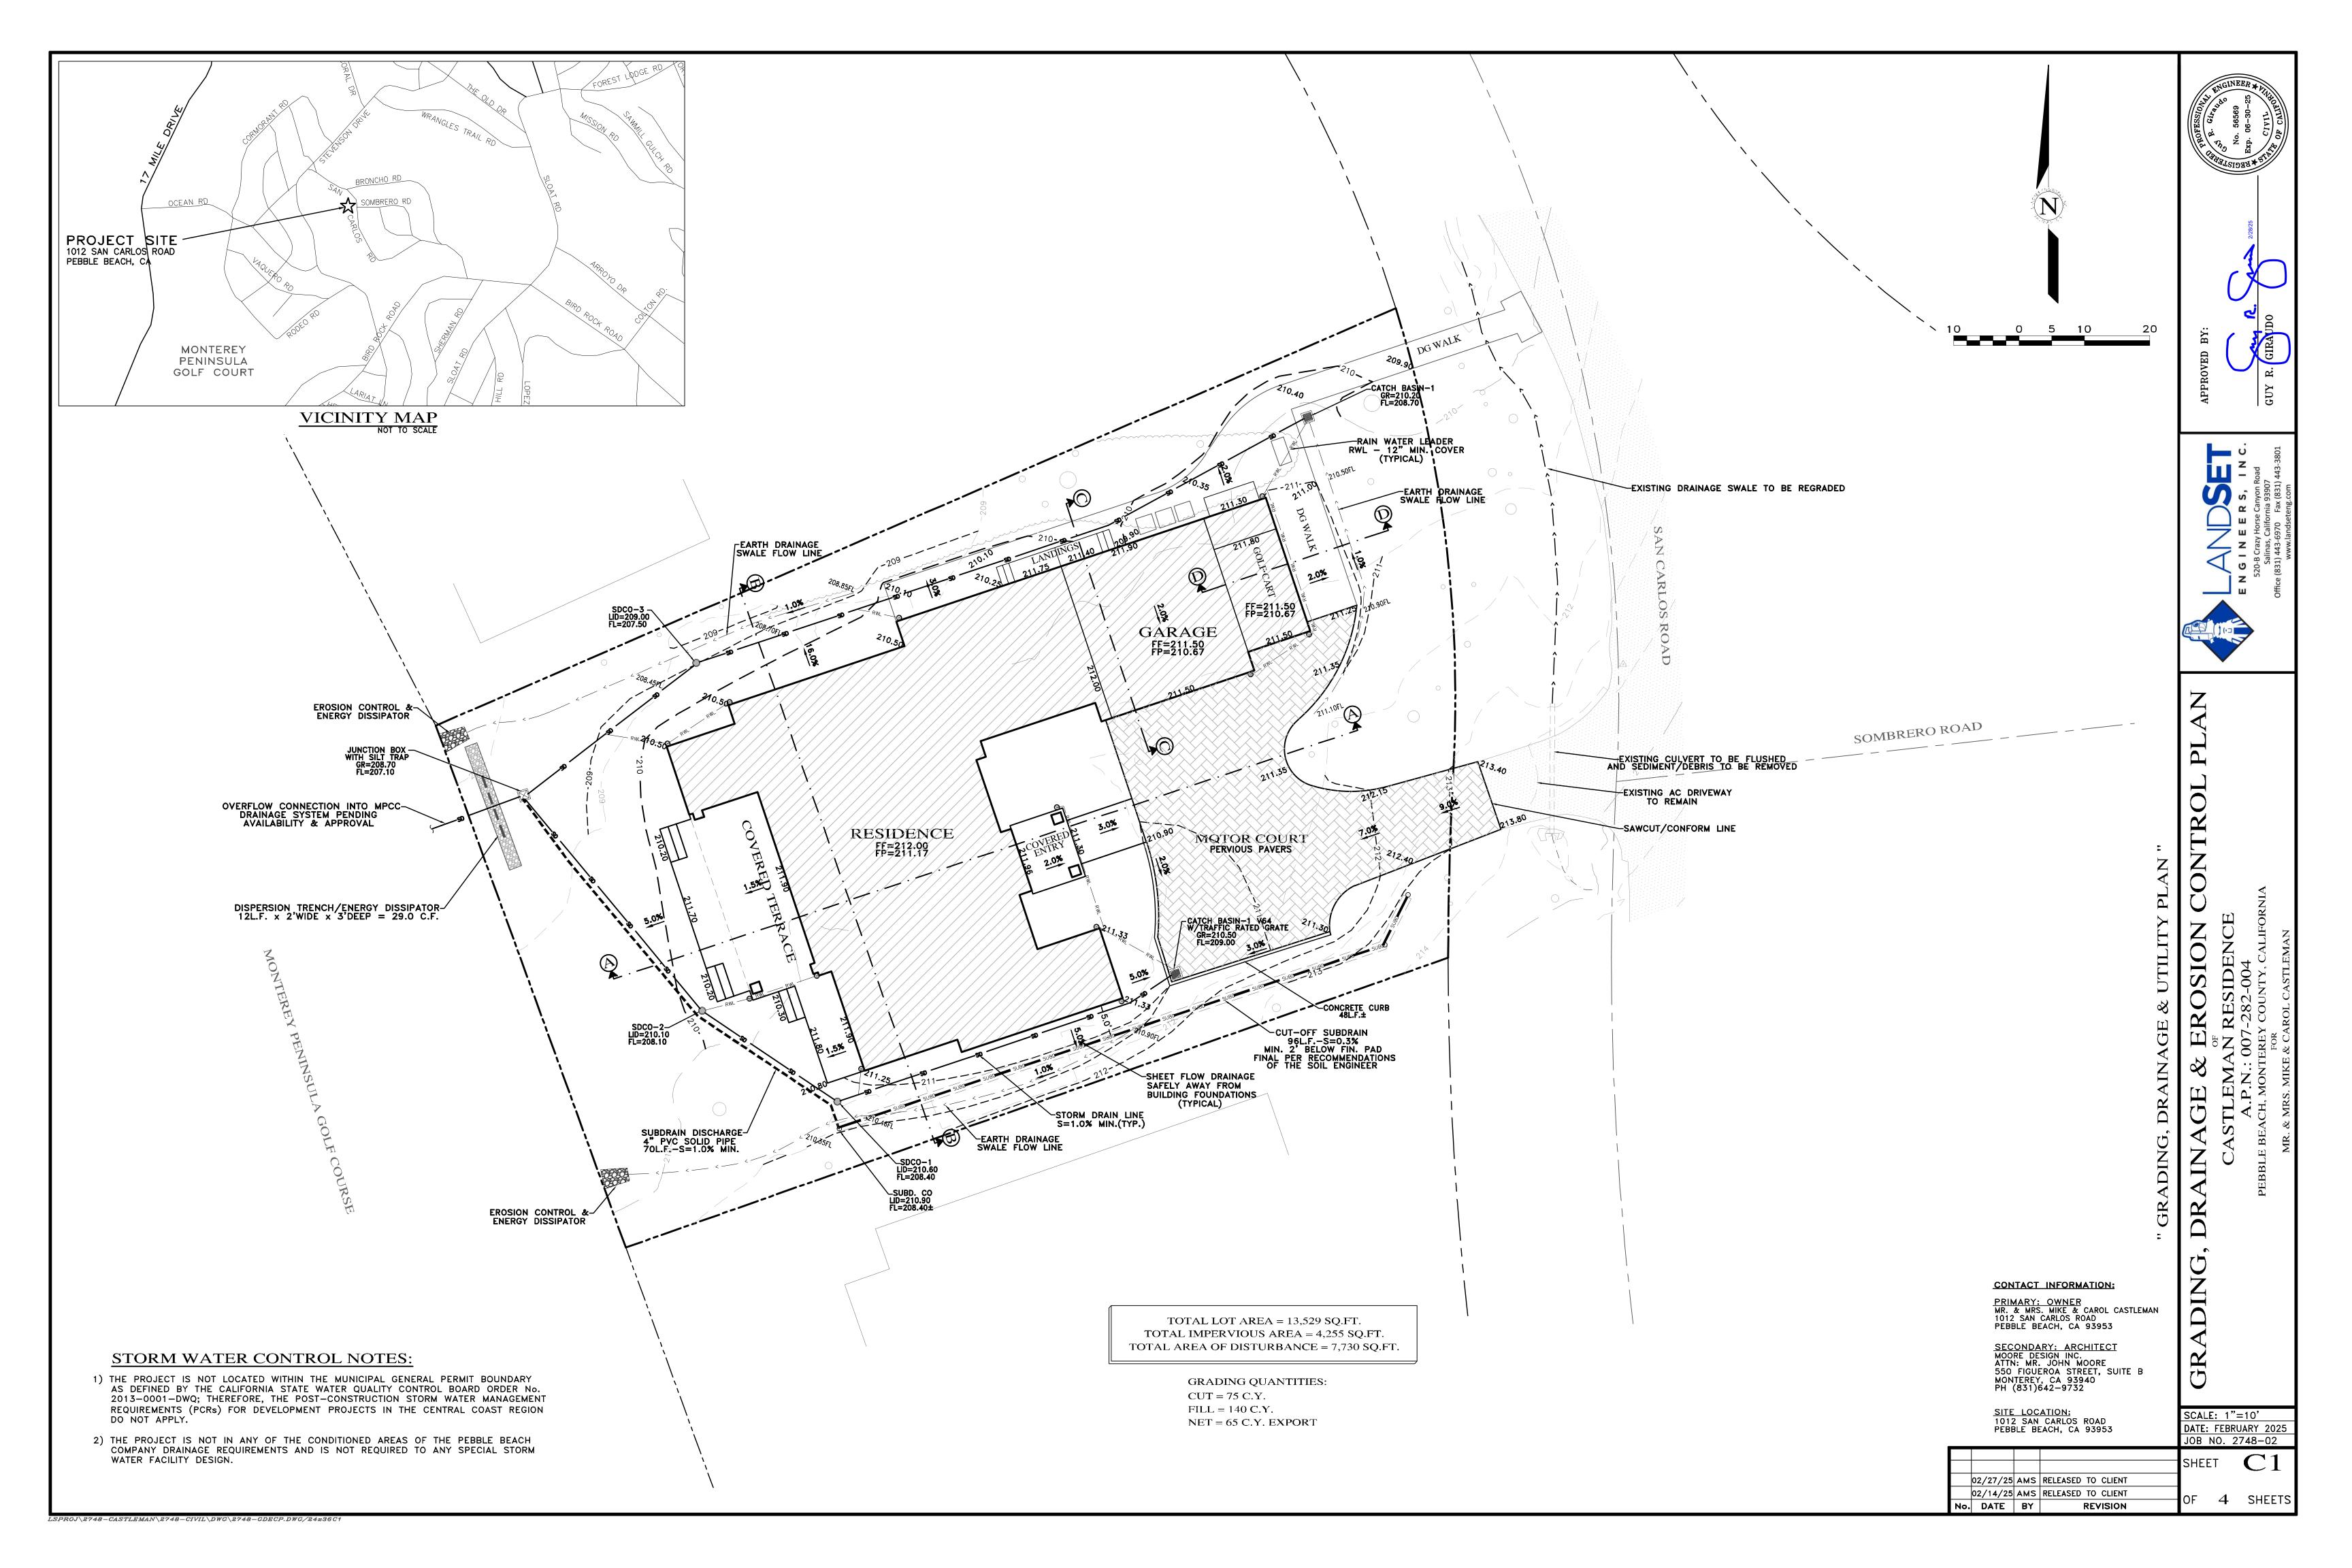

CUT-OFF-SUBDRAIN


0+80

0+90

Ν	C	T	E	Ξ	5:
		<b>A</b> I			

- ALL FILL MATERIAL SHALL BE STRUCTURAL FILL PER SOIL'S ENGINEERING INVESTIGATION REPORT
   SEE ARCHITECTURAL AND STRUCTURAL PLANS FOR LAYOUT OF FOUNDATION COMPONENTS.
   OVEREXCAVATION ON BUILDING AREAS PER SOILS ENGINEERING INVESTIGATION REPORT
- FOR SECTION LOCATIONS, SEE SHEET C3 "GRADING, DRAINAGE & UTILITY PLAN".

				SCAL	F· 1"	=10' H&V
						UARY 2025
				JOB	NO. 2	2748-02
				SHE	FT	$\overline{C}$
					_ '	
	02/27/25	AMS	RELEASED TO CLIENT			
	02/14/25	AMS	RELEASED TO CLIENT	OF	1	SHEETS
No.	DATE	BY	REVISION	Or	4	SHEETS

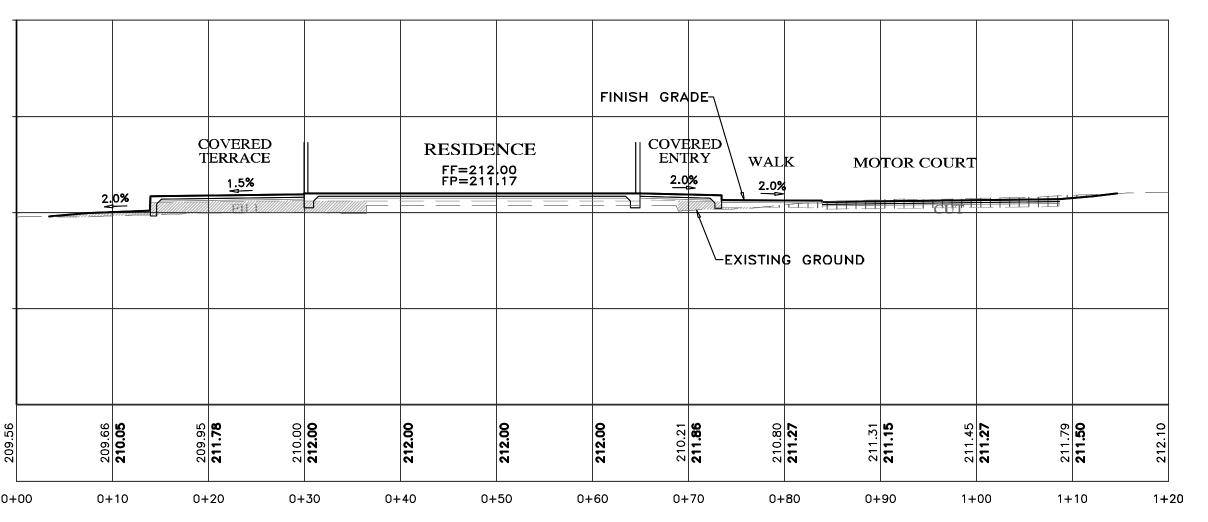

DRAINAGE SWALE<sub>7</sub>

0+10

0+20

0+30

EXISTING GROUND


0+40


0+50


SECTION B-B
SCALE: 1"=10' H&V

0+60

0+70

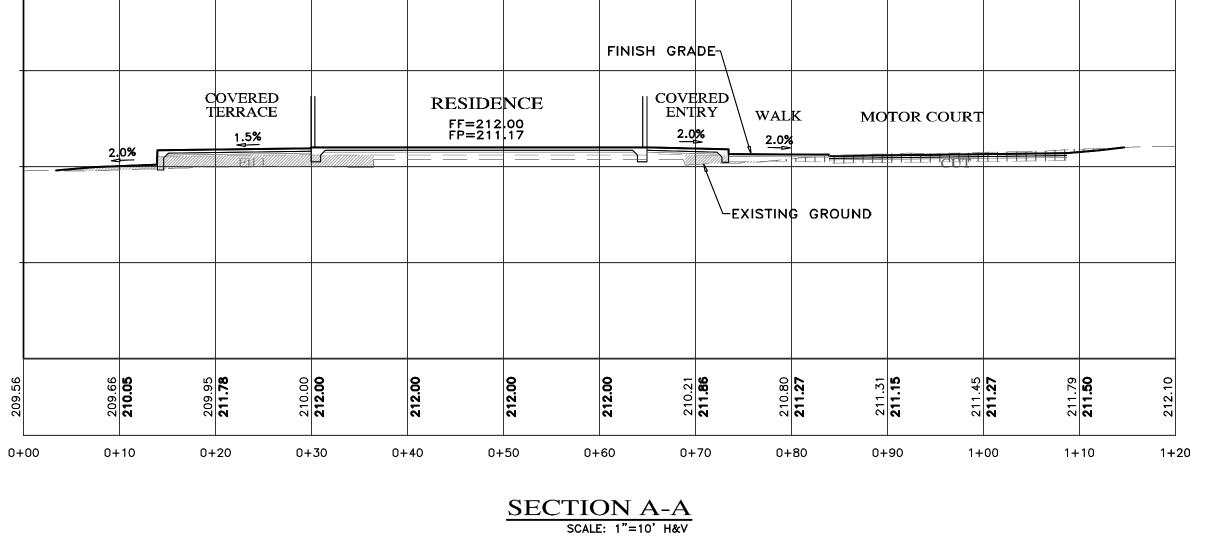

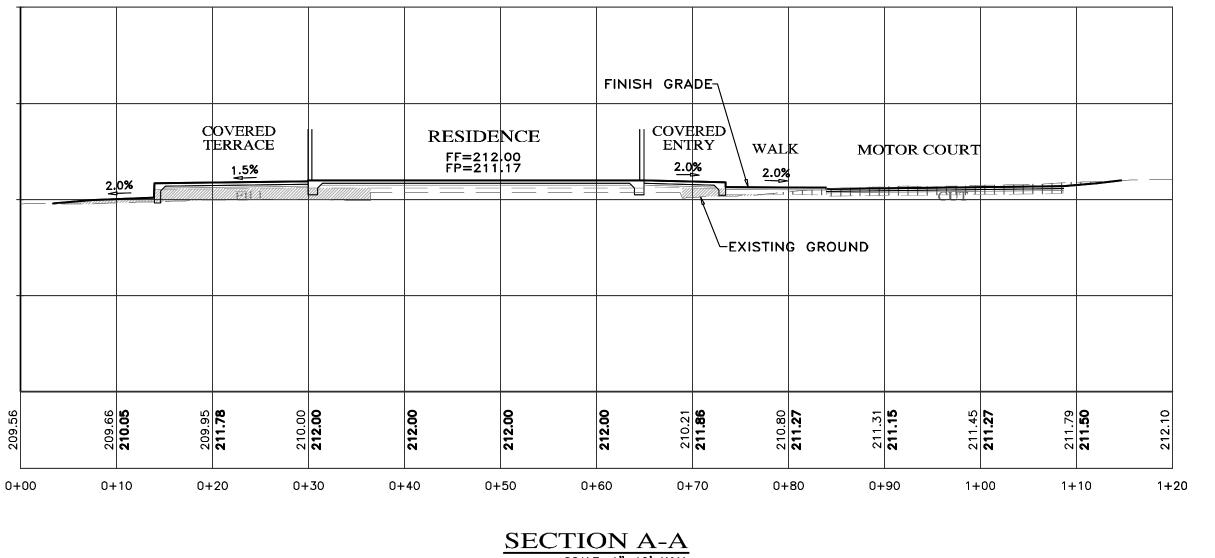

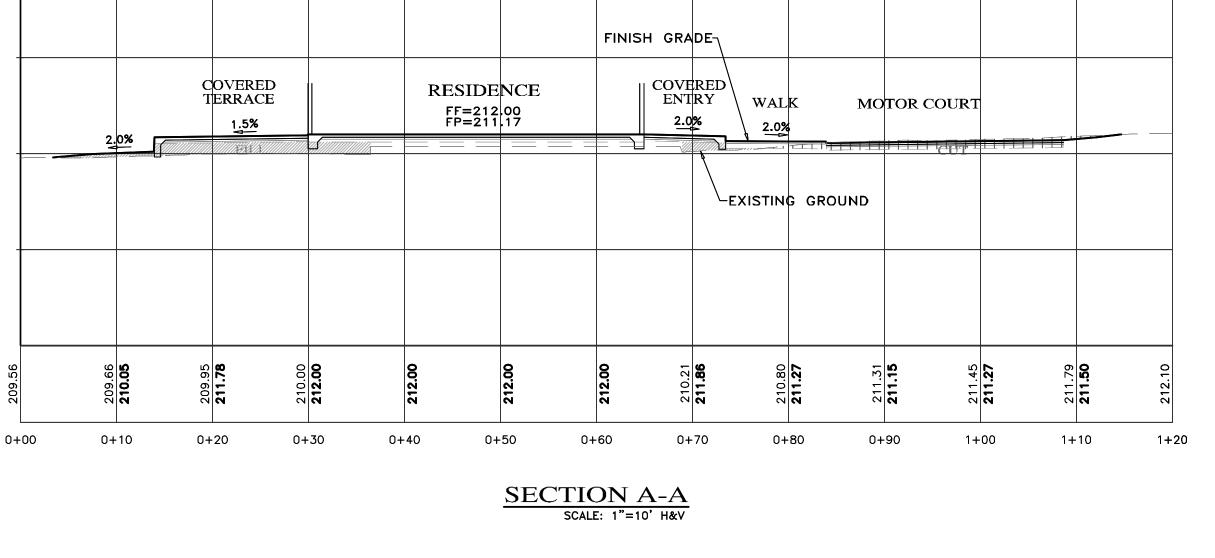

GARAGE GOLF CART DG WALK FF=211.50 2.0%


0+10

SECTION D-D
SCALE: 1"=10' H&V

0+20

0+30

0+00

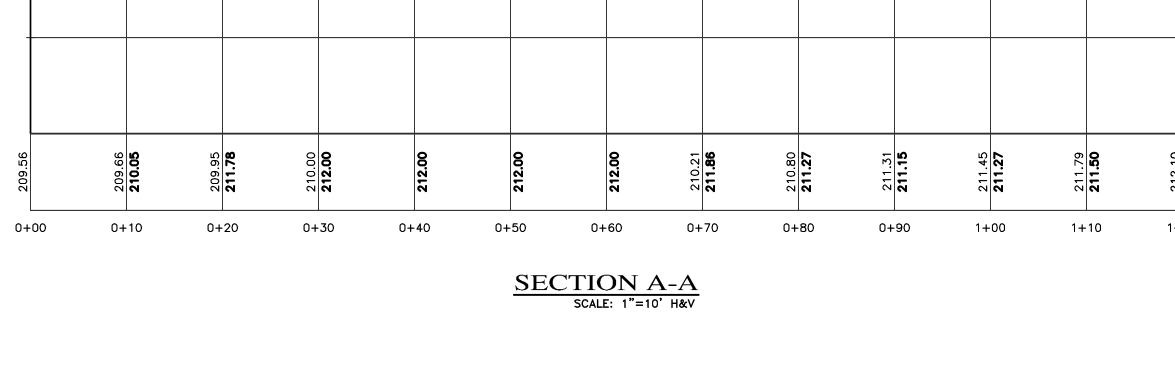

0+10

FINISH GRADE

∥\ MOTOR

0+40

GARAGE FF=211.50 FP=210.67 2.0%

LEXISTING GROUND

0+20

SECTION C-C
SCALE: 1"=10' H&V

0+30


STAIRS LANDING


0+00

 $LSPROJ \setminus 2748 - CASTLEMAN \setminus 2748 - CIVIL \setminus DWG \setminus 2748 - GDECP.DWG / 24x36C4$ 

#### **EROSION & SEDIMENT CONTROL NOTES:**

- 1) ALL EROSION CONTROL MEASURES SHALL CONFORM WITH THE COUNTY OF MONTEREY EROSION
- 2) EROSION AND SEDIMENT CONTROL MEASURES SHALL BE IN EFFECT FOR ANY CONSTRUCTION DURING THE RAINY SEASON, APPROX. OCTOBER 15 TO APRIL 15. EROSION CONTROL PLAN SHALL BE PREPARED AND SUBMITTED FOR APPROVAL BY SEPT. 15 OF ANY OR EACH CALENDAR YEAR THAT CONSTRUCTION MAY EXTEND BEYOND OCTOBER 15.
- 3) ALL SLOPES SHALL BE PROTECTED WITH STRAW MULCH OR SIMILAR MEASURES TO PROTECT AGAINST EROSION UNTIL SUCH SLOPES ARE PERMANENTLY STABILIZED.
- 4) RUNOFF SHALL BE DETAINED OR FILTERED BY BERMS, VEGETATED FILTER STRIPS, AND/OR CATCH BASINS TO PREVENT THE ESCAPE OF SEDIMENT FROM THE SITE.
- 5) EROSION AND SEDIMENT CONTROL MEASURES SHALL BE IN PLACE AT THE END OF EACH DAY'S
- 6) EROSION CONTROL PLANTINGS AND MULCH SHALL BE CLOSELY MONITORED THROUGHOUT THE WINTER AND ANY RUNOFF PROBLEMS CORRECTED PROMPTLY. SEE LANDSCAPE ARCHITECT'S PLAN FOR PERMANENT PLANTINGS AND TREE SCHEDULES.
- 7) DISTURBED SURFACES NOT INVOLVED IN THE IMMEDIATE GRADING OPERATIONS MUST BE PROTECTED BY MULCHING AND/OR OTHER EFFECTIVE MEANS OF SOIL PROTECTION.
- 8) ALL ROADS AND DRIVEWAYS SHALL HAVE DRAINAGE FACILITIES SUFFICIENT TO PREVENT EROSION ON OR ADJACENT TO THE ROADWAY OR ON THE DOWNHILL PROPERTIES.
- 9) DRAINAGE CONTROL MEASURES SHALL BE MAINTAINED AND IN PLACE AT THE END OF EACH DAY AND CONTINUOUSLY THROUGHOUT THE LIFE OF THE PROJECT DURING WINTER OPERATIONS.
- 10) REVEGETATION SHALL CONSIST OF A MECHANICALLY APPLIED HYDROMULCH SLURRY OR HAND SEEDED WITH A STRAW MULCH COVER. MULCH SHALL BE ANCHORED BY AN APPROVED METHOD SUCH AS PUNCHING, TACKING, OR THE USE OF JUTE NETTING, AS DEEMED NECESSARY FOR THE SITE CONDITIONS TO ALLOW FOR GERMINATION AND ENABLE ADEQUATE GROWTH TO BE
- 11) CHECK DAMS, SILT FENCES, FIBER ROLLS OR OTHER DESIGNS SHALL BE INCORPORATED TO CATCH ANY SEDIMENT UNTIL AFTER THE NEWLY EXPOSED AREAS ARE REVEGETATED SUFFICIENTLY TO CONTROL EROSION. EROSION CONTROL PLANTINGS AND MULCH SHALL BE CLOSELY MONITORED THROUGHOUT THE WINTER AND ANY RUNOFF PROBLEMS SHALL BE CORRECTED PROMPTLY. ALL EROSION AND/OR SLIPPAGE OF THE NEWLY EXPOSED AREAS SHALL BE REPAIRED BY THE PERMITTEE AT THEIR EXPENSE.
- 12) THE GRASS SEED SHALL BE PROPERLY IRRIGATED UNTIL ADEQUATE GROWTH IS ESTABLISHED AND MAINTAINED TO PROTECT THE SITE FROM FUTURE EROSION DAMAGE. ALL NEWLY EXPOSED (DISTURBED) AREAS SHALL BE SEEDED WITH THE FOLLOWING EROSION CONTROL MIX: BROMUS CARINATUS (CALIFORNIA BROME), VULPIA MICROSTACHYS (NUTTALL'S FESCUE), ELYMUS GLAUCUS (BLUE WILD RYE), HORDEUM BRACHYANTHERUM (MEADOW BARLEY), FESTUCA RUNRA'MOLATE BLUE AND A MIXTURE OF LOCALLY NATIVE WILDFLOWERS.
- 13) THE DIRECTOR OF BUILDING INSPECTION (BUILDING OFFICIAL) SHALL STOP OPERATIONS DURING PERIODS OF INCLEMENT WEATHER IF HE OR SHE DETERMINES THAT EROSION PROBLEMS ARE NOT BEING CONTROLLED ADEQUATELY.
- 14) GENERAL CONTRACTOR SHALL BE RESPONSIBLE FOR EROSION AND SEDIMENT CONTROL BMP INSTALLATION AND MAINTENANCE AND SHALL PROVIDE FULL PARTICULARS TO COUNTY RMA-ENVIRONMENTAL SERVICES PRIOR TO BEG. WORK.

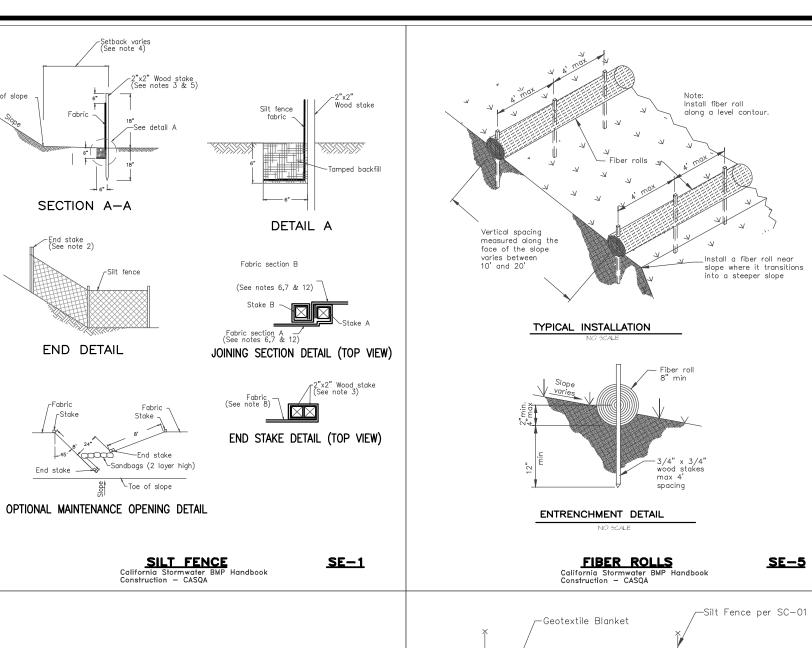


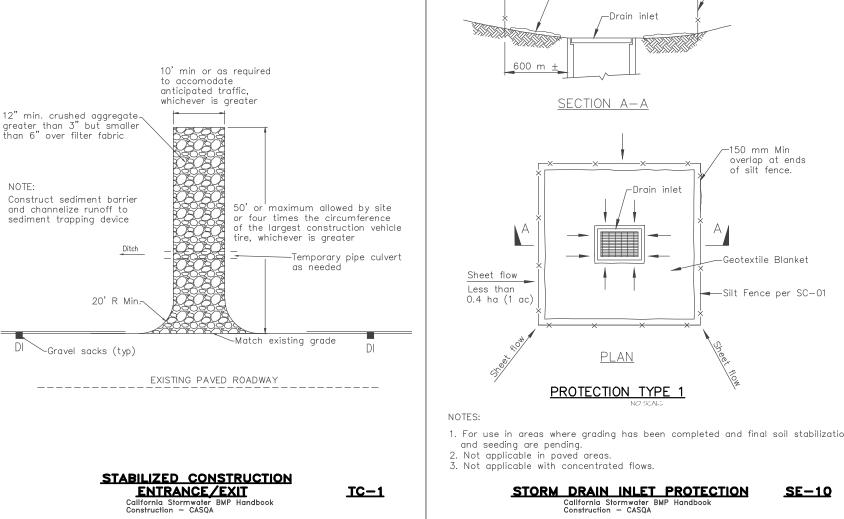

#### LEGEND:

**~~~~~** 

FIBER ROLLS: THE CONTRACTOR SHALL MAINTAIN A STOCKPILE OF FIBER ROLLS ONSITE, AS THEY CAN BE USED ALONG ERODIBLE SLOPES, ALONG STOCKPILE PERIMETERS, DOWNSLOPE OF EXPOSED SOIL AREAS, AND TO DELINEATE/PROTECT STAGING AREAS. FIBER ROLLS MUST BE TRENCHED INTO THE SOIL AND STAKED (STAKES SPACED MAX. 4' ON CENTER). SEE DETAIL. INSTALL FIBER ROLLS ALONG LEVEL CONTOURS, AND TURN THE ENDS UPHILL. INSPECT WEEKLY AND REMOVE ACCUMULATED SEDIMENT REGULARLY.

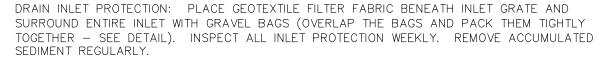

STABILIZED CONSTRUCTION ACCESS: INSTALL STABILIZED CONSTRUCTION ACCESS PRIOR TO COMMENCEMENT OF EARTH MOVING OPERATIONS (SEE DETAIL). INSPECT ENTRANCE DAILY, AND ADD ADDITIONAL STONE AS TOP-DRESSING WHEN REQUIRED. USE FENCING OR BARRICADES TO PREVENT VEHICLE TRAFFIC FROM DRIVING AROUND THE STABILIZED ACCESS

CONCRETE WASHOUT: WASHOUT MUST BE LOCATED A MINIMUM OF 50 FEET FROM STORM DRAINS, OPEN DITCHES, OR WATER BODIES. DISCONTINUE USE WHEN WASHOUT WASTES REACH 75% OF THE WASHOUT CAPACITY. ALLOW WASHOUT WASTES TO HARDEN, BE BROKEN UP, AND THEN DISPOSED OF PROPERLY.

SANITARY/SEPTIC WASTE MANAGEMENT: PORTABLE TOILETS WILL BE PROVIDED AND MAINTAINÉD ONSITE FOR THE DURATION OF THE PROJECT. ALL PORTABLE TOILETS WILL BE EQUIPPED WITH A SECONDARY CONTAINMENT TRAY, AND SHALL BE LOCATED A MINIMUM OF 50' FROM ALL OPERATIONAL STORM DRAIN INLETS. WEEKLY MAINTENANCE SHALL BE PROVIDED AND WASTES LEGALLY DISPOSED OF OFF-SITE

STOCKPILE MANAGEMENT: SOIL STOCKPILES MUST BE COVERED OR STABILIZED (I.E. WITH SOIL BINDERS) IMMEDIATELY IF THEY ARE NOT SCHEDULED TO BE USED WITHIN 14 DAYS. ACTIVE SOIL STOCKPILES SHALL BE WATERED TWICE DAILY TO AVOID WIND EROSION. SURROUND ALL STOCKPILES WITH FIBER ROLLS OR SILT FENCE. STOCKPILES OF "COLD MIX", TREATED WOOD, AND BASIC CONSTRUCTION MATERIALS SHOULD BE PLACED ON AND COVERED WITH PLASTIC SHEETING OR COMPARABLE MATERIAL AND SURROUNDED BY A BERM..

CONTRACTOR'S STAGING AREA: THE CONTRACTOR'S STAGING AREA SHALL BE SURROUNDED BY FIBER ROLLS. THE STAGING AREA WILL BE USED TO STORE DELIVERED MATERIALS, AND FOR OVERNIGHT EQUIPMENT PARKING/FUELING. STORED CONSTRUCTION MATERIALS SHALL BE MAINTAINED IN THEIR ORIGINAL CONTAINERS, AND COVERED AT ALL TIMES. PETROLEUM PRODUCTS AND HAZARDOUS MATERIALS SHALL BE STORED WITHIN SECONDARY CONTAINMENT STRUCTURES OR A STORAGE SHED. EQUIPMENT FUELING AND MAINTENANCE WILL ONLY OCCUR WITHIN THE DESIGNATED STAGING AREA. DRIP PANS OR ABSORBENT PADS MUST BE USED DURING ALL FUELING OR MAINTENANCE ACTIVITIES. AN AMPLE SUPPLY OF SPILL

CLEANUP MATERIALS SHALL BE MAINTAINED IN THE STAGING AREA AT ALL TIMES. WASTE MANAGEMENT: SOLID WASTES WILL BE LOADED DIRECTLY ONTO TRUCKS FOR TRASH OFF-SITE DISPOSAL. WHEN ON-SITE STORAGE IS NECESSARY, SOLID WASTES WILL BE STORED RECYCLE IN WATERTIGHT DUMPSTERS IN THE GENERAL STORAGE AREA OF THE CONTRACTOR'S YARD. DUMPSTERS AND/OR TRASH BINS SHALL BE COVERED AT THE END OF EACH WORK DAY. HAZARDOUS WASTES SHALL NOT BE STORED ONSITE. CONSTRUCTION DEBRIS AND GENERAL LITTER WILL BE COLLECTED DAILY AND WILL NOT BE ALLOWED NEAR DRAINAGE INLETS OR

> GRAVEL BAG CHECK DAM: GRAVEL BAGS SHALL CONSIST OF WOVEN POLYPROPYLENE, POLYETHYLENE OR POLYAMIDE FABRIC, MIN. UNIT WEIGHT OF 40Z/SY. BAGS SHALL BE A MINIMUM OF 18" LONG X 12" WIDE X 3" THICK, FILLED WITH 1/2" - 1" CRUSHED ROCK. TIGHTLY ABUT BAGS AND CONSTRUCT CHECK DAM AT LEAST 3 BAGS WIDE X 2 BAGS HIGH. INSPECT CHECK DAM REGULARLY AND REMOVE ACCUMULATED SEDIMENT.

TREE PROTECTION: TREE PROTECTION SHALL CONSIST OF ORANGE PLASTIC MESH FENCING, AND SHALL BE INSTALLED PRIOR TO COMMENCEMENT OF EARTH-MOVING OPERATIONS (SEE DETAIL). INSTALL FENCING ALONG THE DRIP LINE OF TREES, AND INSTRUCT EMPLOYEES AND SUBCONTRACTORS TO HONOR PROTECTIVE DEVICES. TREE INJURIES SHALL BE ATTENDED TO BE A LICENSED AND CERTIFIED ARBORIST.

SILT FENCE: SILT FENCE SHALL CONSIST OF WOVEN GEOTEXTILE FABRIC WITH A MINIMUM WIDTH OF 36 INCHES. WOOD STAKES SHALL BE COMMERCIAL QUALITY LUMBER, SPACED A MAXIMUM OF 6' APART AND DRIVEN SECURELY INTO THE GROUND (SEE DETAIL). FENCING FABRIC SHALL BE KEYED INTO THE SOIL AS PER MANUFACTURER'S RECOMMENDATIONS. INSTALL SILT FENCE ALONG LEVEL CONTOURS. TURN THE ENDS OF THE SILT FENCE UPHILL TO PREVENT WATER FROM FLOWING AROUND THE FENCE. INSPECT SILT FENCE DAILY, AND MAKE REPAIRS IMMEDIATELY.


#### TABLE 1706.6 REQUIRED VERIFICATION AND INSPECTION OF SOILS

VERIFICATION AND INSPECTION TASK	CONTINUOUS DURING TASK LISTED	PERIODICALLY DURING TASK LISTED
<ol> <li>Verify material below shallow foundations are adequate to achieve the design bearing capacity</li> </ol>		×
2. Verify excavations are extended to proper depth and have reached proper material		Х
3. Perform classification and testing of compacted fill materials		Х
4. Verify use of proper materials, densities and lift sicknesses during placement and compaction of compacted fill.	Х	
5. Prior to placement of compacted fill, observe subgrade and verify that site has been prepared properly.		X

#### CONSTRUCTION INSPECTION REQUIREMENTS

- A-PRIOR TO COMMENCEMENT OF ANY LAND DISTURBANCE, THE OWNER/APPLICANT SHALL SCHEDULE AN INSPECTION WITH HCD-ENVIRONMENTAL SERVICES TO ENSURE ALL NECESSARY SEDIMENT CONTROLS ARE IN PLACE AND THE PROJECT IS COMPLIANT WITH MONTEREY COUNTY GRADING AND EROSION CONTROL REGULATIONS.
- B-DURING CONSTRUCTION THE OWNER/APPLICANT SHALL SCHEDULE AN INSPECTION WITH HCD-ENVIRONMENTAL SERVICES TO UPDATE COMPACTION TEST RECORDS, INSPECT DRAINAGE DEVICE INSTALLATION, REVIEW THE MAINTENANCE AND EFFECTIVENESS OF BMP's INSTALLED, AS WELL AS, TO VERIFY THAT POLLUTANTS OF CONCERN ARE NOT DISCHARGED FROM THE SITE.
- C-PRIOR TO FINAL INSPECTION, THE OWNER/APPLICANT SHALL SCHEDULE AN INSPECTION WITH HCD-ENVIRONMENTAL SERVICES TO CONDUCT A FINAL GRADING INSPECTION, COLLECT FINAL GEOTECHNICAL LETTER OF CONFORMANCE, ENSURE THAT ALL DISTURBED AREAS HAVE BEEN STABILIZED AND THAT ALL TEMPORARY EROSION AND SEDIMENT CONTROL MEASURES THAT ARE NO LONGER NEEDED HAVE BEEN REMOVED.

#### **Material Delivery and Storage** WM-1

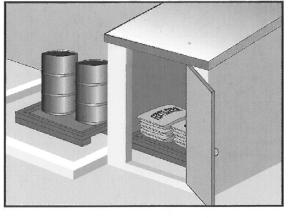

**Description and Purpose** Prevent, reduce, or eliminate the discharge of pollutants from material delivery and storage to the stormwater system or watercourses by minimizing the storage of hazardous materials onsite, storing materials in watertight containers and/or a completely enclosed designated area, installing secondary containment, conducting regular inspections, and training employees and subcontractors.

This best management practice covers only material delivery and storage. For other information on materials, see WM-2, Material Use, or WM-4, Spill Prevention and Control. For information on wastes, see the waste management BMPs in this

## **Targeted Constituents** Oil and Grease

**Potential Alternatives** 

EC Erosion Control

SE Sediment Control

C Tracking Control

WE Wind Erosion Control

Non-Stormwater

Secondary Objective

Management Control

Waste Management and

SE Sediment Control

TC Tracking Control

WE Wind Erosion Control

Non-Stormwater

Primary Category


Secondary Category

Management Control

Waste Management and

Materials Pollution Control

#### Hazardous Waste Management

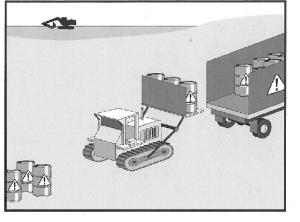


Prevent or reduce the discharge of pollutants to stormwater from hazardous waste through proper material use, waste disposal, and training of employees and subcontractors.

Targeted Constituents Oil and Grease Organics

**Potential Alternatives** 


#### Stockpile Management

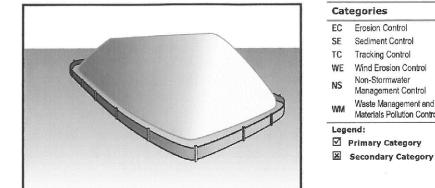

**Description and Purpose** Stockpile management procedures and practices are designed to reduce or eliminate air and stormwater pollution from stockpiles of soil, soil amendments, sand, paving materials such as portland cement concrete (PCC) rubble, asphalt concrete (AC), asphalt concrete rubble, aggregate base, aggregate sub base or pre-mixed aggregate, asphalt minder (so called "cold mix" asphalt), and pressure treated wood.

**Potential Alternatives** 

#### Sanitary/Septic Waste Management WM-9

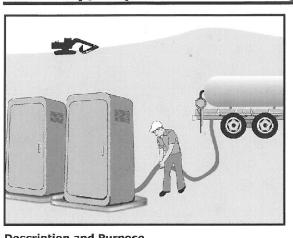

**Description and Purpose** Proper sanitary and septic waste management prevent the discharge of pollutants to stormwater from sanitary and septic waste by providing convenient, well-maintained facilities, and arranging for regular service and disposal.

Targeted Constituents Bacteria Oil and Grease Organics

WM-3

Non-Stormwater

Management Control

**Targeted Constituents** 

Oil and Grease

Categories

EC Erosion Control

SE Sediment Control

WE Wind Erosion Control

☑ Primary Category

■ Secondary Category

Non-Stormwater

Management Control

Waste Management and

Materials Pollution Control


TC Tracking Control

Waste Management and

Materials Pollution Control

Potential Alternatives

#### **Solid Waste Management**

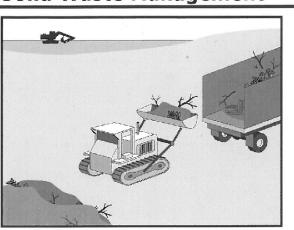

**Description and Purpose** Solid waste management procedures and practices are designed to prevent or reduce the discharge of pollutants to stormwater from solid or construction waste by providing designated waste collection areas and containers, arranging for regular disposal, and training employees and subcontractors.

Targeted Constituents Nutrients Bacteria Oil and Grease

SE Sediment Control

Tracking Control

WE Wind Erosion Control

☑ Primary Objective

■ Secondary Objective

Non-Stormwater

Management Control

Waste Management and

Materials Pollution Control

**Potential Alternatives** 


EC Erosion Control

SE Sediment Control

TC Tracking Control

WE Wind Erosion Control

#### **Preservation Of Existing Vegetation EC-2**

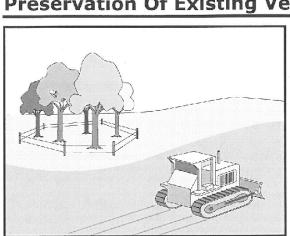

**Description and Purpose** Carefully planned preservation of existing vegetation minimizes he potential of removing or injuring existing trees, vines, shrubs, and grasses that protect soil from erosion.

Non-Stormwater Management Control Waste Management and Materials Pollution Control ☑ Primary Objective ▼ Secondary Objective **Targeted Constituents** 

Nutrients


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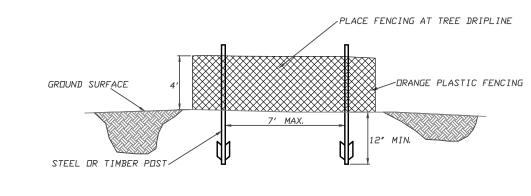
Oil and Grease

REVISION

SCALE: AS SHOWN DATE: FEBRUARY 202 OB NO. 2748-02

02/27/25 AMS RELEASED TO CLIENT 02/14/25 AMS RELEASED TO CLIENT



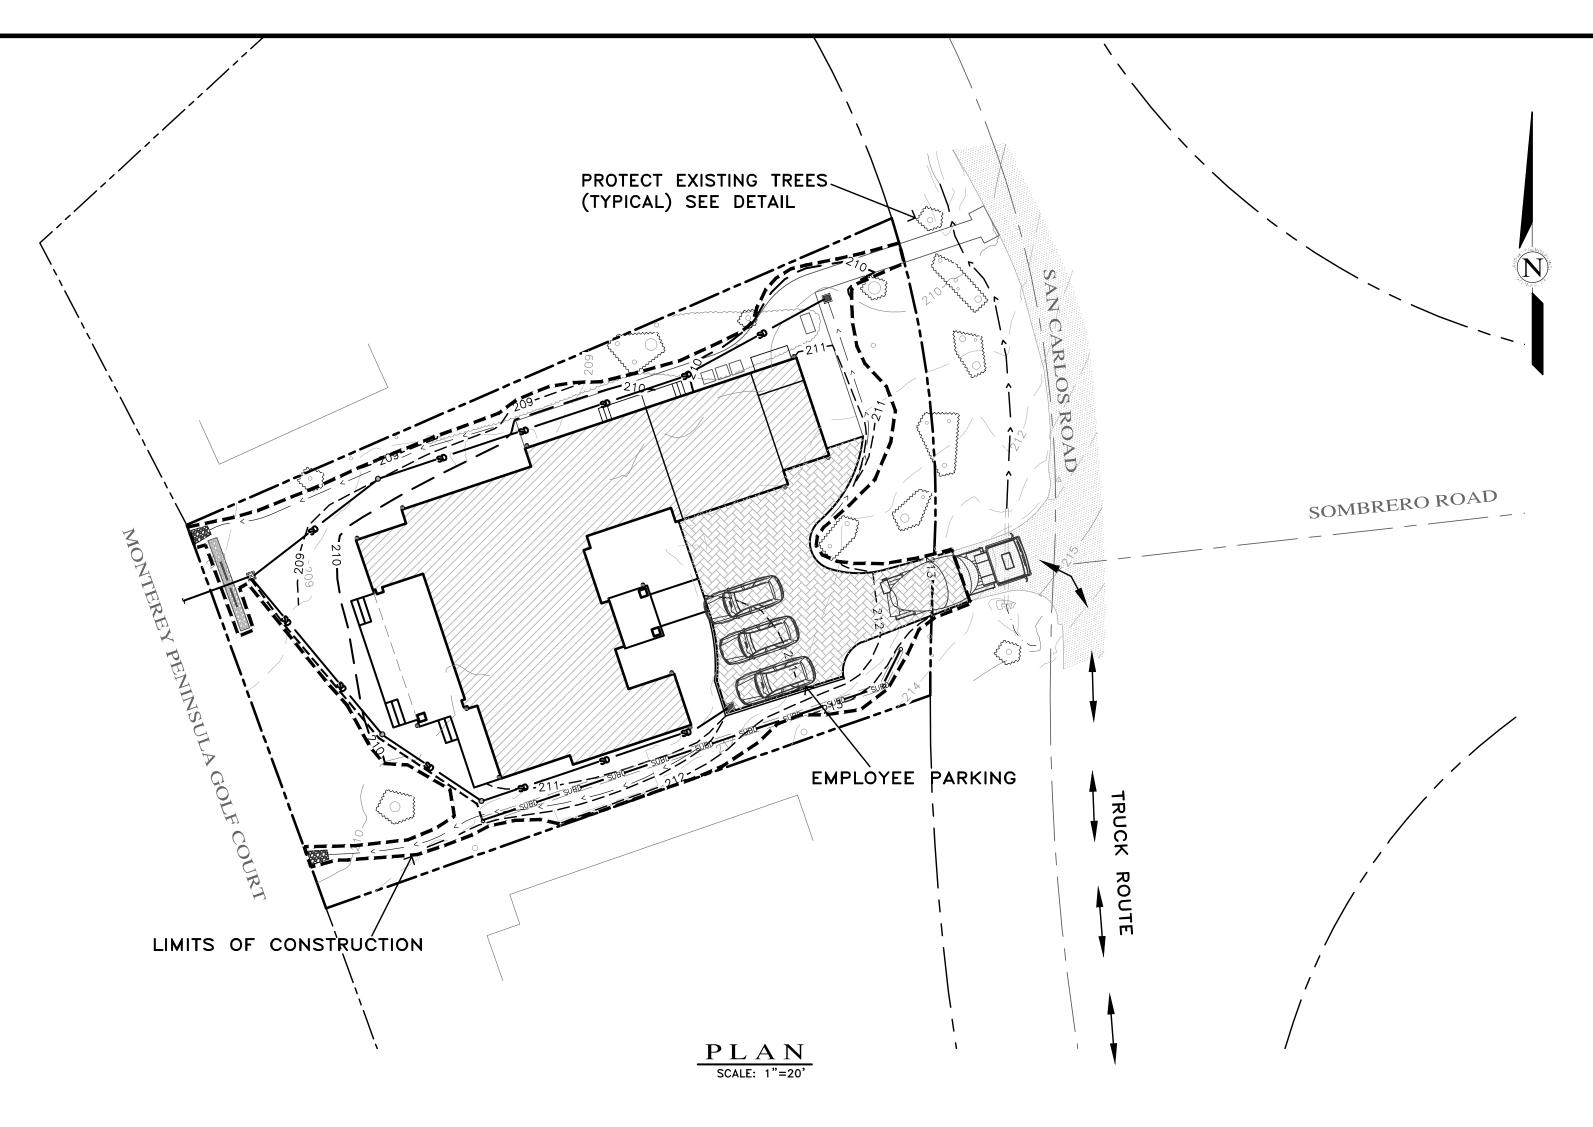

FENCING (ESA) DETAIL

EARTHWORK QUANTITIES PER CIVIL ENGINEERING PLANS BY LANDSET ENGINEERS, INC.: 140 CY FILL

DEMOLISH EXISTING HARDSCAPE AND OFFHAUL DEBRIS: EXISTING DRIVEWAY TO BE USED FOR EQUIPMENT STAGING AND TEMPORARY STOCKPILE AREA.

PERFORM GRADING, CONSTRUCT STRUCTURES, AND INSTALL UNDERGROUND UTILITIES: PROPOSED NEW MOTOR COURT AREA TO BE USED FOR MATERIAL AND EQUIPMENT STAGING.

#### INSTALL NEW PERVIOUS PAVERS DRIVEWAY AND LANDSCAPING.

SEE ARCHITECTURAL AND CIVIL PLANS FOR EROSION CONTROL AND DEMOLITION NOTES. CONSTRUCTION EQUIPMENT AND MATERIALS SHALL NOT BE STAGED ON SAN CARLOS ROAD AT ANY TIME DURING CONSTRUCTION. MATERIAL DELIVERIES SHALL BE SCHEDULED SUCH THAT THEY ARE USED PROMPTLY, AND MATERIAL STORAGE IS MINIMIZED. ALL CONSTRUCTION EQUIPMENT AND MATERIALS SHALL BE STORED IN A DESIGNATED AREA ON THE

THE HAUL ROUTE TO THE SITE IS FROM HIGHWAY 68 TO MORSE DRIVE TO CONGRESS ROAD TO BIRD ROCK ROAD TO STEVENSON ROAD TO SAN CARLOS ROAD. (HAUL TRUCKS EXIT IN THE SAME FASHION.) VEHICLES SHALL NOT BE LEFT UNATTENDED WHILE IN QUEUE (IF NECESSARY) ON SAN CARLOS ROAD. CONTRACTOR TO ENSURE THAT HEIGHT RESTRICTIONS WITHIN THE DRIVEWAY AREA SHALL BE ADDRESSED BEFORE CONSTRUCTION VEHICLES ENTER THE SITE. SEE DETAILS B AND C, TRUCK ROUTING PLANS.

IN THE EVENT THAT MATERIAL DELIVERIES CAUSE ANY STREETS ALONG THE HAUL ROUTE TO BE PARTIALLY BLOCKED BY DELIVERY TRUCKS OR LOADING/UNLOADING OPERATIONS, A FLAGMAN SHALL BE PRESENT TO DIRECT TRAFFIC AROUND THE LANE OBSTRUCTION. THE FLAGMAN SHALL BE PRESENT AT ALL TIMES DURING WHICH DELIVERY/ CONSTRUCTION OPERATIONS MAY IMPACT TRAFFIC ON THE HAUL ROUTE AND SURROUNDING STREETS.

LIMITED EMPLOYEE PARKING ON-SITE. EMPLOYEES SHALL USE PUBLIC PARKING LOTS AND CARPOOL TO JOBSITE IF POSSIBLE. ON-SITE PARKING SHALL BE IN PROPOSED NEW MOTOR COURT AREA AND IN LEGAL SPACES ALONG SAN CARLOS ROAD, OBEYING ALL PARKING LAWS. PARKING IS PROHIBITED IN ALL NATURAL AREAS WHICH ARE NOT CURRENTLY PAVED OR GRAVEL.

<u>LIMITS OF CONSTRUCTION:</u> ALL CONSTRUCTION SHALL TAKE PLACE WITHIN THE BORDER AS SHOWN. EXISTING CYPRESS, PINE, AND OAK TREES LOCATED WITHIN THE LIMITS SHOWN SHALL BE SURROUNDED BY ORANGE PROTECTIVE FENCING (SEE DETAIL).

#### TRUCK TRIP GENERATION CHART:

CATEGORY	NO. OF TRUCK TRIPS	TOTAL DAYS
DEMOLITION/CLKEARING	3	2
GRADING & SOIL REMOVAL (EXPORT)	1	1
ENGINEERING MATERIALS (IMPORT)	4	2
TOTALS	8	5


#### TRUCK TRIP GENERATION NOTES:

- 1. TRUCK TRIPS FOR THE GRADING/SOIL REMOVAL IS BASED UPON 20 CUBIC YARDS PER TRUCKLOAD WITH AN AVERAGE OF 5 TRUCK LOADS PER DAY. 2. THERE ARE 65 C.Y. OF SOIL MATERIAL THAT WILL BE IMPORTED TO THE
- 3. GRADING OPERATIONS SHALL TAKE APPROXIMATELY 5 WORKING DAYS TO
- 4. THE AMOUNT OF GRADING PER DAY WILL VARY, THE AVERAGE BETWEEN 80 & 120 CUBIC YARDS.

#### NUMBER OF EMPLOYEES/DAY: 6-10

HOURS OF OPERATION/DAY: 8

PROJECT SCHEDULING: PROJECTED START DATE 18 MARCH 2025, 5 WORKING DAYS TO COMPLETE GRADING, MONDAY THRU FRIDAY, 8:00 A.M. - 4:30 P.M. TOTAL PROJECT DURATION IS APPROXIMATELY 12 MONTHS.

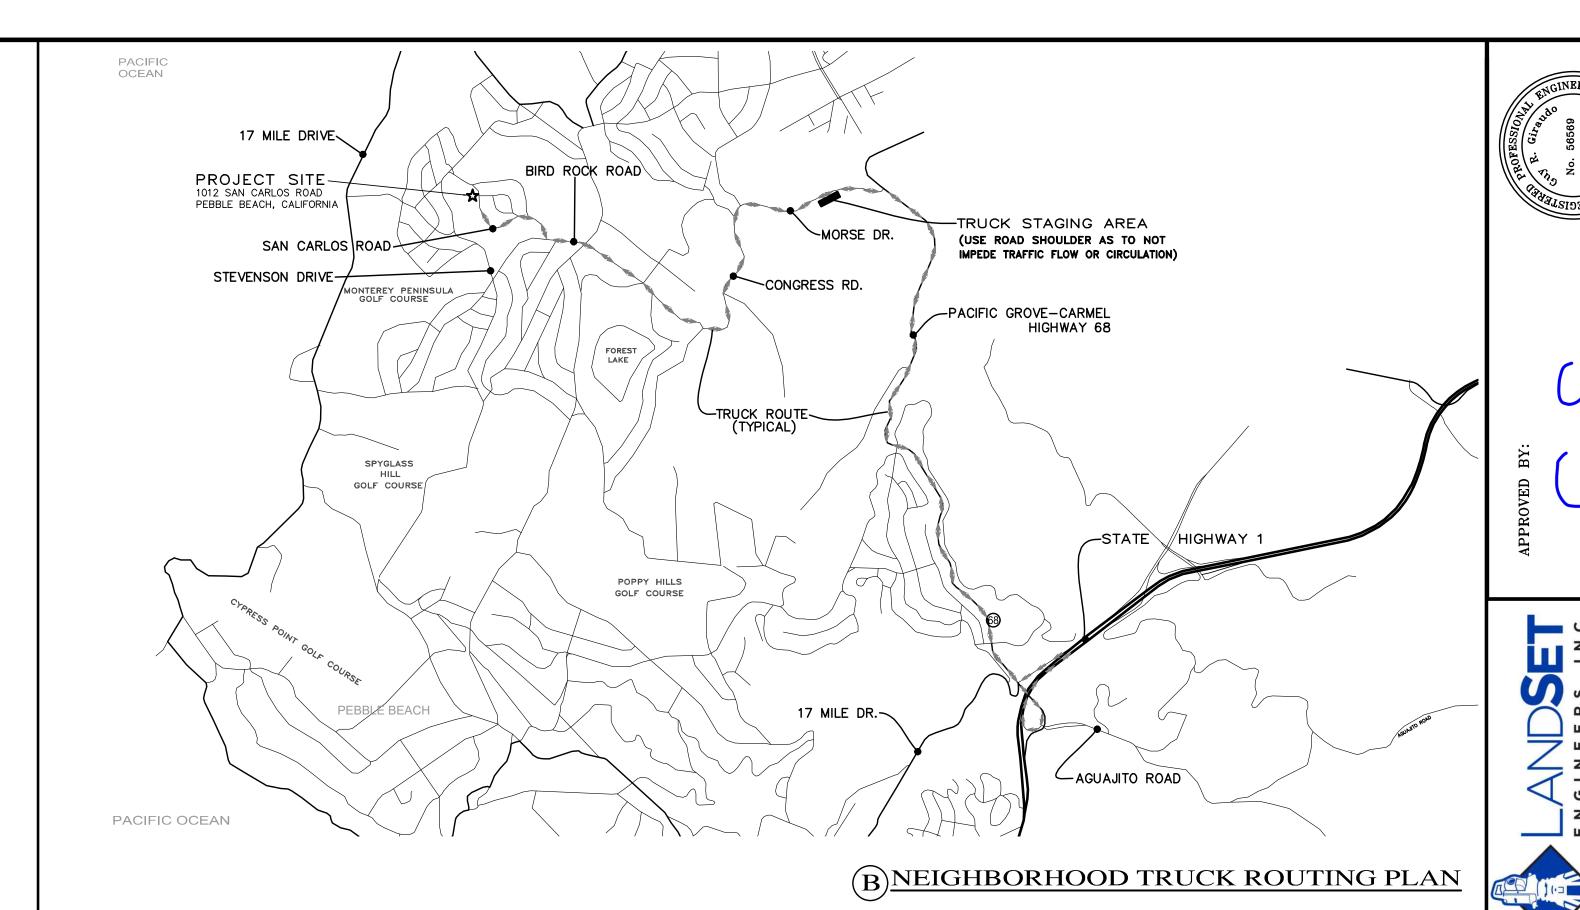



No. DATE BY





#### CASTLEMAN RESIDENCE

1012 SAN CARLOS ROAD PEBBLE BEACH, CA 93953

APN: 007-282-004-000

MOORE DESIGN Inc.

RESIDENTIAL PLANNING &

550 FIGUEROA STREET, SUITE B MONTEREY CA. 93940 831.642.9732 FAX 831.401.3292 john@mooredesign.org

CONSTRUCTION ADMINISTRATION

DRAWING RECORD		
DESCRIPTION	ISSUED	
PLN SUBMIT	3/12/2025	
PLN RE-SUBMIT	5/14/2025	
_		

PRINT DATE: 5/14/2025



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SHEET TITLE:

MAIN FLOOR PLAN

SHEET NUMBER:

[R327.1.2]

POSITION.

LANDING. [R327.1.4]

3. AT LEAST ONE BATHROOM AND ONE BEDROOM ON THE

AT AN ANGLE OF 90 DEGREES FROM THE CLOSED

MORE THAN 48" ABOVE THE EXTERIOR FLOOR OR

4. DOORBELL BUTTONS, WHEN INSTALLED, SHALL EXCEED

ENTRY LEVEL SHALL PROVIDE A NET CLEAR OPENING OF

NOT LESS THAN 32" MEASURED WITH THE DOOR POSITION

GLASS MAT GYPSUM PANELS, FIBER-REINFORCED GYPSUM

CEMENTITIOUS BACKER UNITS INSTALLED IN ACCORDANCE

WITH MANUFACTURERS' RECOMMENDATIONS[R702.4.2]

PANELS, NON-ASBESTOS FIBER-CEMENT BACKER BOARD,

OR NON-ASBESTOS FIBER-CEMENT REINFORCED

5. CONTRACTOR TO SEE ARCHITECTURTAL & STRUCTURAL

WALL DETAILS FOR ADDITIONAL NOTES REGARDING

7. PROVIDE BLOCKING AND/OR BACKING AT ALL TOWEL BAR

4. ALL DIMENSIONS ARE TO FACE OF STUD, UNLESS

6. SEE BUILDING SECTIONS SHEET FOR INSULATION


INSULATION, SHEAR, SOUND, ETC.

OTHERWISE NOTED.

SCHEDULE.

LOCATIONS.

A2.1

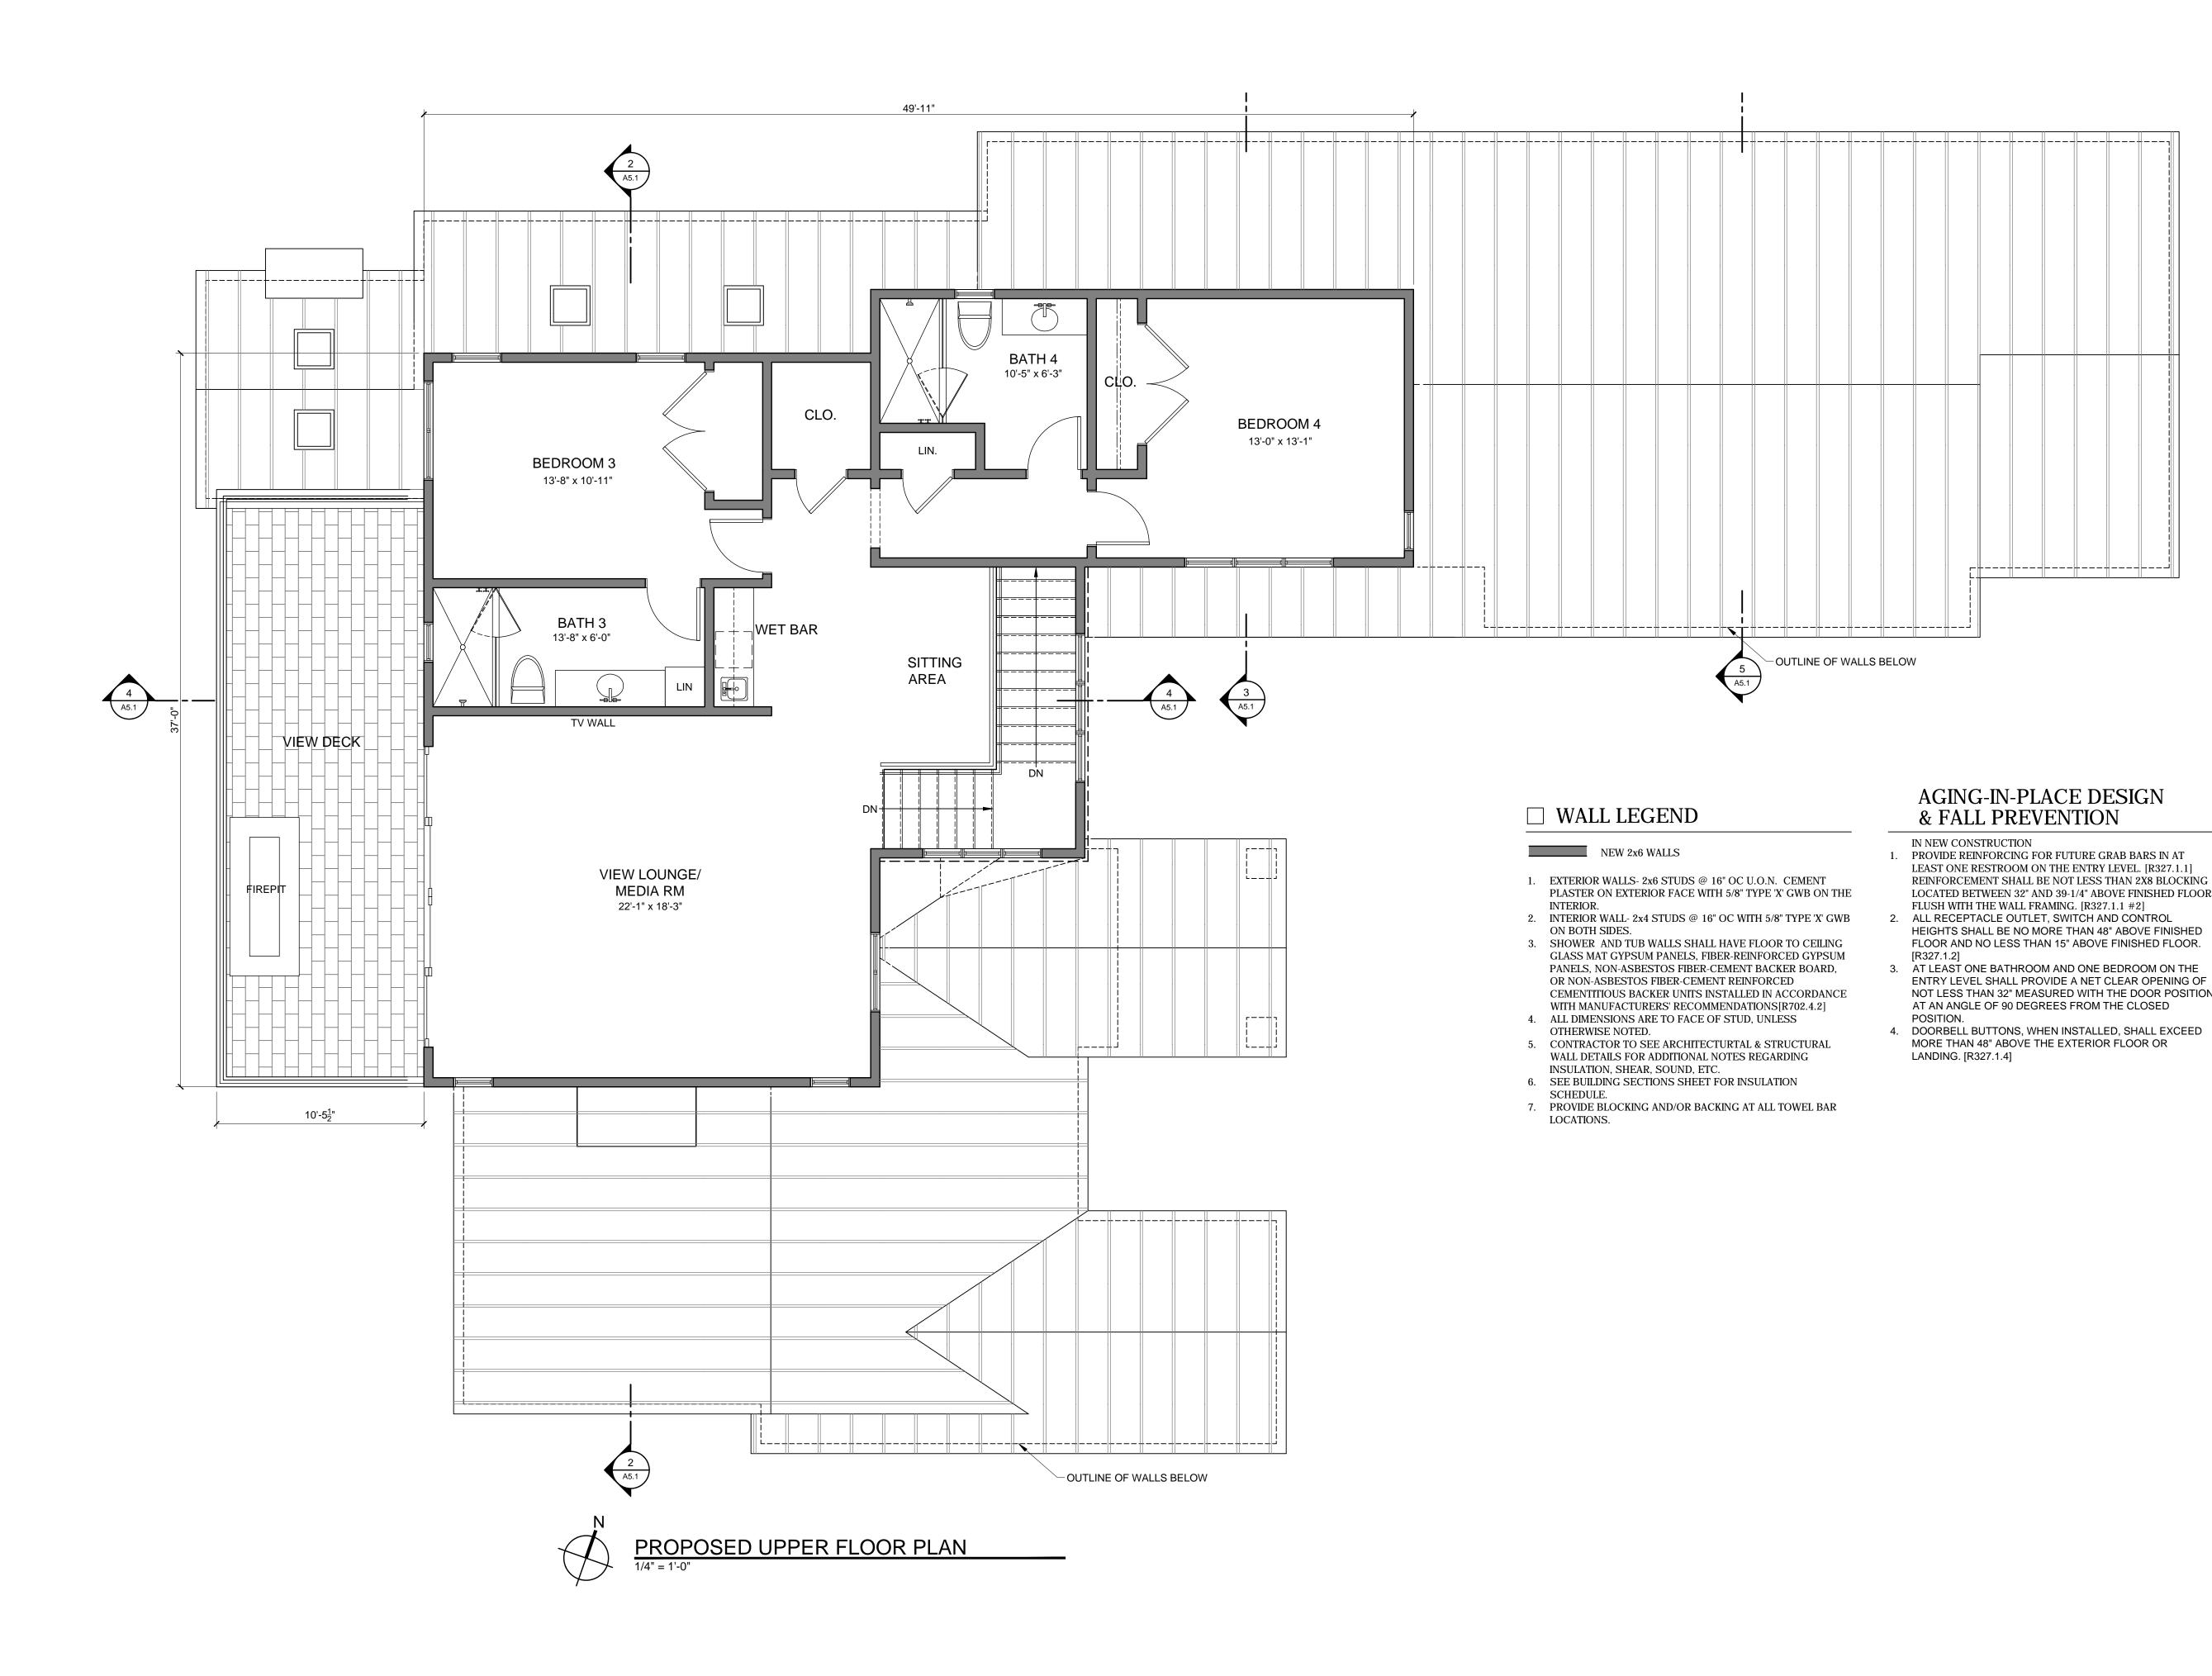

CASTLEMAN

RESIDENCE

1012 SAN CARLOS

PEBBLE BEACH, CA

APN: 007-282-004-000

ROAD

93953

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AGING-IN-PLACE DESIGN & FALL PREVENTION

PROVIDE REINFORCING FOR FUTURE GRAB BARS IN AT LEAST ONE RESTROOM ON THE ENTRY LEVEL. [R327.1.1]

HEIGHTS SHALL BE NO MORE THAN 48" ABOVE FINISHED FLOOR AND NO LESS THAN 15" ABOVE FINISHED FLOOR.

ENTRY LEVEL SHALL PROVIDE A NET CLEAR OPENING OF

AT AN ANGLE OF 90 DEGREES FROM THE CLOSED

MORE THAN 48" ABOVE THE EXTERIOR FLOOR OR

NOT LESS THAN 32" MEASURED WITH THE DOOR POSITION

FLUSH WITH THE WALL FRAMING. [R327.1.1 #2]

IN NEW CONSTRUCTION

[R327.1.2]

POSITION.

LANDING. [R327.1.4]

PRINT DATE: 5/14/2025




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SHEET TITLE:

UPPER FLOOR PLAN



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DS \_\_10'-4" PLATE HT.

APN: 007-282-004-000

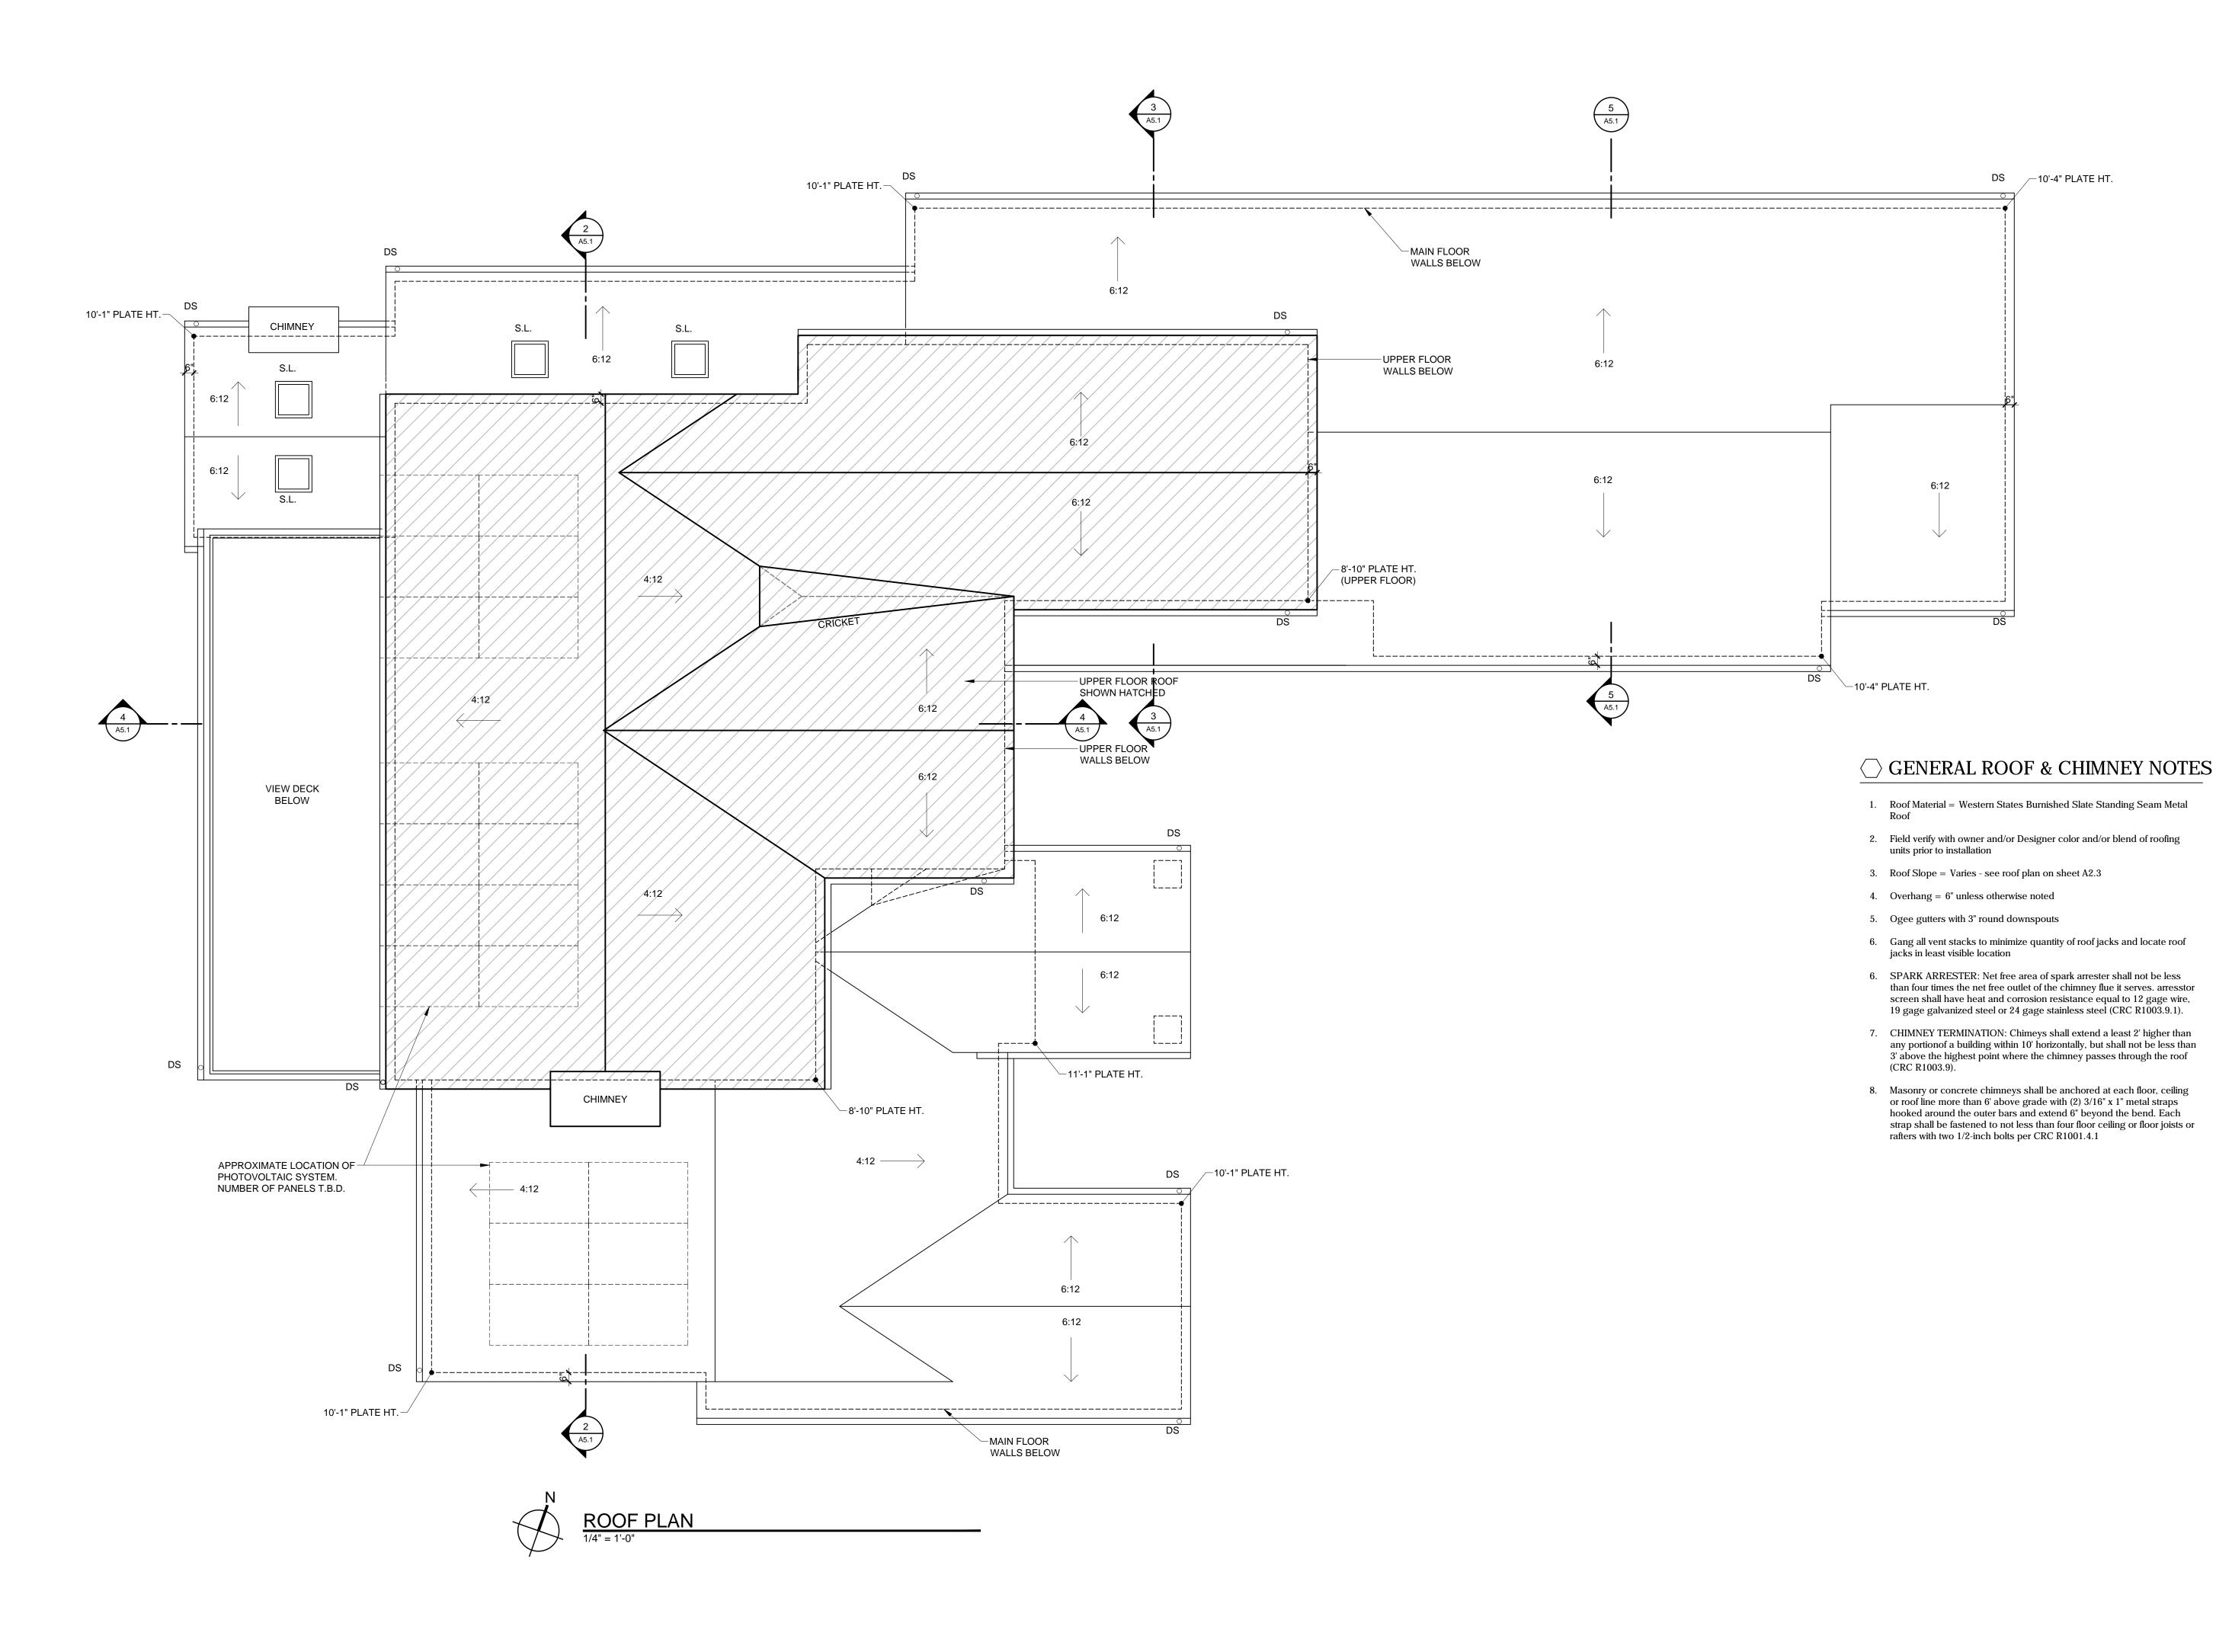

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the acceptance of the restrictions.

SHEET TITLE: **ROOF PLAN** 



CONCEPTUAL FRONT ELEVATION



CONCEPTUAL REAR ELEVATION

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SHEET TITLE:

COLOR

RENDERINGS

SHEET NUMBER:

A4.0




PROPOSED EAST ELEVATION

1/4" = 1'-0"


## $\bigcirc$ SHEET NOTES

- 1. ROOF WESTERN STATES BURNISHED SLATE STANDING SEAM METAL ROOF
- 2. WALLS TWO COATS EXTERIOR PAINT (BODY COLOR SHERWIN WILLIAMS USEFUL GRAY SW7050), (TRIM COLOR - SHERWIN WILLIAMS SEALSKIN SW7675) OVER 7/8" CEM. PLASTER W/ EXP. METAL LATH & PLASTESIZER ADDITIVE ( 3 COAT PER CBC 2508.1) 0/2 LAYERS GRADE 'D' BLDG. PAPER.
- 3. WINDOWS QUARTZ NEW DARK BRONZE WOOD CLAD DOUBLE PANE WINDOWS.

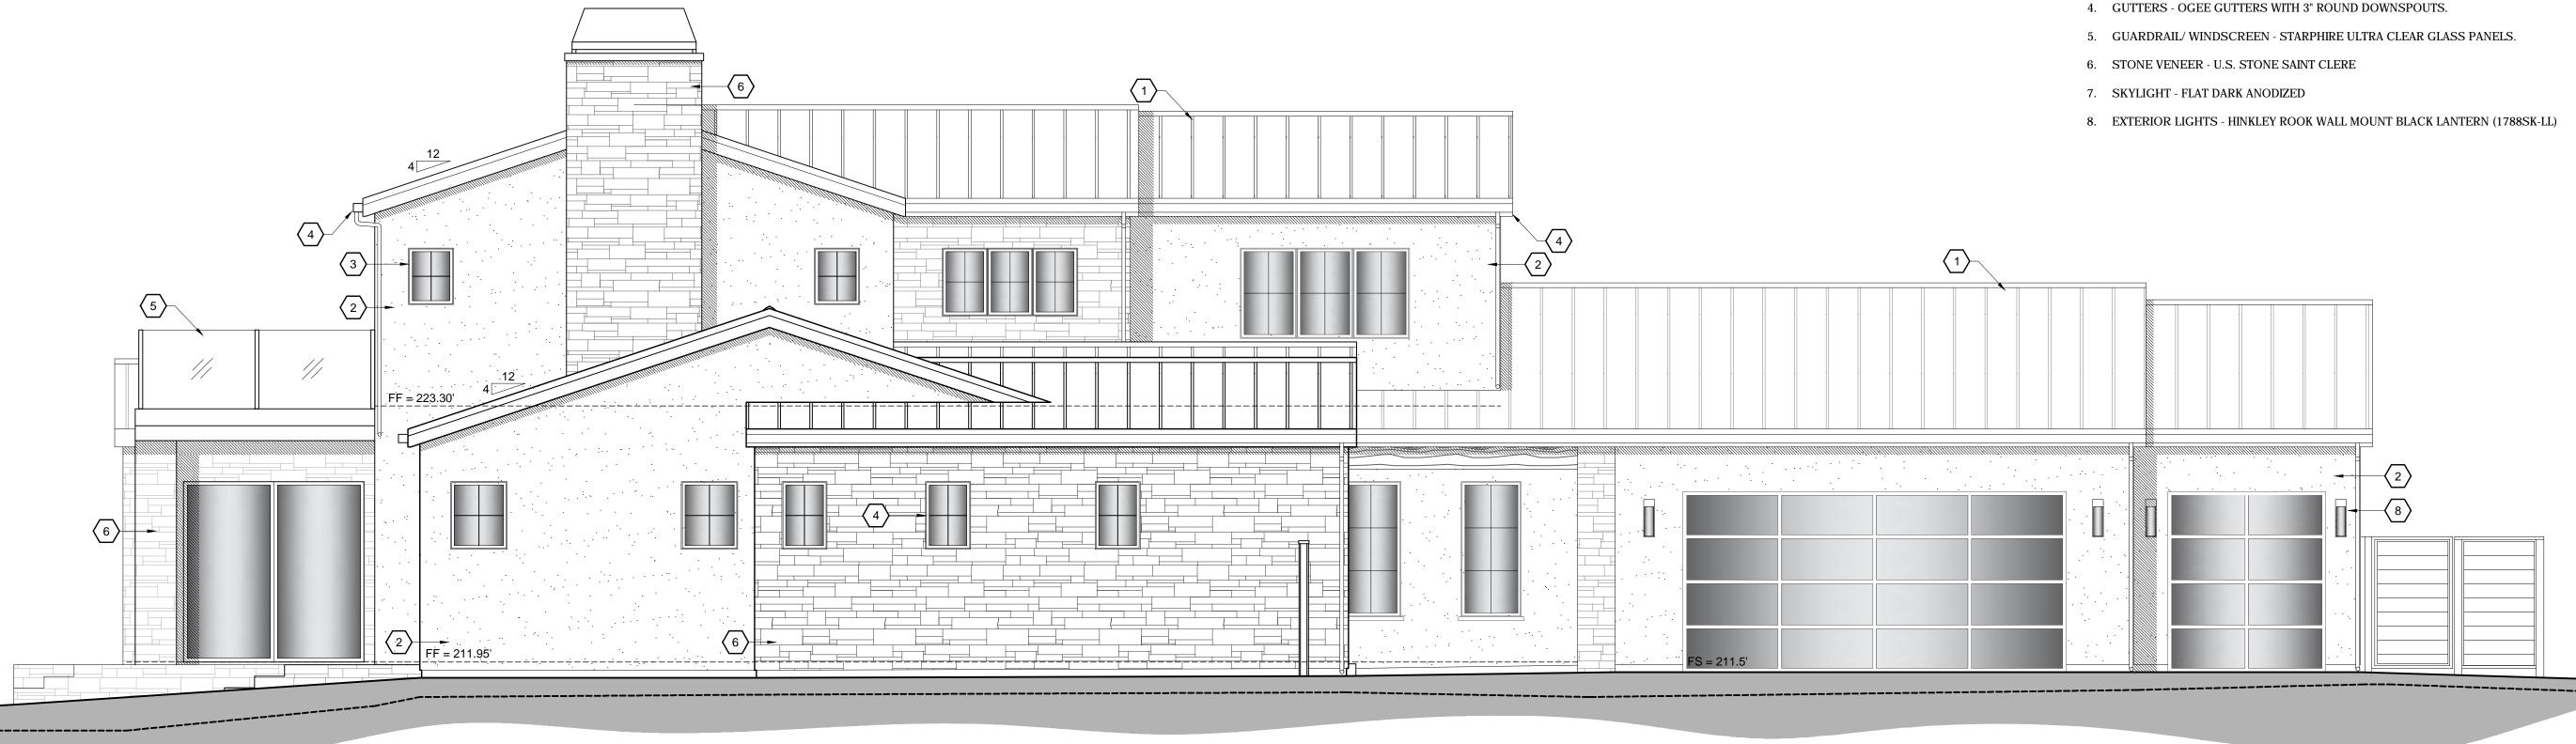

PROPOSED SOUTH ELEVATION

1/4" = 1'-0"

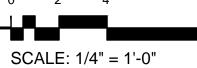

SCALE: 1/4" = 1'-0"

PROJECT NAME:

### CASTLEMAN RESIDENCE

1012 SAN CARLOS ROAD PEBBLE BEACH, CA 93953

APN: 007-282-004-000



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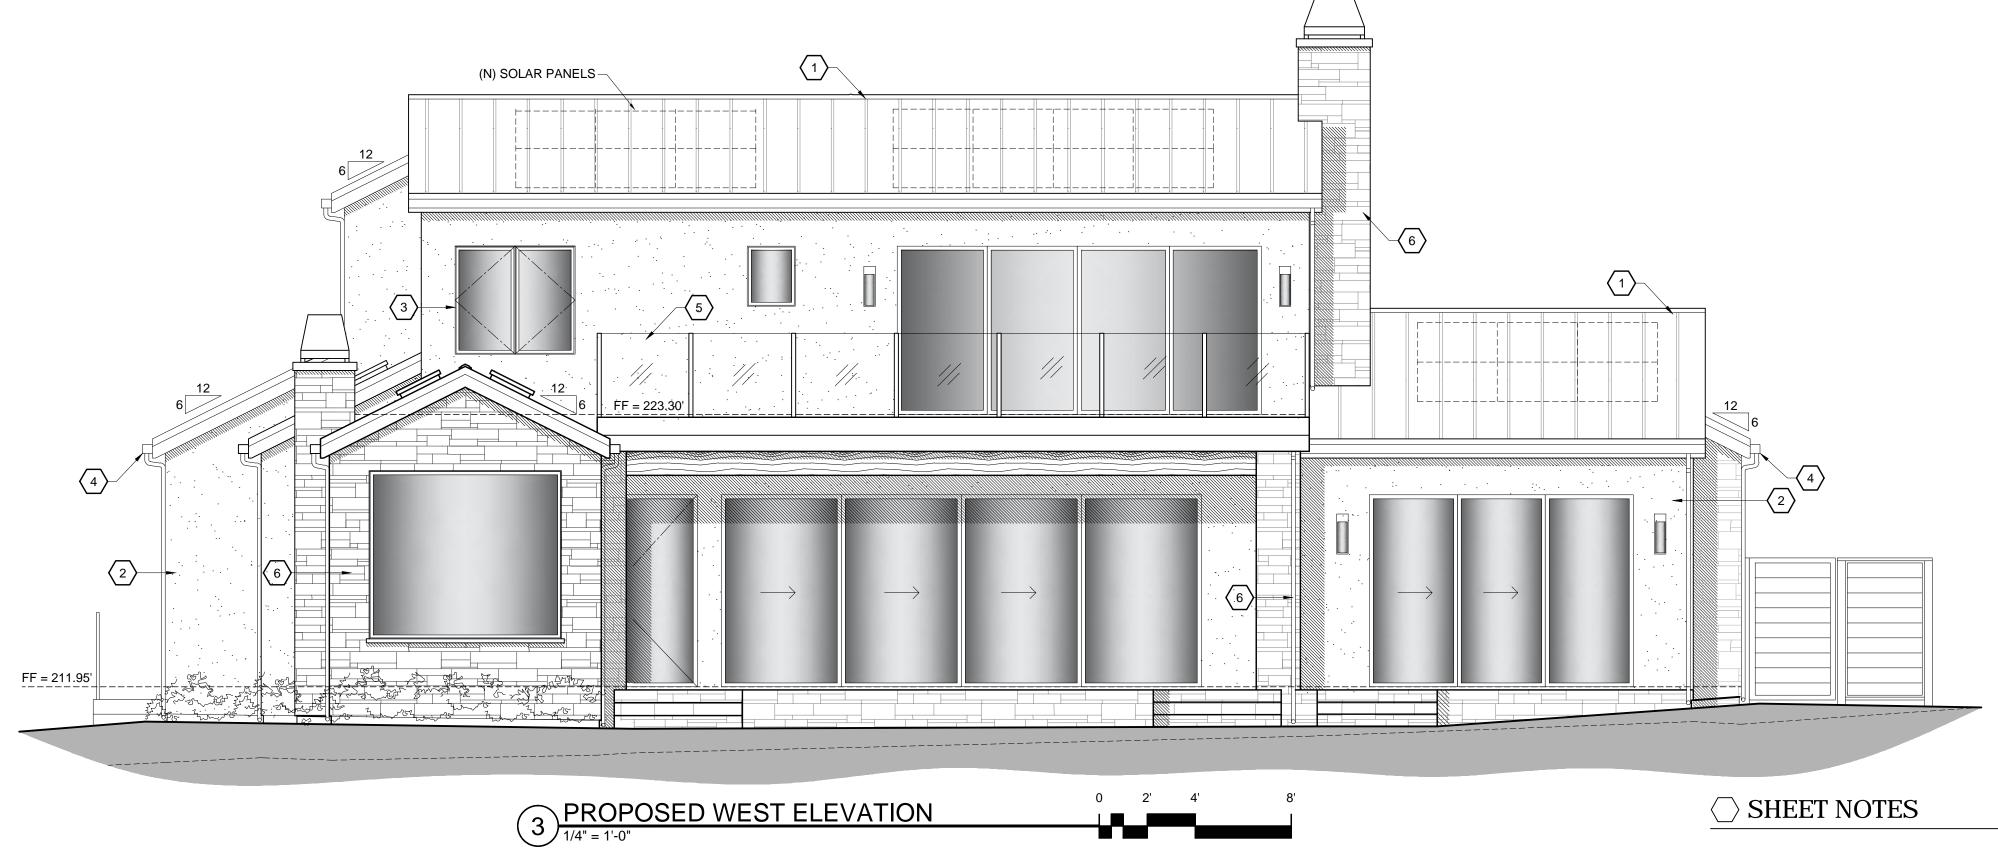
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SHEET TITLE: **ELEVATIONS** 




SCALE: 1/4" = 1'-0"

SCALE: 1/4" = 1'-0"

### ○ SHEET NOTES

- 1. ROOF WESTERN STATES BURNISHED SLATE STANDING SEAM METAL ROOF
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- 3. WINDOWS QUARTZ NEW DARK BRONZE WOOD CLAD DOUBLE PANE WINDOWS.
- 4. GUTTERS OGEE GUTTERS WITH 3" ROUND DOWNSPOUTS.
- 5. GUARDRAIL/ WINDSCREEN STARPHIRE ULTRA CLEAR GLASS PANELS.
- 6. STONE VENEER U.S. STONE SAINT CLERE
- 7. SKYLIGHT FLAT DARK ANODIZED
- 8. EXTERIOR LIGHTS HINKLEY ROOK WALL MOUNT BLACK LANTERN (1788SK-LL)

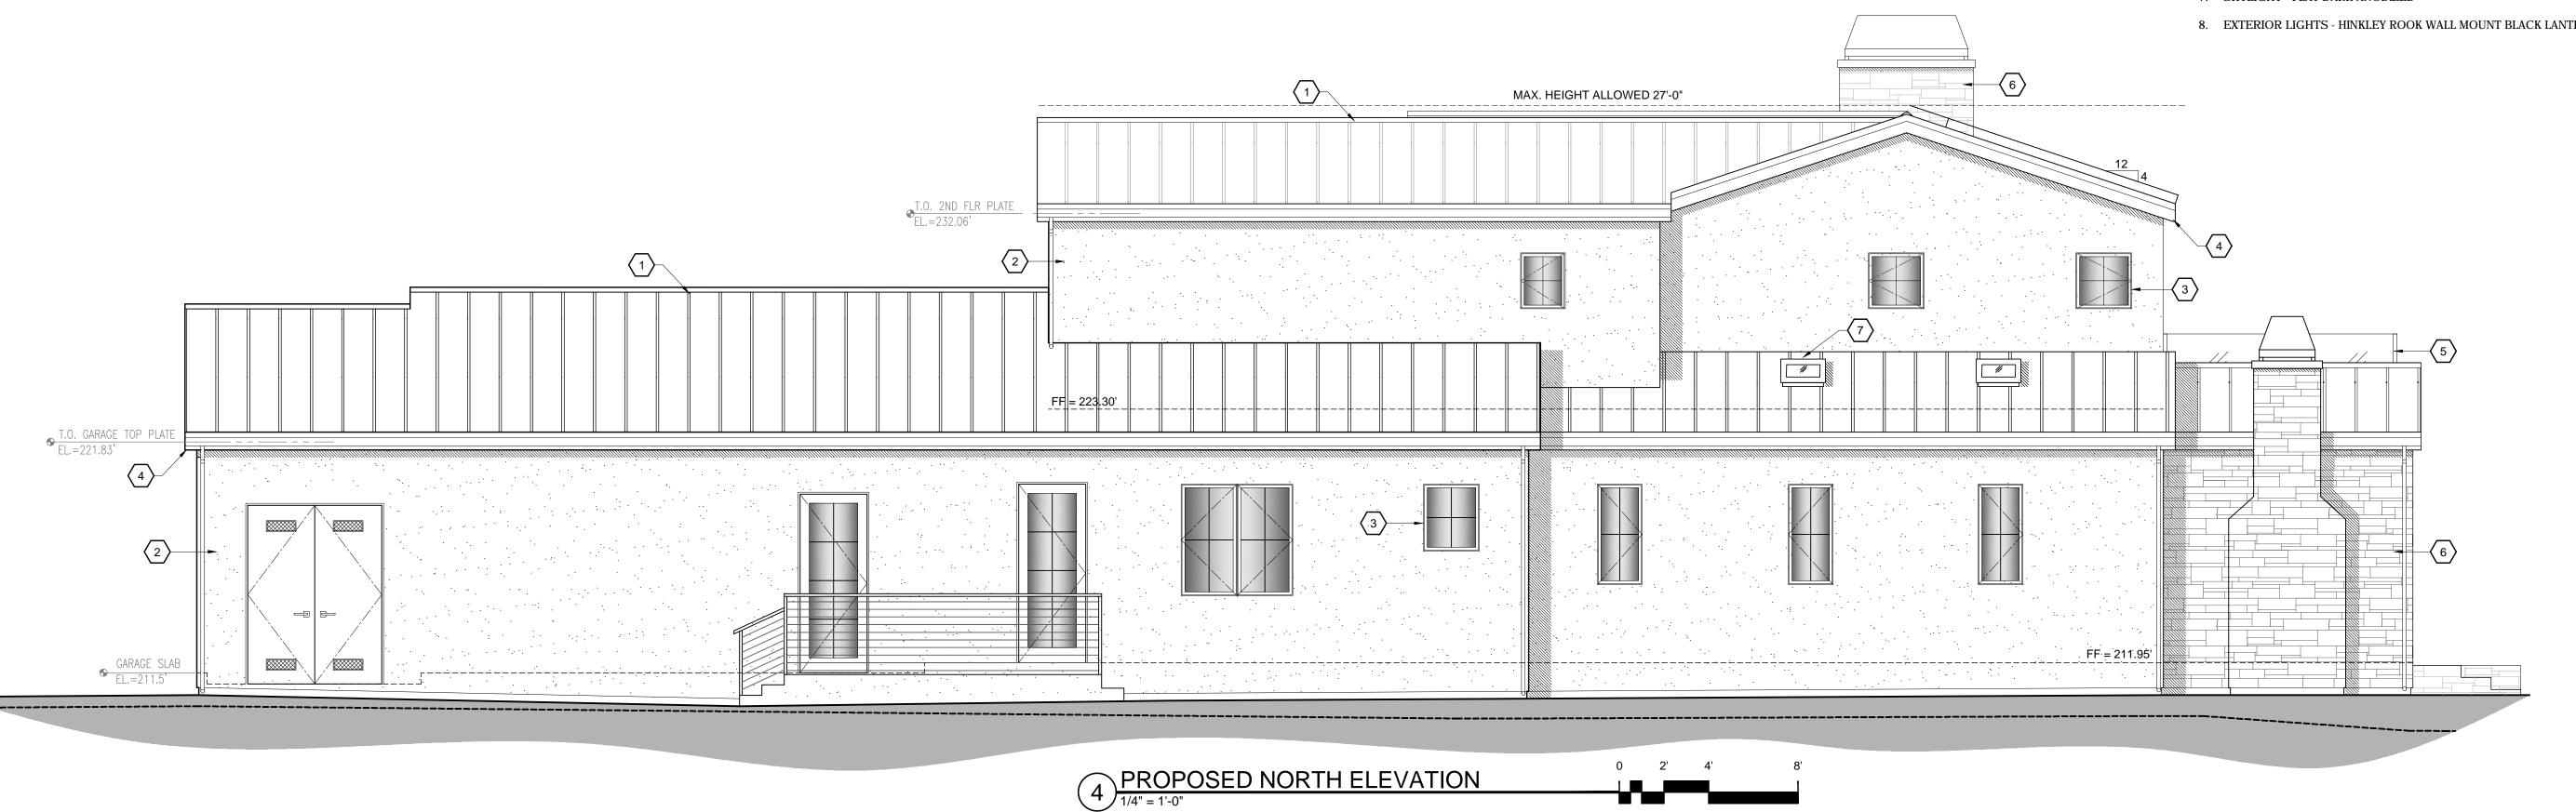

PROJECT NAME:

### CASTLEMAN RESIDENCE

1012 SAN CARLOS ROAD PEBBLE BEACH, CA 93953

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CONSTRUCTION ADMINISTRATION

DRAWING RECORD		
DESCRIPTION	ISSUED	
PLN SUBMIT	3/12/2025	
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SHEET TITLE: **ELEVATIONS**