Exhibit B

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Before the Zoning Administrator in and for the County of Monterey, State of California

In the matter of the application of: **PETERSON BRADLEY J & KERRY A TRS (PLN220185) RESOLUTION NO. 25-**

Resolution by the County of Monterey Zoning Administrator:

- Finding that the project qualifies as a Class 3 Categorical Exemption pursuant to CEQA Guidelines section 15303, and there are no exceptions pursuant to Section 15300.2; and
- Approving a Design Approval to allow the construction of a 5,510 square foot single family dwelling, a 1,197 attached garage, a 1,213 square foot detached pool house, a 929 detached yoga studio, and associated site improvements; and a Tree Removal Permit to allow the removal of two protected trees.

[PLN220185 Peterson Bradley J & Kerry A Trs, 25600 Via Malpaso, Carmel, Greater Monterey Peninsula Area Plan (Assessor's Parcel Number: 259-092-023-000)]

The Peterson Bradley J & Kerry A Trs application (PLN220185) came on for a public hearing before the County of Monterey Zoning Administrator on January 30, 2025. Having considered all the written and documentary evidence, the administrative record, the staff report, oral testimony, and other evidence presented, the Zoning Administrator finds and decides as follows:

RECITALS:

WHEREAS, the proposed project PLN220185, located at 25600 Via Malpaso, Carmel, Greater Monterey Peninsula Area Plan (APN: 259-092-023-000), is consistent with the policies of the Monterey County 2010 General Plan, Greater Monterey Peninsula Area Plan, and the Monterey County Zoning Ordinance (Title 21);

WHEREAS, the subject parcel is zoned Rural Density Residential with a density of one unit per 10 acres, Urban Reserve, and Design overlay districts ("RDR/10-UR-D"), which allows for the construction of the first single family dwelling and accessory structures on a legal lot of record subject to the granting of a Design Approval;

WHEREAS, pursuant to Title 21 Chapter 21.50, HCD-Planning staff provided the application materials to the City of Monterey's planning department, who had no comments or concerns with the proposed development;

WHEREAS, as proposed, the project consists of construction of a 5,510 square foot single family dwelling, a 1,197 attached garage, a 1,213 square foot detached pool house, a 929

detached yoga studio, and associated site improvements including a pool, a motor court, covered terraces and an asphalt driveway and the removal of two protected oak trees;

WHEREAS, as detailed in the attached plans, the proposed project meets all required development standards established in the Monterey County Code (MCC) Section 21.16.060 and the 2010 General Plan Policy LU-2.34(b);

WHEREAS, the proposed colors and materials consist of smooth, taupe exterior stucco siding, light grey board-formed concrete accent pillars, copper chimney shroud, aluminum door and window frames, copper downspouts, a flat roof membrane and grey concrete for the landscape walls and patios. As designed and sited, the project colors and materials blend with the surrounding natural environment. The overall design, including the bulk and mass, are consistent with other nearby homes;

WHEREAS, the subject property is not located in an area of high visual sensitivity and will not result in adverse visual impacts. As sited, designed, and conditioned, the project is consistent with the applicable scenic resource policies of the 2010 General Plan and the Greater Monterey Peninsula Area Plan;

WHEREAS, the subject property (27.13 acres in size), APN: 259-092-023-000, is illustrated in its current size and configuration as Lot 84 within Tract No. 1336 of the Canada Woods North, Phase I subdivision, which was recorded with the County of Monterey Clerk-Recorder in February of 2000. Therefore, the County recognizes the subject property as a legal lot of record;

WHEREAS, construction of the proposed single-family dwelling requires the removal of two protected Coast live oak trees (16 inches and 7 inches in diameter). Pursuant to MCC Section 21.64.260.C.4, a Tree Removal Permit is required to allow the proposed tree removal. The project-specific tree assessment (Monterey County Library No. LIB250003) identified the two Oaks slated for removal as being in fair condition with notable structural deficiencies and being located within, or directly adjacent to, the structure's footprint. The numerous remaining trees on the property will be retained and protected from construction activities for the duration of the property development project. As conditioned, tree and root protection measures will be properly monitored and maintained during project construction to assist in preserving and protecting ecological resources and minimizing impacts on nearby trees and woodland habitat. The removal of the two Oaks will not have any long-term impacts on the health of the surrounding Oak Forest. As conditioned, the project will involve the replanting of at least two Oaks near the proposed development. HCD-Planning staff has independently reviewed this report and agrees with its conclusions. In this case, tree removal is the minimum amount necessary for development of the site;

WHEREAS, Monterey County HCD-Planning and HCD-Building Services records were reviewed, and the County is not aware of any violations existing on subject property;

WHEREAS, the project was referred to the Greater Monterey Peninsula Land Use Advisory Committee (LUAC) pursuant to Board of Supervisors adopted LUAC Guidelines. This LUAC failed to provide a quorum at two consecutive meetings; therefore, the project did not receive review from the LUAC;

WHEREAS, California Environmental Quality Act (CEQA) Guidelines section 15303 categorically exempts new construction of structures including the first single-family residence in a residential zone and small accessory structures. The project involves the construction of the

first single-family dwelling and detached accessory structures. Therefore, the proposed development is consistent with CEQA Guidelines section 15303, and none of the exceptions under CEQA Guidelines section 15300.2 apply to this project. The location of the project was not identified on any federal, state or local maps of environmentally sensitive, hazardous or areas of critical concern, successive projects in the same place will not result in a significant cumulative impact, there are no unusual circumstances that would result in a significant effect to the environment due to this project, the project will not result in adverse impacts to scenic resources, and the project is not located on or near a hazardous waste site; and

WHEREAS, pursuant to MCC Section 21.80.040.B, the Planning Commission shall consider appeals from the discretionary decisions of the Zoning Administrator, and the decision of the Planning Commission would be final and may not be appealed.

NOW, THEREFORE BE IT RESOLVED, based on the above recitals, the Monterey County Zoning Administrator does hereby:

- 1) Find that the project qualifies as a Class 3 Categorical Exemption pursuant to CEQA Guidelines section 15303, and there are no exceptions pursuant to Section 15300.2; and
- 2) Approve a Design Approval to allow the construction of a 5,510 square foot single family dwelling, a 1,197 attached garage, a 1,213 square foot detached pool house, a 929 detached yoga studio and associated site improvements; and a Tree Removal Permit to allow the removal of two protected trees.

PASSED AND ADOPTED this 30th day of January, 2025.

Mike Novo, AICP Zoning Administrator

COPY OF THIS DECISION MAILED TO APPLICANT ON DATE.

THIS APPLICATION IS APPEALABLE TO THE PLANNING COMMMISSION. IF ANYONE WISHES TO APPEAL THIS DECISION, AN APPEAL FORM MUST BE COMPLETED AND SUBMITTED TO THE SECRETARY OF THE PLANNING COMMISSION ALONG WITH THE APPROPRIATE FILING FEE ON OR BEFORE DATE.

This decision, if this is the final decision, is subject to judicial review pursuant to California Code of Civil Procedure Sections 1094.5 and 1094.6. Any Petition for Writ of Mandate must be filed with the Court no later than the 90th day following the date on which this decision becomes final.

<u>NOTES</u>

- 1. You will need a building permit and must comply with the Monterey County Building Ordinance in every respect.
- 2. Additionally, the Zoning Ordinance provides that no building permit shall be issued, nor any use conducted, otherwise than in accordance with the conditions and terms of the permit granted or until ten days after the mailing of notice of the granting of the permit by the appropriate authority, or after granting of the permit by the Board of Supervisors in the event of appeal.
- 3. Do not start any construction or occupy any building until you have obtained the necessary permits and use clearances from Monterey County HCD-Planning and HCD-Building Services Department office in Salinas.

County of Monterey HCD Planning

DRAFT Conditions of Approval/Implementation Plan/Mitigation Monitoring and Reporting Plan

PLN220185

1. PD001 - SPECIFIC USES ONLY

Responsible Department: Planning

Performed:

Condition/Mitigation This Design Approval and Tree Removal permit (PLN220185) allows construction of a **Monitoring Measure:** 5,510 square foot single family dwelling, a 1,197 attached garage, a 1,213 square foot detached pool house, a 929 detached yoga studio and associated site improvements including a pool, a motor court, covered terraces and an asphalt driveway and the removal of two protected oak trees. The property is located at 25600 Via Malpaso, Carmel (Assessor's Parcel Number 259-092-023-000), Greater Monterey Peninsula Area Plan. This permit was approved in accordance with County ordinances and land use regulations subject to the terms and conditions described in the project file. Neither the uses nor the construction allowed by this permit shall commence unless and until all of the conditions of this permit are met to the satisfaction of the Director of Any use or construction not in substantial conformance with the HCD - Planning. terms and conditions of this permit is a violation of County regulations and may result in modification or revocation of this permit and subsequent legal action. No use or construction other than that specified by this permit is allowed unless additional permits are approved by the appropriate authorities. To the extent that the County has delegated any condition compliance or mitigation monitoring to the Monterey County Water Resources Agency, the Water Resources Agency shall provide all information requested by the County and the County shall bear ultimate responsibility to ensure that conditions and mitigation measures are properly fulfilled. (HCD - Planning)

Compliance or Monitoring Action to beThe Owner/Applicant shall adhere to conditions and uses specified in the permit on an on-going basis unless otherwise stated.

2. PD002 - NOTICE PERMIT APPROVAL

Responsible Department: Planning

Condition/Mitigation The applicant shall record a Permit Approval Notice. This notice shall state:

"A Public Hearing Design Approval and Tree Removal Permit (Resolution Number _____) was approved by the Zoning Administrator for Assessor's Parcel Number 259-092-023-000 on January 30, 2025. The permit was granted subject to 13 conditions of approval which run with the land. A copy of the permit is on file with Monterey County HCD - Planning."

Proof of recordation of this notice shall be furnished to the Director of HCD - Planning prior to issuance of grading and building permits, Certificates of Compliance, or commencement of use, whichever occurs first and as applicable. (HCD - Planning)

Compliance or Monitoring Action to be Performed:Prior to the issuance of grading and building permits, certificates of compliance, or commencement of use, whichever occurs first and as applicable, the Owner/Applicant shall provide proof of recordation of this notice to the HCD - Planning.

3. PD003(A) - CULTURAL RESOURCES NEGATIVE ARCHAEOLOGICAL REPORT

Responsible Department: Planning

Condition/Mitigation construction, cultural, lf, during the course of archaeological, historical or **Monitoring Measure:** paleontological resources are uncovered at the site (surface or subsurface resources) work shall be halted immediately within 50 meters (165 feet) of the find until a qualified professional archaeologist can evaluate it. Monterey County HCD - Planning and a archaeologist registered with of qualified archaeologist (i.e., an the Register Professional Archaeologists) shall be immediately contacted by the responsible individual present on-site. When contacted, the project planner and the archaeologist shall immediately visit the site to determine the extent of the resources and to develop proper mitigation measures required for recovery. (HCD - Planning)

Compliance or Monitoring Action to be Performed:

The Owner/Applicant shall adhere to this condition on an on-going basis.

Prior to the issuance of grading or building permits and/or prior to the recordation of the final/parcel map, whichever occurs first, the Owner/Applicant shall include requirements of this condition as a note on all grading and building plans. The note shall state "Stop work within 50 meters (165 feet) of uncovered resource and contact Monterey County HCD - Planning and a qualified archaeologist immediately if cultural, archaeological, historical or paleontological resources are uncovered."

When contacted, the project planner and the archaeologist shall immediately visit the site to determine the extent of the resources and to develop proper mitigation measures required for the discovery.

4. PD011 - TREE AND ROOT PROTECTION

Responsible Department: Planning

Condition/Mitigation Trees which are located close to construction site(s) shall be protected from **Monitoring Measure:** inadvertent damage from construction equipment by fencing off the canopy driplines and/or critical root zones (whichever is greater) with protective materials, wrapping trunks with protective materials, avoiding fill of any type against the base of the trunks and avoiding an increase in soil depth at the feeding zone or drip-line of the retained Said protection, approved by certified arborist, shall be demonstrated prior to trees. issuance of building permits subject to the approval of HCD - Director of Planning. lf there is any potential for damage, all work must stop in the area and a report, with mitigation measures, shall be submitted by certified arborist. Should any additional trees not included in this permit be harmed, during grading or construction activities, in such a way where removal is required, the owner/applicant shall obtain required permits. (HCD - Planning)

Compliance or Monitoring Action to be Prior to issuance of grading and/or building permits, the Owner/Applicant shall submit evidence of tree protection to HCD - Planning for review and approval.

During construction, the Owner/Applicant/Arborist shall submit on-going evidence that tree protection measures are in place through out grading and construction phases. If damage is possible, submit an interim report prepared by a certified arborist.

Prior to final inspection, the Owner/Applicant shall submit photos of the trees on the property to HCD-Planning after construction to document that tree protection has been successful or if follow-up remediation or additional permits are required.

5. PD011(A) - TREE REMOVAL

Performed:

Responsible Department: Planning

Condition/Mitigation Monitoring Measure: Tree removal shall not occur until a construction permit has been issued in conformance with the appropriate stage or phase of development in this permit. Only those trees approved for removal shall be removed. (HCD-Planning)

Compliance or Applicant/ Prior to tree removal, the Owner/ Tree Removal Contractor shall Monitoring demonstrate that a construction permit has been issued prior to commencement of Action to be tree removal. Performed:

6. PD012(F) - LANDSCAPE PLAN & MAINTENANCE (SFD ONLY)

Responsible Department: Planning

Condition/Mitigation Monitoring Measure: The site shall be landscaped. Prior to the issuance of building permits, three (3) copies of a landscaping plan shall be submitted to the Director of HCD - Planning. A landscape plan review fee is required for this project. Fees shall be paid at the time of landscape plan submittal. The landscaping plan shall be in sufficient detail to identify the location, species, and size of the proposed landscaping materials and shall include an irrigation plan. The plan shall be accompanied by a nursery or contractor's estimate of the cost of installation of the plan. Before occupancy, landscaping shall be either installed or a certificate of deposit or other form of surety made payable to Monterey County for that cost estimate shall be submitted to the Monterey County HCD -Planning. All landscaped areas and fences shall be continuously maintained by the applicant; all plant material shall be continuously maintained in a litter-free, weed-free, healthy, growing condition. (HCD - Planning)

Compliance or Prior to issuance of building permits, the Owner/Applicant/Licensed Landscape Monitorina plans Contractor/Licensed Landscape Architect shall submit landscape and Action to be contractor's estimate to the HCD - Planning for review and approval. Landscaping Performed: plans shall include the recommendations from the Forest Management Plan or Biological Survey as applicable. All landscape plans shall be signed and stamped by licensed professional under the following statement, "I certify that this landscaping and irrigation plan complies with all Monterey County landscaping requirements including use of native, drought-tolerant, non-invasive species; limited turf; and low-flow, water conserving irrigation fixtures."

Prior to occupancy, the Owner/Applicant/Licensed Landscape Contractor/Licensed Landscape Architect shall ensure that the landscaping shall be either installed or a certificate of deposit or other form of surety made payable to Monterey County for that cost estimate shall be submitted to the Monterey County HCD - Planning.

On an on-going basis, all landscaped areas and fences shall be continuously maintained by the Owner/Applicant; all plant material shall be continuously maintained in a litter-free, weed-free, healthy, growing condition.

7. PD014(A) - LIGHTING - EXTERIOR LIGHTING PLAN

Responsible Department: Planning

Condition/Mitigation Monitoring Measure: All exterior lighting shall be unobtrusive, down-lit, harmonious with the local area, and constructed or located so that only the intended area is illuminated and off-site glare is fully controlled. The lighting source shall be shielded and recessed into the fixture. The applicant shall submit three (3) copies of an exterior lighting plan which shall indicate the location, type, and wattage of all light fixtures and include catalog sheets for each fixture. The lighting shall comply with the requirements of the California Energy Code set forth in California Code of Regulations Title 24 Part 6. The exterior lighting plan shall be subject to approval by the Director of HCD - Planning, prior to the issuance of building permits.

(HCD - Planning)

Compliance or Monitoring Action to be Performed:Prior to the issuance of building permits, the Owner/Applicant shall submit three copies of the lighting plans to HCD - Planning for review and approval. Approved lighting plans shall be incorporated into final building plans.

Prior to final/occupancy, the Owner/Applicant/Contractor shall submit written and photographic evidence demonstrating that the lighting has been installed according to the approved plan.

On an on-going basis, the Owner/Applicant shall ensure that the lighting is installed and maintained in accordance with the approved plan.

8. PD048 - TREE REPLACEMENT/RELOCATION

Responsible Department:	Planning
Condition/Mitigation Monitoring Measure:	Prior to final, the applicant shall replace and or relocate each tree approved for removal as follows: - Replacement ratio: 1:1 - Replacement ratio recommended by arborist: 1:1 - Other: Replacement tree(s) shall be located within the same general location as the tree being removed. (HCD - Planning)
Compliance or Monitoring Action to be Performed:	The Owner/Applicant shall submit evidence of tree replacement to HCD -Planning for review and approval. Evidence shall be a receipt for the purchase of the replacement tree(s) and photos of the replacement tree(s) being planted.
	Six months after the planting of the replacement tree(s), the Owner/Applicant shall submit evidence demonstrating that the replacement tree(s) are in a healthy, growing condition.
	One year after the planting of the replacement tree(s), the Owner/Applicant shall submit a letter prepared by a County-approved tree consultant reporting on the health of the replacement tree(s) and whether or not the tree replacement was successful or if follow-up remediation measures or additional permits are required.

9. PD050 - RAPTOR/MIGRATORY BIRD NESTING

Responsible Department: Planning

- Condition/Mitigation Monitoring Measure: Any tree removal activity that occurs during the typical bird nesting season (February 22-August 1), the County of Monterey shall require that the project applicant retain a County qualified biologist to perform a nest survey in order to determine if any active raptor or migratory bird nests occur within the project site or within 300 feet of proposed tree removal activity. During the typical nesting season, the survey shall be conducted no more than 30 days prior to ground disturbance or tree removal. If nesting birds are found on the project site, an appropriate buffer plan shall be established by the project biologist. (HCD - Planning)
 - Compliance or No more than 30 days prior to ground disturbance or tree removal, the Monitoring Owner/Applicant/Tree Removal Contractor shall submit to HCD -Planning а nest Action to be survey prepare by a County qualified biologist to determine if any active raptor or Performed: migratory bird nests occur within the project site or immediate vicinity.

10. PW0043 - REGIONAL DEVELOPMENT IMPACT FEE

Responsible Department: Public Works

- Condition/Mitigation Monitoring Measure: Prior to issuance of building permits, applicant shall pay the Regional Development Impact Fee (RDIF) pursuant to Monterey Code Chapter 12.90. The fee amount shall be determined based on the parameters adopted in the current fee schedule.
 - Compliance or
Monitoring
Action to be
Performed:PriortoissuanceofBuildingPermitsOwner/ApplicantshallpayMontereyCountyBuildingServicesDepartmentthetrafficmitigationfee.Owner/ApplicantshallsubmitproofofpaymenttotheHCD-EngineeringServices.Services.

11. PW0044 - CONSTRUCTION MANAGEMENT PLAN

Responsible Department: Public Works

Condition/Mitigation
Monitoring Measure:The applicant shall submit a Construction Management Plan (CMP) to HCD-Planning
and HCD-Engineering Services for review and approval. The CMP shall include
measures to minimize traffic impacts during the construction/grading phase of the
project.

CMP shall include, at a minimum, duration of the construction, hours of operation, truck routes, estimated number of truck trips that will be generated, number of construction workers, and on-site/off-site parking areas for equipment and workers and locations of truck staging areas. Approved measures included in the CMP shall be implemented by the applicant during the construction/grading phase of the project. (Public Works)

Compliance or 1. Prior issuance the Grading to of Permit or Building Permit, Monitorina Owner/Applicant/Contractor shall prepare a CMP and shall submit the CMP to the Action to be HCD-Planning and HCD- Engineering Services for review and approval. Performed:

2. On-going through construction phases Owner/Applicant/Contractor shall implement the approved measures during the construction/grading phase of the project.

12. PW0045 – COUNTYWIDE TRAFFIC FEE

Responsible Department: Public Works

Condition/Mitigation
Monitoring Measure:Prior to issuance of building permits, the Owner/Applicant shall pay the Countywide
Traffic Fee or the ad hoc fee pursuant to General Plan Policy C-1.8. The fee amount
shall be determined based on the parameters in the current fee schedule.Compliance orPrior to issuance of Building Permits, the Owner/Applicant shall pay Monterey County

Monitoring Action to be Performed: proof of payment to HCD-Engineering Services.

13. PD041 - HEIGHT VERIFICATION

Responsible Department: Planning

Condition/Mitigation Monitoring Measure: The applicant shall have a benchmark placed upon the property and identify the benchmark on the building plans. The benchmark shall remain visible on-site until final building inspection. The applicant shall provide evidence from a licensed civil engineer or surveyor to the Director of HCD - Building Services for review and approval, that the height of the structure(s) from the benchmark is consistent with what was approved on the building permit associated with this project. (HCD - Planning and HCD - Building Services)

Compliance or
Monitoring
Action to be
Performed:Prior to the issuance of grading or building permits, the Owner/Applicant shall have a
benchmark placed upon the property and identify the benchmark on the building plans.
The benchmark shall remain visible onsite until final building inspection.

Prior to the foundation pre-pour inspection, the Owner/Applicant shall provide evidence from a licensed civil engineer or surveyor, to the Director of HCD - Building Services for review and approval, that the height of first finished floor from the benchmark is consistent with what was approved on the building permit.

Prior to the final inspection, the Owner/Applicant/Engineer shall provide evidence from a licensed civil engineer or surveyor, to the Director of HCD - Building Services for review and approval, that the height of the structure(s) from the benchmark is consistent with what was approved on the building permit.

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ABBREVIATIONS

-ANCHOR BOLT	F.E.(C).	-FIRE EXTINGUISHER(CABINET)
-AIR CONDITIONER	F.H.	-FIRE HYDRANT
-ACOUSTIC TILE	F.H.C.	-FIRE HOSE
-AREA DRAIN	FIBERGL.	-FIBERGLASS
-ADJUSTABLE	FIN.	-FINISH
-ALUMINUM	FIN.FL.	-FINISH FLOOR
-AND	FIN.GR.	-FINISH GRADE

FLR. -FLOOR

FLUOR. -FLUORESCENT

F.O.S. -FACE OF STUD

F.S.P. -FIRE STANDPIPE

-FOOTING

-GAUGE

-GLASS

-GRADE

-HEAD(ER)

HDWD. -HARDWOOD

HDWR. -HARDWARE

H.M. -HOLLOW METAL

-HOUR

-HEIGHT

I.D. -INSIDE DIAMETER

-INCHES

-LAMINATE(ION)

-LAVATORY

-LIGHT(ING)

-MACHINE

MECH. -MECHANICAL

-MAXIMUM

-MEMBRANE

-MEZZANINE

-MINIMUM

-MOUNTED

-MEETING

-METAL

-NORTH

N.I.C. -NOT IN CONTRACT

-NUMBER

-NOMINAL

N.T.S. -NOT TO SCALE

-MANUFACTURER

-MISCELLANEOUS

-POUND

HORZ. -HORIZONTAL

HTR. -HEATING(ER)

INSUL. -INSULATION

INV. -INVERT

JAN. -JANITOR

JT. -JOINT

LVR. -LOUVER

-GALVANIZED IRON

-GALVANIZED IRON

GALV. -GALVANIZED

GEN. -GENERAL

GLZ. -GLAZING

F.O. -FACE OF

FR. -FRAME

FXTR. -FIXTURE

FTG.

GA.

G.L

GL.

GR.

HD(R)

HR.

HT.

IN.

LAM.

LAV.

LB.

LT.(G)

MACH.

MEMB.

MEZZ.

MFR.

MIN.

MISC.

MTD.

MTG.

MTL.

N.

NO.

NOM.

MAX.

G.I.

FT. -FOOT, FEET

AB.

AC.

ACT.

AD.

ADJ.

ALUM.

&

ANOD

ARCH.

BITUM.

BLDG.

BLK(S).

BOT.

BRK.

BSMT.

B.U.R.

CAB.

CAP.

CAT.

CEM.

CER.

C.F.M.

CLG.

C.J.

C.M.U.

CNTR

C.O.

CONF.

COL.

COMM.

CONC.

CONST.

CONT.

CORR.

CPT.

C.T.

CTR.

DFT

D.F.

DIA.

DIAG.

DIM.

DN.

D.S.

DWG

ELEV.

ELECT.

ELEV.

EMER

EQ.

EQUIP

EXH.

EXP.

E.J.

EXTER.

F.D.

FDN.

EXIST('G)

С

BD.

-ANGLE

-BOARD

-ANODIZED

-ACCESS PANEL

-ARCHITECTURAL

-BITUMINOUS

-BUILDING

-BLOCK(ING)

-BASEMENT

-BUILT UP ROOF

-CENTERLINE

-CABINET

-CAPACITY

-CATALOG

-CERAMIC

-CEILING

UNIT

-COUNTER

-CLEANOUT

-COLUMN

-CONCRETE

-CONTINUOUS

-CERAMIC TILE

-DRINKING FOUNTAIN

-CORRIDOR

-CARPET

-CENTER

-DETAIL

-DIAMETER

-DIAGONAL

-DOWN

-DOWNSPOU

-DRAWING

-ELEVATION

-ELECTRICA

-ELEVATOR

-EQUAL

-EXISTING

-EXHAUST

-EXPANSION

-EXTERIOR

-FLOOR DRAIN

-FOUNDATION

-EXPANSION JOIN

-EQUIPMEN

-EMERGENCY

-DOOF

-EAST

-EACH

-CONFERENCE

-COMMUNICATION

-CONSTRUCTION

-CEMENT(ITIOUS)

-CUBIC FEET/MIN

-CONTROL JOINT

-CONCRETE MASONRY

-BOTTOM

-BRICK

O.D. -OUTSIDE DIAMETER O/ -OVER OPNG. -OPENING OVHD. -OVERHEAD PERF. -PERFORATED PL. -PLATE PLAS. -PLASTER PLAS. LAM. -PLASTIC LAMINATE PLUMB. -PLUMBING PLYWD. -PLYWOOD POL. -POLISH(ED) PART. -PARTITION RAD. -RADIUS RA. -RETURN AIR R.D. -ROOF DRAIN REFR. -REFRIGERATOR REINF. -REINFORCED REV. -REVISED -RISER RM. -ROOM R.O. -ROUGH OPENING SCHED. -SCHEDULE SECT. -SECTION SHT. -SHEET G.F.I. -GROUND FAULT INTERRUPT GWBD. -GYPSUM WALL BOARD SIM. -SIMILAR S.J. -SCORED JOINT SPKLR. -SPRINKLER SPKR. -SPEAKER S.F. -SQUARE FEET -SOUTH S. SQ. -SQUARE S.S. -STAINLESS STEEL STL. -STEEL S.T.C. -SOUND TRANS GLASS H.V.A.C. -HEATING VENTILATION AND AIR CONDITIONING STD. -STANDARD STOR. -STORAGE STRUCT. -STRUCTURAL SUSP. -SUSPENDED TEL. -TELEPHONE TEMP. -TEMPORARY T&G -TONGUE AND GROVE KDVGDF. -KILN DRY VERT. GRAIN DOUG FIR -THICK THRU. -THROUGH T.O.S. -TOP OF SLAB /SUBFLOOR T.O.W. -TOP OF WAL' TYP. -TYPICAL VENT. -VENTILATION VERT. -VERTICAL VEST. -VESTIBULE W. -WIDE, WIDTH W/(O) -WITH (OR WITHOUT) W.C. -WATER CLOSET WD. -WOOD WDW. -WINDOW W.P. -WATERPROOFING WT. -WEIGHT

O.C. -ON CENTER


SYMBOLS LEGEND

4 (0) A7.1

INTERIOR ELEVATION INDEX SYMBOL SHOWING SHEET AND LAYOUT NUMBER FOR WALL ELEVATIONS CORRESPONDING TO THE 1,2,3 AND 4 VIEW DIRECTIONS

- DOOR NUMBER, SEE DOOR SCHEDULE 0
- $\langle 0 \rangle$ WINDOW LETTER, SEE WINDOW SCHEDULE
 - DETAIL CUT, SEE SHEETS INDICATED
- 00 PLAN KEYNOTES, SEE SHEET A8.2

ASSESSOR'S PARCEL MAP

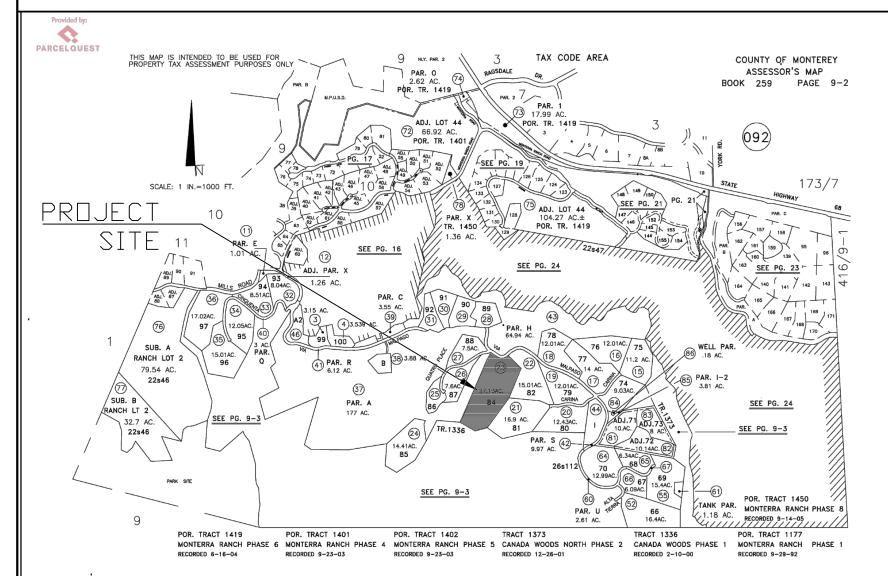

COI AN POC RE 650 1. THIS PROJECT SHA INCLUDE: CALIFORNI CALIFORNIA PLUMBI CODE (CEnC) AND CA 2. CONSTRUCTION W OF 65 PERCENT OF ACCORDANCE WITH

3. PRIOR TO BUILDIN WITH THE VEGETATI SECTION 4906, INCLU GOVERNMENT CODE

1. THIS PROJECT SH (CRC), 2019 CALIFOR 2019 CALIFORNIA EL CALIFORNIA GREEN

2. CONSTRUCTION W OF 65 PERCENT OF ACCORDANCE WITH

3. PRIOR TO BUILDIN WITH THE VEGETATI CODE SECTION 4906 CALIFORNIA GOVERI

					SHEET INDEX
ΡΕΤ	ERSON LOT 84, T 25600 VIA N	EHAMA	ENCE	T1.1 SP.1 G0.1 G0.2 A1.0 A1.1 A1.2	CAL-GREEN NOTES CAL-GREEN NOTES SITE SURVEY PLOT PLAN SITE PLAN
	CARME A.P.N. 259	•		C3.0 C3.1 C4.0 C5.0 C5.1 C5.1 C5.2	DRIVEWAY GRADING & LAYOUT PLANRESIDENTIAL SITE LAYOUT PLANRESIDENTIAL SITE GRADING PLANDRIVEWAY UTILITY PLANSITE UTILITY PLAN
	A.F.IN. 233	-032-023		C6.0 C6.1 C6.2	CONSTRUCTION DETAILS CONSTRUCTION DETAILS
PROJECT D	ESCRIPTION	OWNER	INFORMATION	C7.0 C8.0 C9.0	EROSION CONTROL PLAN
AN ATTACHED 1197 S.F. GARAGE POOLHOUSE, AND 929 S.F. GYM. 2	ORY 5,510 S.F. SINGLE FAMILY HOME WITH & STORAGE, 1213 S.F. DETACHED 2 TREES (1-6" AND 1-8" OAK) WILL BE T OF APPROXIMATELY 650 C.Y. OF CUT AND	BRADLEY 361 BEACO BOSTON, M		L1.0 L2.0 L2.1 L2.2	SITE PLAN
CONSUL	FANT LIST		JILDING CODE LEGEND	L2.2 L2.3 L2.4 L4.0	
ARCHITECTURE:	STERLING + HUDDLESON P.O. BOX 221092 CARMEL, CA 93923 OFFICE: 831.624.4363 CONTACT: BRADEN STERLING	A.P.N.: LOT SIZE: ZONING: OCCUPANCY GROUP:	259-092-023 27.13 ACRES LOT 3.85 ACRES BUILDING ENVELOPE RDR/10-UR-D R-3/U	SGNY L4.1 L4.2 L5.0 L5.1 L5.2	IRRIGATION NOTES IRRIGATION PLAN IRRIGATION PLAN
SURVEY/CIVIL:	L& S ENGINEERING, INC. 2640 GARDEN ROAD, SUITE G MONTEREY, CA 93940 OFFICE: 831.655.2723 CONTACT: CHRIS STOUT	DESCRIPTION OF USE: TYPE OF CONSTRUCTION: SPRINKLERS: STORIES:	SINGLE FAMILY RESIDENTIAL TYPE V-B YES 2	L6.0 L6.1 L6.2 A2.1	SITE LIGHTING PLAN
SOILS: LANDSCAPE:	SOILS SURVEYS INC. 103 CHURCH STREET SALINAS, CA 93901 OFFICE: 831.757.2172 CONTACT: BELINDA TALUBAN SEVEN SPRINGS STUDIO	HEIGHT LIMIT: BUILDING HEIGHT:	30'-0" RESIDENCE 15'-0" ACCESSORY BUILDING 27 FEET NONE	A2.1. A2.1. A2.1. A2.1. A2.1. A2.1. A3.1	 ENLARGED PARTIAL MAIN LEVEL PLAN-1 ENLARGED PARTIAL MAIN LEVEL PLAN-2 ENLARGED GYM EXERCISE PLAN ENLARGED POOL HOUSE PLAN
MECHANICAL:	2548 EMPIRE GRADE SANTA CRUZ, CA 95060 OFFICE: 831.466.9617 CONTACT: SIMON PHILLIPS MONTEREY ENERGY GROUP	TREE REMOVAL: PARKING REQUIRED: PARKING PROVIDED:	NONE 2 SPACES 3 COVERED SPACES	A3. A4.1. A4.1. A4.2 A5.1	MAIN LEVEL REFLECTED CEILING PLAN EXERCISE AND POOL REFLECTED CEILING PLAN
STRUCTURAL:	26465 CARMEL RANCHO BLVD. STE 8 CARMEL, CA 93923 OFFICE: 831.372.8328 CONTACT: DAVID KNIGHT PFS CONSULTING, INC.	GRADING: WATER PROVIDER: SEWER PROVIDER:	CUT: APPROX. 350 C.Y. FILL: APPROX. 350 C.Y. CARMEL LAHAINA WATER COMPANY CANADA WOODS	A5.2 A5.3 A5.4 A5.4 A6.1 A6.2	BUILDING SECTIONS WALL SECTION EXTERIOR ELEVATIONS
	1750 HOWE AVENUE STE 640 SACRAMENTO, CA 95825 OFFICE: 916.978.2875 CONTACT: TERRY FRIZZELL	FIRE DEPARTMENT: SQUARE	FOOT ANALYSIS	 ▲ A6.3 A6.4 A8.1 A8.2 	EXTERIOR ELEVATION SECTIONS EXTERIOR RENDERINGS DOOR SCHEDULE WINDOW SCHEDULE
		LOT SIZE: 3 85 ACR <u>FLOOR AREA TABULATION</u>	27.313 ACRES FULL SITE ES (167,706 S.F.) BUILDING ENVELOPE	A9.1 A9.2 A9.3	DETAILS
PROJEC		MAIN LIVING AREA DETACHED POOL HOUSE DETACHED GYM AND YOGA GARAGE	5,510 S.F. 1,213 S.F. 929 S.F. 1,197 S.F.	E2.1. E2.1.	1 MAIN HOUSE ELECTRICAL PLAN 2 EXERCISE AND POOL HOUSE ELECTRICAL PLAN
RNIA RESIDENTIAL CODE (CRC	IFORNIA CODE OF REGULATIONS, TITLE 24 TO), CALIFORNIA MECHANICAL CODE (CMC), IA ELECTRICAL CODE (CEC) CALIFORNIA ENERGY alGreen).	TOTAL FLOOR AREA SITE COVERAGE TABULATIO	8,849 S.F. <u>DN</u>		
OF THE NON-HAZARDOUS CONS	CLE AND/OR SALVAGE FOR REUSE A MINIMUM STRUCTION AND DEMOLITION WASTE IN JILDING CODE, CHAPTER 4, DIVISION 4.4.	BUILDING FOOTPRINT POOL COVERED ENTRY COVERED TERRACE	8,849 S.F. 1,343 S.F. 327 S.F. 552 S.F.		
DING PERMIT FINAL APPROVAL, T HE PROPERTY SHALL BE IN COMPLIANCE ATION MANAGEMENT REQUIREMENTS PRESCRIBED IN CALIFORNIA FIRE CODE CLUDING CALIFORNIA PUBLIC RESOURCES CODE 4291 OR CALIFORNIA DDE SECTION 51182 PER CRC R327.1.5.		TOTAL SITE COVERAGE ALLOWABLE SITE COVERAG	(6.6%) 11,071 S.F. GE (25%) 41,927 S.F.		
GENERA	L NOTES				
FORNIA MECHANICAL CODE (CM	AND 2019 CALIFORNIA RESIDENTIAL CODE MC), 2019 CALIFORNIA PLUMBING CODE (CPC), IFORNIA ENERGY CODE (CENC) AND THE 2019				
OF THE NON-HAZARDOUS CON	CLE AND/OR SALVAGE FOR REUSE A MINIMUM STRUCTION AND DEMOLITION WASTE IN UILDING CODE, CHAPTER 4, DIVISION 4.4.				
DING PERMIT FINAL APPROVAL, T HE PROPERTY SHALL BE IN COMPLIANCE ATION MANAGEMENT REQUIREMENTS PRESCRIBED IN CALIFORNIA FIRE 906, INCLUDING CALIFORNIA PUBLIC RESOURCES CODE 4291 OR					
ERNMENT CODE SECTION 5118	σε Γ μιν υπο πσει. Ι.σ.				



STERLING | HUDDLESON ARCHITECTURE

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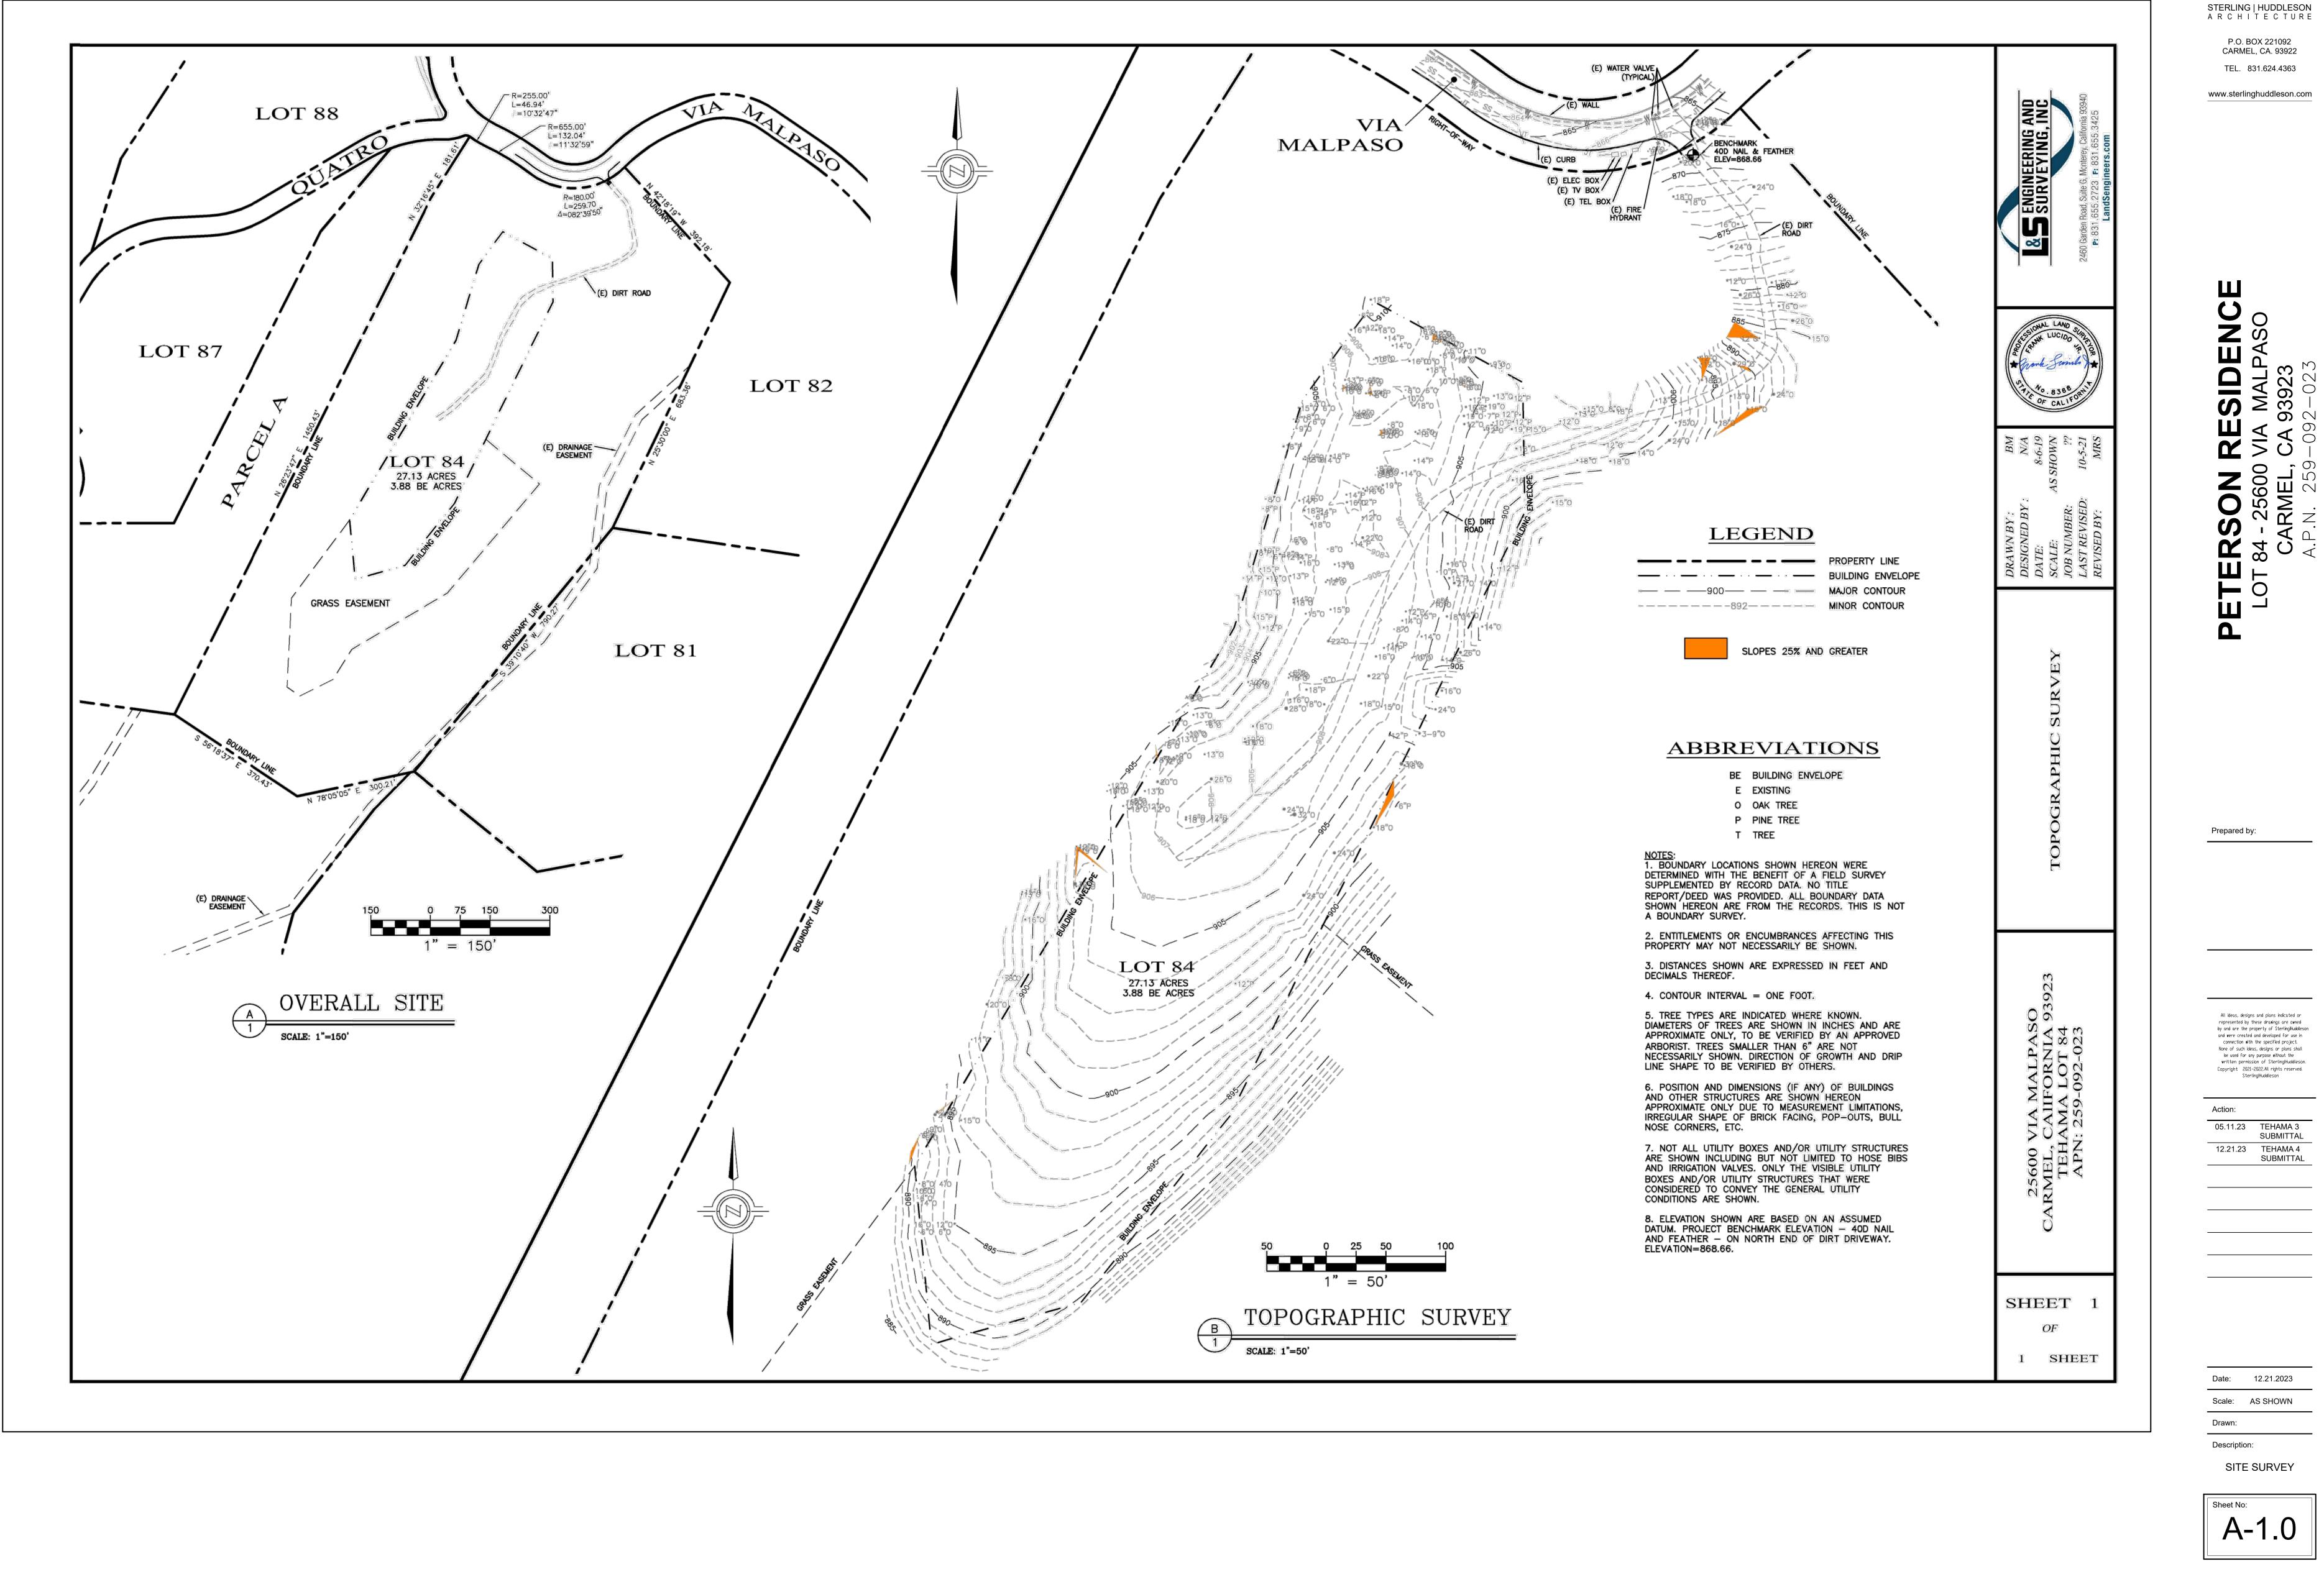


Prepared by

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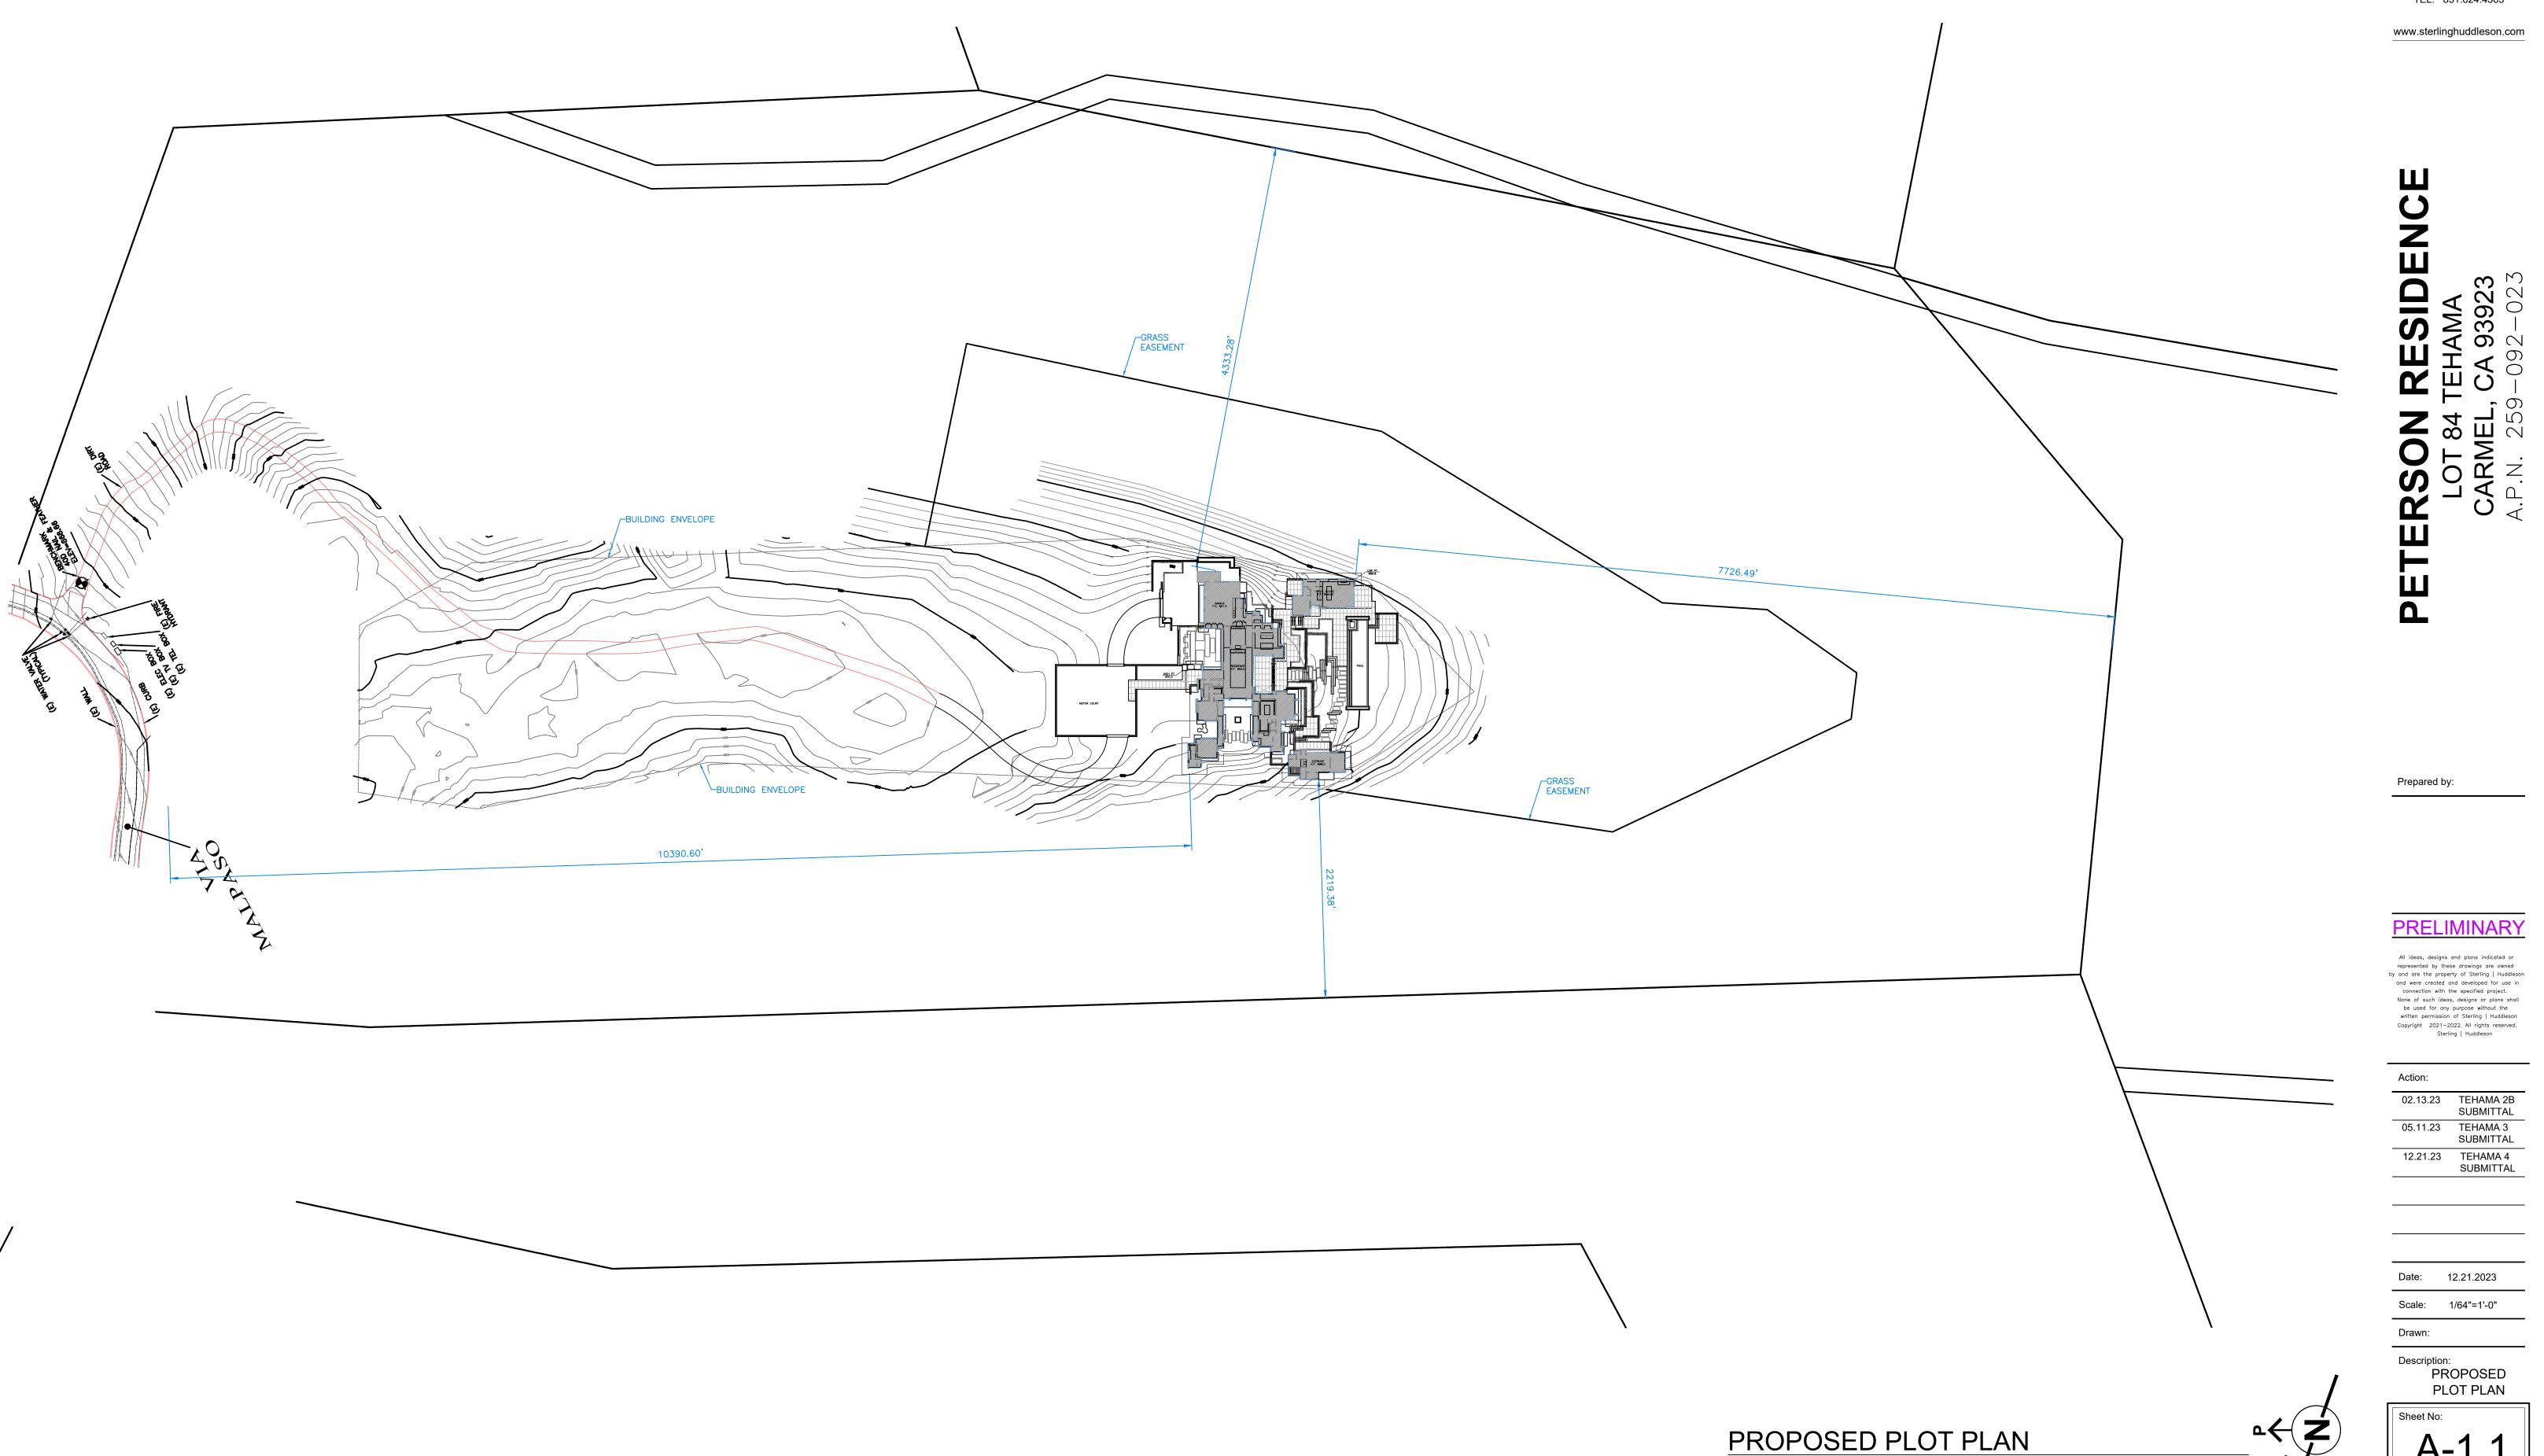
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12.08.22	UPDATED
TEHAMA 2	2A SUBMITTAL
02.13.23	TEHAMA 2B
	SUBMITTAL
05.11.23	TEHAMA 3
	SUBMITTAL
12.21.23	TEHAMA 4
	SUBMITTAL


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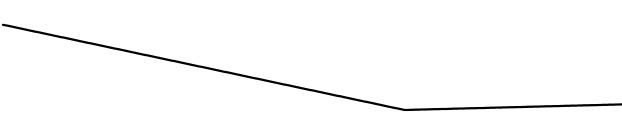










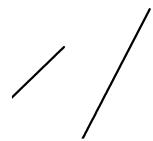



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PROPOSED PLOT PLAN

A-1.1

SCALE: 1/64"=1'-0"

FIRE007 – DRIVEWAYS

DRIVEWAYS SHALL NOT BE LESS THAN 12 FEET WIDE UNOBSTRUCTED, WITH AN UNOBSTRUCTED VERTICAL CLEARANCE OF NOT LESS THAN 15 FEET. THE GRADE FOR ALL DRIVEWAYS SHALL NOT EXCEED 15 PERCENT. WHERE THE GRADE EXCEEDS 8 PERCENT, A MINIMUM STRUCTURAL ROADWAY SURFACE OF 0.17 FEET OF ASPHALTIC CONCRETE ON 0.34 FEET OF AGGREGATE BASE SHALL BE REQUIRED. THE DRIVEWAY SURFACE SHALL BE CAPABLE OF SUPPORTING THE IMPOSED LOAD OF FIRE APPARATUS (22 TONS), AND BE ACCESSIBLE BY CONVENTIONAL-DRIVE VEHICLES, INCLUDING SEDANS. FOR DRIVEWAYS WITH TURNS 90 DEGREES AND LESS. THE MINIMUM HORIZONTAL INSIDE RADIUS OF CURVATURE SHALL BE 25 FEET. FOR DRIVEWAYS WITH TURNS GREATER THAN 90 DEGREES, THE MINIMUM HORIZONTAL INSIDE RADIUS CURVATURE SHALL BE 28 FEET. FOR ALL DRIVEWAY TURNS, AN ADDITIONAL SURFACE OF 4 FEET SHALL BE ADDED. ALL DRIVEWAYS EXCEEDING 150 FEET IN LENGTH, BUT LESS THAN 800 FEET IN LENGTH, SHALL PROVIDE A TURNOUT NEAR THE MIDPOINT OF THE DRIVEWAY. WHERE THE DRIVEWAY EXCEEDS 800 FEET, TURNOUTS SHALL BE PROVIDED AT NO GREATER THAN 400-FOOT INTERVALS. TURNOUTS SHALL BE A MINIMUM OF 12 FEET WIDE AND 30 FEET LONG WITH A MINIMUM OF 25-FOOT TAPER AT BOTH ENDS. TURNAROUNDS SHALL BE REQUIRED ON DRIVEWAYS IN EXCESS OF 150 FEET OF SURFACE LENGTH AND SHALL BE LOCATED WITHIN 50 FEET OF THE PRIMARY BUILDING. THE MINIMUM TURNING RADIUS FOR A TURNAROUND SHALL BE 40 FEET FROM THE CENTER LINE OF THE DRIVEWAY. IF A HAMMERHEAD/T IS USED, THE TOP OF THE "T" SHALL BE A MINIMUM OF 60 FEET IN LENGTH.

FIRE008 – GATES

ALL GATES PROVIDING ACCESS FROM A ROAD TO A DRIVEWAY SHALL BE LOCATED AT LEAST 30 FEET FROM THE ROADWAY AND SHALL OPEN TO ALLOW A VEHICLE TO STOP WITHOUT OBSTRUCTING TRAFFIC ON THE ROAD. GATE ENTRANCES SHALL BE AT LEAST THE WIDTH OF THE TRAFFIC LANE BUT IN NO CASE LESS THAN 12 FEET WIDE. WHERE A ONE-WAY ROAD WITH A SINGLE TRAFFIC LANE PROVIDES ACCESS TO A GATED ENTRANCE, A 40-FOOT TURNING RADIUS SHALL BE USED. WHERE GATES ARE TO BE LOCKED, THE INSTALLATION OF A KEY BOX OR OTHER ACCEPTABLE MEANS FOR IMMEDIATE ACCESS BY EMERGENCY EQUIPMENT MAY BE REQUIRED.

FIRE011 - ADDRESSES FOR BUILDINGS

ALL BUILDINGS SHALL BE ISSUED AN ADDRESS IN ACCORDANCE WITH MONTEREY COUNTY ORDINANCE NO. 1241. EACH OCCUPANCY, EXCEPT ACCESSORY BUILDINGS, SHALL HAVE ITS OWN PERMANENTLY POSTED ADDRESS. WHEN MULTIPLE OCCUPANCIES EXIST WITHIN A SINGLE BUILDING, EACH INDIVIDUAL OCCUPANCY SHALL BE SEPARATELY IDENTIFIED BY ITS OWN ADDRESS. LETTERS, NUMBERS AND SYMBOLS FOR ADDRESSES SHALL BE A MINIMUM OF 4-INCH HEIGHT, 1/2-INCH STROKE, CONTRASTING WITH THE BACKGROUND COLOR OF THE SIGN, AND SHALL BE ARABIC. THE SIGN AND NUMBERS SHALL BE REFLECTIVE AND MADE OF A NONCOMBUSTIBLE MATERIAL. ADDRESS SIGNS SHALL BE PLACED AT EACH DRIVEWAY ENTRANCE AND AT EACH DRIVEWAY SPLIT. ADDRESS SIGNS SHALL BE VISIBLE AND LEGIBLE FROM BOTH DIRECTIONS OF TRAVEL ALONG THE ROAD. IN ALL CASES, THE ADDRESS SHALL BE POSTED AT THE BEGINNING OF CONSTRUCTION AND SHALL BE MAINTAINED THEREAFTER. ADDRESS SIGNS ALONG ONE-WAY ROADS SHALL BE VISIBLE FROM BOTH DIRECTIONS OF TRAVEL. WHERE MULTIPLE ADDRESSES ARE REQUIRED AT A SINGLE DRIVEWAY, THEY SHALL BE MOUNTED ON A SINGLE SIGN. WHERE A ROADWAY PROVIDES ACCESS SOLELY TO A SINGLE COMMERCIAL OCCUPANCY, THE ADDRESS SIGN SHALL BE PLACED AT THE NEAREST ROAD INTERSECTION PROVIDING ACCESS TO THAT SITE. PERMANENT ADDRESS NUMBERS SHALL BE POSTED PRIOR TO REQUESTING FINAL CLEARANCE.

FIRE017 - DISPOSAL OF VEGETATION AND FUELS

DISPOSAL, INCLUDING CHIPPING, BURYING, OR REMOVAL TO A LANDFILL SITE APPROVED BY THE LOCAL JURISDICTION, OF VEGETATION AND DEBRIS CAUSED BY SITE DEVELOPMENT AND CONSTRUCTION, ROAD AND DRIVEWAY CONSTRUCTION, AND FUEL MODIFICATION SHALL BE COMPLETED PRIOR TO FINAL CLEARANCE OF THE RELATED PERMIT.

FIRE019 – DEFENSIBLE SPACE REQUIREMENTS – (STANDARD)

REMOVE COMBUSTIBLE VEGETATION FROM WITHIN A MINIMUM OF 30 FEET OF STRUCTURES. LIMB TREES 6 FEET UP FROM GROUND. REMOVE LIMBS WITHIN 10 FEET OF CHIMNEYS. ADDITIONAL AND/OR ALTERNATE FIRE PROTECTION OR FIREBREAKS APPROVED BY THE FIRE AUTHORITY MAY BE REQUIRED TO PROVIDE REASONABLE FIRE SAFETY. ENVIRONMENTALLY SENSITIVE AREAS MAY REQUIRE ALTERNATIVE FIRE PROTECTION, TO BE DETERMINED BY REVIEWING AUTHORITY AND THE DIRECTOR OF PLANNING AND BUILDING INSPECTION.

FIRE021 - FIRE PROTECTION EQUIPMENT & SYSTEMS - FIRE SPRINKLER SYSTEM (STANDARD) THE BUILDING(S) AND ATTACHED GARAGE(S) SHALL BE FULLY PROTECTED WITH AUTOMATIC FIRE SPRINKLER SYSTEM(S). INSTALLATION SHALL BE IN ACCORDANCE WITH THE APPLICABLE NFPA STANDARD. A MINIMUM OF FOUR (4) SETS OF PLANS FOR FIRE SPRINKLER SYSTEMS MUST BE SUBMITTED BY A CALIFORNIA LICENSED C-16 CONTRACTOR AND APPROVED PRIOR TO INSTALLATION. THIS REQUIREMENT IS NOT INTENDED TO DELAY ISSUANCE OF A BUILDING PERMIT. A ROUGH SPRINKLER INSPECTION MUST BE SCHEDULED BY THE INSTALLING CONTRACTOR AND COMPLETED PRIOR TO REQUESTING A FRAMING INSPECTION.

FIRE024 - FIRE ALARM SYSTEM - (SINGLE FAMILY DWELLING)

THE RESIDENCE SHALL BE FULLY PROTECTED WITH AN APPROVED HOUSEHOLD FIRE WARNING SYSTEM AS DEFINED BY NFPA STANDARD 72. PLANS AND SPECIFICATIONS FOR THE HOUSEHOLD FIRE WARNING SYSTEM SHALL BE SUBMITTED BY A CALIFORNIA LICENSED C-10 CONTRACTOR AND APPROVED PRIOR TO INSTALLATION. HOUSEHOLD FIRE WARNING SYSTEMS INSTALLED IN LIEU OF SINGLE-STATION SMOKE ALARMS REQUIRED BY THE UNIFORM BUILDING CODE SHALL BE REQUIRED TO BE PLACARDED AS PERMANENT BUILDING EQUIPMENT.

FIRE025 – SMOKE ALARMS – (SINGLE FAMILY DWELLING)

WHERE A HOUSEHOLD FIRE WARNING SYSTEM OR COMBINATION FIRE/BURGLAR ALARM SYSTEM IS INSTALLED IN LIEU OF SINGLE-STATION SMOKE ALARMS REQUIRED BY THE UNIFORM BUILDING CODE THE ALARM PANEL SHALL BE REQUIRED TO BE PLACARDED AS PERMANENT BUILDING EQUIPMENT.

FIRE029 - ROOF CONSTRUCTION - (CYPRESS FPD & PEBBLE BEACH CSD)

ALL NEW STRUCTURES, AND ALL EXISTING STRUCTURES RECEIVING NEW ROOFING OVER 25 PERCENT OR MORE OF THE EXISTING ROOF SURFACE WITHIN A ONE-YEAR PERIOD, SHALL REQUIRE A MINIMUM OF ICBO CLASS A ROOF CONSTRUCTION.



PROPOSED SITE PLAN



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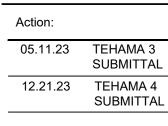
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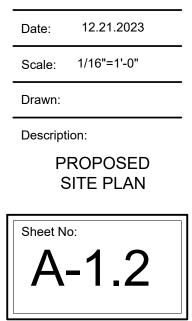



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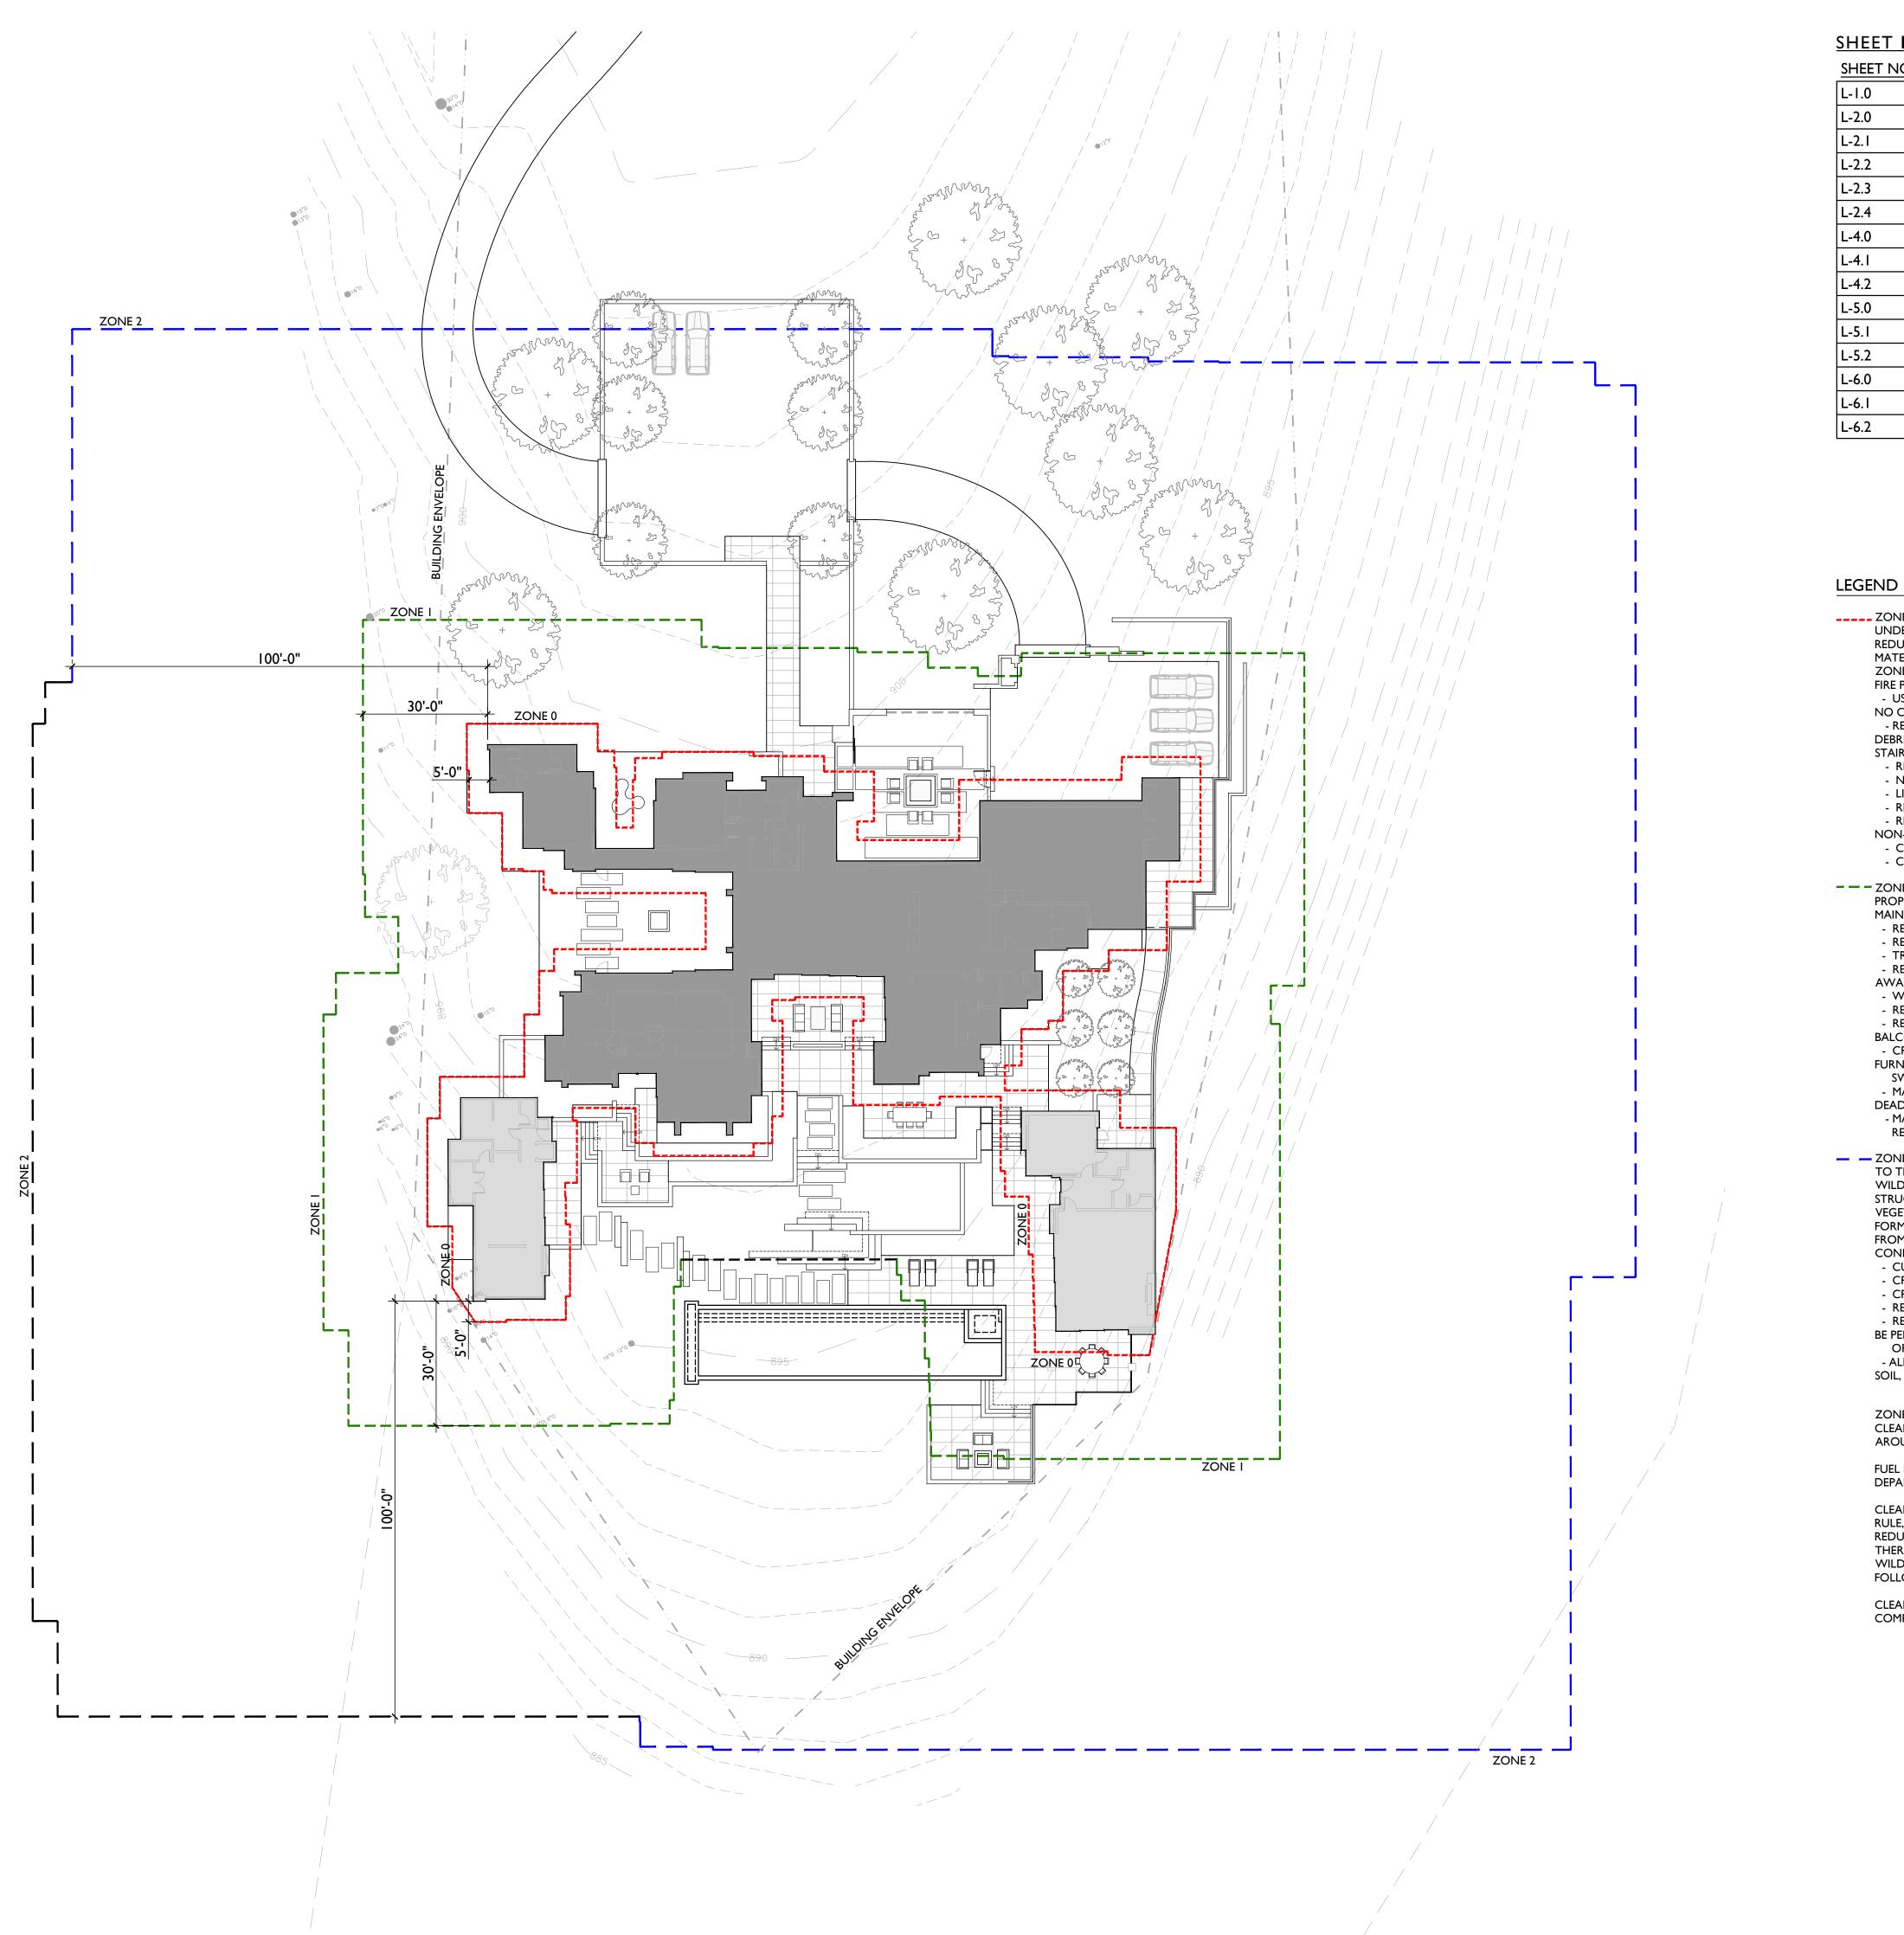
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SUBMITTAL SUBMITTAL







SHEET INDEX
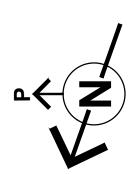
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SITE PLAN
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PLANTING NOTES
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IRRIGATION NOTES
IRRIGATION PLAN
IRRIGATION PLAN
SITE LIGHTING PLAN
SITE LIGHTING PLAN
SITE LIGHTING SPECS

- ZONE 0: ZONE EXTENDS 5' FROM BUILDINGS, STRUCTURES DECKS, ETC. THIS ZONE INCLUDES THE AREA UNDER AND AROUND ALL ATTACHED DECKS, AND REQUIRES THE MOST STRINGENT WILDFIRE FUEL REDUCTION. THE EMBER-RESISTANT ZONE IS DESIGNED TO KEEP FIRE OR EMBERS FROM IGNITING MATERIALS THAT CAN SPREAD THE FIRE TO YOUR HOME. THE FOLLOWING PROVIDES GUIDANCE FOR THIS ZONE, WHICH MAY CHANGE BASED ON THE REGULATION DEVELOPED BY THE BOARD OF FORESTRY AND FIRE PROTECTION.
 - USE HARDSCAPE LIKE GRAVEL, PAVERS, CONCRETE, AND OTHER NONCOMBUSTIBLE MULCH MATERIALS. NO COMBUSTIBLE BARK OR MULCH. - REMOVE ALL DEAD AND DYING WEEDS, GRASS, PLANT, SHRUBS, TREES, BRANCHES AND VEGETATIVE
 - DEBRIS (LEAVES, NEEDLES, CONES, BARK, ETC.); CHECK YOUR ROOFS, GUTTERS, DECKS, PORCHES, STAIRWAYS, ETC.
 - REMOVE ALL BRANCHES WITHIN 10 FEET OF ANY CHIMNEY OR STOVEPIPE OUTLET.
 - NO PLANTS SHALL BE PLANTED IN THIS ZONE - LIMIT COMBUSTIBLE ITEMS (OUTDOOR FURNITURE, PLANTERS, ETC.) ON TOP OF ROOF DECKS. - RELOCATE FIREWOOD AND LUMBER TO ZONE 2
 - REPLACE COMBUSTIBLE FENCING, GATES AND ARBORS ATTACH TO THE HOME WITH NON-COMBUSTIBLE ALTERNATIVES.
 - CONSIDER RELOCATING GARBAGE AND RECYCLING CONTAINERS OUTSIDE THIS ZONE. - CONSIDER RELOCATING BOATS, RVS, VEHICLES AND OTHER COMBUSTIBLE ITEMS OUTSIDE THIS ZONE.
- ----ZONE I: ZONE EXTENDS 30 FEET FROM ALL SIDES OF BUILDINGS, STRUCTURES, DECKS, ETC OR TO THE PROPERTY LINE, WHICHEVER IS CLOSER. WITHIN THIS ZONE, THE FOLLOWING CONDITIONS SHALL BE
 - MAINTAINED: - REMOVE ALL DEAD PLANTS, GRASS, AND WEEDS (VEGETATION)
 - REMOVE DEAD OR DRY LEAVES AND PINE NEEDLES FROM YARD, ROOF, AND RAIN GUTTERS.
 - TRIM TREES REGULARLY TO KEEP BRANCHES A MINIMUM OF 10 FEET FROM OTHER TREES. - REMOVE BRANCHES THAT HANG OVER ROOFS AND KEEP DEAD BRANCHES A MINIMUM OF 10 FEET
 - AWAY FROM CHIMNEYS AND STOVEPIPES.
 - WOOD PILES ARE PROHIBITED WITHIN THIS ZONE. RELOCATE WOOD PILES TO ZONE 2.
 - REMOVE OR PRUNE FLAMMABLE PLANTS AND SHRUBS NEAR WINDOWS. REMOVE OR PRUNE FLAMMABLE ITEMS THAT COULD CATCH FIRE FROM AROUND AND UNDER DECKS,
 - BALCONIES, AND STAIRS. - CREATE A SEPARATION BETWEEN TREES, SHRUBS, AND ITEMS THAT COULD CATCH FIRE, SUCH AS PATIO FURNITURE, WOOD PILES,
 - SWING SETS, ETC.
 - MAINTAIN A TREE, SHRUB OR OTHER PLANT ADJACENT TO OR OVERHANGING A BUILDING FREE OF DEAD OR DYING WOOD.
 - MAINTAIN THE ROOF OF A STRUCTURE FREE OF LEAVES, NEEDLES OR OTHER VEGETATIVE MATERIALS. REMOVE OR PRUNE FLAMMABLE PLANTS AND SHRUBS NEAR WINDOWS

- ZONE 2: ZONE 2 EXTENDS FROM 30 FEET TO 100 FEET OUT FROM BUILDINGS, STRUCTURES, DECKS ETC. OR TO THE PROPERTY LINE WHICHEVER IS CLOSER. FUELS SHALL BE MAINTAINED IN A CONDITION SO THAT A WILDFIRE BURNING UNDER AVERAGE WEATHER CONDITIONS WOULD BE UNLIKELY TO IGNITE THE STRUCTURE. THE ITEMS STIPULATED BELOW DO NOT APPLY TO SINGLE SPECIMENS OF TREES OR OTHER VEGETATION THAT ARE WELL-PRUNED AND MAINTAINED SO AS TO EFFECTIVELY MANAGE FUELS AND NOT FORM A MEANS OF RAPIDLY TRANSMITTING FIRE FROM OTHER NEARBY VEGETATION TO A STRUCTURE OR FROM A STRUCTURE TO THE OTHER NEARBY VEGETATION. WITHIN THIS ZONE, THE FOLLOWING CONDITIONS SHALL BE MAINTAINED:

- CUT OR MOW ANNUAL GRASS DOWN TO A MAXIMUM HEIGHT OF 4 INCHES.
- CREATE HORIZONTAL SPACING BETWEEN SHRUBS AND TREES.
- CREATE VERTICAL SPACING BETWEEN GRASS, SHRUBS, AND TREES.
- REMOVE ALL DEAD TREES.
- REMOVE FALLEN LEAVES, NEEDLES, TWIGS, BARK, CONES AND SMALL BRANCHES. HOWEVER, THEY MAY BE PERMITTED TO A DEPTH
- OF 3 INCHES. - ALL EXPOSED WOOD PILES MUST HAVE A MINIMUM OF 10 FEET OF CLEARANCE, DOWN TO BARE MINERAL SOIL, IN ALL DIRECTIONS.

ZONE I AND 2 - 'OUTBUILDINGS' AND LIQUID PROPANE GAS (LPG) STORAGE TANKS SHALL HAVE 10 FEET OF CLEARANCE TO BARE MINERAL SOIL AND NO FLAMMABLE VEGETATION FOR AN ADDITIONAL 10 FEET AROUND THEIR EXTERIOR.

FUEL MANAGEMENT TO FOLLOW PUBLIC RESOURCE CODE 4291 AS DEVELOPED BY CALIFORNIA'S DEPARTMENT OF FORESTRY AND FIRE PROTECTION (CALFIRE).

CLEARING BEYOND THE PROPERTY LINE MAY ONLY BE REQUIRED IF THE STATE LAW, LOCAL ORDINANCE, RULE, OR REGULATION INCLUDES FINDINGS THAT THE CLEARING IS NECESSARY TO SIGNIFICANTLY REDUCE THE RISK OF TRANSMISSION OF FLAME OR HEAT SUFFICIENT TO IGNITE THE STRUCTURE AND THERE IS NO FEASIBLE MITIGATION MEASURES POSSIBLE TO REDUCE THE RISK OF IGNITION OR SPREAD OF WILDFIRE TO THE STRUCTURE. CLEARANCE ON THE ADJACENT PROPERTY SHALL ONLY BE CONDUCTED FOLLOWING WRITTEN ON CONSENT BY THE ADJACENT LANDOWNER.

CLEARING BEYOND THE BUILDING ENVELOPE IS TO BE COORDINATED WITH THE TEHAMA ROAD COMPANY.

SEVEN SPRINGS STUDIO LANDSCAPE ARCHITECTS

2548 EMPIRE GRADE SANTA CRUZ, CA 95060 831.466.9617



PROJECT NAME:

PETERSON RESIDENCE

PROJECT ADDRESS:

LOT 84 TEHAMA 25600 VIA MALPASO CARMEL, CA 93923

APN: 259-092-023

ISSUANCE: TEHAMA STEP 4

PROJECT NO: 2022-11 DATE: 06/12/2024

REVISIONS:

DATE DESCRIPTION


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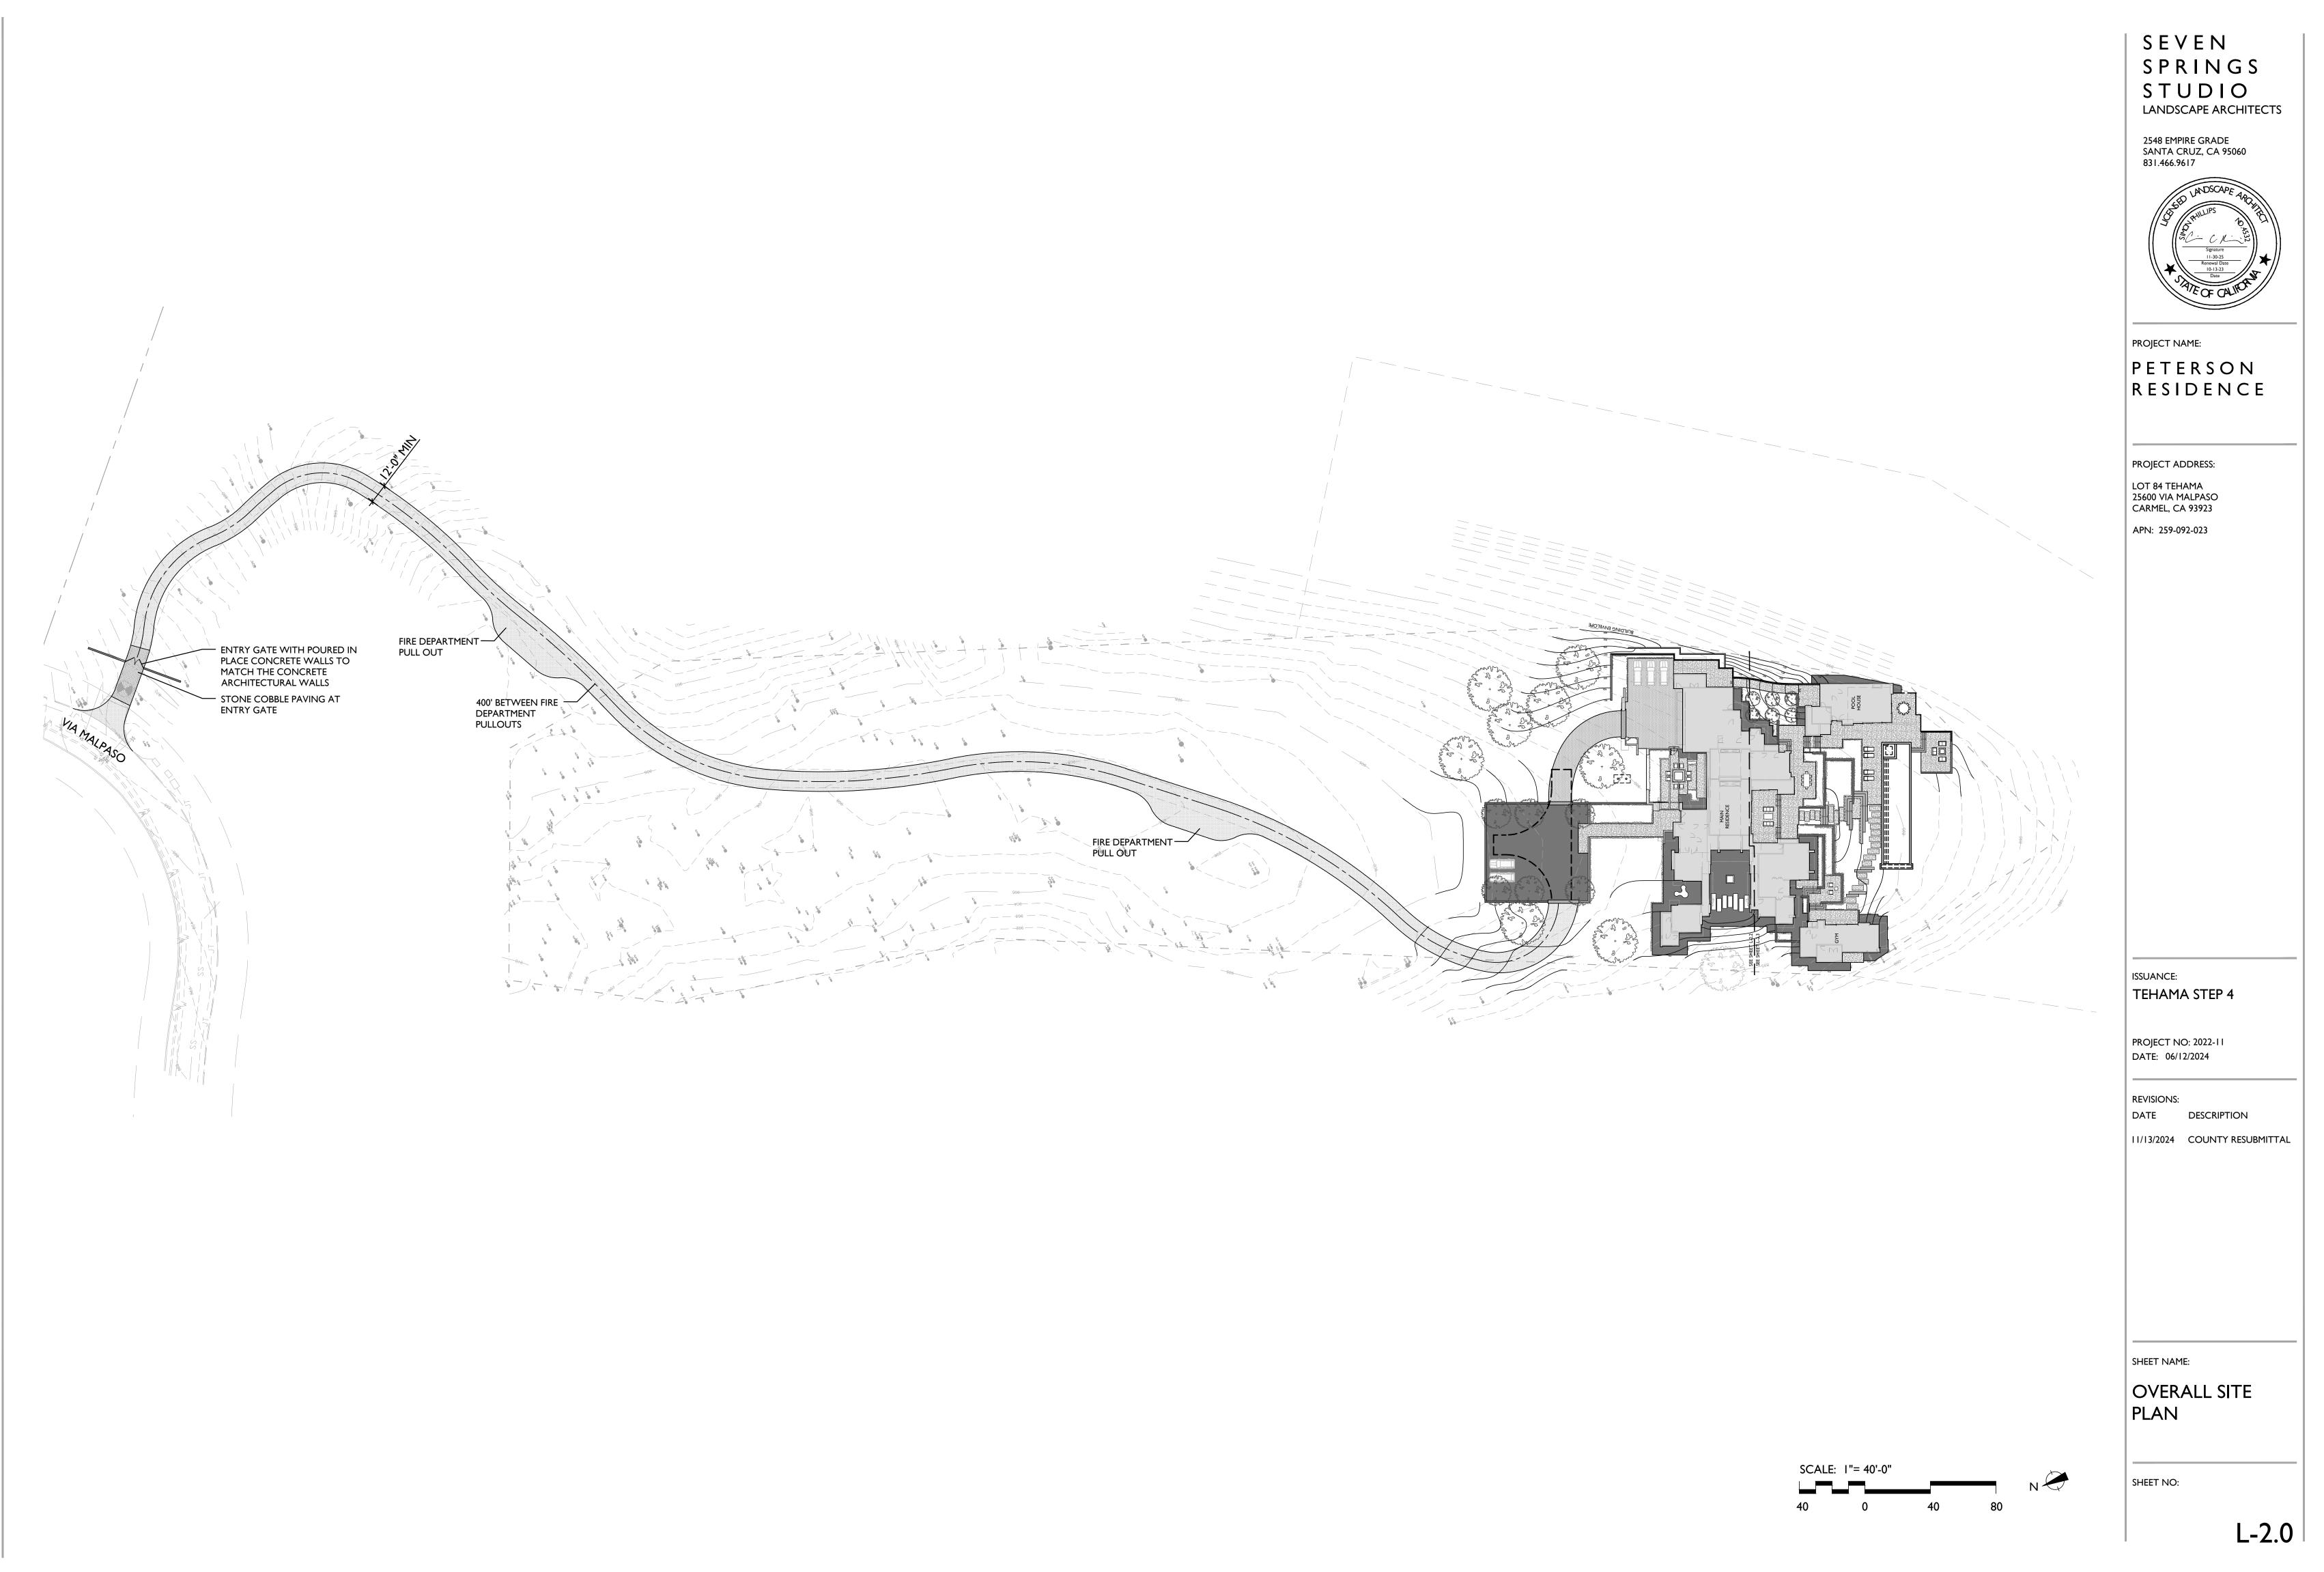
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FUEL


MANAGEMENT PLAN

SHEET NO:





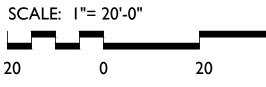

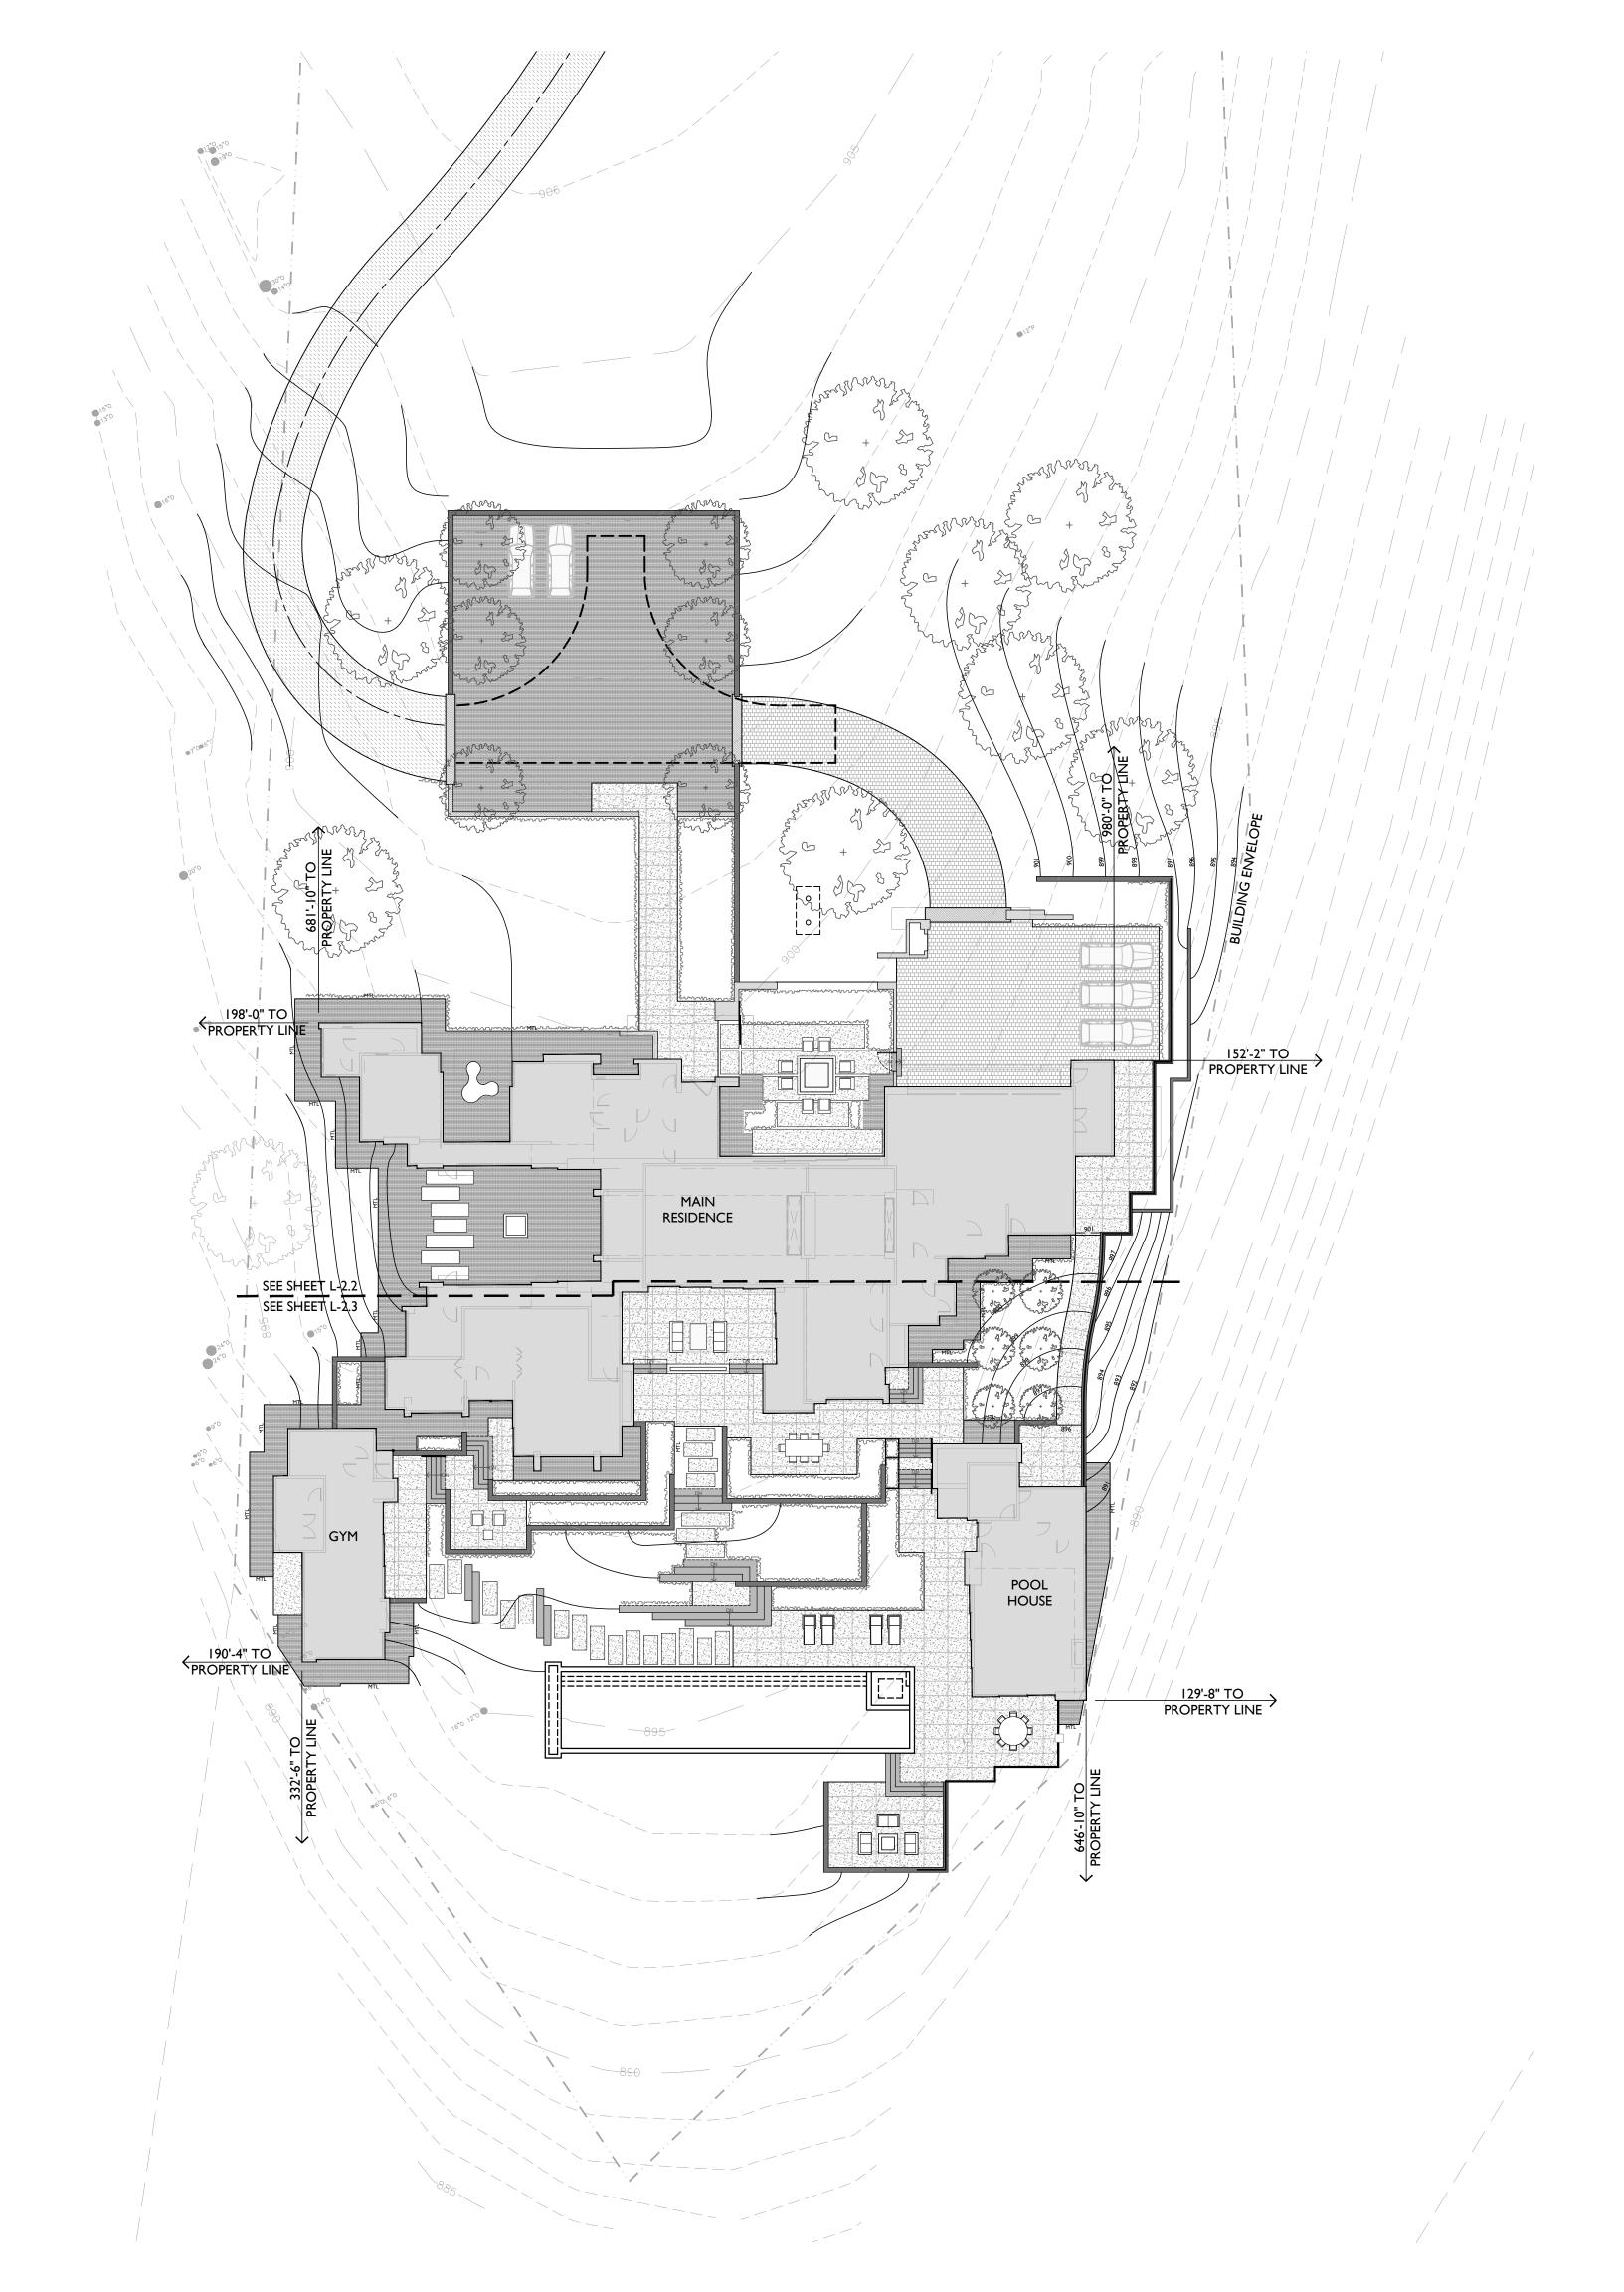

LEGEND

	STONE COBBLE: WET SET OVER 6" CONCRETE SUB-SLAB. SEE 6/L-2.4
	CONCRETE PAVING: INTEGRAL COLOR WITH LIGHT-SAND FINISH. 4" THICK WITH #4 AT 16" O.C. OVER 4" COMPACTED CLASS II BASE.
	ASPHALT DRIVE: 3" SECTION OVER 8" CLASS II BASE OVER COMPACTED SUBGRADE MINIMUM - SEE CIVIL DRAWINGS.
	CRUSHED GRAVEL: FOR VEHICLE AREAS - 3" OF 3/8" CRUSHED GRAVEL OVER 8" OF CLASS II BASE OVER COMPACTED SUBGRADE - FOR PEDESTRIAN AREAS - 3" OF ³ / ₈ " CRUSHED GRAVEL OVER FILTER FABRIC AND GOPHER WIRE OVER COMPACTED SUBGRADE.
	FLUSH CONCRETE BAND
	FLUSH CONCRETE BAND CONCRETE STEPS: COLOR AND FINISH TO MATCH CONCRETE PAVING.
	CONCRETE STEPS: COLOR AND FINISH TO MATCH
	CONCRETE STEPS: COLOR AND FINISH TO MATCH CONCRETE PAVING. CONCRETE STEPSTONES: COLOR AND FINISH TO
<u>م</u>	CONCRETE STEPS: COLOR AND FINISH TO MATCH CONCRETE PAVING. CONCRETE STEPSTONES: COLOR AND FINISH TO MATCH CONCRETE PAVING. BOARD-FORM CONCRETE WALL: BOARD FORMED WALL WITH INTEGRAL COLOR.

REFERENCE NOTES

	FIRE DEPARTMENT HAMMERHEAD TURN AROUND
2	GUEST PARKING
3	POSTLESS GLASS GUARDRAIL: SEE 5/L-2.4
4	POOL WITH AUTOMATIC POOL COVER
5	RECIRCULATING WATER FEATURE
6	POOL MECHANICAL ENCLOSURE
(7)	PROPOSED TREES TO SCREEN NEIGHBORING HOME
8	TOP OF WALL TO SLOPE WITH GRADE OF CONCRETE PATH
9	ORNAMENTAL GUARDRAIL: PAINTED METAL - SIM TO $(4/L-2.4)$
(0)	GAS FIREPIT I: WITH AUTOMATIC IGNITER
	GAS FIREPIT 2: WITH AUTOMATIC IGNITER
(12)	GAS FIREPIT 3: WITH AUTOMATIC IGNITER
(13)	UNDERGROUND SEPTIC TANK: FORCED MAIN TO STREET SEWER. SEE CIVIL DRAWINGS
(14)	SCULPTURE - TO BE DETERMINED
(15)	SLIDING GATE - WOOD WITH STEEL FRAME
(16)	PEDESTRIAN GATE: WOOD WITH STEEL FRAME


- (17) SPA IN POOL
- (18) POOL COVER TROUGH

TREE REMOVAL LIST

SPECIES	DBH
COAST LIVE OAK	6"
COAST LIVE OAK	8"
TOTAL	2


MITIGATION PLANTING TO BE 3:1 FOR A TOTAL OF 6 MITIGATION TREES REQUIRED - SEE PLANTING PLAN

20

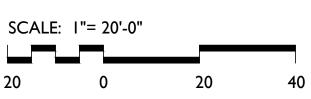



2548 EMPIRE GRADE SANTA CRUZ, CA 95060 831.466.9617

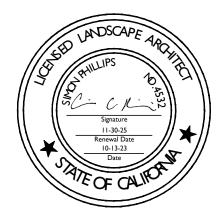

PROJECT NAME:

PETERSON RESIDENCE

PROJECT ADDRESS:

LOT 84 TEHAMA 25600 VIA MALPASO CARMEL, CA 93923

APN: 259-092-023

ISSUANCE:

TEHAMA STEP 4

PROJECT NO: 2022-11 DATE: 06/12/2024

REVISIONS: DATE DESCRIPTION

11/13/2024 COUNTY RESUBMITTAL


SHEET NAME:

SITE PLAN

SHEET NO:

Ν

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/ ,/	LEGEND		SEVEN
		ET SET OVER 6" CONCRETE	SPRINGS
	SUB-SLAB. SEE 6	<u>/L-2.4</u>)	STUDIO LANDSCAPE ARCHITECTS
	V VIII VIII VIII VIII VIII VIII VIII V	G: INTEGRAL COLOR WITH H. 4" THICK WITH #4 AT 16" O.C. TED CLASS II BASE.	2548 EMPIRE GRADE SANTA CRUZ, CA 95060
		SECTION OVER 8" CLASS II BASE SUBGRADE MINIMUM - SEE CIVIL	831.466.9617
	CRUSHED GRAVEL COMPACTED SUBG OF ³ / ₈ " CRUSHED GR	FOR VEHICLE AREAS - 3" OF 3/8" OVER 8" OF CLASS II BASE OVER RADE - FOR PEDESTRIAN AREAS - 3" AVEL OVER FILTER FABRIC AND R COMPACTED SUBGRADE.	Signature II-30-25 Renewal Date 10-13-23 N
	FLUSH CONCRETE	BAND	STATE OF OALIFORM
	CONCRETE STEPS: CONCRETE PAVING	COLOR AND FINISH TO MATCH G.	PROJECT NAME:
		ONES: COLOR AND FINISH TO E PAVING.	PETERSON
/	BOARD-FORM CON WALL WITH INTEG	NCRETE WALL: BOARD FORMED RAL COLOR.	RESIDENCE
	<u>MTL</u> METAL PLANTER EE MATCH BUILDING	OGE - PRIMED AND PAINTED TO TRIM	
	PLT PLANTING AREA: SI	EE PLANTING PLAN	PROJECT ADDRESS: LOT 84 TEHAMA 25600 VIA MALPASO CARMEL, CA 93923
	REFERENCE NOTES		APN: 259-092-023
	\bigcirc	MERHEAD TURN AROUND	
	 (2) GUEST PARKING (3) POSTLESS GLASS GUARE 	DRAIL: SEE $(5/L-2.4)$	
	(4) POOL WITH AUTOMAT		
-/	5 RECIRCULATING WATE		
/	6 POOL MECHANICAL EN	CLOSURE	
	$(\overline{7})$ proposed trees to so	CREEN NEIGHBORING HOME	
		E WITH GRADE OF CONCRETE	
	PATH ORNAMENTAL GUARDE	RAIL: PAINTED METAL -	
	SIM TO $(4/L-2.4)$ (10) GAS FIREPIT 1: WITH AL		
895	(10) GAS FIREPIT 1: WITH AL (11) GAS FIREPIT 2: WITH AL		
	(12) GAS FIREPIT 3: WITH AU		
	(13) UNDERGROUND SEPTIC	C TANK: FORCED MAIN TO STREET	
BUILDING ENVELOPE 897.00	SEWER. SEE CIVIL DRAW (14) SCULPTURE - TO BE DE		
LE C	(14) SCULPTORE - TO BE DE		
897.00 Ž	(16) PEDESTRIAN GATE: WO		
DING	(17) SPA IN POOL		
BUIL	(18) POOL COVER TROUGH		ISSUANCE:
	\bigcirc		TEHAMA STEP 4
	SPECIES	DBH	PROJECT NO: 2022-11 DATE: 06/12/2024
	COAST LIVE OAK COAST LIVE OAK	6" 8"	REVISIONS:
	TOTAL	2	DATE DESCRIPTION
/	MITIGATION PLANTING TO TOTAL OF 6 MITIGATION TE		
	REQUIRED - SEE PLANTING F	PLAN	
/ /			
/ /			
/ /			
/			
/ FG 893.00			SHEET NAME:
-TW 897.00			CONSTRUCTION
			PLAN

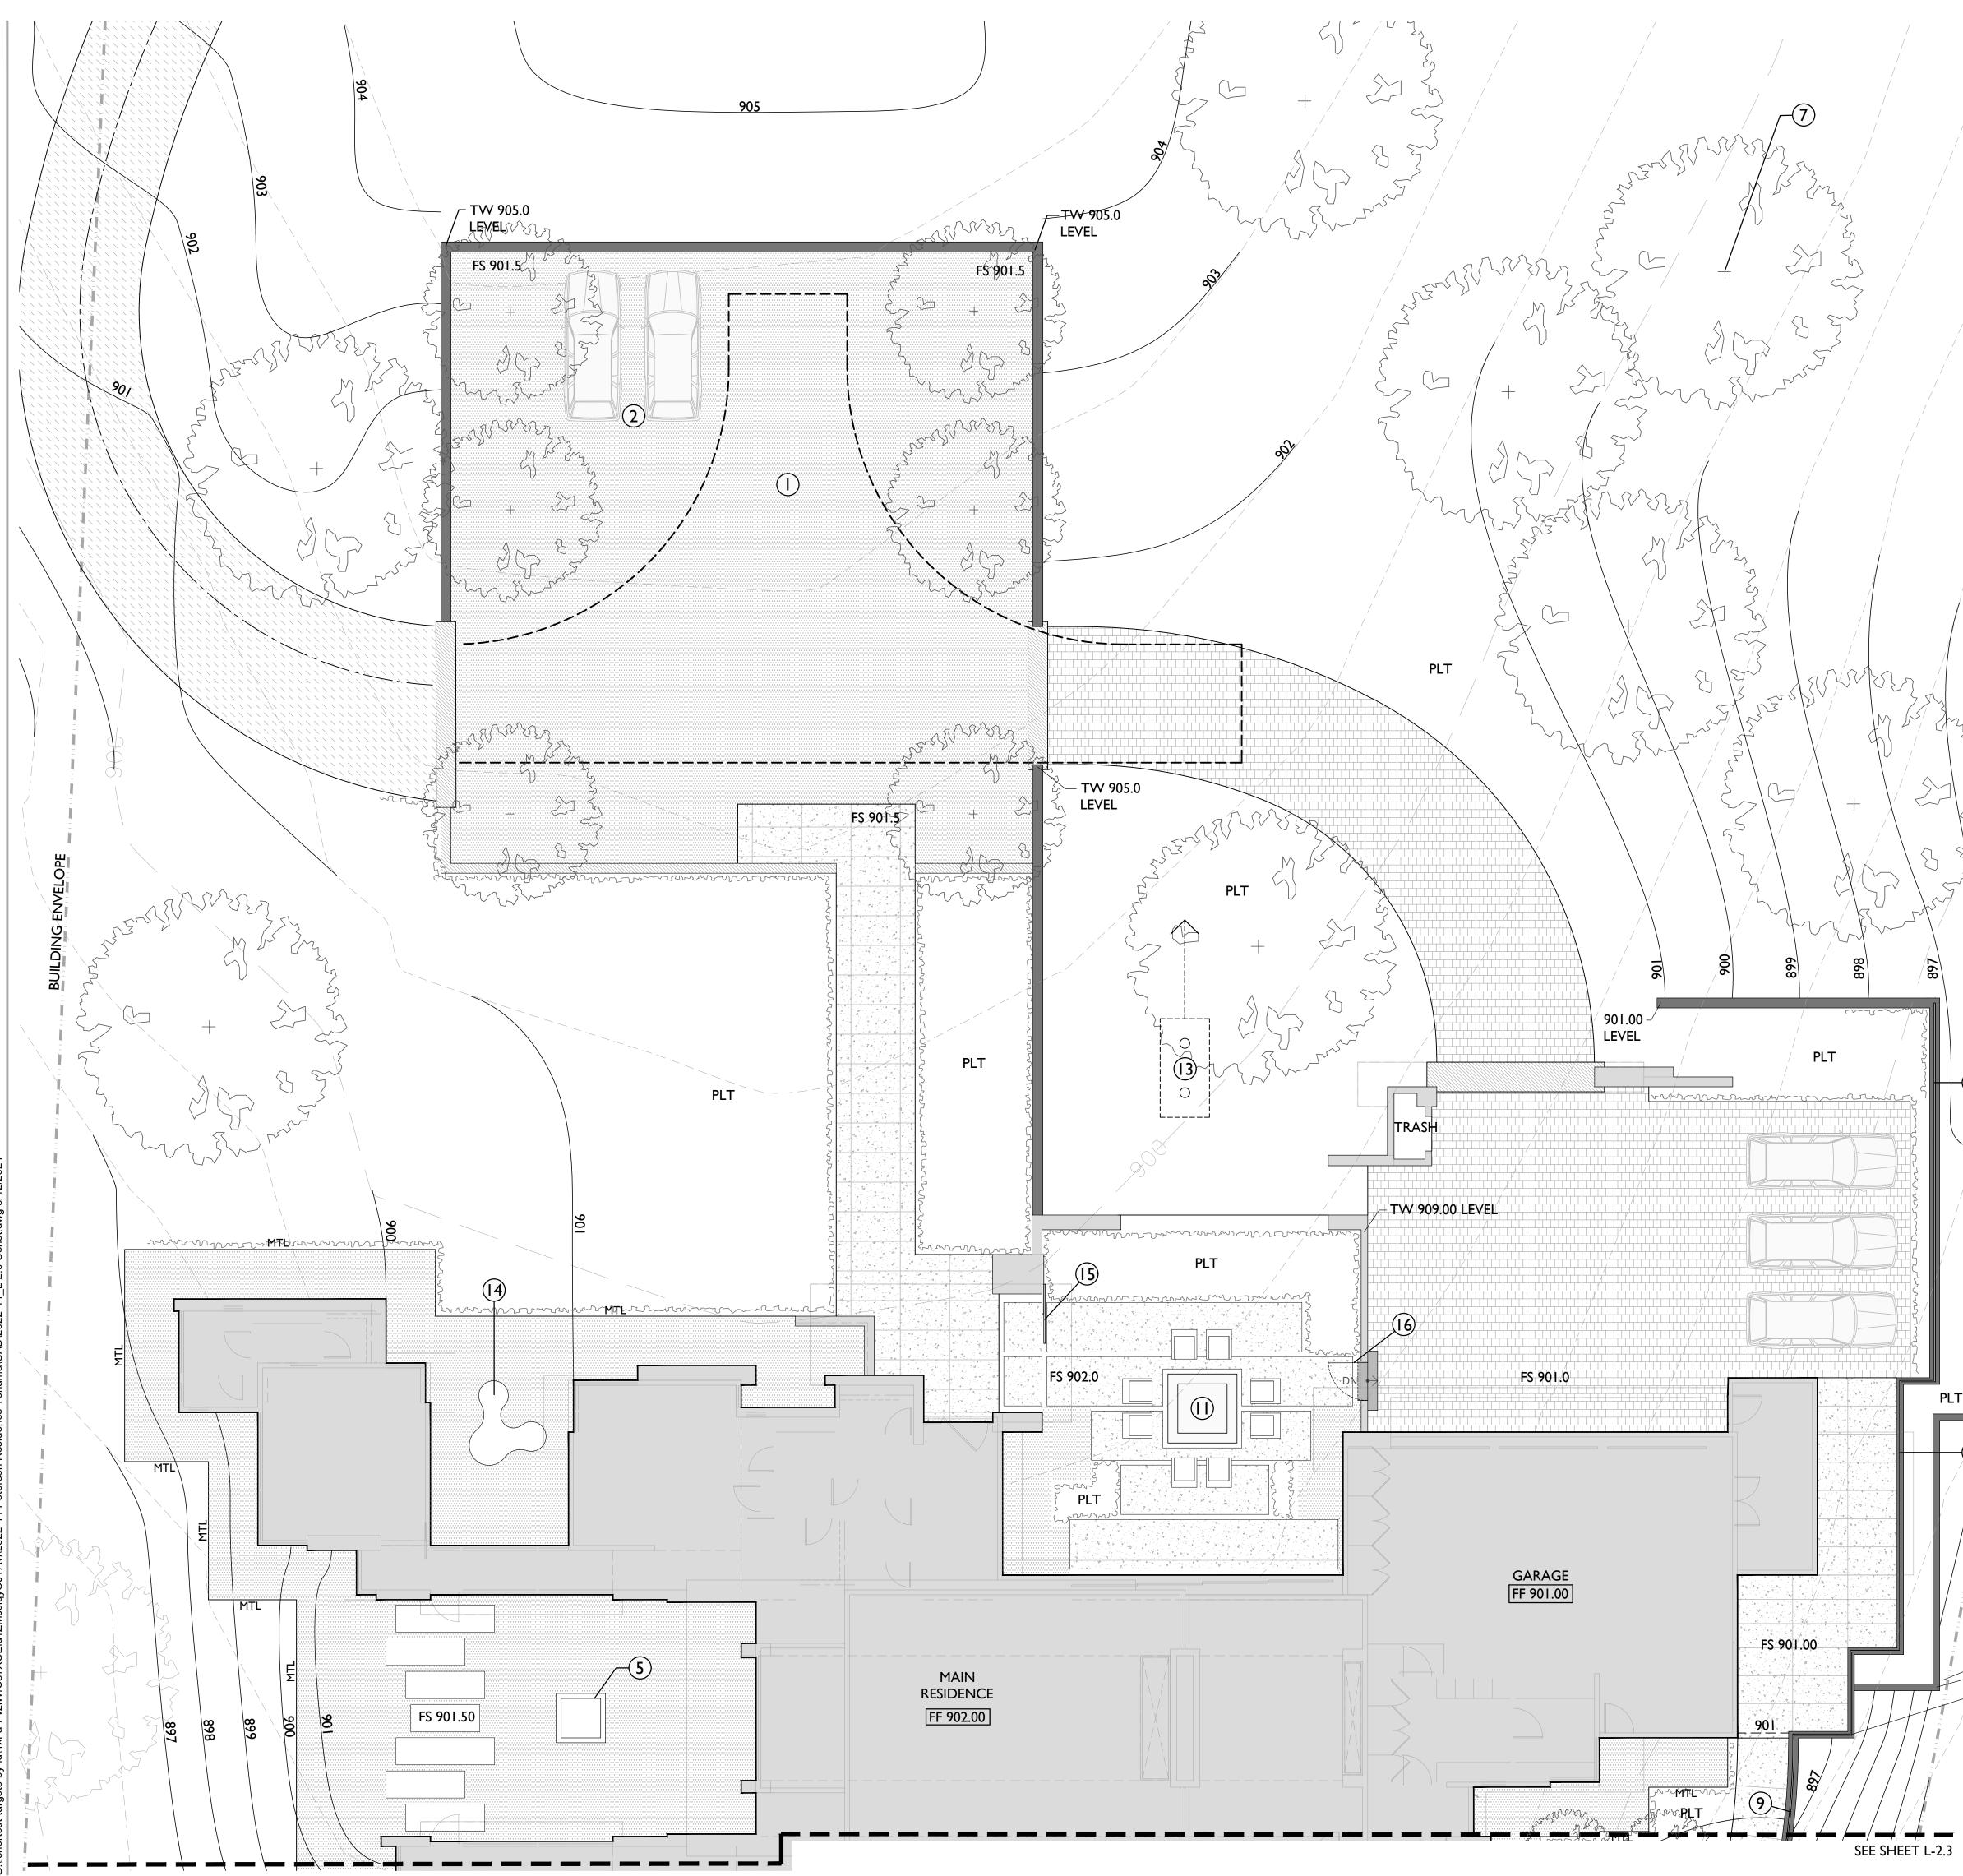
SCALE: 1/8"= 1'-0" 16




SHEET NO:

L-2.2

9) -TW 897.00

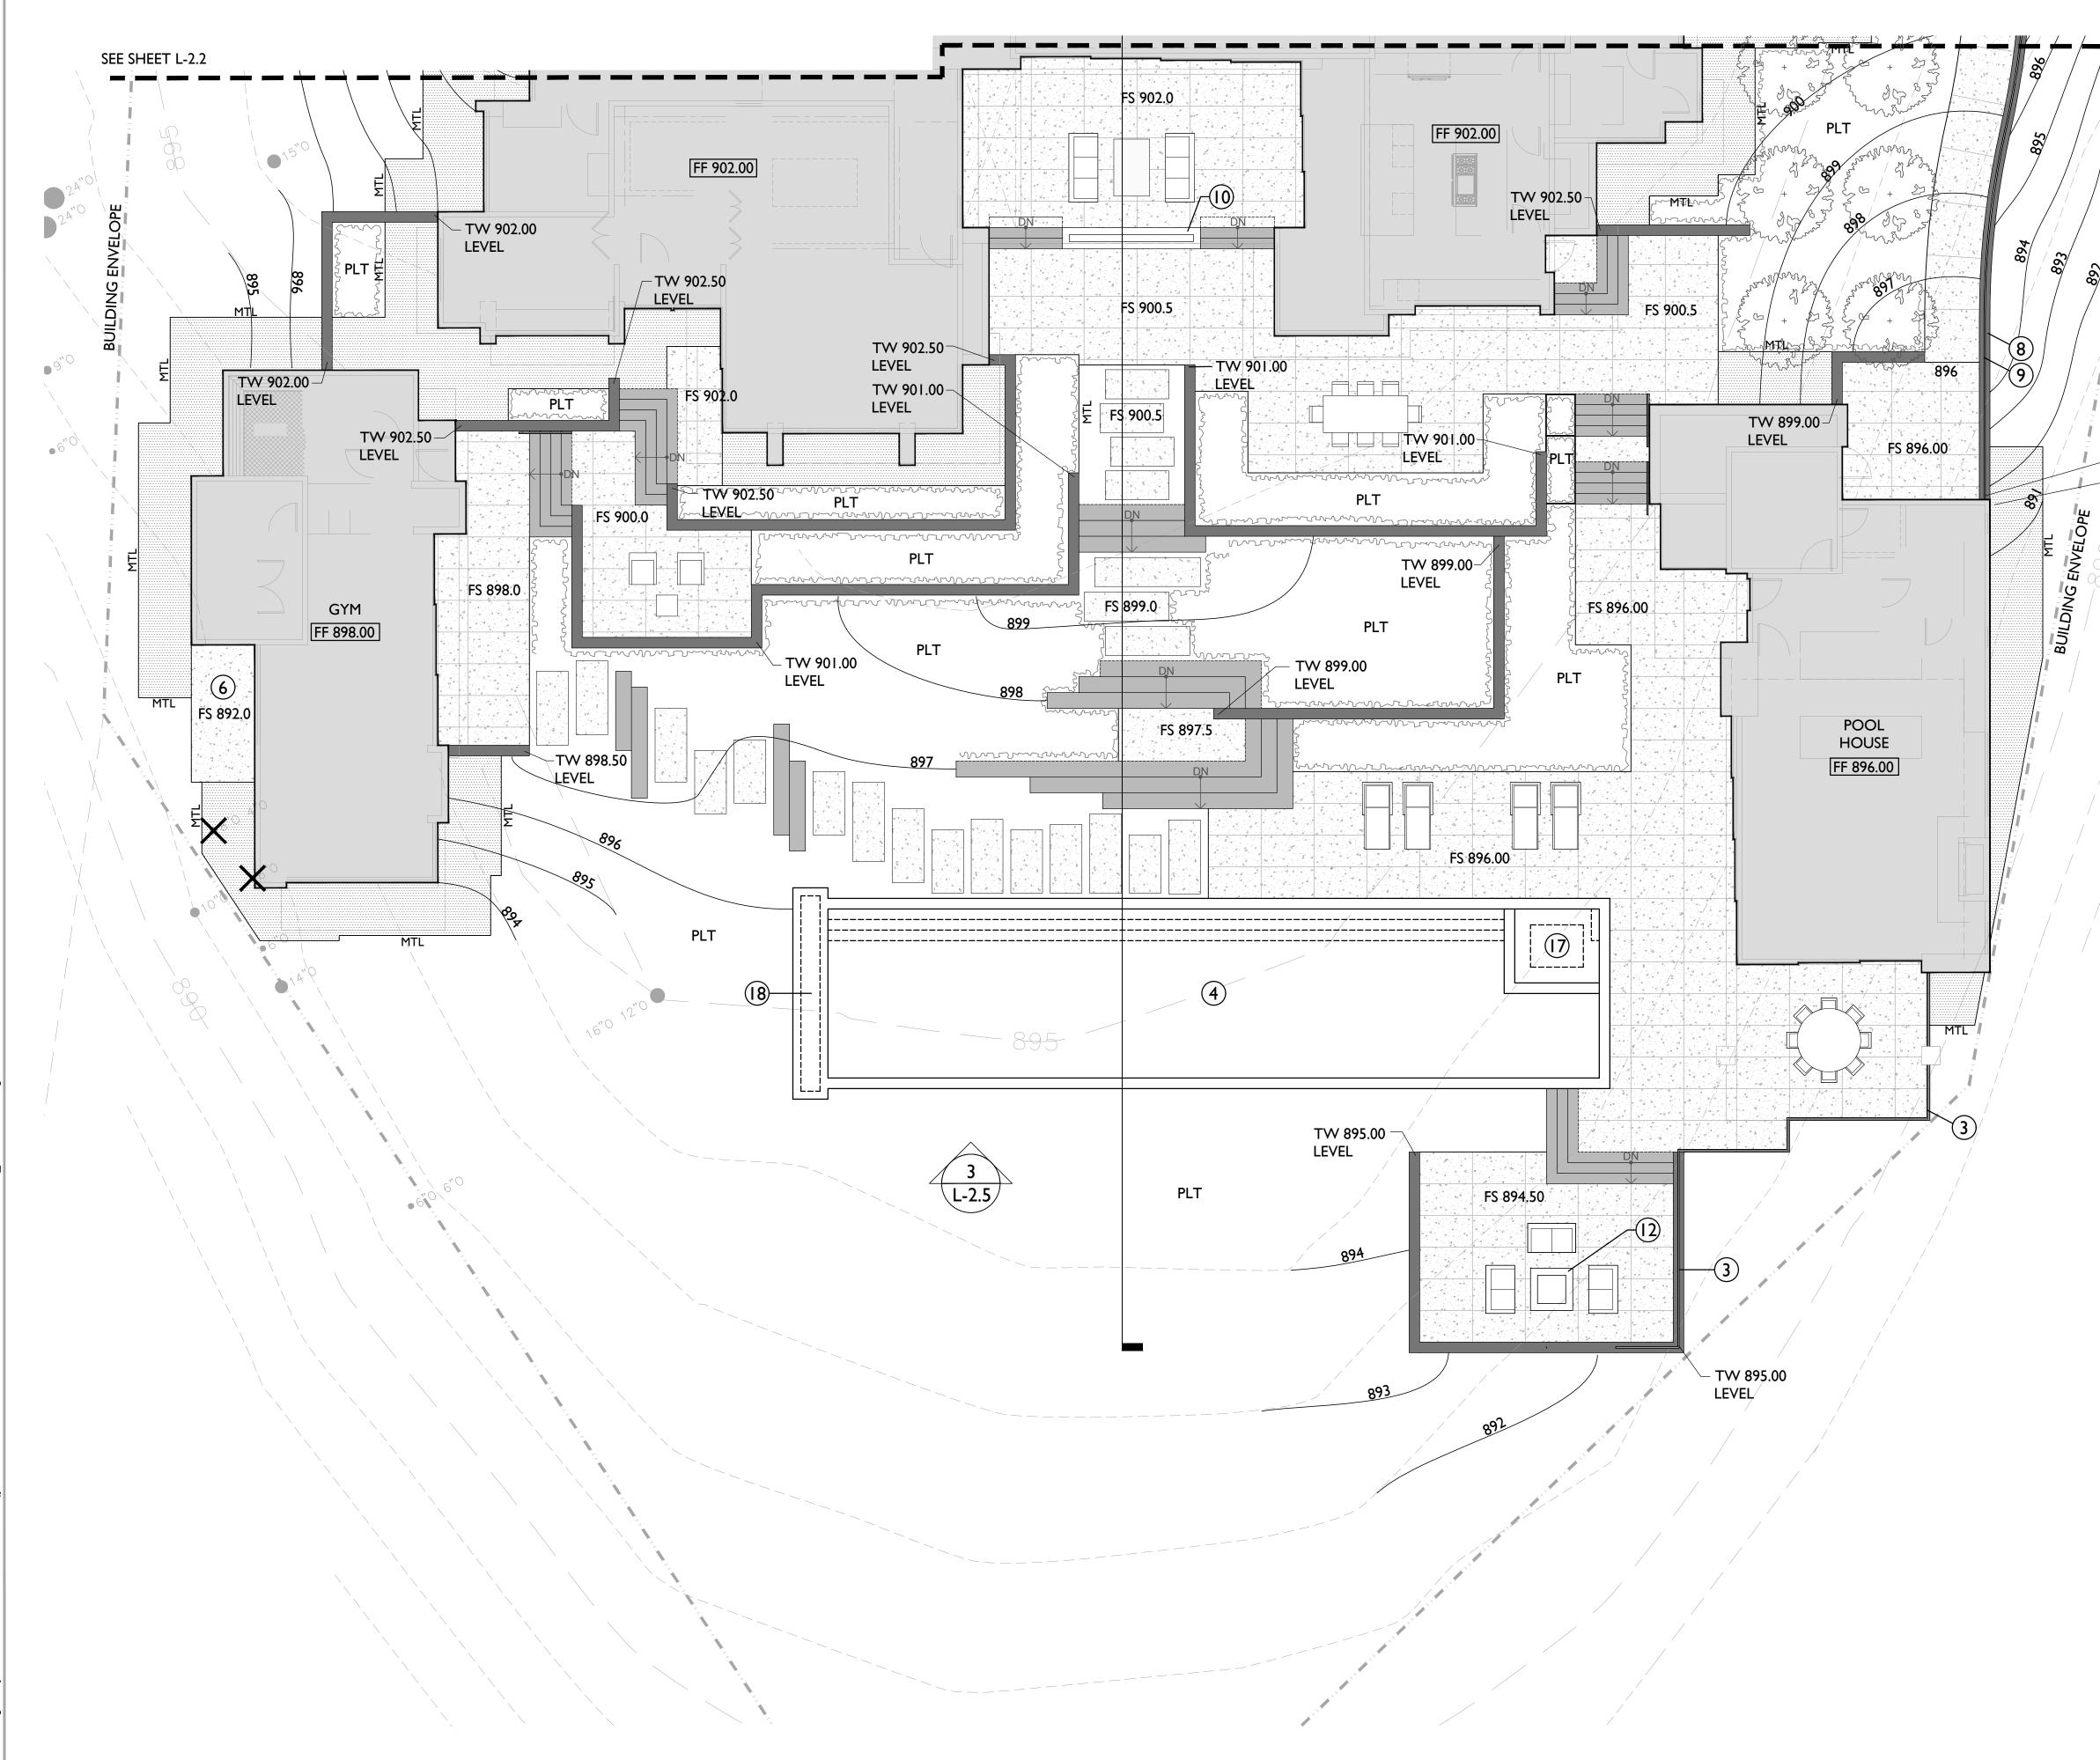

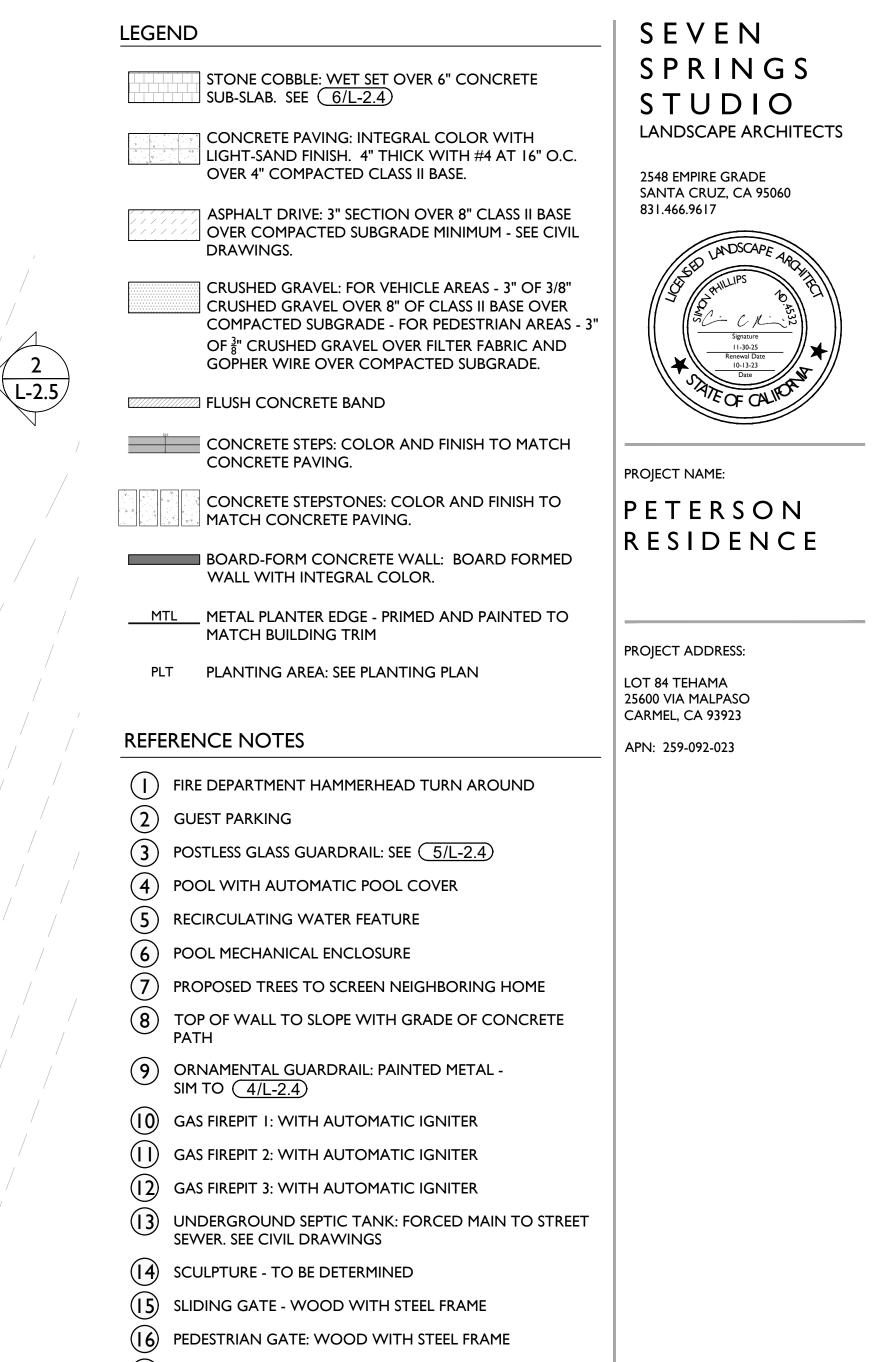

(17) SPA IN POOL

- TW/896.25


FG 892.50

(18) POOL COVER TROUGH

TREE REMOVAL LIST

SPECIES	DBH
COAST LIVE OAK	6"
COAST LIVE OAK	8"
TOTAL	2

MITIGATION PLANTING TO BE 3:1 FOR A TOTAL OF 6 MITIGATION TREES REQUIRED - SEE PLANTING PLAN

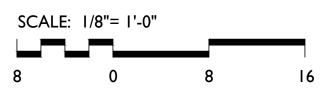

ISSUANCE:

TEHAMA STEP 4

PROJECT NO: 2022-11 DATE: 06/12/2024

REVISIONS:


DATE DESCRIPTION


11/13/2024 COUNTY RESUBMITTAL

SHEET NAME:

CONSTRUCTION PLAN

SHEET NO:

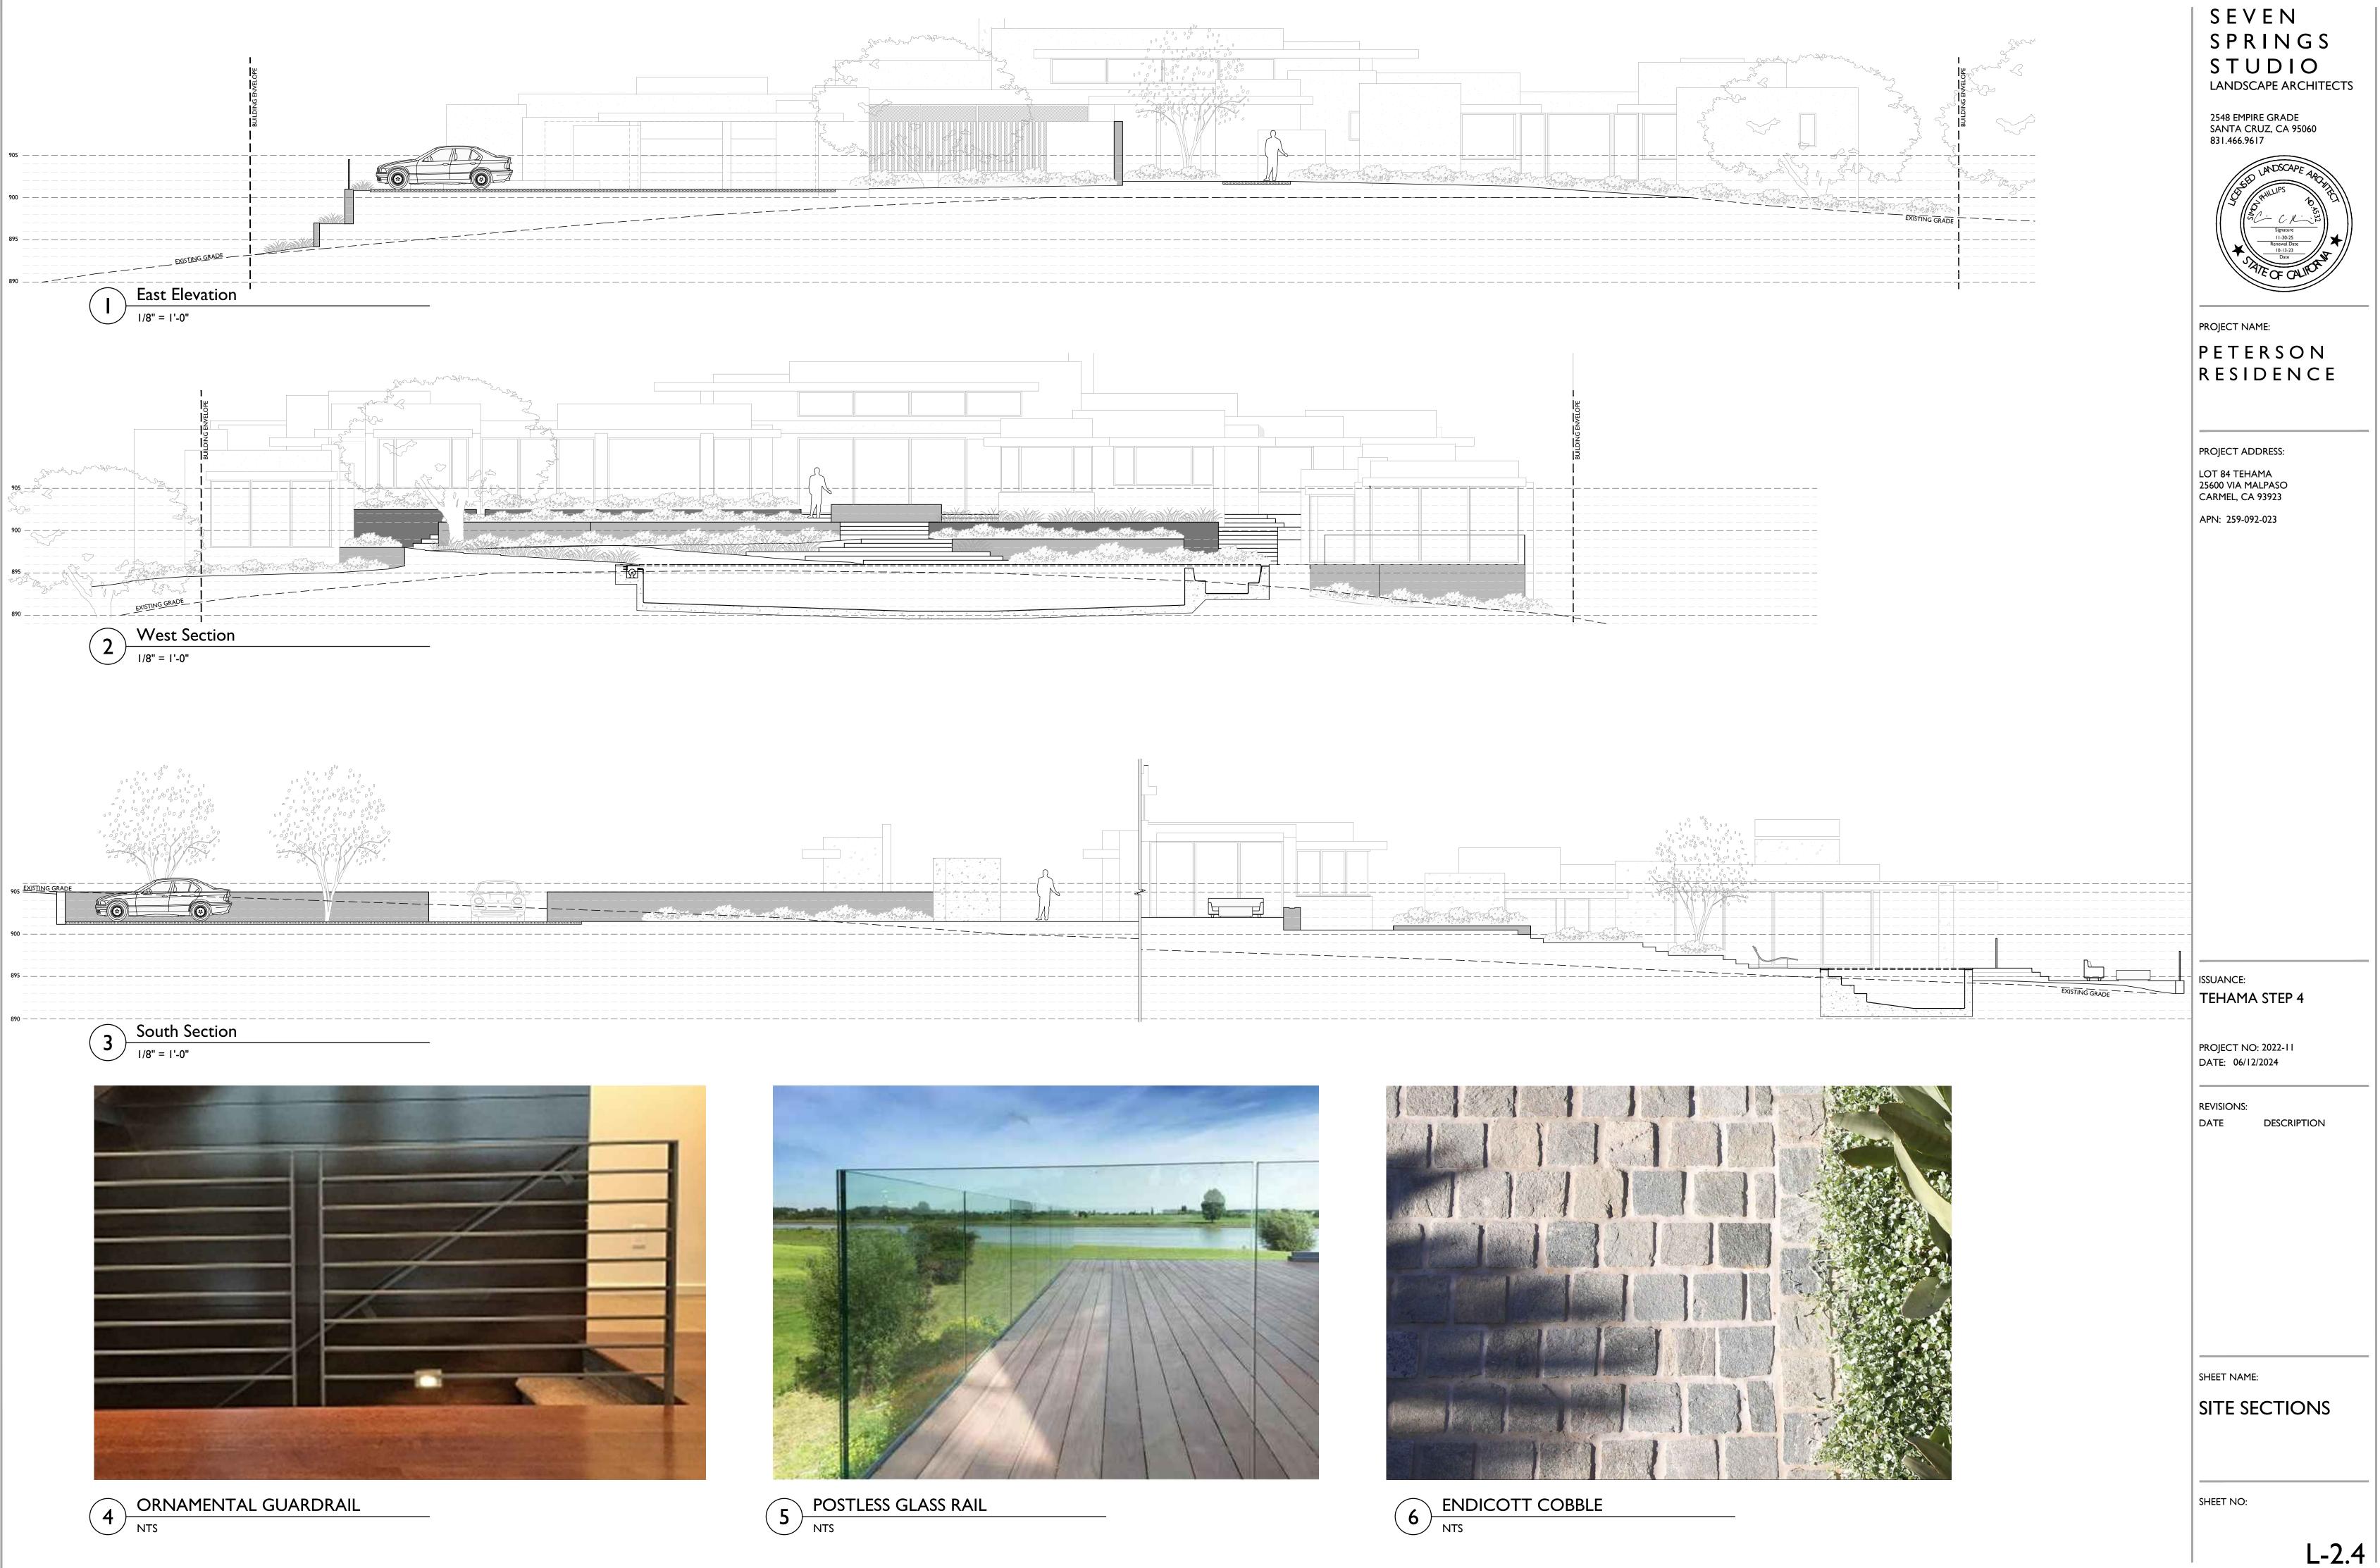

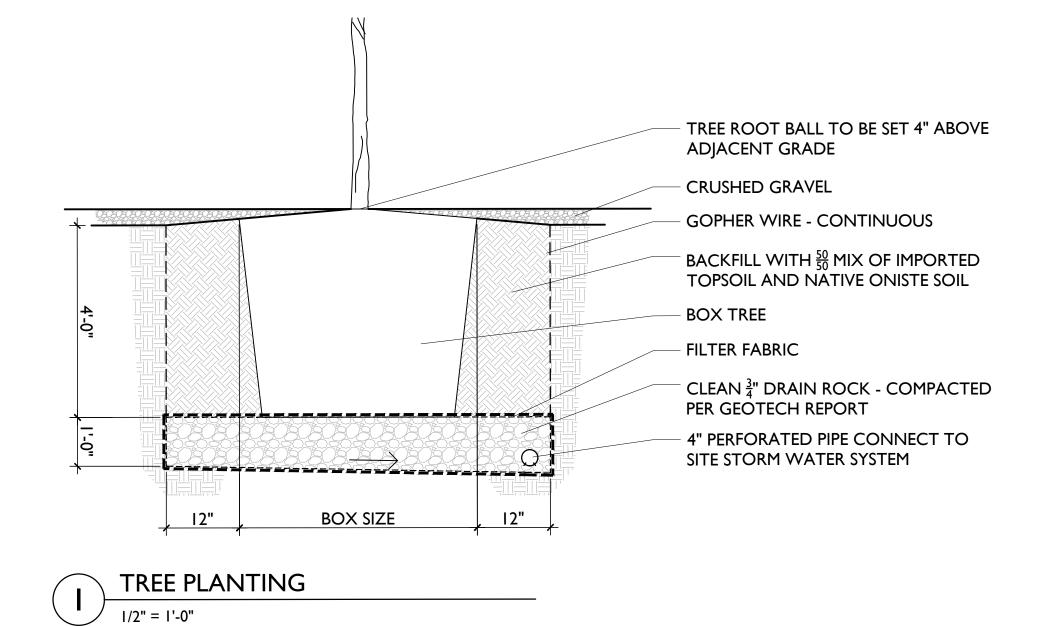

GENERAL NOTES

- I. ALL PLANTING AREAS TO BE TREATED WITH A PRE-EMERGENT HERBICIDE PRIOR TO BEGINNING PLANTING.
- 2. CONTRACTOR TO TAKE SAMPLES OF PLANTING AREA SOIL, FROM 0"-12" DEEP FROM AT LEAST THREE SEPARATE LOCATIONS FROM PLANTING AREAS ON THE SITE, MIXED TO FORM A SINGLE COMPOSITE SAMPLE. COMBINED VOLUME OF COMPOSITE SAMPLE SHALL BE AT LEAST I-QUART. SAMPLE LOCATIONS SHALL BE MARKED ON THE PLANTING PLAN AND SHALL BE REPRESENTATIVE
- OF SITE CONDITIONS AND PROPOSED PLANTING TYPES. 3. FORWARD THE COMPOSITE SAMPLES TO THE TESTING LABORATORY FOR TESTING AND THEIR RECOMMENDATIONS AS TO EXACT FERTILIZERS AND SOIL AMENDMENTS TO BE USED IN PLANTING, WAYPOINT ANALYTICAL A05-2 COMPLETE ANALYSIS. LAB REPORT TO INCLUDE RECOMMENDATION LETTER AND TESTING RESULTS.
 - LAB REPORT TO INCLUDE AN ESTIMATED INFILTRATION RATE FOR SOIL TESTED. LAB REPORT TO NOTE THE PROPOSED PLANTING TYPES SPECIFIC TO THE
- PROJECT, GROUND-COVERS, NATIVE GRASSES AND TREES. 4. AMENDMENT AND FERTILIZER RECOMMENDATIONS BY THE TESTING LAB SHALL BE SPECIFIC TO THE PROPOSED AMENDMENTS TO BE USED AND INCLUDE THE AMENDMENT LAB TEST / SAMPLE ID NUMBER AND TESTING DATE AS REFERENCE. GENERIC RECOMMENDATIONS WILL BE REJECTED AND WILL REQUIRE SPECIFIC RECOMMENDATIONS TO BE OBTAINED FROM THE TESTING LAB.
- 5. FOR BIDDING PURPOSES ASSUME SOIL AMENDMENT FERTILIZER TO BE COMMERCIAL FERTILIZER, 16-6-8 (N-P-K) UNIFORM PELLET, EXACT FERTILIZER TO BE DETERMINED BY TESTING LAB ANALYSIS.
- 6. INSTALL COMMERCIAL PLANT FERTILIZER PACKETS / TABLETS, TWO-YEAR CONTROLLED -RELEASE 20-10-05 (N-P-K). BEST TABS BY SIMPLOT PROFESSIONAL PRODUCTS, AGRIFORM BY THE SCOTTS COMPANY.
- 7. SOIL AMENDMENTS TO BE MINERALIZED AND NITRIFIED BARK OR SAWDUST, WITH WETTING AGENT AND PROPERLY PULVERIZED, CONTAINING A MINIMUM OF 270LBS. PER CUBIC YARD OF ORGANIC MATTER. SUBMIT SAMPLE ANALYSIS FOR APPROVAL.
- 8. AMENDMENT CHEMISTRY SUITABILITY CONSIDERATIONS
- I.NITROGEN (DRY WEIGHT BASIS): 0.4 TO 0.6%
- 2.IRON (MINIMUM): 0.08%
- 3.ORGANIC CONTENT: ABOVE 17% 4.CARBON-NITROGEN RATIO: BELOW 25

5.PH: BELOW 8.0


- 6.SALINITY (ECE): A VALUE SUCH THAT WHEN COMBINED WITH THE EXISTING SITE SOIL AT A USE RATE DETERMINED BY THE TESTING LAB ANALYSIS, THE SALINITY OF THE AMENDED SOIL SHALL NOT EXCEED 4.0 DS/M (MMHOS/CM).
- 9. GYPSUM (IF REQUIRED BY EXISTING SOILS TEST): AGRICULTURAL GRADE, OMRI LISTED. I. CAL-SUL PELLETIZED GYPSUM BY NORTH PACIFIC, PORTLAND OR 2. ULTRA FINE AG GYPSUM BY WESTERN MINING & MINERALS
 - 3. APPROVED EQUAL.
- 10. SULFUR (IF REQUIRED BY EXISTING SOILS TEST): GRANULAR DEGRADABLE SULFUR PRODUCT,
- TIGER 90CR ORGANIC 0-0-0-90 SULFUR BY TIGERSUL.COM, OR APPROVED EQUAL. 11. ALL PLANTING AREAS TO BE CULTIVATED TO A MINIMUM DEPTH OF 10". SOIL AMENDMENTS AND COMMERCIAL FERTILIZERS TO BE APPLIED AT THE RATES SPECIFIED IN THE TESTING LAB ANALYSIS.
- 12. CROSS-RIP OR CULTIVATE SUB-GRADE TO THE 10" MINIMUM DEPTH. ADD WATER IF NECESSARY AND CONTINUE RIPPING OR CULTIVATION UNTIL THE ENTIRE SPECIFIED DEPTH IS LOOSE AND FRIABLE, CROSS RIPING SHALL INCLUDE AREAS IN BETWEEN TREE AND PLANT PITS. UPON COMPLETION OF CROSS RIPPING APPLY THE AMENDMENTS AS SPECIFIED IN THE TESTING LAB ANALYSIS. SETTLE THE SOIL WITH WATER AS NEEDED AND REGRADE HIGH/LOW AREAS TO CREATE A SMOOTH FINISH GRADE.
- 13. UNIFORMLY SPREAD AND INCORPORATED THE MATERIALS TO OBTAIN A HOMOGENEOUSLY BLENDED SOIL, 6-INCHES IN DEPTH. IF GYPSUM AND/OR SULFUR ARE REQUIRED TO BE ADDED AS PART OF AMENDMENTS PER SOILS REPORT FROM THE TESTING LAB, MANUALLY WATER THE AMENDED SOILS USING IMPACT SPRINKLERS OR HOSE-END SPRINKLERS - TO APPLY 1/2-INCH OF WATER OVER ALL PLANTING AREAS. EXISTING SOILS WITH HIGH ALKALINITY AS DETERMINED BY THE SOILS REPORT FROM THE TESTING LAB WILL BE REQUIRED TO BE SIMILARLY MANUALLY WATERED TO LEACH THE SALTS DEEPER INTO THE SOIL, AMOUNT OF WATER TO BE DETERMINED BY THE TESTING LAB.
- 14. PRE-MIX AMENDMENTS INTO SOIL BEFORE BACKFILLING PLANT PITS DO NOT MIX INSIDE PITS. BREAK LARGE CLODS INTO SMALL PIECES. ALL PLANTING AREAS TO BE TREATED WITH A PRE-EMERGENT HERBICIDE PRIOR TO BEGINNING PLANTING.
- 15. INSTALL 3" MULCH TO ALL PLANTING AREAS. MULCH TO BE SHREDDED CEDAR BARK OR SIMILAR. SUBMIT A SAMPLE OF MULCH FOR OWNER & LANDSCAPE ARCHITECT APPROVAL PRIOR TO INSTALLATION.
- 16. COMPOST: COMPOST MINIMUM OF 4 CUBIC YARDS PER 1,000 SQ. FT. OF PERMEABLE AREA TILLED TO A DEPTH OF 6".
- 17. OLIVE TREES PLANTING PITS TO BE OVER EXCAVATED AND BACKFILLING WITH PLANTING SOIL MIX - SEE (1/L-4.0)
- 18. NO PLANTING WITHIN THE EMBER RESISTANT ZONE WITHIN 5' OF BUILDING OR STRUCTURES. USE OF HARDSCAPES LIKE CRUSHED GRAVEL, PAVERS, CONCRETE AND OTHER NONCOMBUSTIBLE MATERIALS ARE THE ONLY MATERIALS ALLOWED IN THIS ZONE. SEE FUEL MANAGEMENT PLAN -SHEET L-1.0 FOR ADDITIONAL INFORMATION.

PLANT LEGE

*WUC	CODE	BOT
	TREE	
L	Qa	QU
VL	Oe	OLE
	FRUIT	TRE
Μ	Cau	CIT
Μ	Ceu	CIT
Μ	Cmi	CIT
Μ	Csi	CIT
Μ	CsM	CIT
Μ	CsV	CIT
	SHRUE	3
L	Am	ACI
L	Ea	EC⊦
L	Hp	HES
L	La	LAV
L	Om	OLE
L	Pa	PER
	GROU	INDO
L	Ар	ARC
L	Ae	ARC
L		
L	Тр	TH
	GRASS	<u>SES</u>
L		
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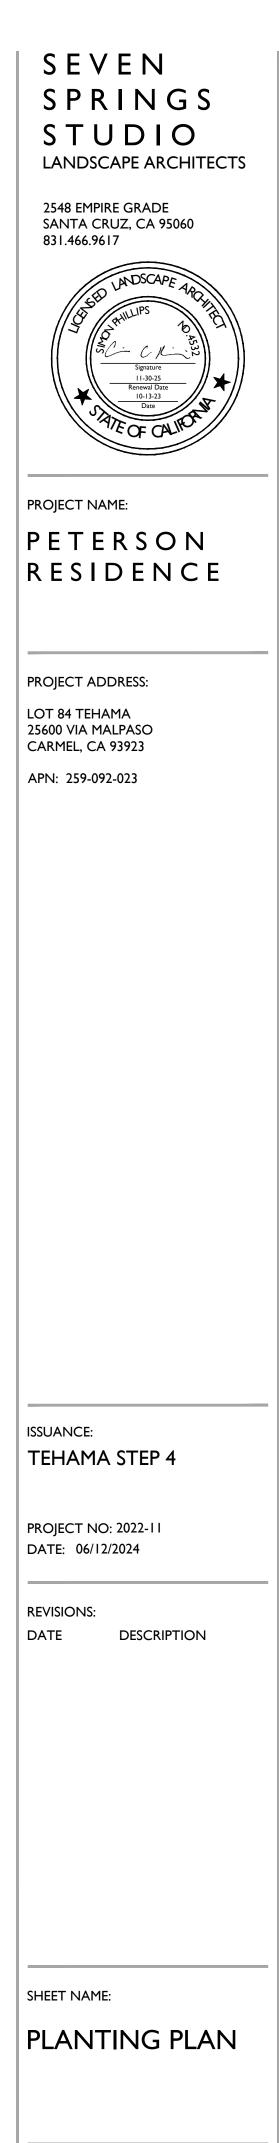
REFERENCE

PLANT SPAC

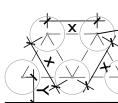


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PLAN	NT LE	GEND					
*WUC	CODE <u>TREE</u>	BOTANICAL NAME	1	СОММО	N NAME	SIZE	CHARACTER
L	Qa	QUERCUS AGRIFO	LIA	COAST L	IVE OAK	48" BOX	MULTI
VL	Oe <u>FRUIT</u>	OLEA 'SWAN HILL' <u>TREES</u>		SWAN H	ILL OLIVE	SIZE AS SI	HOWN
Μ	Cau	CITRUS X AURANT	FIIFOLIA	MEXICAN	N LIME	45 GAL.	
Μ	Ceu	CITRUS X 'EUREKA	.'	EUREKA	LEMON		
Μ	_	CITRUS 'MEYER IMP	PROVED'		1PROVED LEMON	45 GAL.	
Μ		CITRUS SINENSIS		NAVEL C	PRANGE	45 GAL.	
M		CITRUS SINENSIS '		BLOOD		45 GAL.	
М	CsV SHRUE	CITRUS SINENSIS '\	/ALENCIA'	VALENC	IA ORANGE	45 GAL.	
L		2 Achillea Millefo		YARROV	v	I GAL.	
L		ECHEVERIA 'AFTER			OW ECHEVERIA	I GAL.	
L			IFOLIA 'BRAKELIGH'			I GAL.	
L	La	LAVANDULA A. 'HI	DECOTE'	HIDECO ⁻	TE LAVENDER	I GAL.	
L	Om	OLEA 'MONTRA'		LITTLE O	LLIE OLIVE	15 GAL.	
L	Pa	PEROVSKIA ATRIPL	ICIFOLIA	RUSSIAN	SAGE	I GAL.	
	GROU	NDCOVERS					
L	Ap	ARCTOSTAPHYLO	S 'PACIFIC MIST'		MIST MANZANITA	I GAL.	
L		1	S 'EMERALD CARPET	MANZAN	D CARPET NITA	I GAL.	
L	<u> </u>	DYMONDIA MARG		SILVER C		FLATS	@ 8" O.C.
L	•	THYMUS 'PINK RIP	PLE'	PINK RIP	PLE THYME	I GAL.	
L	GRASS	CAREX DIVULSA		BERKELE		I GAL.	@ 24" O.C.
L		LOMANDRA L. 'BRI	FF7F'			I GAL.	W 24 O.C.
L	L. Mc	MUHLENBERGIA C			HLY GRASS	I GAL.	
L		MUHLENBERGIA D	UBIA	PINE MU	HLY	I GAL.	@ 36" O.C.
М	Sa	SESLERIA AUTUMN	IALIS	AUTUMN	N MOOR GRASS	I GAL.	
	BULBS						
	Na	NARCISSUS		DAFFOD	IL		
	+ + -				ED FIELD SEDGE		
	+ +	KOELERIA MACRAI	LONDE AMBITION'		AMBITION UNEGRASS		
	+ + + + + + + + + + + + + + + + + + + +			-	NEEDLEGRASS		
	+ +						
		CRUSHED GRAVEL	: FOR PEDESTRIAN A	AREAS 2" O	VER 4" COMPACTED	CLASS II BA	ASE.
	MTL	_ METAL EDGING: W	/eld all joints an	ID PRIME AI	ND PAINT ONCE W	ELDED.	
			(Y (VVUC) KEY FO THIS PROJECT: R				
H = H	IGH; M		OW; VL = VERY LOV		CIES NOT		
* FRO							
			S OF LANDSCAPE PL TIVE EXTENSION, L.R. CC				
REFE		CE NOTES					
\sim		DSEED MIX LIMITS T MINED IN FIELD	O FOLLOW GRADIN	NG LIMITS A	S		
			ED AT 36 LBS/ACRES	EVENLY BE	TWEEN THE		
	SPECIES	S LISTED					
PLAN	NT SP	ACING AND P	PLANTING SETE		AGRAM		
					-PLANT,		
×		PLANT, TYP.			TYP.		
4		- EDGE OF			- EDGE OF		
		PLANTING	SQUARE SP		PLANTING		
		+ 12" UON					
		COMPLIANCE S					
			RITERIA OF THE ORI				
		DESIGN PLAN.					
	C.K	~	Simon Phillips	4532	10-13-2023 DATE		
SIGN	ED		NAME	CLA#	DATE		
			OMPLIANCE ST				
			PING AND IRRIGAT				
INCL	UDING	USE OF NATIVE, DE	ROUGHT-TOLERAN DW-FLOW, WATER	T, NON-IN	/ASIVE		
	,	FIXTURES.					
C.	C.K	· _ `	Simon Phillips	4532	10-13-2023		
SIGN	ED		NAME	CLA#	DATE		



SHEET NO:



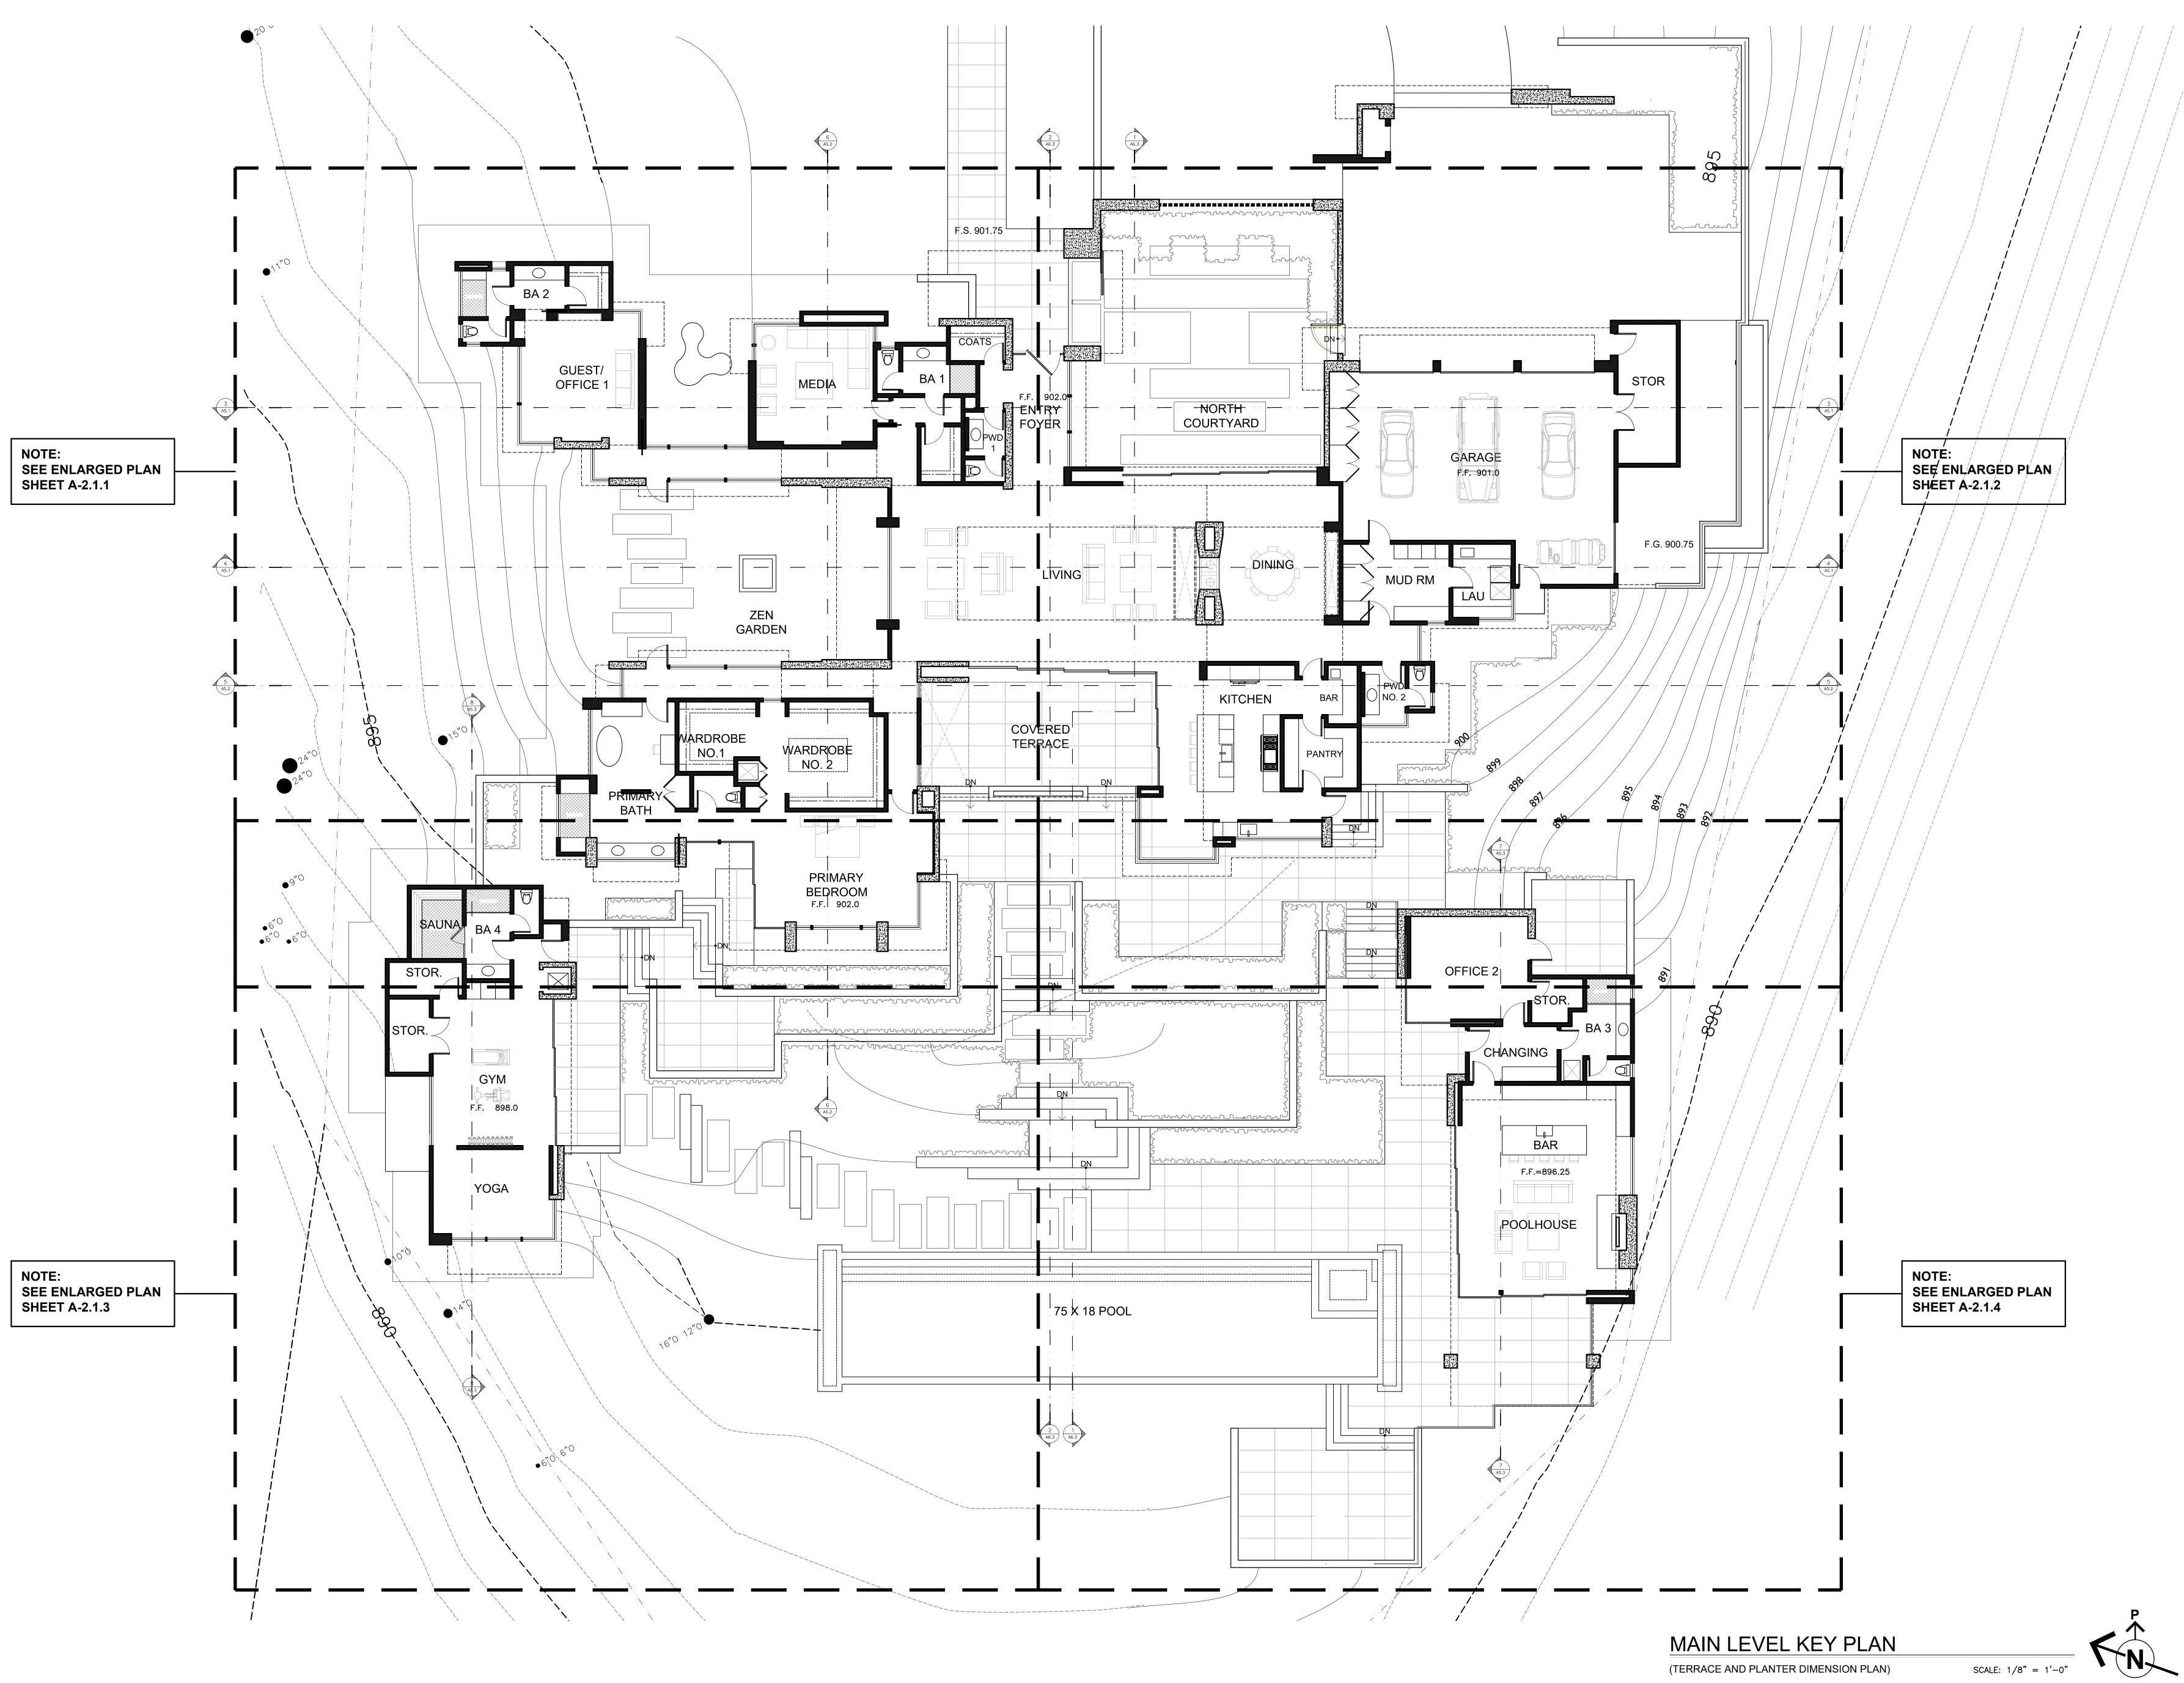

STERLING | HUDDLESON A R C H I T E C T U R E

P.O. BOX 221092 CARMEL, CA. 93922 TEL. 831.624.4363


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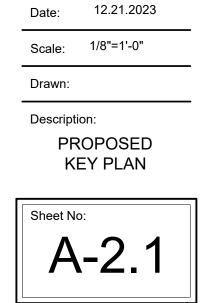
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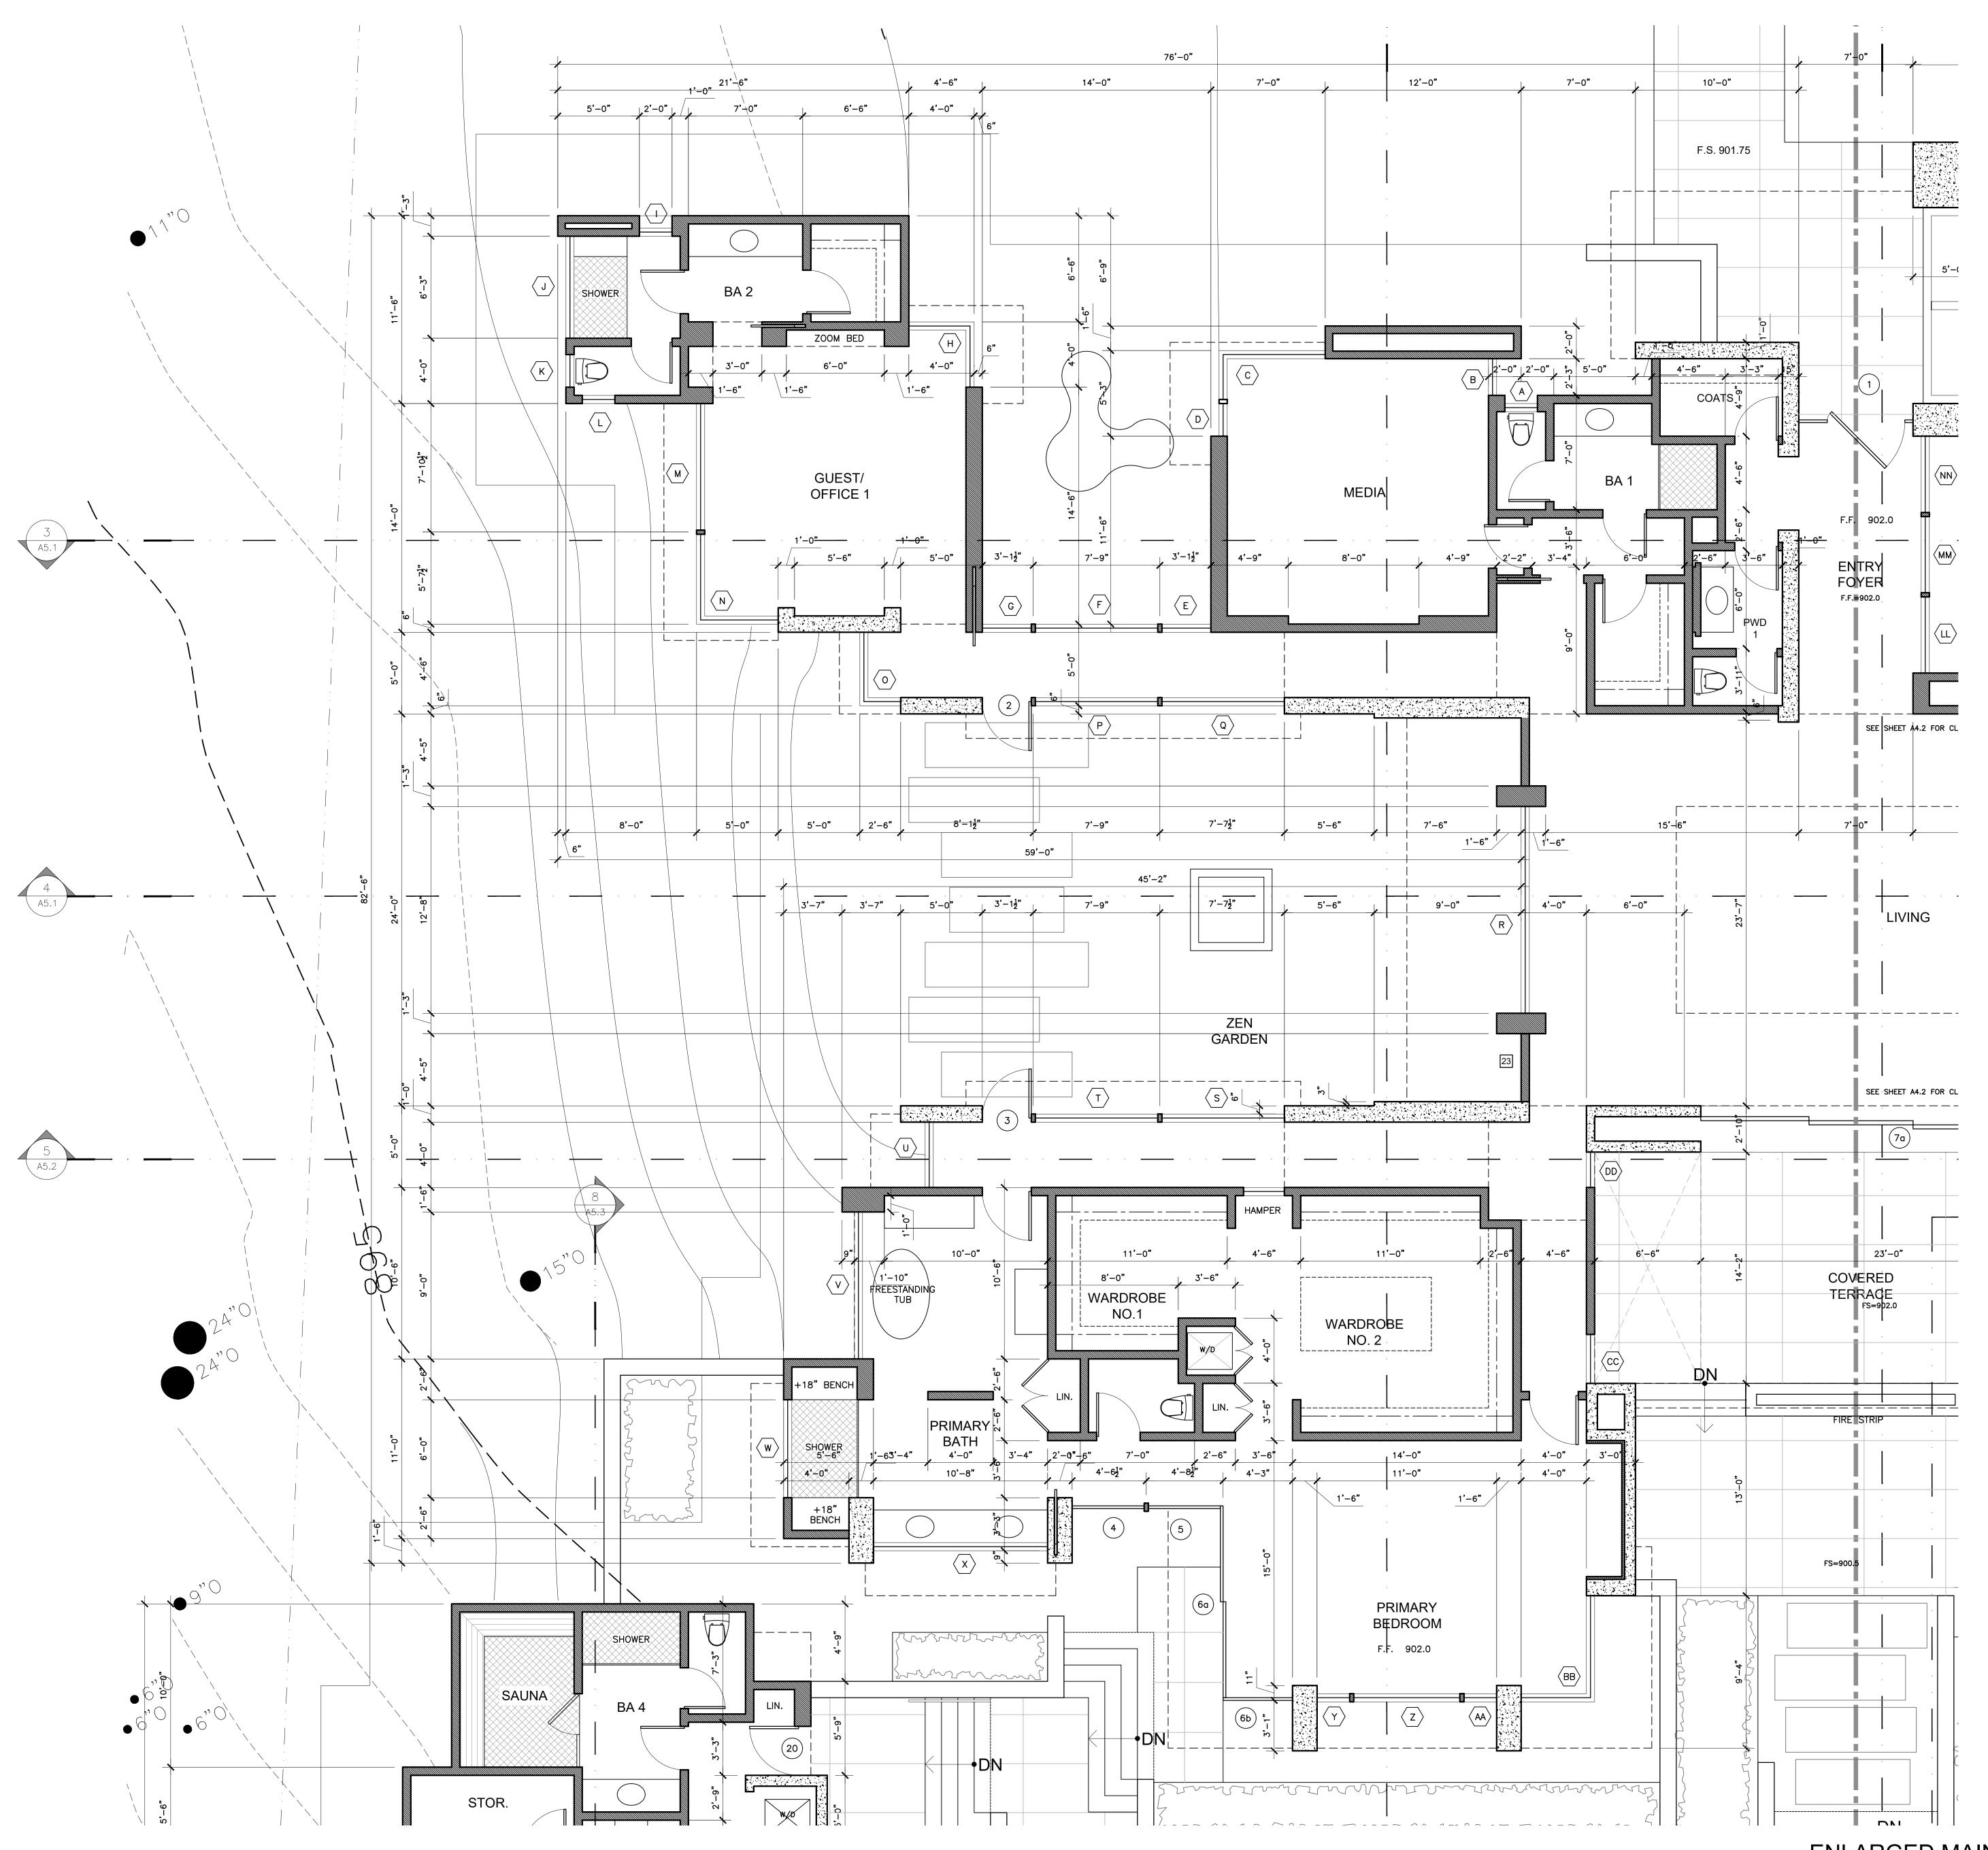
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SUBMITTAL SUBMITTAL





KE	Y NOTES
1	LINE OF UPPER FLOOR ABOVE
2	CEILING OR ROOF ABOVE, SEE RCP
3	ROOF WINDOW ABOVE, SEE SCHEDULE SHEET A8.2
4	SITE RETAINING WALL, SEE CIVIL AND LANDSCAPE
5	IMPERVIOUS STONE PAVERS
6	GRAVEL OR D.G. SURFACE, SEE LANDSCAPE DWG
7	FIRETRUCK TURNAROUND
8	STAIRS: 18 RISERS AT 7.27 INCHES, 17 WINDING TREAD
9	FIREPLACE BY 'ISOKERN' SELECTED MODEL/SIZE
	 SHOWN ON PLANS. SOLID FUEL (WOOD) BURNING w/GAS LOG LITER LINE (NOT CONSTANT PILOT LITE). ESR 2316, BY EARTHCORE, CSI 103100. PROVIDE APPROVED INSTALLATION INSTRUCTIONS ARE TO BE ON THE JOB SITE AT TIME OF INSPECTION. FIREPLACE GAS OUTLET 'LOG LIGHTER' CONTROL VALVE(S) SHALL BE INSTALLED PER MANUFACTURER'S INSTALLATION INSTRUCTIONS AND WITH-IN 6-FEET MAXIMUM FROM GAS OUTLET. GLASS DOORS (TIGHT FITTING) SHALL BE INSTALLED AT FIREBOX OPENING. PROVIDE OUTSIDE MAKE-UP AIR LINE. WITH MT'L. UL LISTED FLUE TO MFG MT'L CAP (SPARK ARRESTER). INSTALLED PER SELECTED MFG LISTING IN FRAMED CHIMNEY CHASE. MAINTAIN MIN 2" CLEARANCE BETWEEN WOOD FRAMING & UNIT (INCLUDES MFG FLUE). PROVIDE NON-COMBUSTIBLE FIREBOX OPENING WITH MIN. 12" WIDE FACING (INCREASE FOR COMBUSTIBLE PROJECTIONS) AND 20 DEEP HEARTH. PROVIDE RETRACTABLE (CONCEALED) METAL GRATED SCREEN. SEE INTERIOR ELEVATIONS FOR ADDITIONAL DETAILS AS PROVIDED
10	EXTERIOR LANDING SHALL BE 36" DEEP MINIMUM AND NOT EXCEED 7-3/4" BELOW TOP OF DOOR THRESHOLI
11	EXTERIOR LANDING SHALL BE 36" DEEP MINIMUM AND NOT EXCEED 1-1/2" BELOW TOP OF DOOR THRESHOLI
12	HOT WATER HEATER, LOCATE ON RAISED PLATFORM + 18" ABOVE FIN. FLR. , SECURE WITH ANCHORS OR STRAPS TO RESIST HORIZ DISPLACEMENT SEE MECH.
13	200 AMP ELECTRICAL MAIN PANEL
14	50 AMP ELECTRICAL SUB PANEL
15	DRYER VENT TO OUTSIDE, 4" Ø EXHAUST DUCT MAX LENGTH OF 14' WITH (2) 90° ELBOWS. VENT DISCHARG TO BE A MINIMUM OF 3 FEET AWAY FROM ANY OPENINGS INTO BUILDINGS
16	5/8" TYPE 'X' GYP. BD. BETWEEN GARAGE AND LIVING SPACE - WALLS AND CEILING
17	STAIRS: 17 RISERS AT 7.23 INCHES, 16 WINDING TREAD
18	HANDRAIL: SEE DETAIL 1/A9.1
19	BBQ GRILL CONNECTED TO NATURAL GAS PIPING, SEE
20	FIRE PIT CONNECTED TO NATURAL GAS PIPING, SEE F
21	PROVIDE MIN. 12" SQ. ACCESS DOOR OR SOLID
	COPPER PLUMBING FITTINGS AT TUB FIXTURES.
22	SHOWER FLOOR FLUSH WITH FINISHED FLOOR, SLOPE TO DRAIN, FINISHED WITH NON-ABSORBENT FLOORING, UP ADJACENT WALLS MIN. 72". WITH TEMPERED GLASS DOOR AND PANELS.THE FINISHED INTERIOR MUCH BE A MINIMUM OF 1024 SQ. INCHES AND CAPABLE OF ENCOMPASSING A 30 INCH CIRCLE
23	WATER CLOSET SHALL HAVE A MINIMUM 24 INCH CLEA SPACE IN FRONT, AND A 15 INCH CLEARANCE FROM IT
24	CENTERLINE TO EACH SIDE WALL (CPC 402.1) SPIRAL STAIR - SEE DETAIL 5/A-9.5
SY	MBOLS LEGEND
	00 DOOR PER SHEET A-8.1
	AA WINDOW PER SHEET A-8.2
	00 FINISHES PER SHEET A-8.3
PL	AN WALL LEGEND
	2/////////////////////////////////////
•	
1	= 2X STUD W/ MASONRY VENEER
-	= MASONRY CONCRETE WALL
	NEDAL NOTES

1. SEE PARTIAL FLOOR PLAN SHEETS FOR OTHER WALL DIMENSIONS

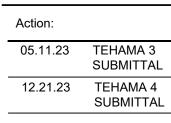GENERAL NOTES

2. SEE SHEET A-2.1 FOR PATIO, SITE WALL AND EXTERIOR STAIR DIMENSIONS

WINDING TREADS

/ODEL/SIZE D) BURNING Γ PILOT LITE). INSTRUCTIONS OF INSPECTION. ER' CONTROL ANUFACTURER'S TH-IN 6-FEET L BE INSTALLED

T'L CAP (SPARK D MFG LISTING IN MIN 2" NG & UNIT -COMBUSTIBLE E FACING ECTIONS) AND 20" LE (CONCEALED) OR ELEVATIONS

ED MINIMUM AND OOR THRESHOLD

P MINIMUM AND OOR THRESHOLD


UST DUCT MAX /ENT DISCHARGE OM ANY

WINDING TREADS

GAS PIPING, SEE P-2.1 AS PIPING, SEE P-2.1

JM 24 INCH CLEAR RANCE FROM ITS C 402.1)



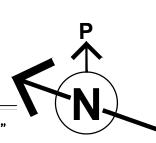



STERLING | HUDDLESON A R C H I T E C T U R E

P.O. BOX 221092 CARMEL, CA. 93922 TEL. 831.624.4363 www.sterlinghuddleson.com

Ш Ζ **RESIDEI** A MALPA: CA 93923 -092-023 \mathbf{O} **1 - 25600 ARMEL**, 0. P.N. 259-0 0 S T **₩** 8 48 7. 10 84

Prepared by:

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PRELIMINARY _____

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Action: 05.11.23 TEHAMA 3 _____


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SUBMITTAL 12.21.23 TEHAMA 4 SUBMITTAL

Date: 12.21.2023 _____ Scale: 1/4"=1'-0" Drawn: Description: ENLARGED MAIN LEVEL PLAN-1

A-2.1.1

Sheet No:

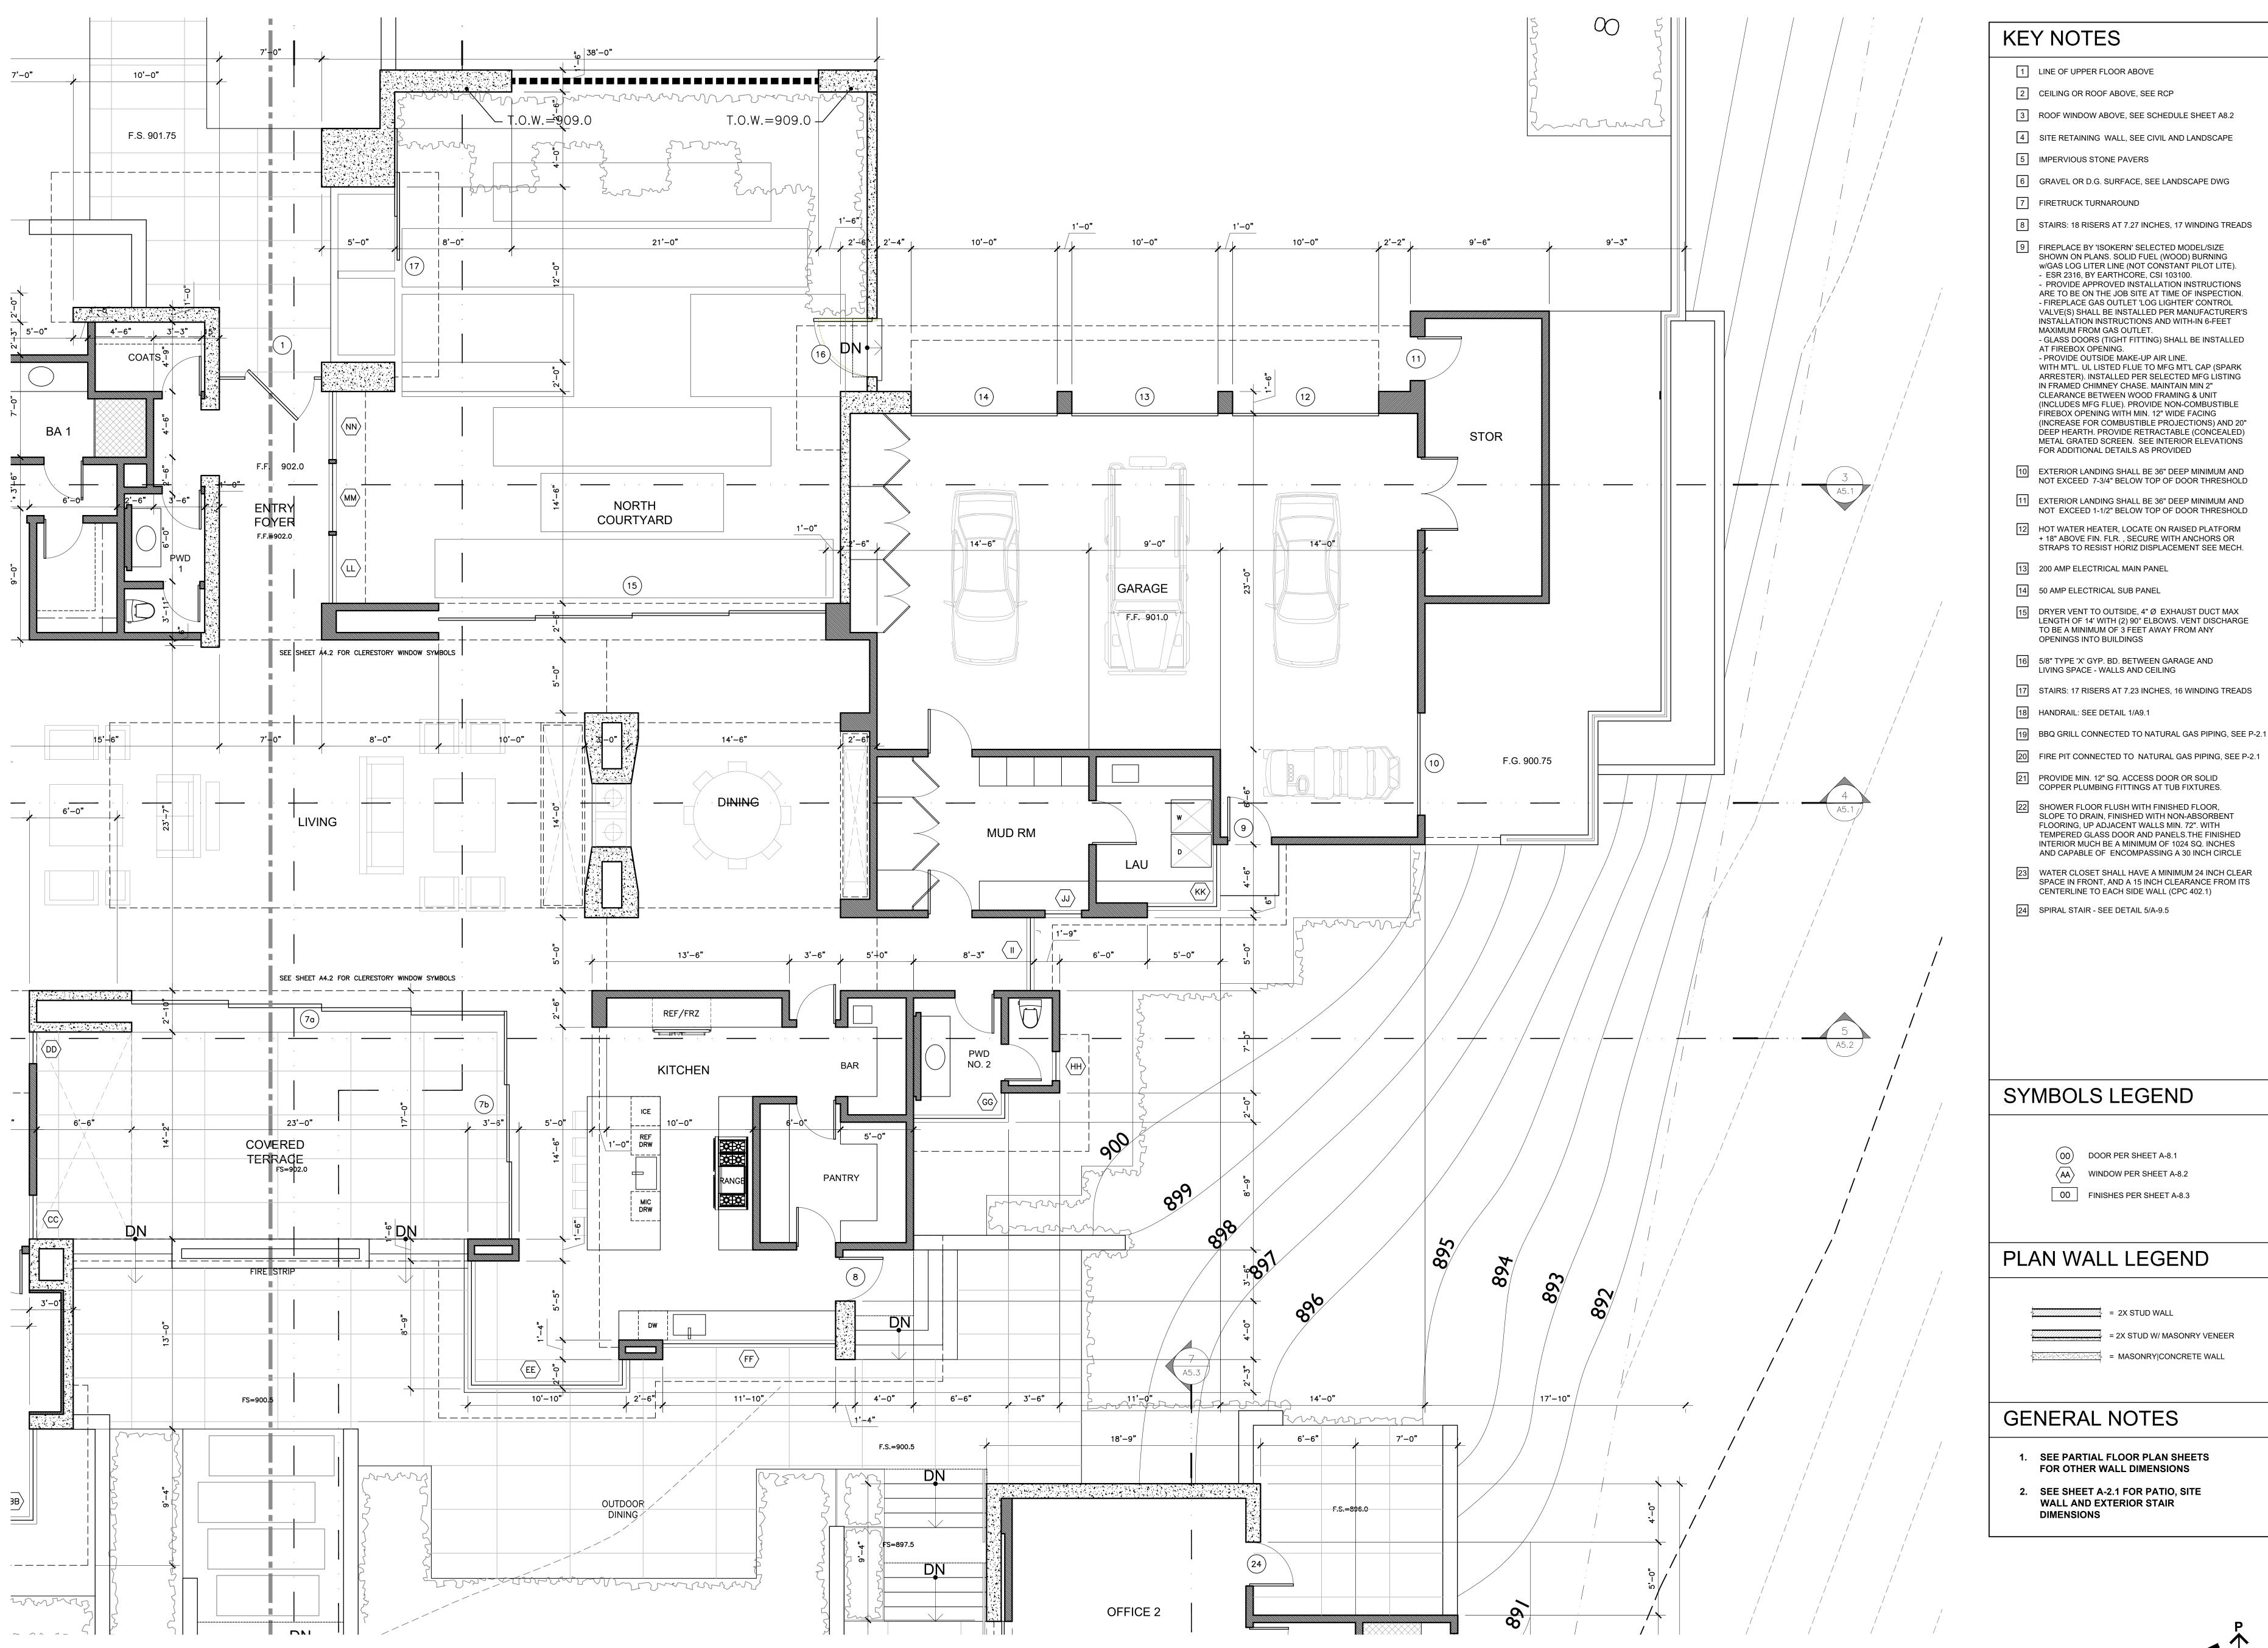


ENLARGED MAIN LEVEL FLOOR PLAN

SCALE: 1/4" = 1'-0"



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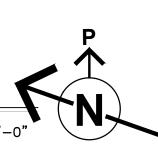
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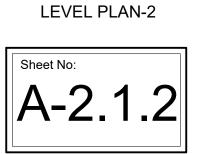
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Action:

05.11.23 TEHAMA 3 SUBMITTAL 12.21.23 TEHAMA 4 SUBMITTAL

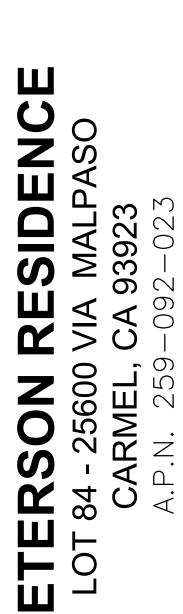



ENLARGED MAIN


Date: 12.21.2023

Scale: 1/4"=1'-0"

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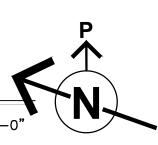
Drawn:

Description:

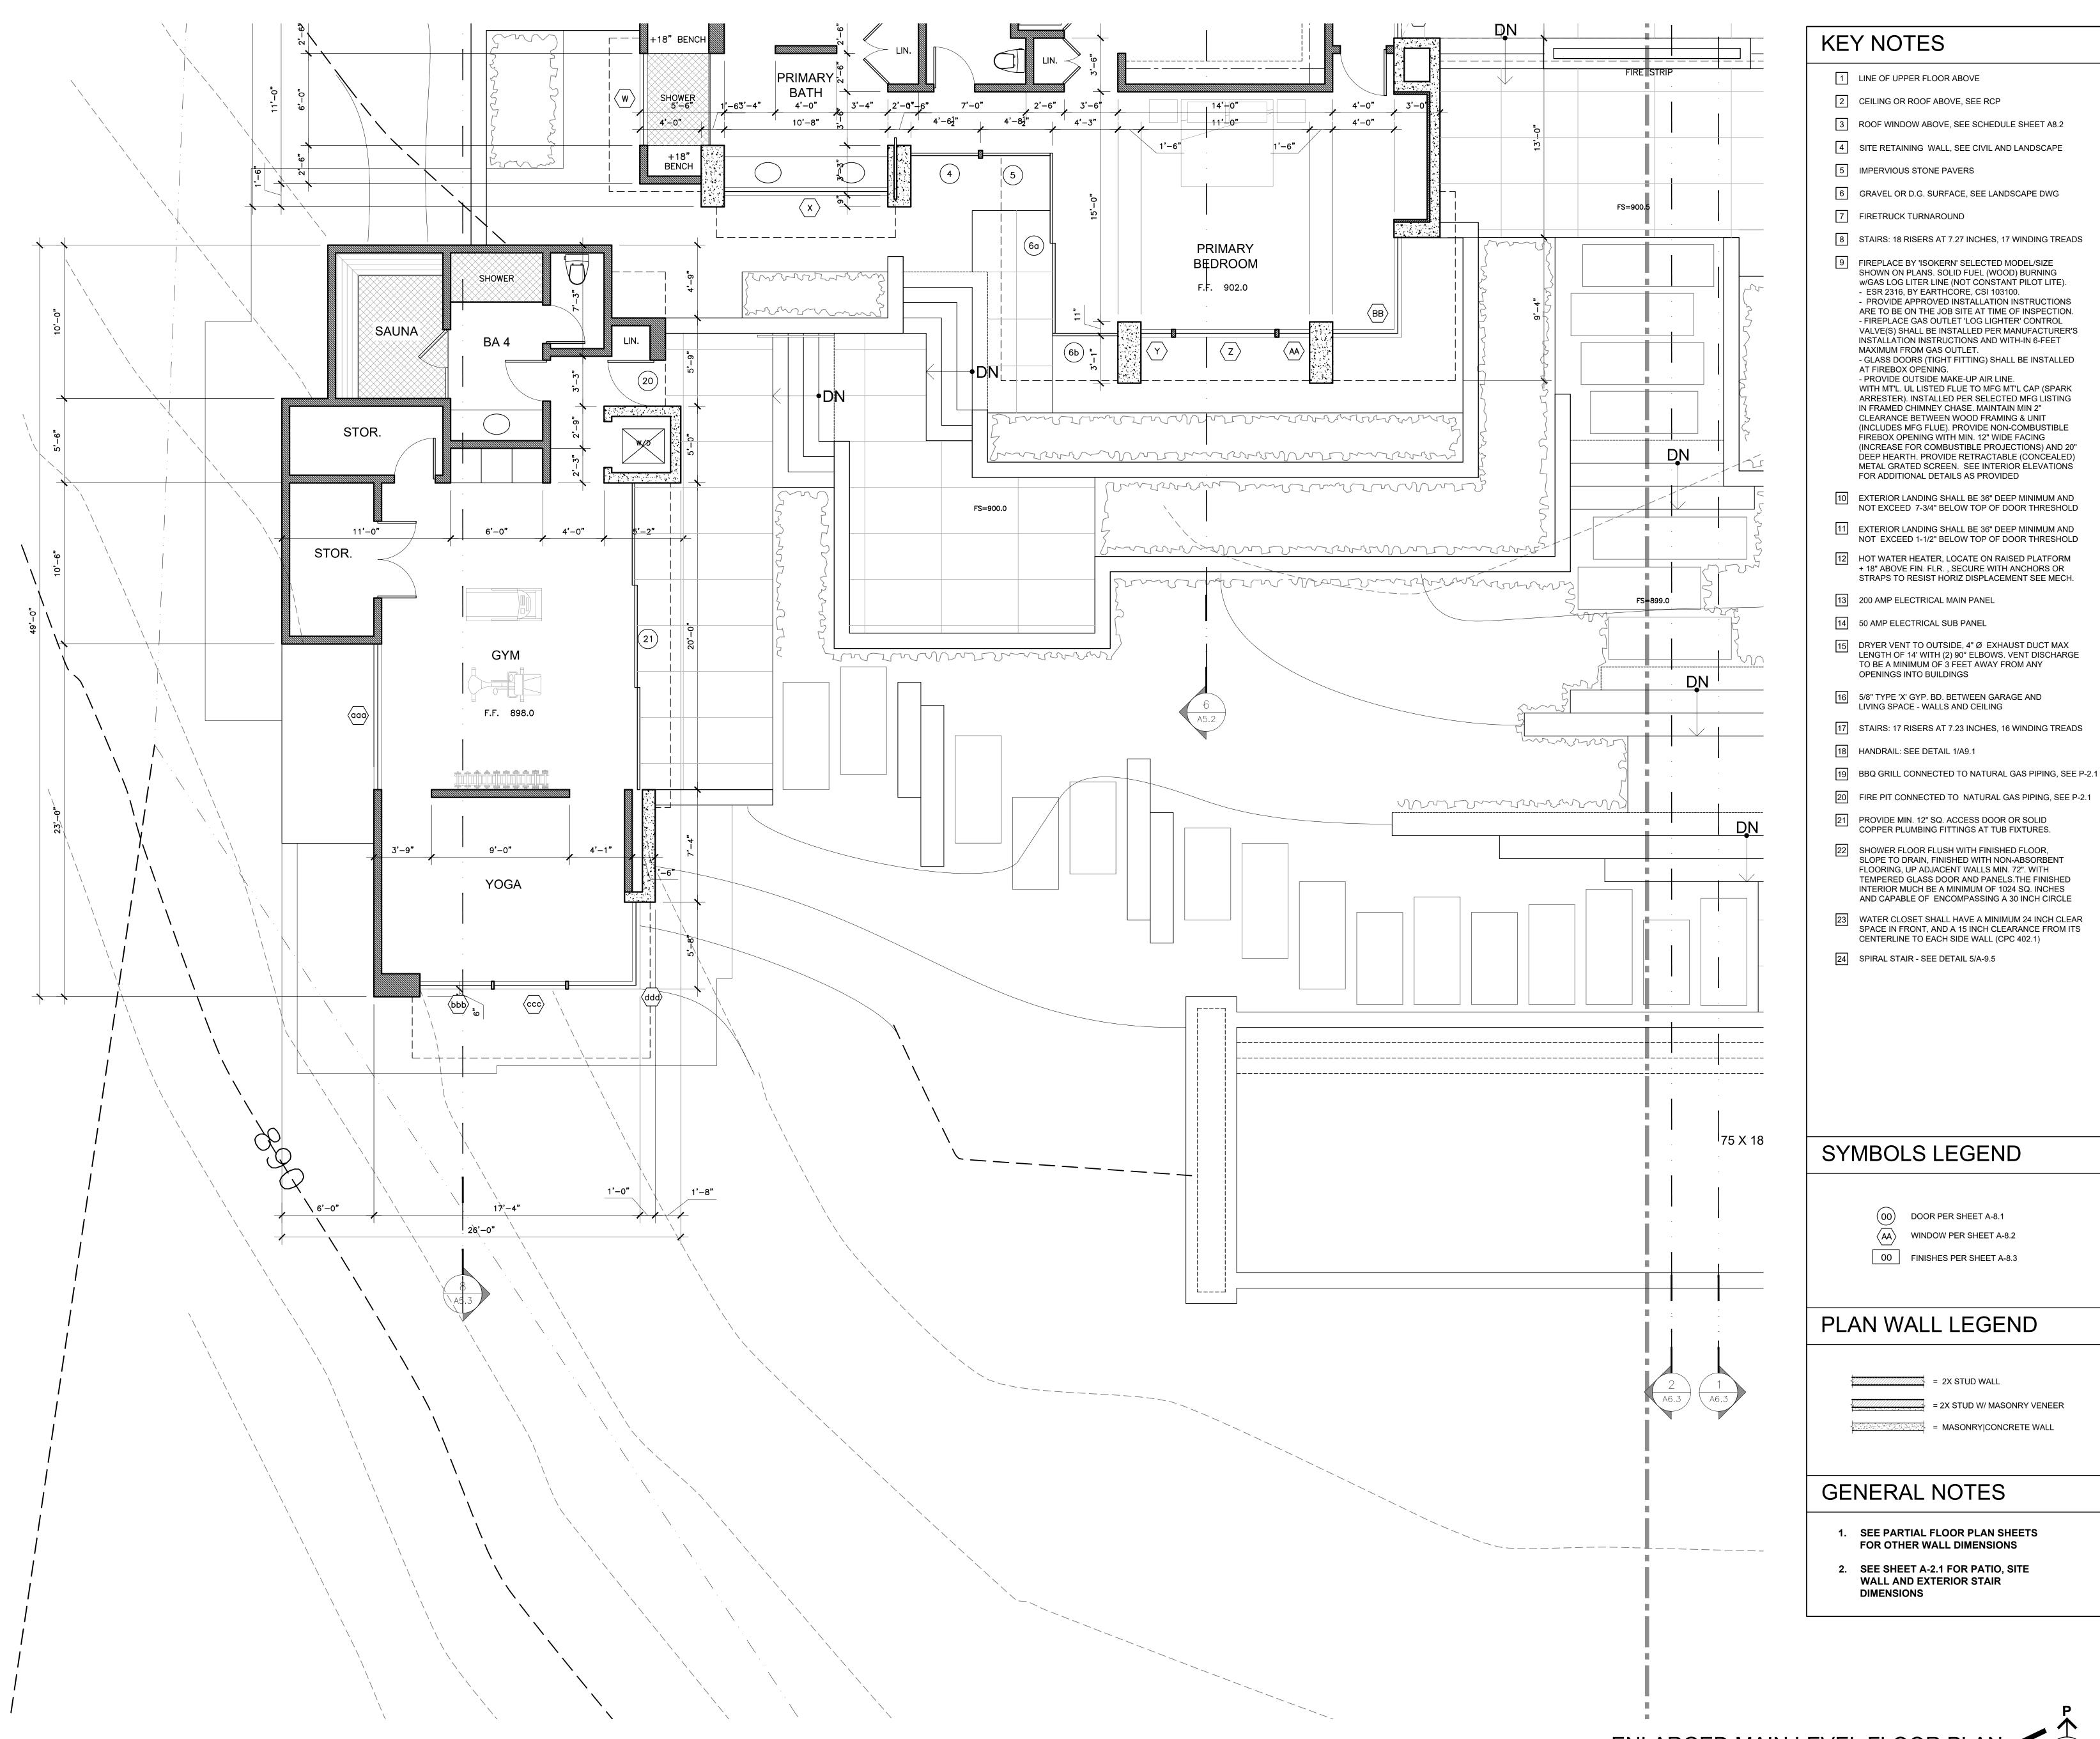

SCALE: 1/4" = 1'-0'








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Action:


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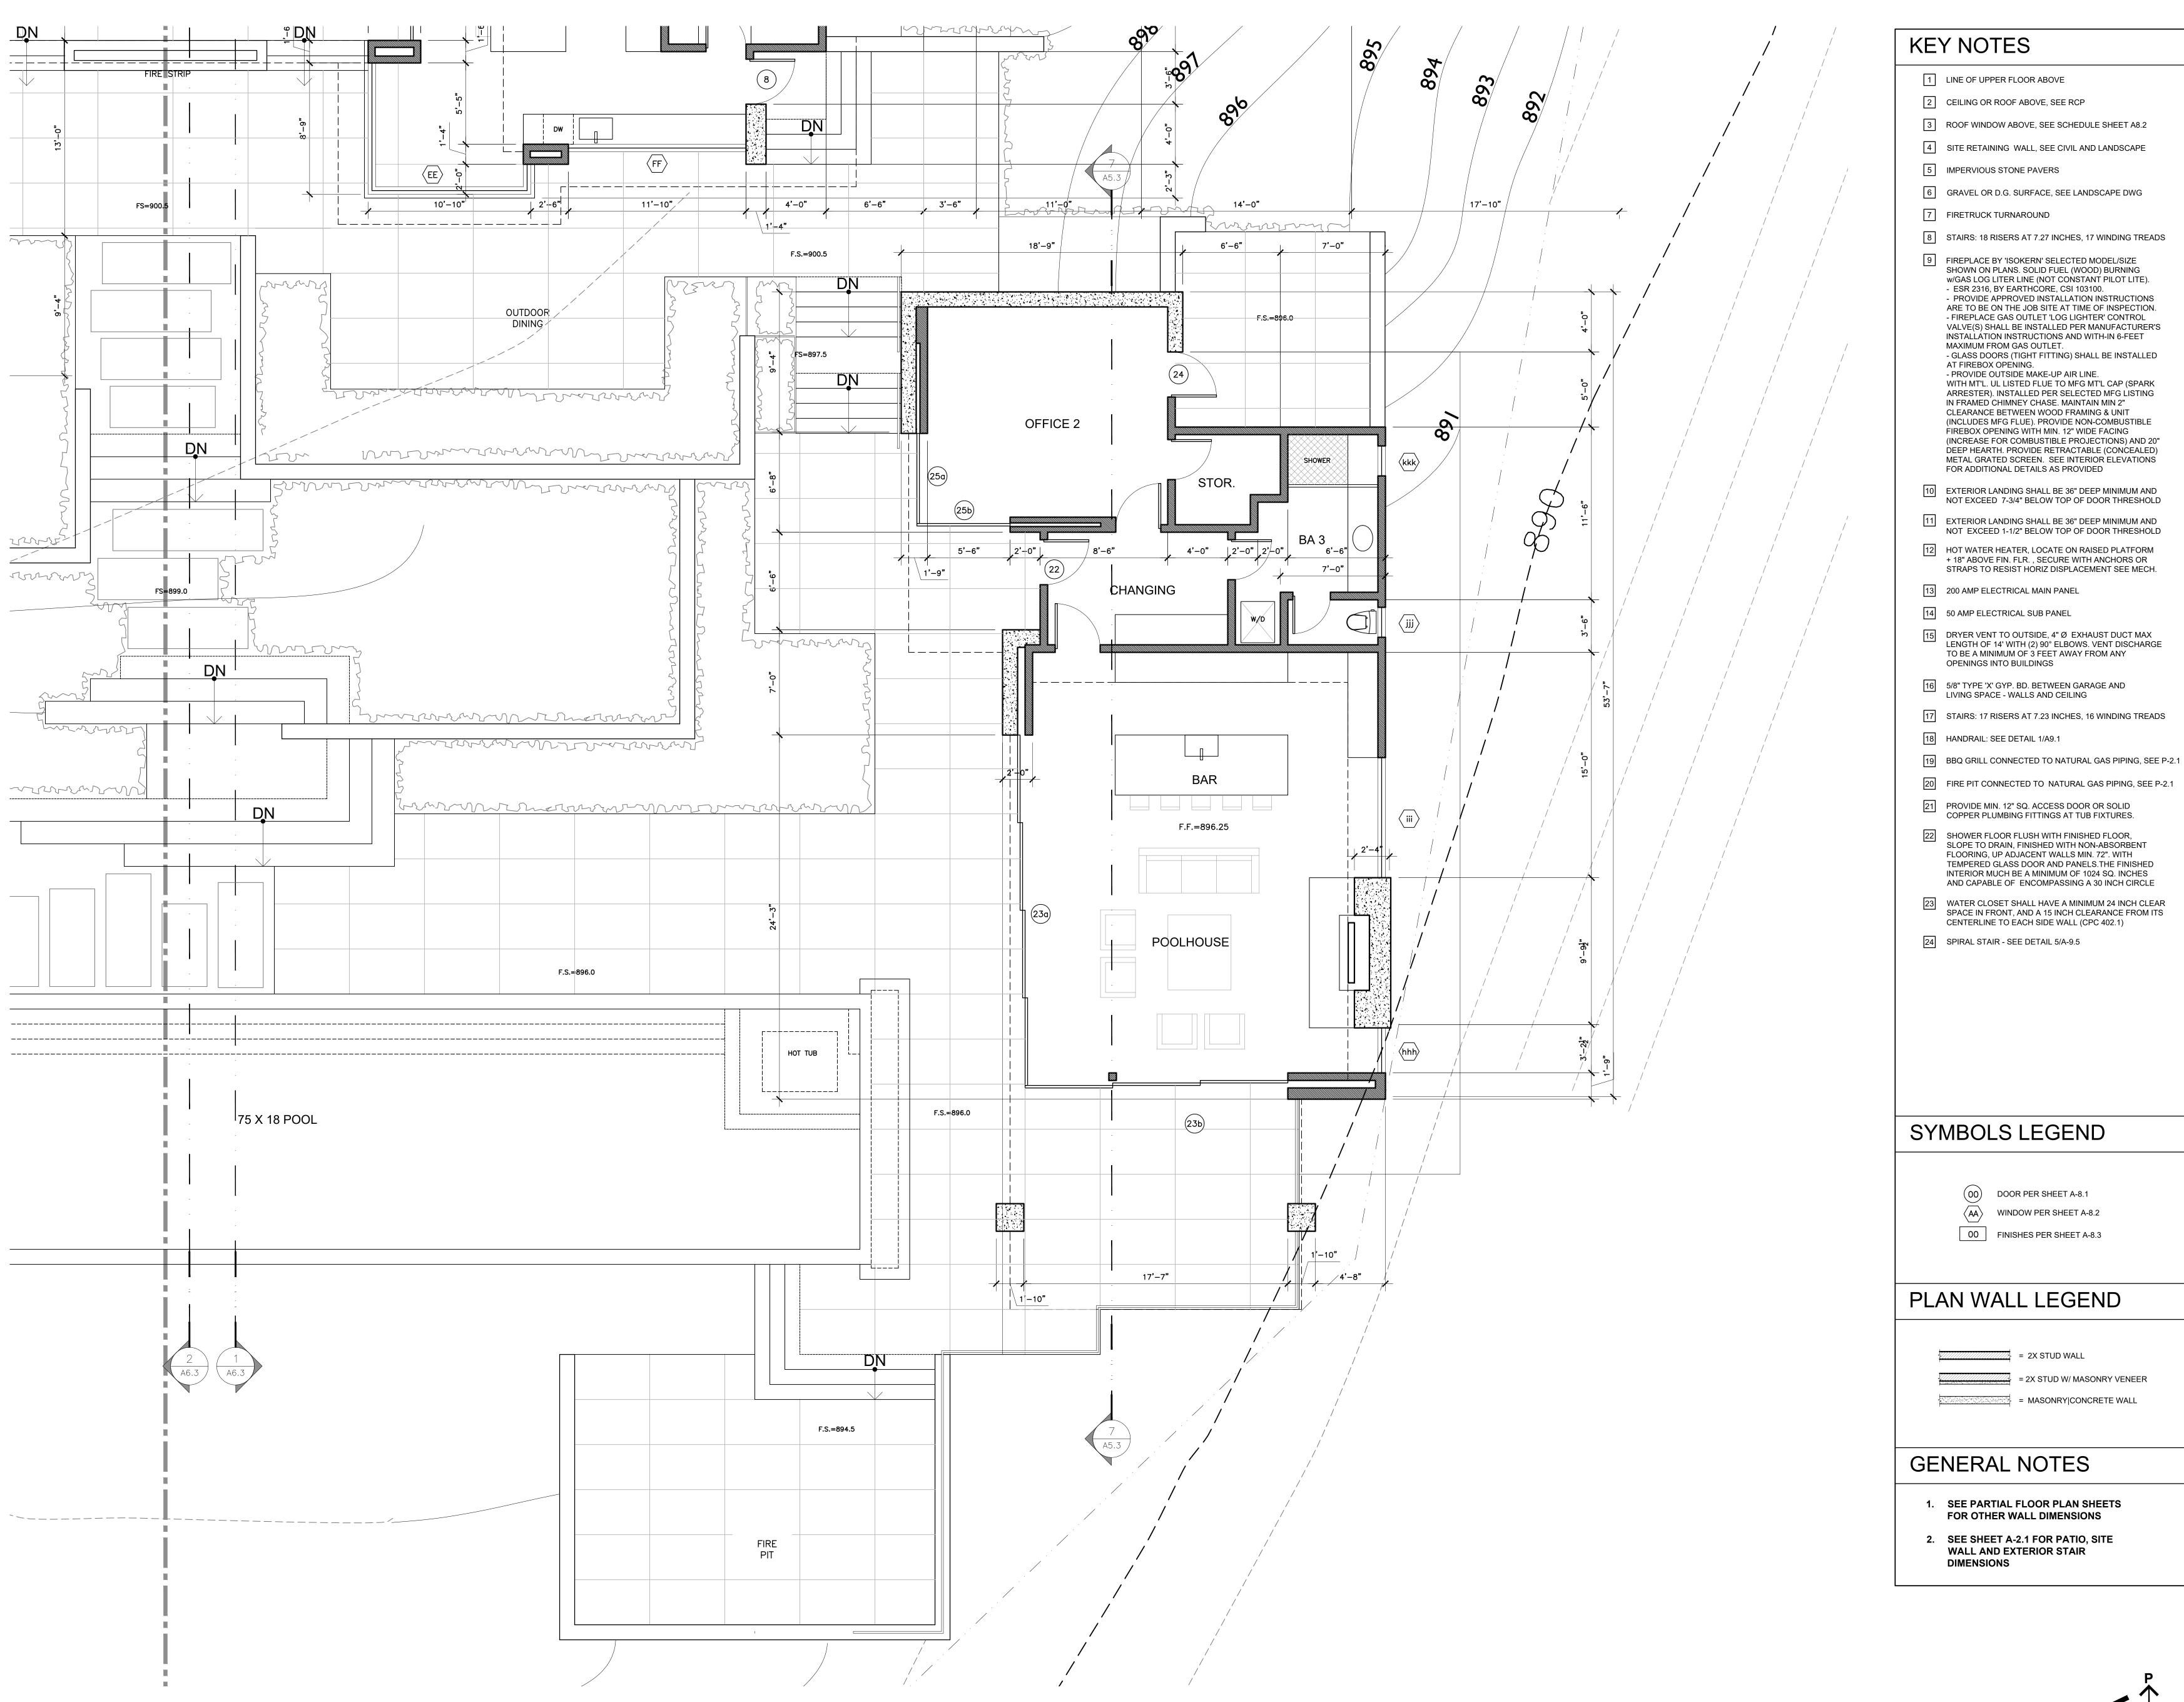
05.11.23 TEHAMA 3 SUBMITTAL 12.21.23 TEHAMA 4 SUBMITTAL

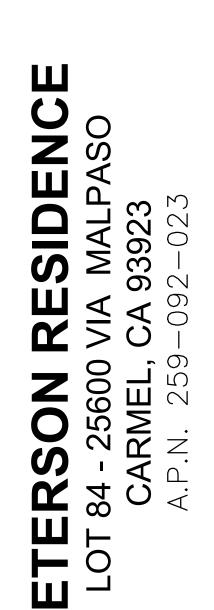Drawn: Description: ENLARGED **GYM**|EXERCISE

Date: 12.21.2023

Scale: 1/4"=1'-0"



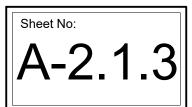


SCALE: 1/4" = 1'-0"



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Action: 05.11.23 TEHAMA 3


SUBMITTAL 12.21.23 TEHAMA 4 SUBMITTAL

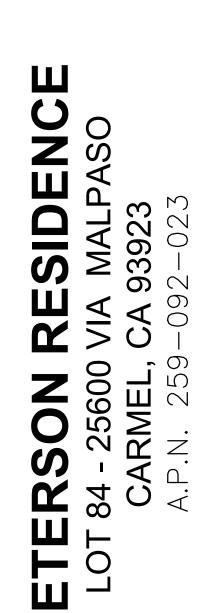Scale: 1/4"=1'-0" Drawn: Description: ENLARGED POOL HOUSE PLAN


Date: 12.21.2023



	EX-2	EX-3	EX-6	
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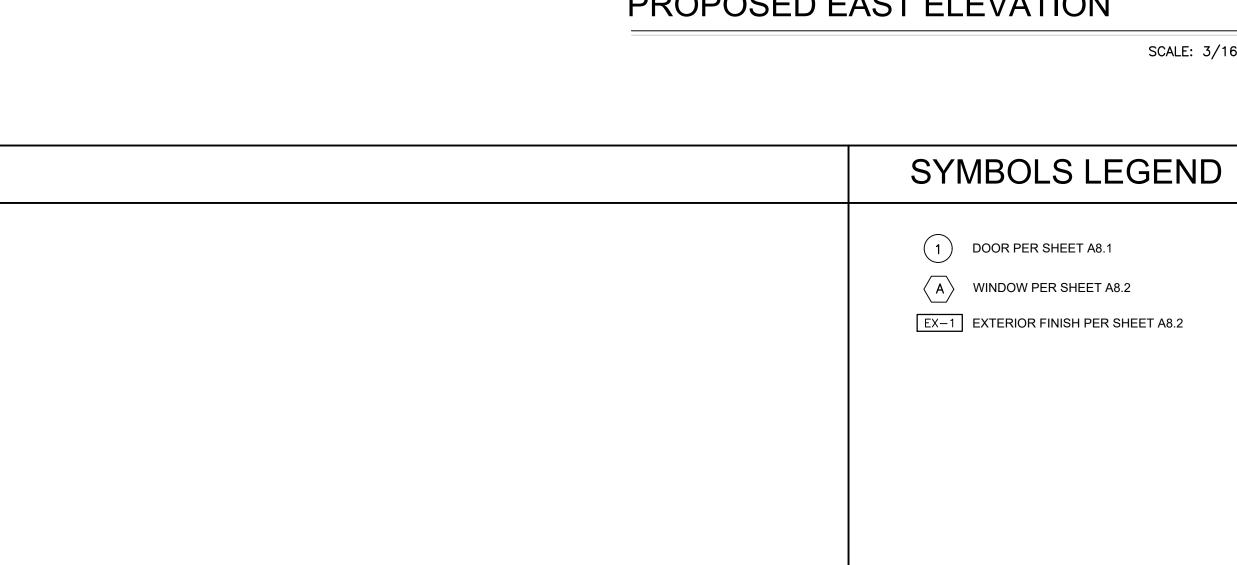


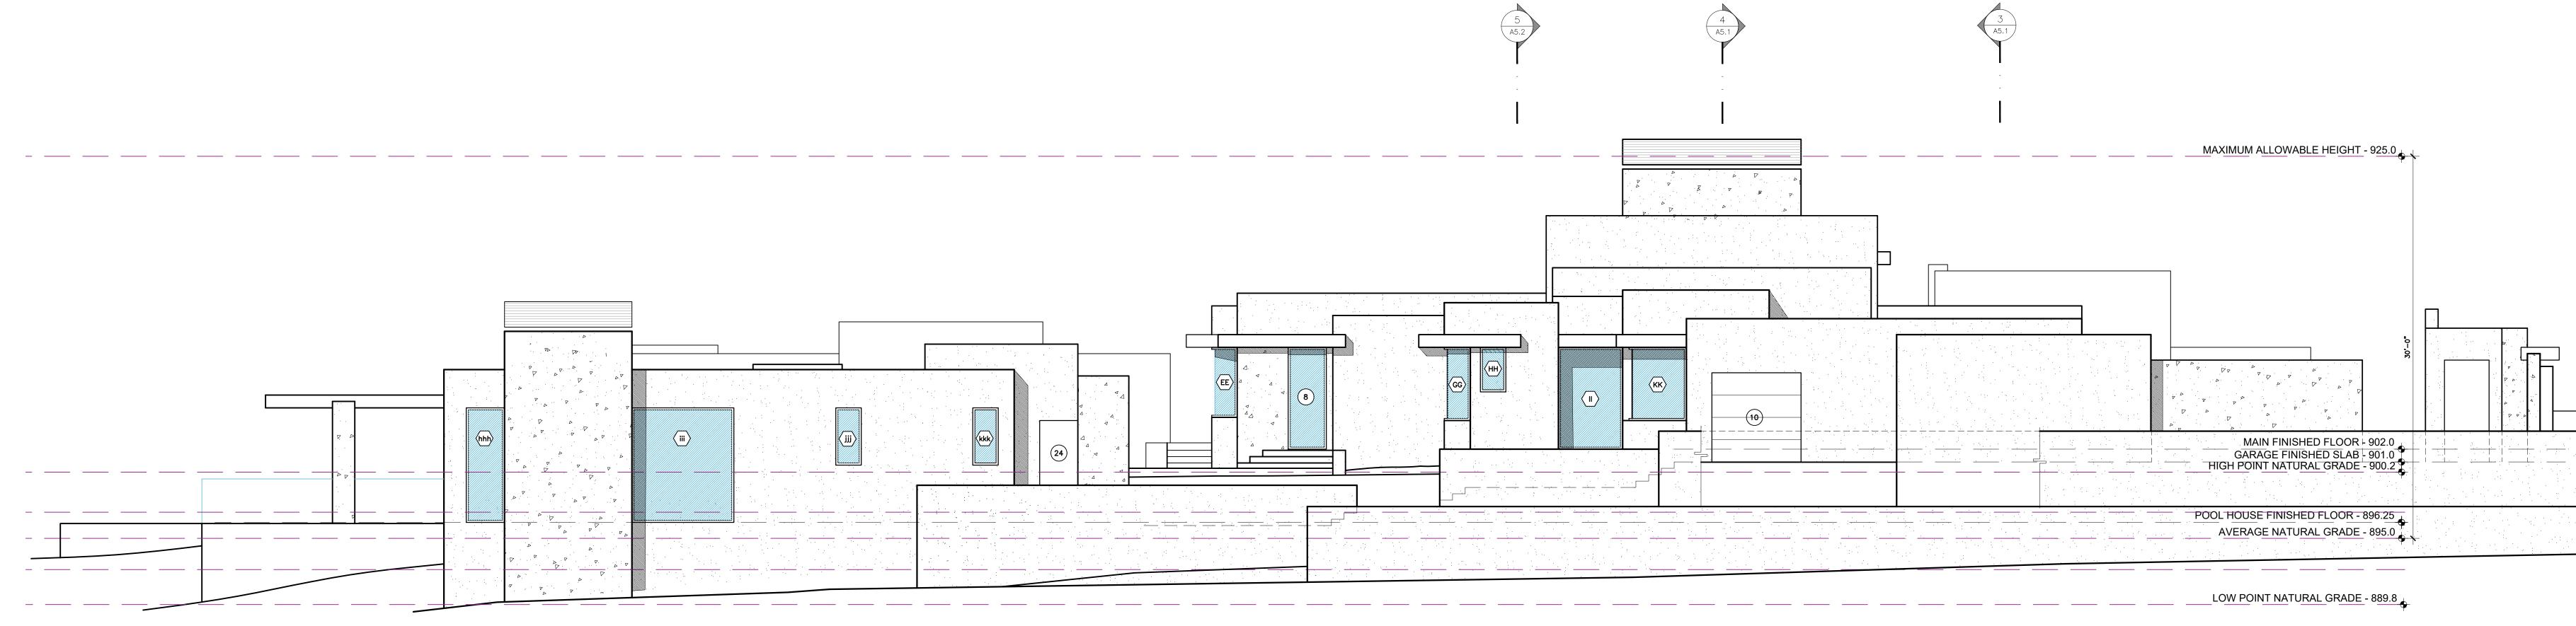ELEVATION KEY NOTES		
EX-1 BRONZE METAL CAP AND FLASHING OVER WOOD PROFLE FASCIA	EX-8 BRONZE PAINTED METAL GUARDRA	JL -
EX-2 STUCCO: 7/8" ACRYLIC EXT. PLASTER w/SMOOTH STEEL TROWEL FINISH o/METAL LATH, ACRYLIC CORNERS o/2-LAYERS, GRADE "D" PAPER. PAINT WITH CLEAR SEALER SAMPLE IN FIELD. COLOR TO BE BENJAMIN MOOR CSP-70 "UPPER WEST SIDE"	EX-9 LANDSCAPE OR RETAINING WALL. CONCRETE (PER PLAN), COLOR BY	
EX-3 BOARD-FORMED CONCRETE, COLOR TO BE LIGHT GRAY,	EX-10 FRAMELESS, TEMP GLASS RAILING,	42"
EX-4 CUSTOM COPPER CHIMNEY SHROUD, PER DTL. W/ I.C.C. SPARK ARRESTOR, O/ SELKIRK/ISOKERN CHIMNEY FLUE.	EX-11 FLAT ROOF MEMBRANE: USE 90# CA SLOPED TO DRAIN MIN. 1/4" PER FOO ALTERNATE USE METAL ACRYLICS (OT
EX-5 FLEETWOOD OR EQUAL ALUMINUM BOX FRAME DOORS AND WINDOWS PER SCHEDULE. PROVIDE SHOP DRAWINGS FOR APPROVAL PRIOR TO ORDERING.	EX-12 EAVE SOFFIT: 1X COULSON ENGINE	
EX-6 ALUMINUM FRAME OVERHEAD SECTIONAL DOOR. PROVIDE SHOP DRAWING FOR REVIEW/APPROVAL.	COLOR: CLEAR SEALER. 0/30# ASPH. GRADE PLYWOOD SHEATHING. WUI	
EX-7 CONCEALED COPPER DOWNSPOUTS. TIE INTO STORM DRAIN SYSTEM, SEE CIVIL SHEETS. USE STAINLESS STEEL GUTTERGUARD TO PREVENT THE ACCUMULATION OF LEAVES AND DEBRIS IN THE GUTTER.	EX-13 CONCRETE PATIO: INTEGRAL COLOR MATTE SEALER. SLOPE 2% MIN. TO I	

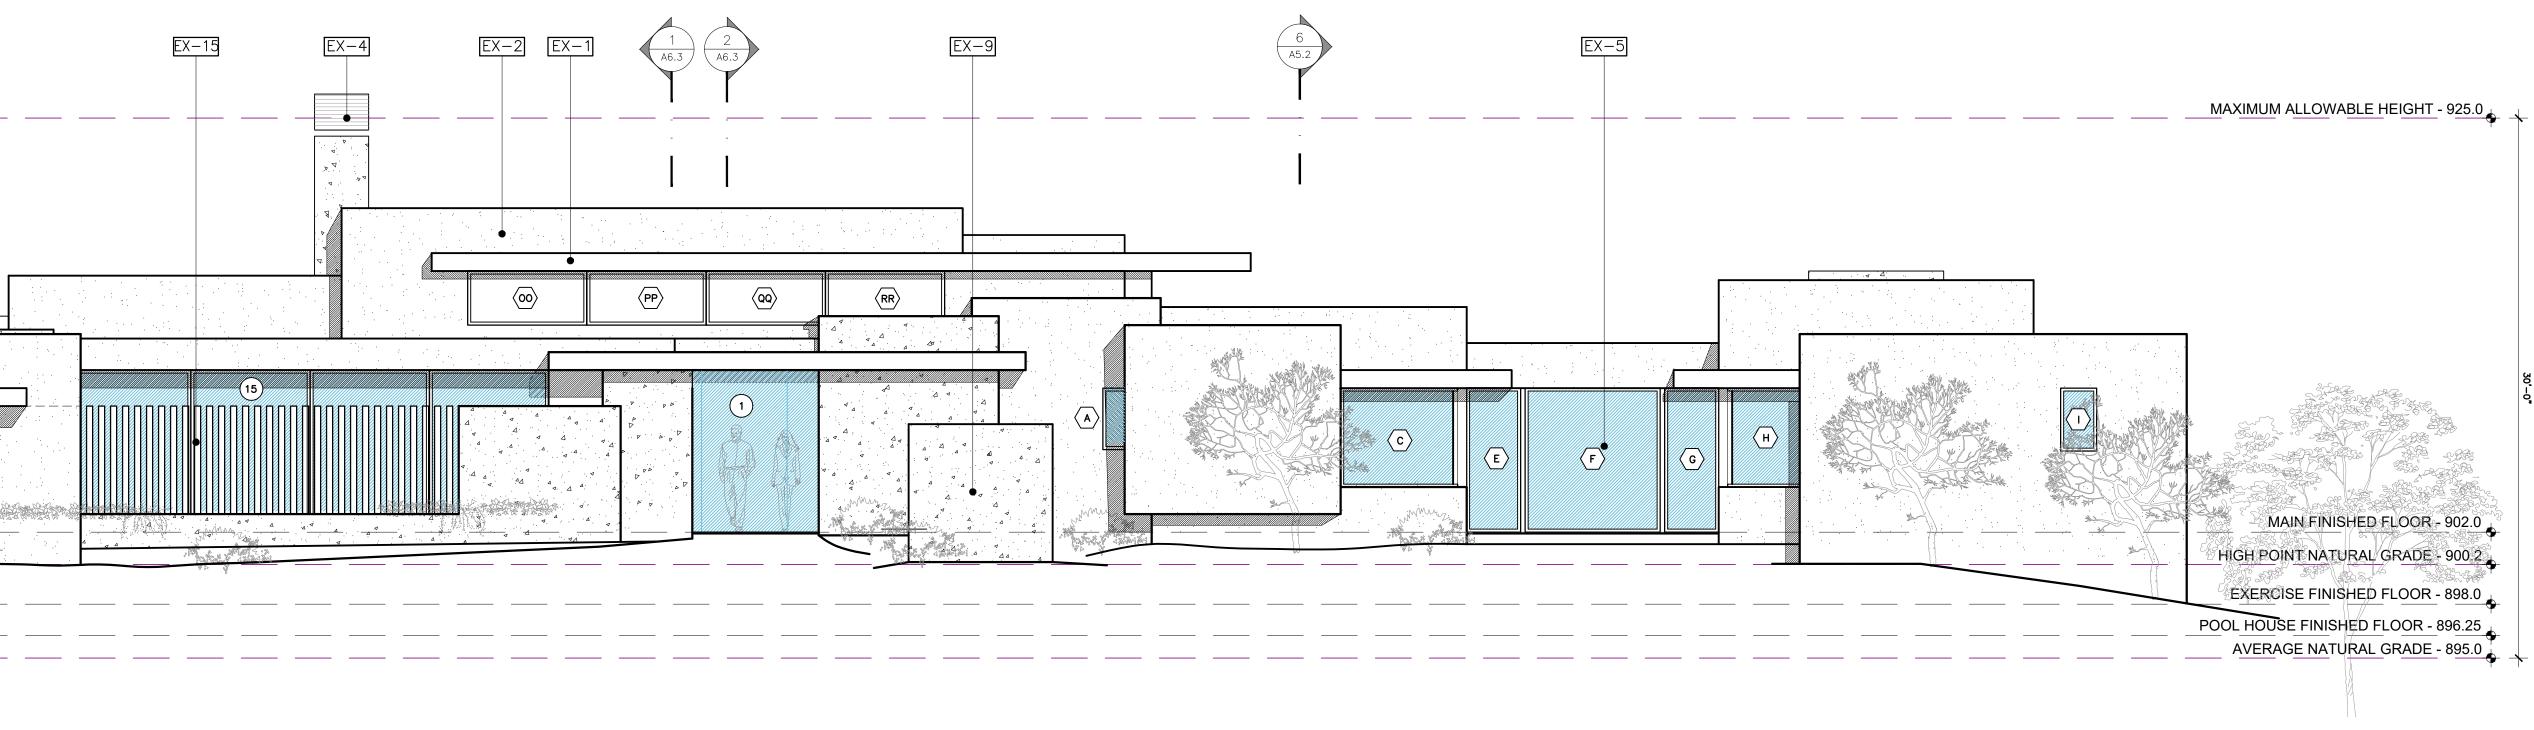


RAIL - SEE LANDSCAPE PLANS	EX-14 PHOTOVOLTAIC PANELS, PER MECHANICAL PLAN
L. STUCCO, OR BOARD FORMED Y OWNER/ARCHITECT	EX-15 VERTICAL DIVIDERS: GALV. IRON TUBE STEEL FRAME. FINISH: PAINT COLOR: BRONZE. FIELD SAMPLE FOR APPROVAL
G, 42" ABOVE FINISHED SURFACE. SEE DETAIL 4/A9.5	EX-16 LANDSCAPE PAVERS OR COBBLE - SEE LANDSCAPE PLANS
CAP SHEET OVER 30# FULLY LAPPED UNDERLAYMENTS, HOT MOPPED BETWEEN. OOT PITCH. COPPER FLASH ALL EDGES AND ROOF TRANSITIONS. D.G. OVERLAYMENT. S OR SIMILAR ROOF MEMBRANE, TORCH APPLIED OR EQUIVALENT	
NEERED CEDAR BOARDS, 6" WIDE, NO GROOVE, PHALT PAPER o/1/2" EXTERIOR UI LISTING 8140-2150:0101	

RED, SAND FINISH, COLOR: GRAY, PATTERN PER ARCHITECT. DRAIN. SEE CIVIL SHEETS FOR DRAINAGE REQUIREMENTS



PROPOSED EAST ELEVATION

PROPOSED NORTH (ENTRY) ELEVATION

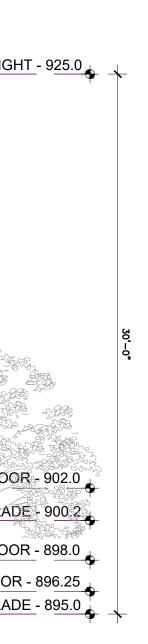







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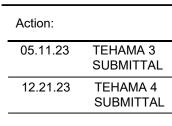
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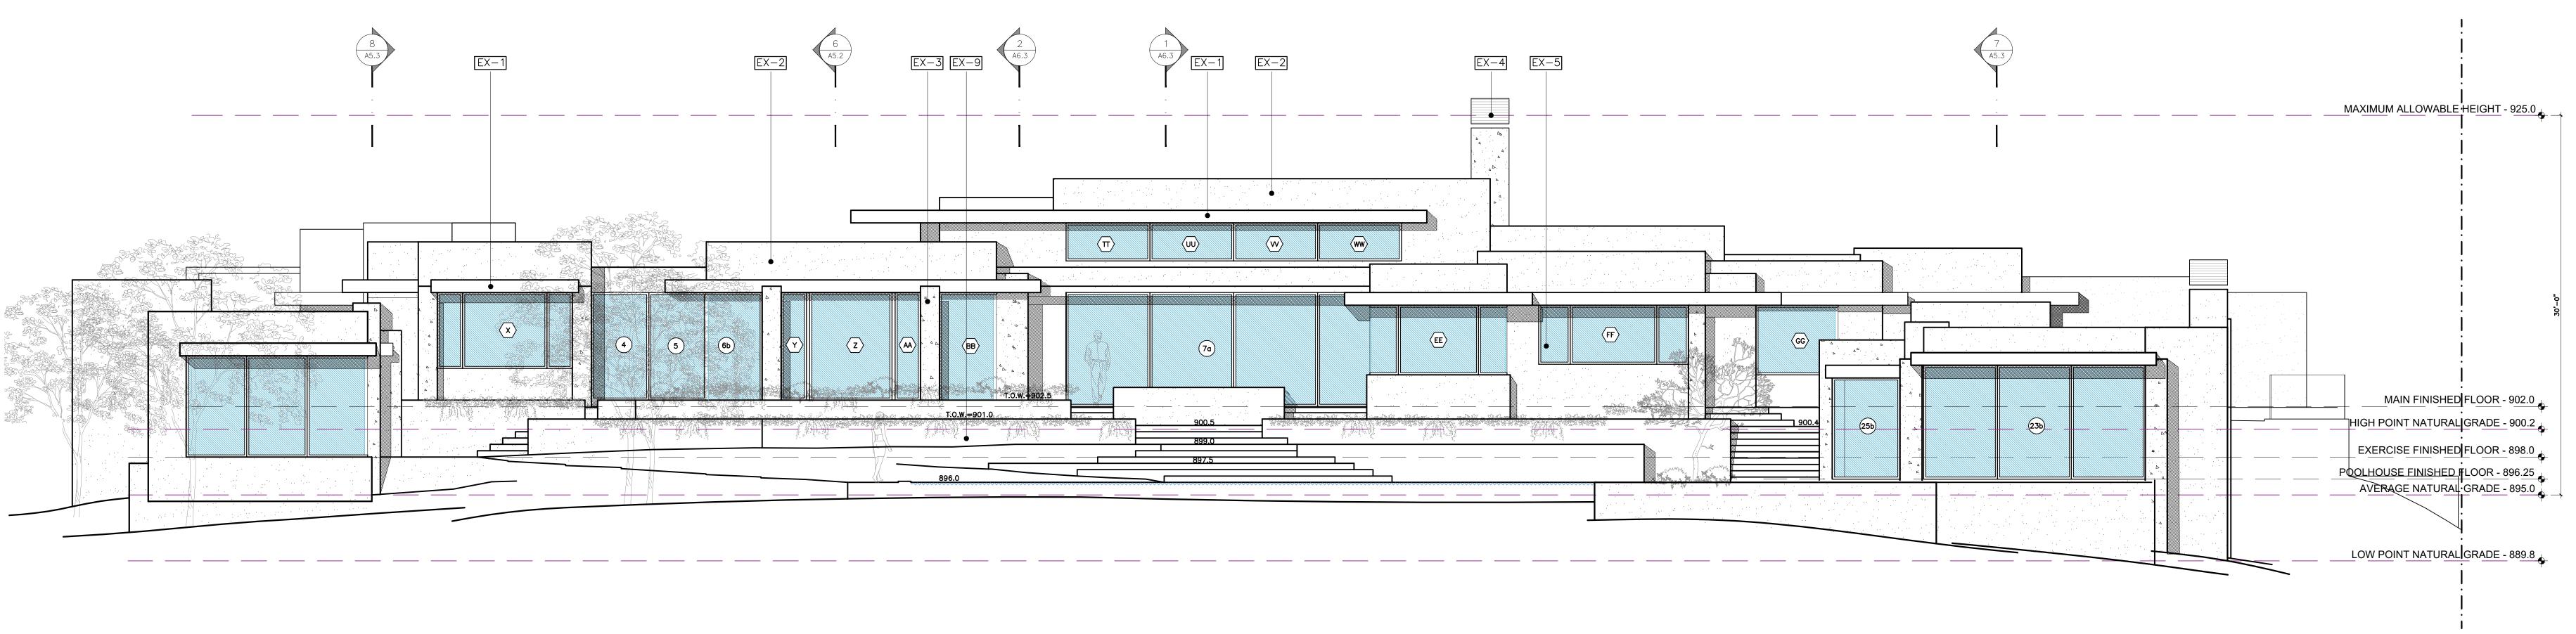
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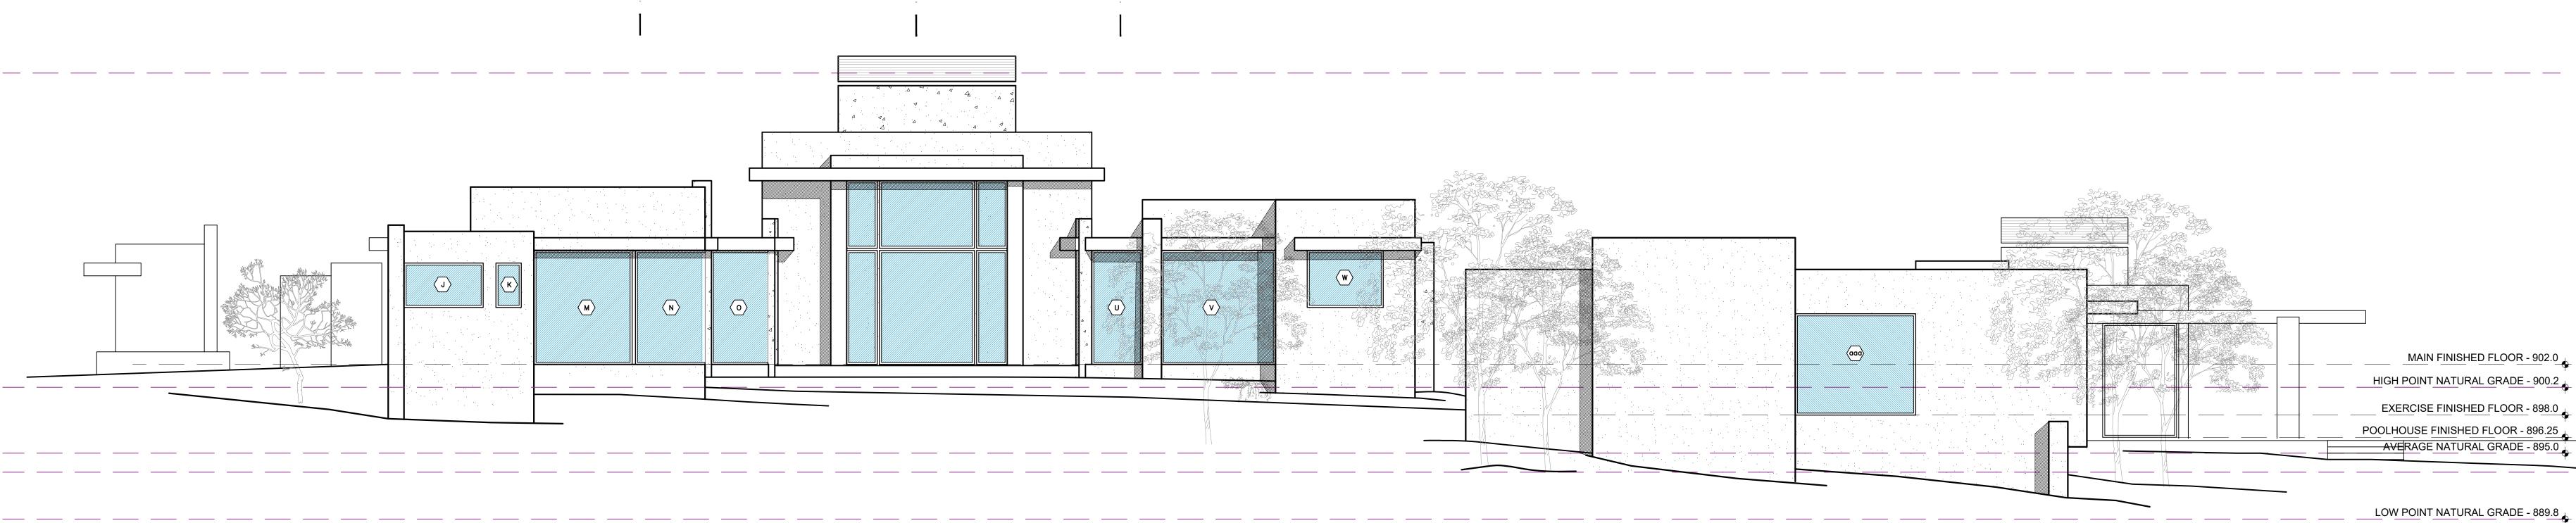


SCALE: 3/16"=1'-0"

Date: 06.07.2024 _____ Scale: 3/16" = 1'-0" _____ Drawn: _____ Description: EXTERIOR ELEVATIONS Sheet No: A-6.1







ELEVATION KEY NOTES		
EX-1 BRONZE METAL CAP AND FLASHING OVER WOOD PROFLE FASCIA	EX-8	BRONZE PAINTED METAL GUARDRAIL - SEE LANDSCAPE PLANS
EX-2 STUCCO: 7/8" ACRYLIC EXT. PLASTER w/SMOOTH STEEL TROWEL FINISH o/METAL LATH, ACRYLIC CORNERS o/2-LAYERS, GRADE "D" PAPER. PAINT WITH CLEAR SEALER SAMPLE IN FIELD. COLOR TO BE BENJAMIN MOOR CSP-70 "UPPER WEST SIDE"	EX-9	LANDSCAPE OR RETAINING WALL. STUCCO, OR BOARD FORMED CONCRETE (PER PLAN), COLOR BY OWNER/ARCHITECT
EX-3 BOARD-FORMED CONCRETE, COLOR TO BE LIGHT GRAY,	EX-10	FRAMELESS, TEMP GLASS RAILING, 42" ABOVE FINISHED SURFACE. SEE DETAIL 4/A9.5
EX-4 CUSTOM COPPER CHIMNEY SHROUD, PER DTL. W/ I.C.C. SPARK ARRESTOR, O/ SELKIRK/ISOKERN CHIMNEY FLUE.	EX-11	FLAT ROOF MEMBRANE: USE 90# CAP SHEET OVER 30# FULLY LAPPED UNDERLAYMENTS, SLOPED TO DRAIN MIN. 1/4" PER FOOT PITCH. COPPER FLASH ALL EDGES AND ROOF TRAN ALTERNATE USE METAL ACRYLICS OR SIMILAR ROOF MEMBRANE, TORCH APPLIED OR EG
EX-5 FLEETWOOD OR EQUAL ALUMINUM BOX FRAME DOORS AND WINDOWS PER SCHEDULE. PROVIDE SHOP DRAWINGS FOR APPROVAL PRIOR TO ORDERING.	EX-12	EAVE SOFFIT: 1X COULSON ENGINEERED CEDAR BOARDS, 6" WIDE, NO GROOVE,
EX-6 ALUMINUM FRAME OVERHEAD SECTIONAL DOOR. PROVIDE SHOP DRAWING FOR REVIEW/APPROVAL.		COLOR: CLEAR SEALER. o/30# ASPHALT PAPER o/1/2" EXTERIOR GRADE PLYWOOD SHEATHING. WUI LISTING 8140-2150:0101
EX-7 CONCEALED COPPER DOWNSPOUTS. TIE INTO STORM DRAIN SYSTEM, SEE CIVIL SHEETS. USE STAINLESS STEEL GUTTERGUARD TO PREVENT THE ACCUMULATION OF LEAVES AND DEBRIS IN THE GUTTER.	EX-13	CONCRETE PATIO: INTEGRAL COLORED, SAND FINISH, COLOR: GRAY, PATTERN PER ARCH MATTE SEALER. SLOPE 2% MIN. TO DRAIN. SEE CIVIL SHEETS FOR DRAINAGE REQUIREMEN


ERED CEDAR BOARDS, 6" WIDE, NO GROOVE,

OT PITCH. COPPER FLASH ALL EDGES AND ROOF TRANSITIONS. D.G. OVERLAYMENT. OR SIMILAR ROOF MEMBRANE, TORCH APPLIED OR EQUIVALENT

EX-16 LANDSCAPE PAVERS OR COBBLE - SEE LANDSCAPE PLANS AP SHEET OVER 30# FULLY LAPPED UNDERLAYMENTS, HOT MOPPED BETWEEN.


EX-15 VERTICAL DIVIDERS: GALV. IRON TUBE STEEL FRAME. FINISH: PAINT COLOR: BRONZE. FIELD SAMPLE FOR APPROVAL

EX-14 PHOTOVOLTAIC PANELS, PER MECHANICAL PLAN

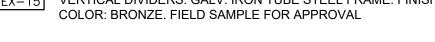

PROPOSED SOUTH ELEVATION

PROPOSED WEST ELEVATION

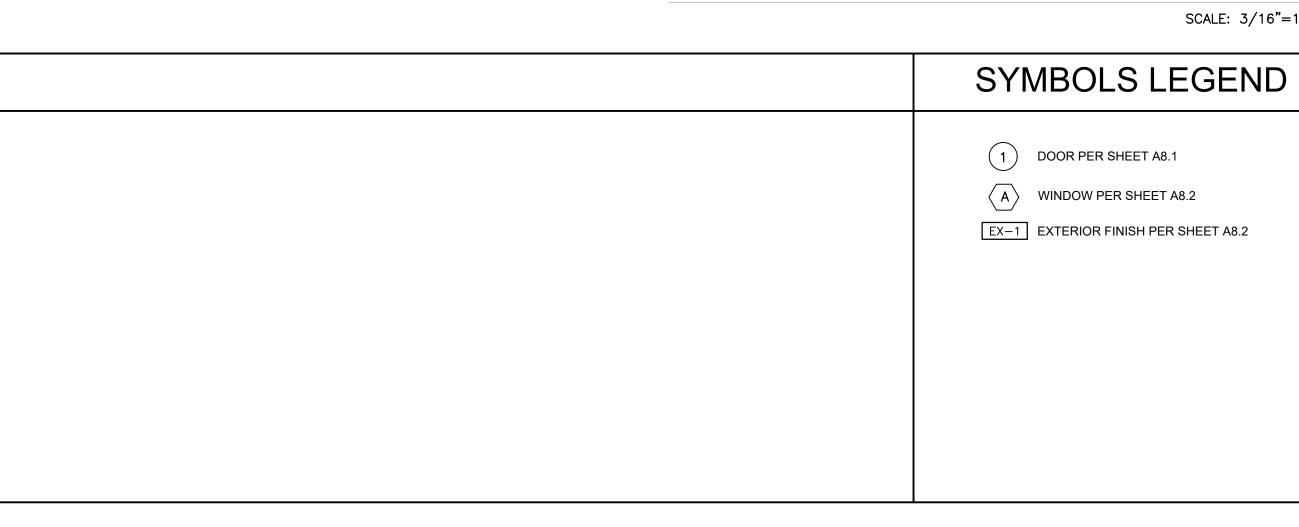

SCALE: 3/16"=1'-0"

SCALE: 3/16"=1'-0"





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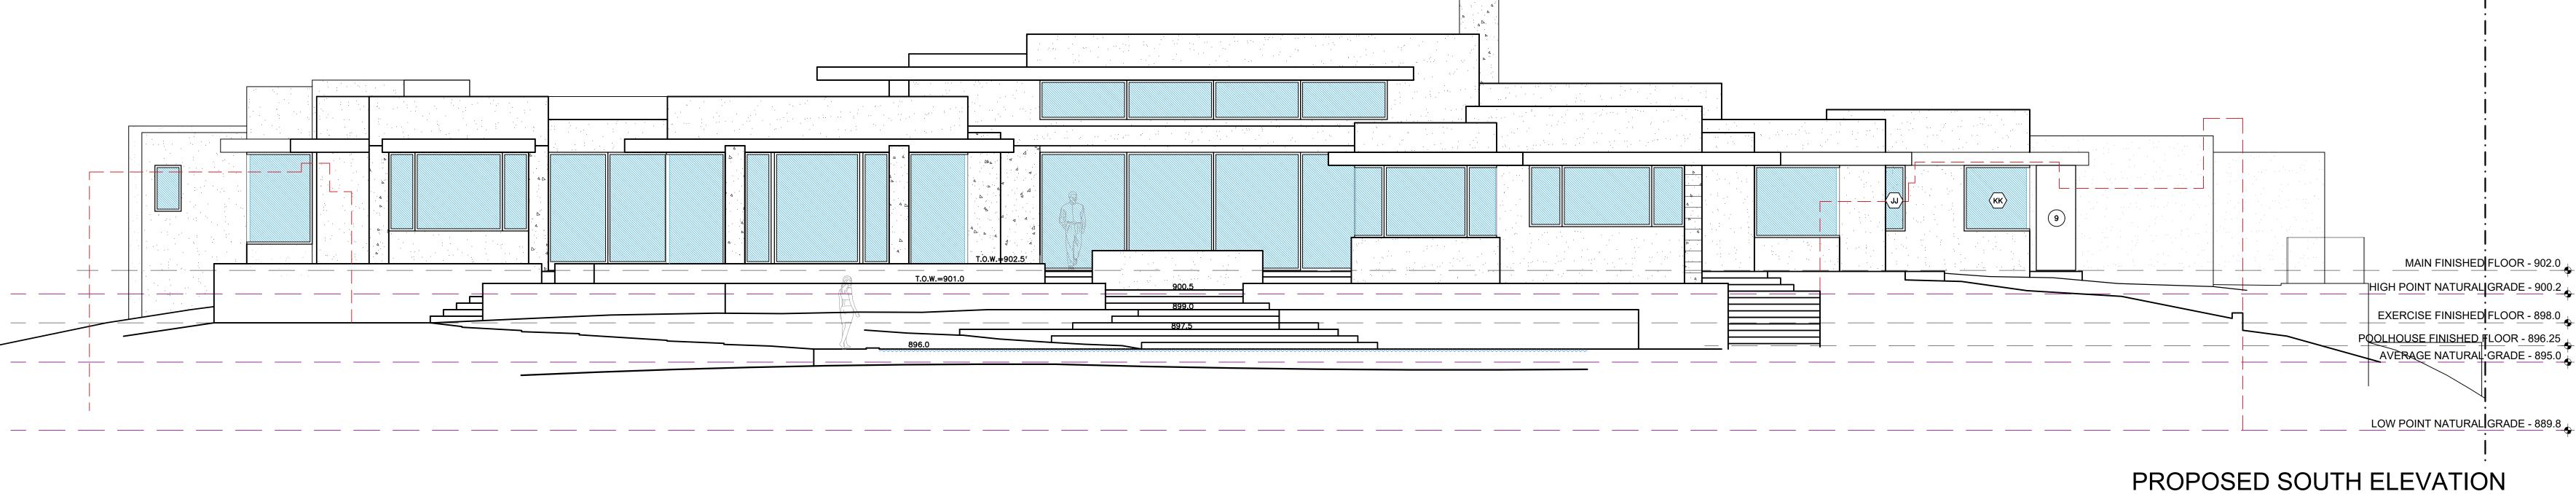
PRELIMINARY


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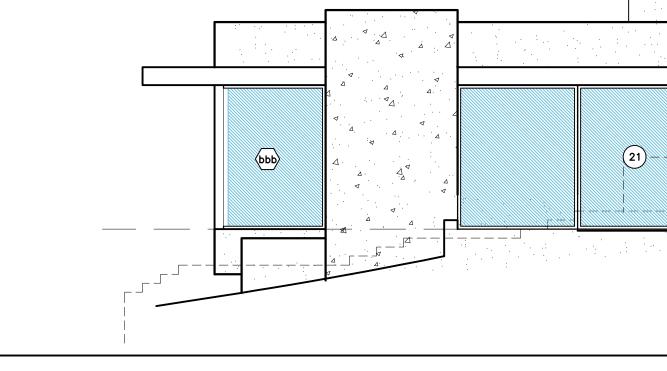
Action: 05.11.23 TEHAMA 3 12.21.23 TEHAMA 4

SUBMITTAL SUBMITTAL

Date: 06.07.2024 Scale: 3/16" = 1'-0" Drawn: _____ Description: EXTERIOR ELEVATIONS Sheet No: A-6.2





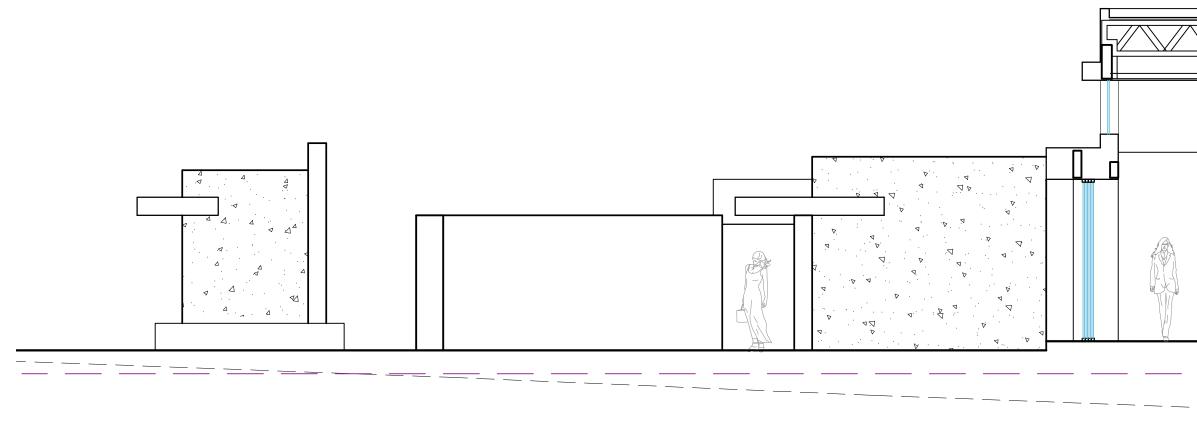

ELEVATION KEY NOTE

EX-1 BRONZE METAL CAP AND FLASHING OVER WOOD PROFLE FASCIA

EX-2 STUCCO: 7/8" ACRYLIC EXT. PLASTER w/SMOOTH STEEL TROWEL FINISH o/METAL LATH, ACRYLIC CORNERS 0/2-LAYERS, GRADE "D" PAPER.

PAINT WITH CLEAR SEALER SAMPLE IN FIELD. COLOR TO BE BENJAMIN MOOR CSP-70 "UPPER WEST SIDE"

EX-3 BOARD-FORMED CONCRETE, COLOR TO BE LIGHT GRAY, EX-4 CUSTOM COPPER CHIMNEY SHROUD, PER DTL. W/ I.C.C.

SPARK ARRESTOR, O/ SELKIRK/ISOKERN CHIMNEY FLUE.

EX-5 FLEETWOOD OR EQUAL ALUMINUM BOX FRAME DOORS AND WINDOWS PER SCHEDULE. PROVIDE SHOP DRAWINGS FOR APPROVAL PRIOR TO ORDERING.

EX-6 ALUMINUM FRAME OVERHEAD SECTIONAL DOOR. PROVIDE SHOP DRAWING FOR REVIEW/APPROVAL.

EX-7 CONCEALED COPPER DOWNSPOUTS. TIE INTO STORM DRAIN SYSTEM, SEE CIVIL SHEETS. USE STAINLESS STEEL GUTTERGUARD TO PREVENT THE ACCUMULATION OF LEAVES AND DEBRIS IN THE GUTTER.


EX-8 BRONZE PAINTED METAL GUARDRAIL - SEE LANDSCAPE PLANS EX-14 PHOTOVOLTAIC PANELS, PER MECHANICAL PLAN EX-9 LANDSCAPE OR RETAINING WALL. STUCCO, OR BOARD FORMED EX-15 VERTICAL DIVIDERS: GALV. IRON TUBE STEEL FRAME. FINISH: PAINT COLOR: BRONZE. FIELD SAMPLE FOR APPROVAL CONCRETE (PER PLAN), COLOR BY OWNER/ARCHITECT EX-10 FRAMELESS, TEMP GLASS RAILING, 42" ABOVE FINISHED SURFACE. SEE DETAIL 4/A9.5 EX-16 LANDSCAPE PAVERS OR COBBLE - SEE LANDSCAPE PLANS EX-11 FLAT ROOF MEMBRANE: USE 90# CAP SHEET OVER 30# FULLY LAPPED UNDERLAYMENTS, HOT MOPPED BETWEEN. SLOPED TO DRAIN MIN. 1/4" PER FOOT PITCH. COPPER FLASH ALL EDGES AND ROOF TRANSITIONS. D.G. OVERLAYMENT. ALTERNATE USE METAL ACRYLICS OR SIMILAR ROOF MEMBRANE, TORCH APPLIED OR EQUIVALENT EX-12 EAVE SOFFIT: 1X COULSON ENGINEERED CEDAR BOARDS, 6" WIDE, NO GROOVE, COLOR: CLEAR SEALER. 0/30# ASPHALT PAPER 0/1/2" EXTERIOR GRADE PLYWOOD SHEATHING. WUI LISTING 8140-2150:0101 EX-13 CONCRETE PATIO: INTEGRAL COLORED, SAND FINISH, COLOR: GRAY, PATTERN PER ARCHITECT. MATTE SEALER. SLOPE 2% MIN. TO DRAIN. SEE CIVIL SHEETS FOR DRAINAGE REQUIREMENTS

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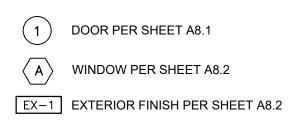
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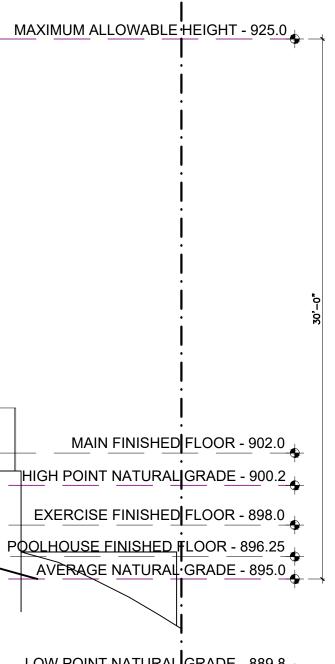
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SCALE: 3/16"=1'-0"

SCALE: 3/16"=1'-0"

SCALE: 3/16"=1'-0"

GEND

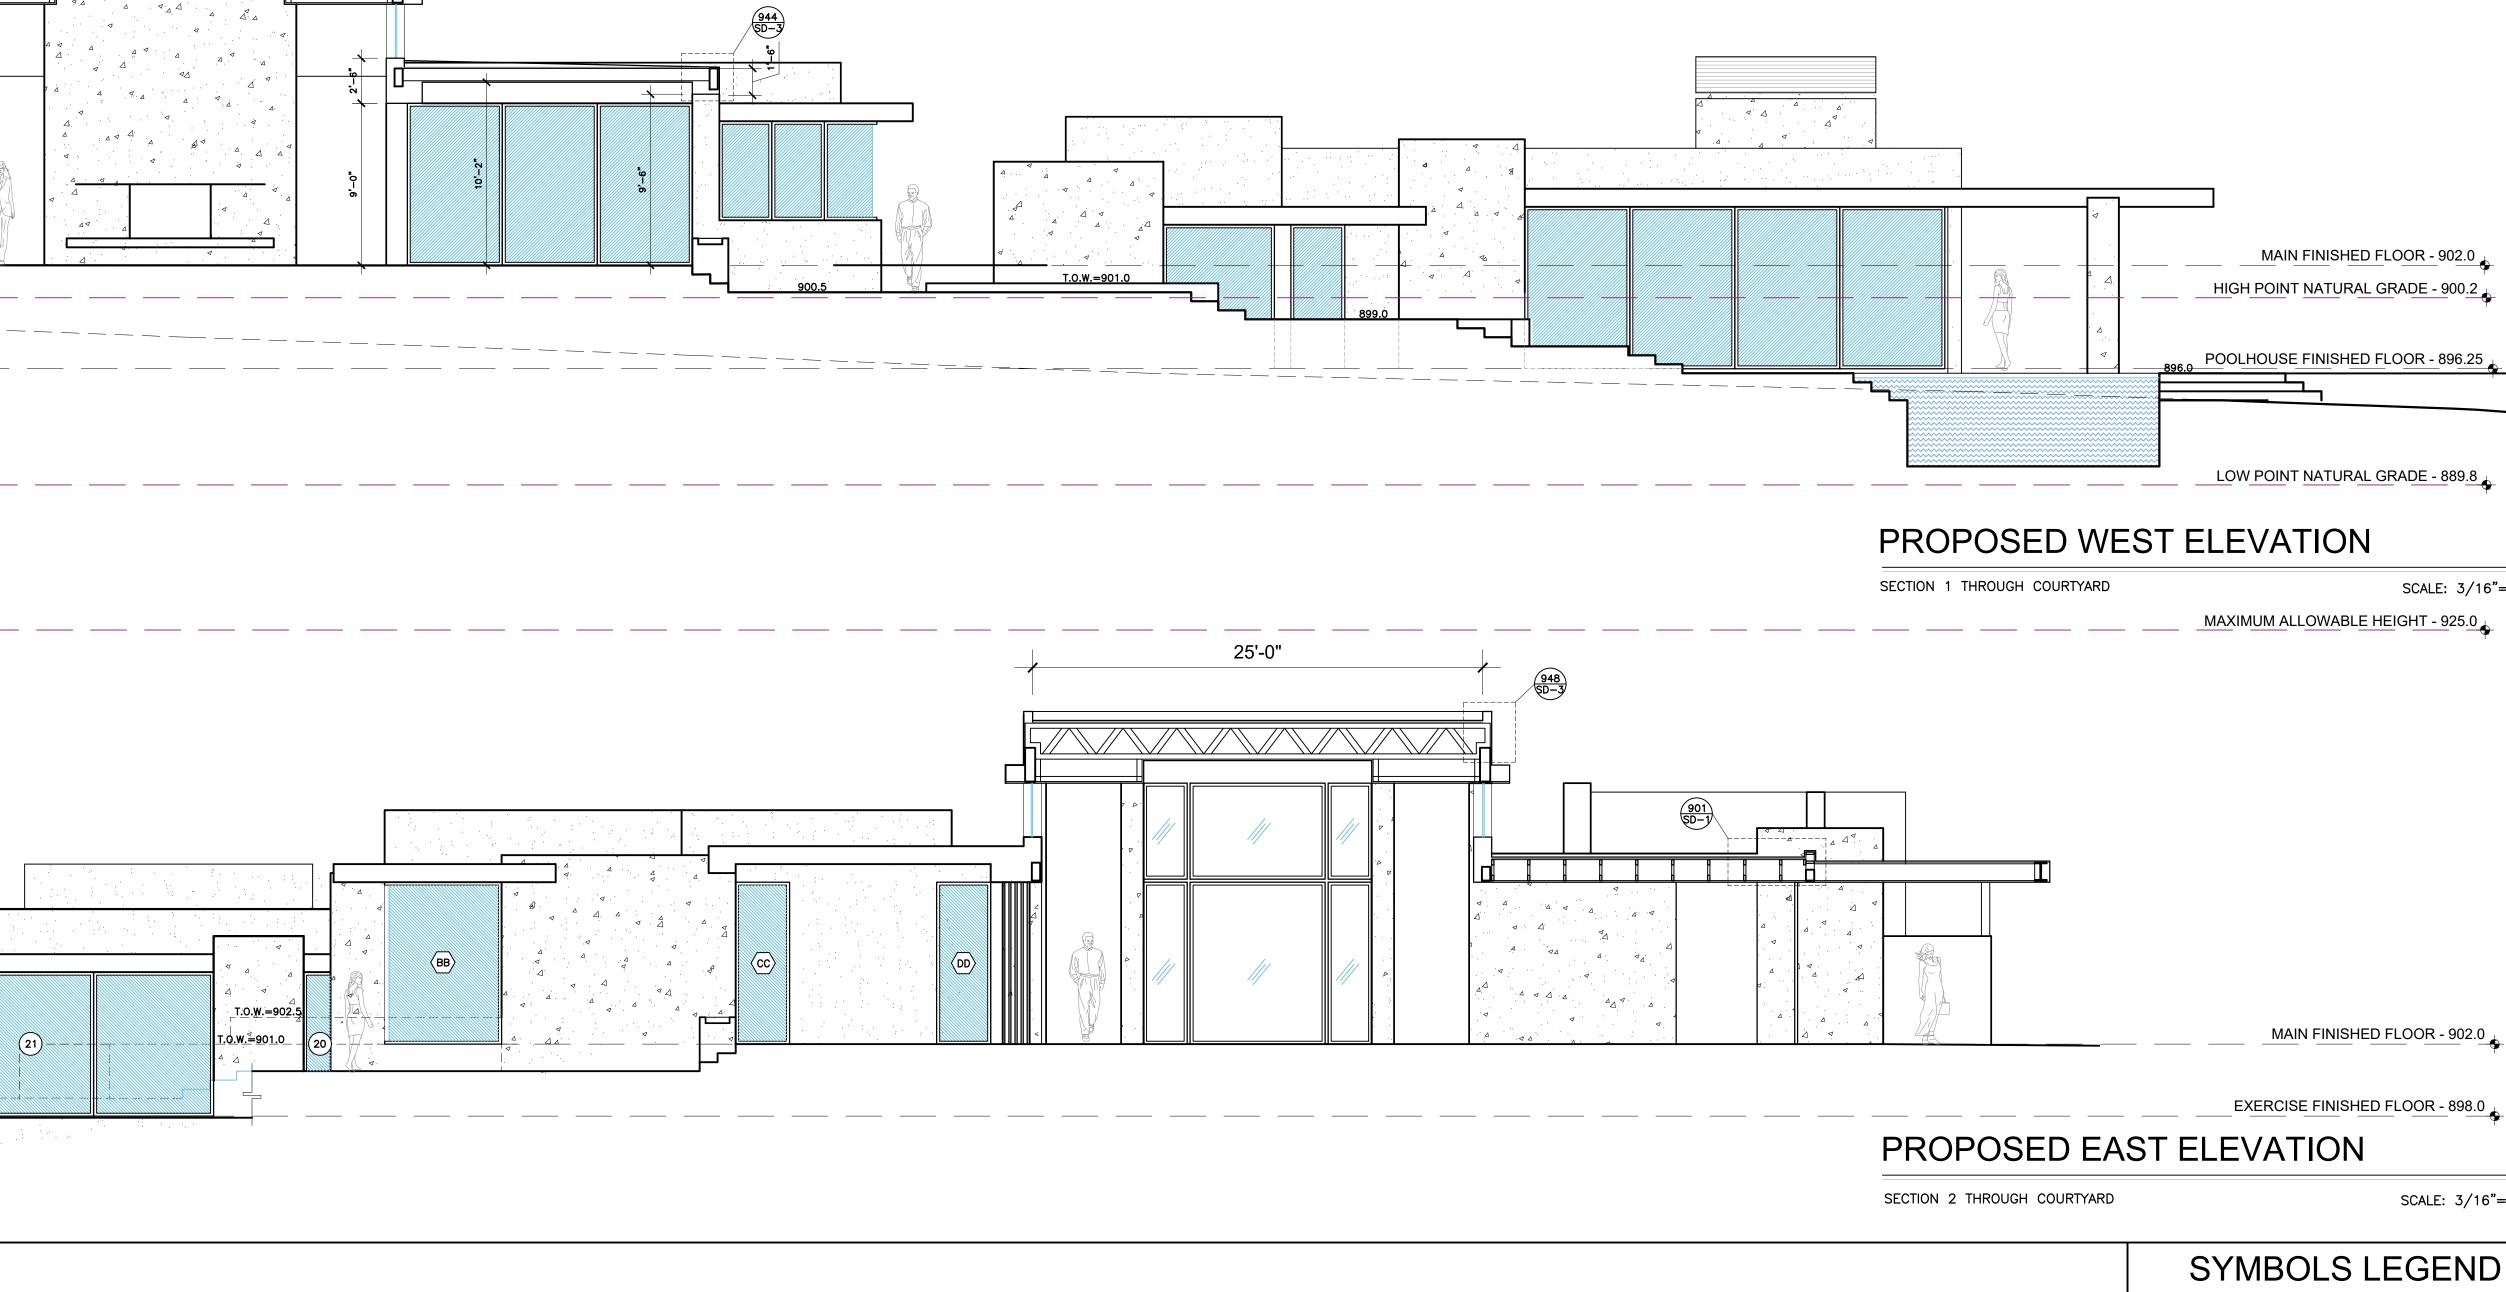

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Action: 05.11.23 TEHAMA 3 12.21.23 TEHAMA 4

SUBMITTAL SUBMITTAL

Date: 12.21.2023 _____ Scale: 1/4" = 1'-0" -----Drawn: _____ Description:

EXTERIOR ELEVATIONS

A-6.3

Sheet No:







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Action:	
05.11.23	TEHAMA 3 SUBMITTAL
12.21.23	TEHAMA 4 SUBMITTAL

Date: 06.07.2024 Scale: NONE Drawn: Description: EXTERIOR RENDERING